


DATE TIME

NOTES:

1. FOR BACKFLOW ASSEMBLY LOCATION, SEE UTILITY PLAN

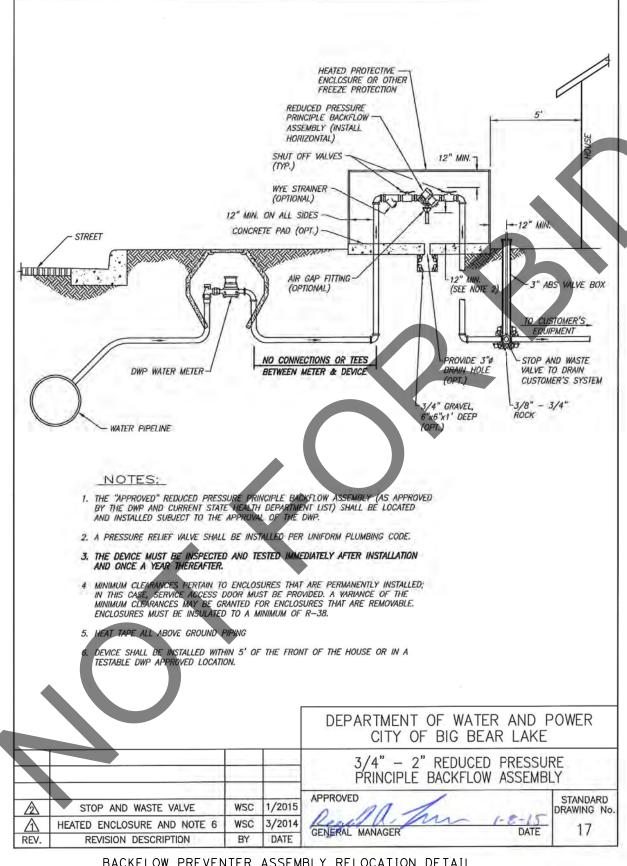

BACKFLOW PREVENTER ASSEMBLY RELOCATION DETAIL

BENCHMARK Underground Service Alert

TWO WORKING DAYS BEFORE YOU DIG

S.B.CO BRASS DISK STAMPED 63-1-12 1975 ON TOP OF CURB. +/- 28' SOUTHERLY FROM HWY 38 & 0.15 MILES EASTERLY FROM INTERSECTION HWY 38 & STANFIELD CUTOFF AS SHOWN PER SPSN 00271. NGVD-29 ELEVATION = 6789.402

PREPARED BY: MATTHEW ATKINSON, PROJECT MANAGER



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ı			(X10
			CHRIS NGUY
	-		TRANSPORT.
			Thomas
			THOMAS BU'
			SUPERVISIN

SAN BERNARDINO COUNTY DEPARTMENT OF PUBLIC WORKS DESIGNED BY: DRAWN BY: UVEN, P.E. DATE
TATION DESIGN ENGINEERING MANAGER 6/26/24 DATE STAMONTE, P.E.

NO SCALE STATE HIGHWAY 38 STANFIELD CUTOFF ROUNDABOUT 6/26/2024


H15055 SHEET 41 OF 72 BIG BEAR AREA


UTILITY DETAILS


UD-1


ROAD NO.


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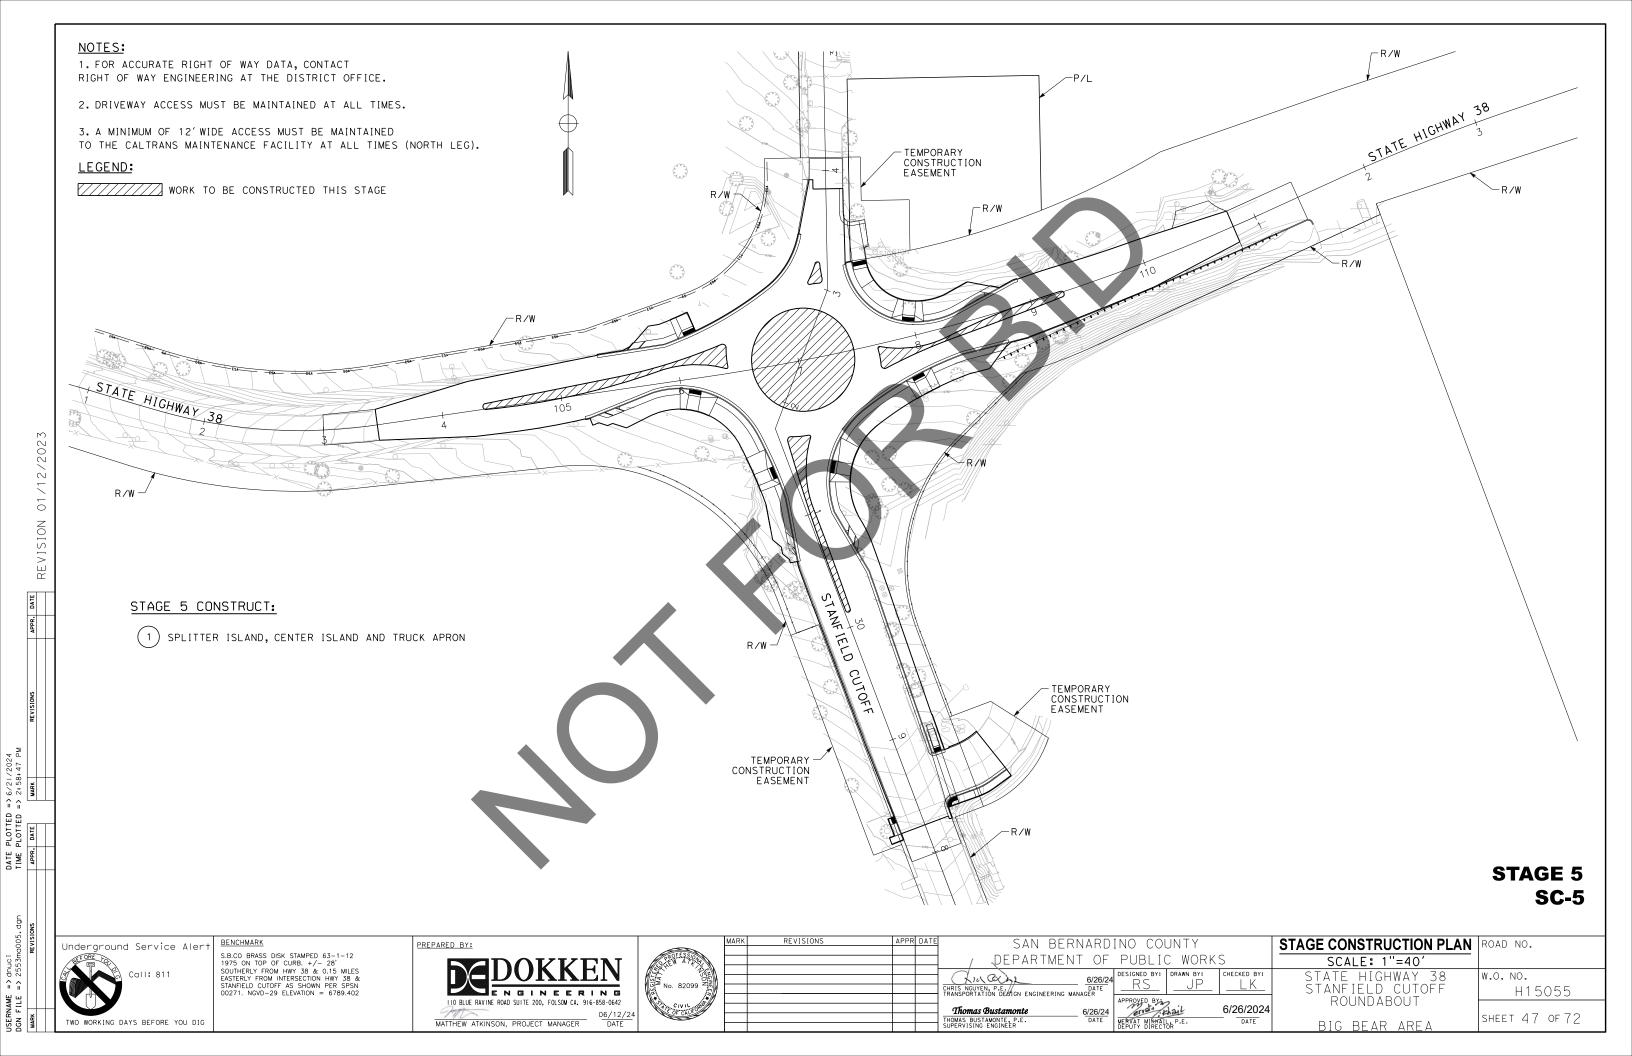


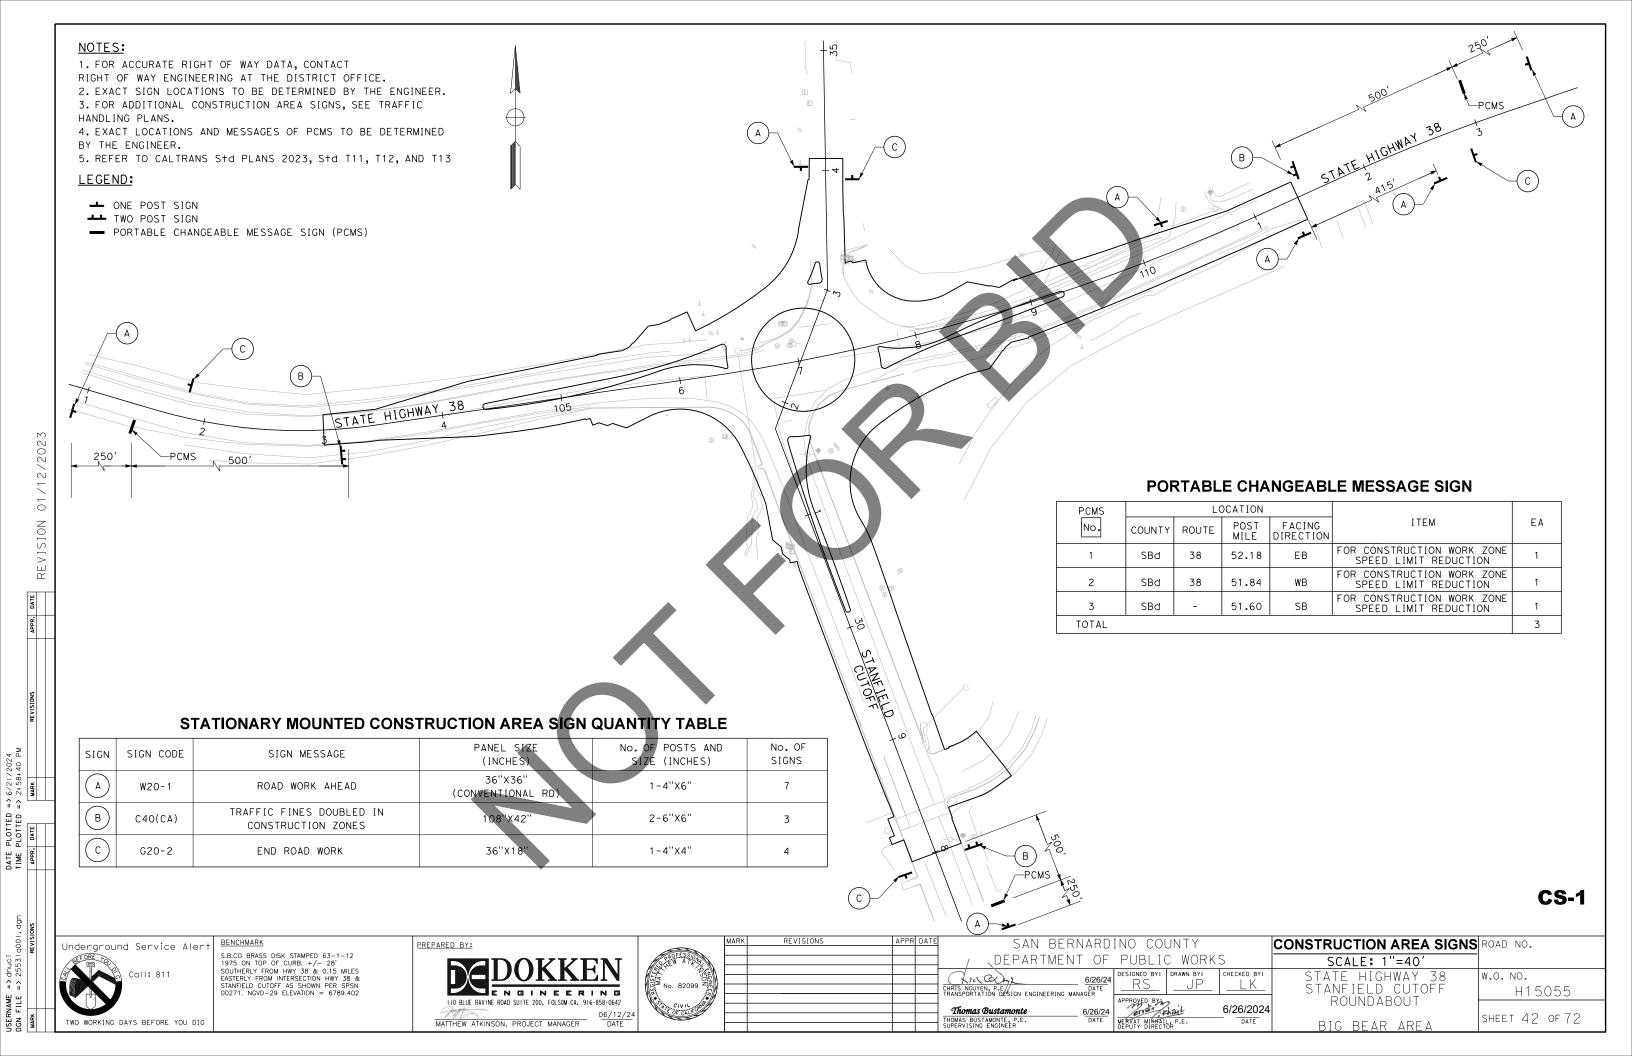


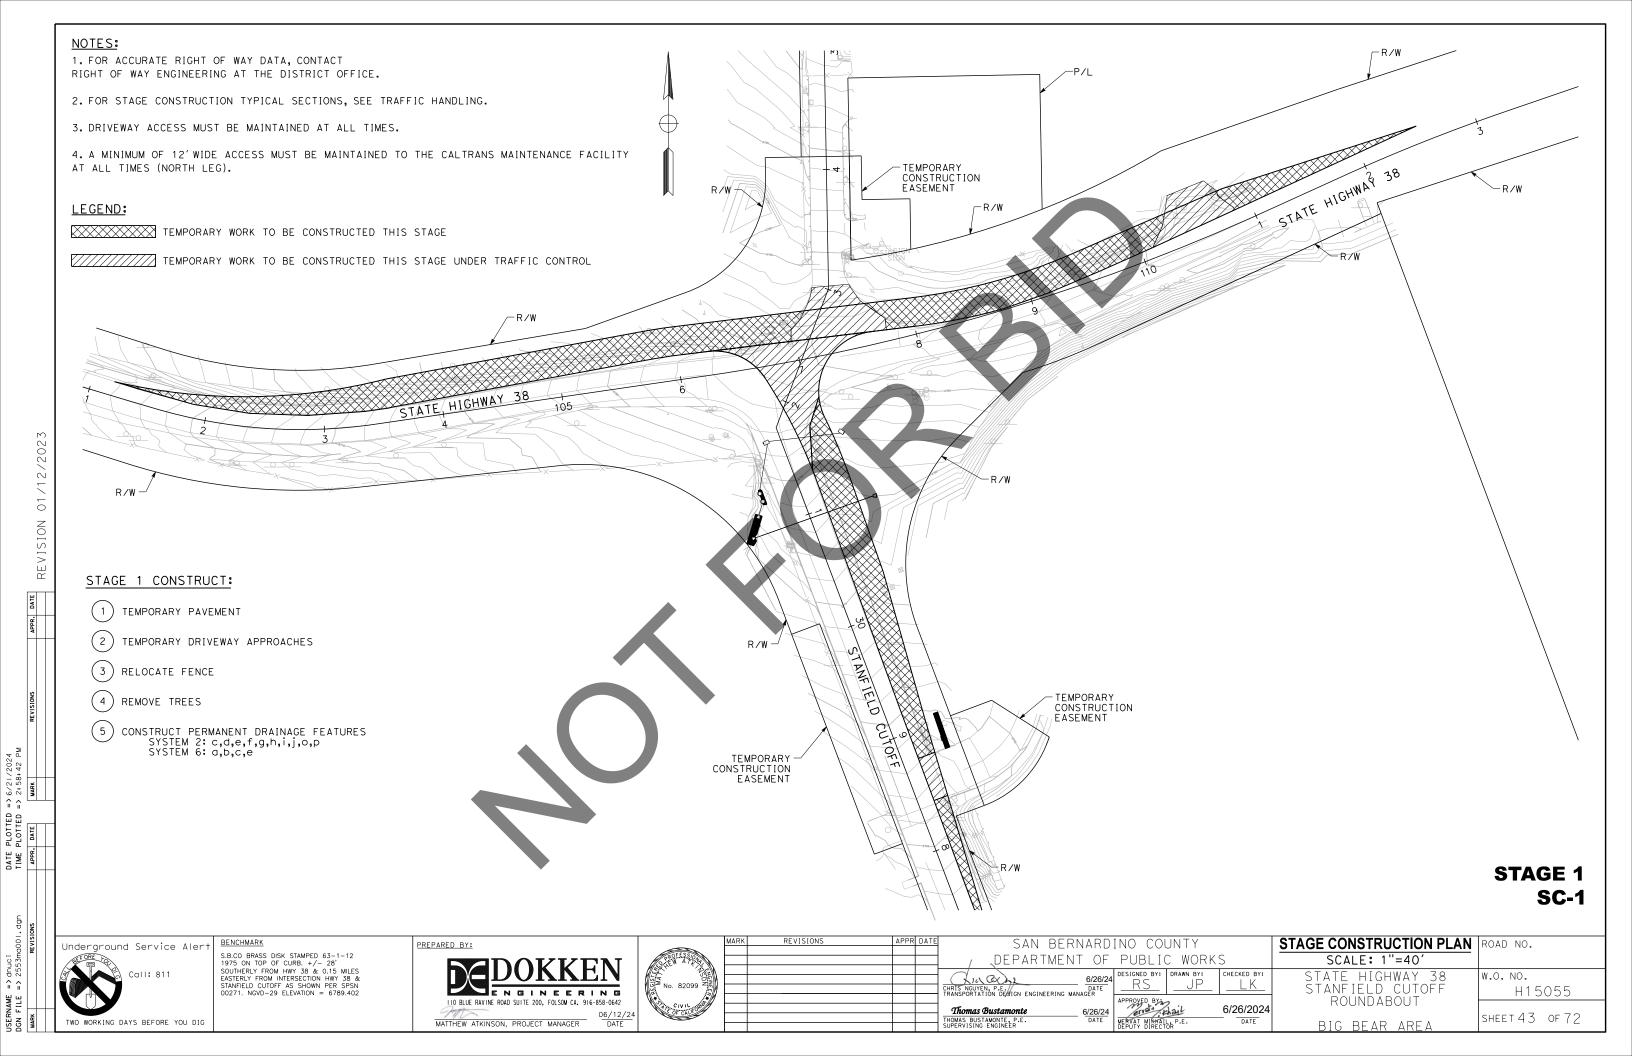


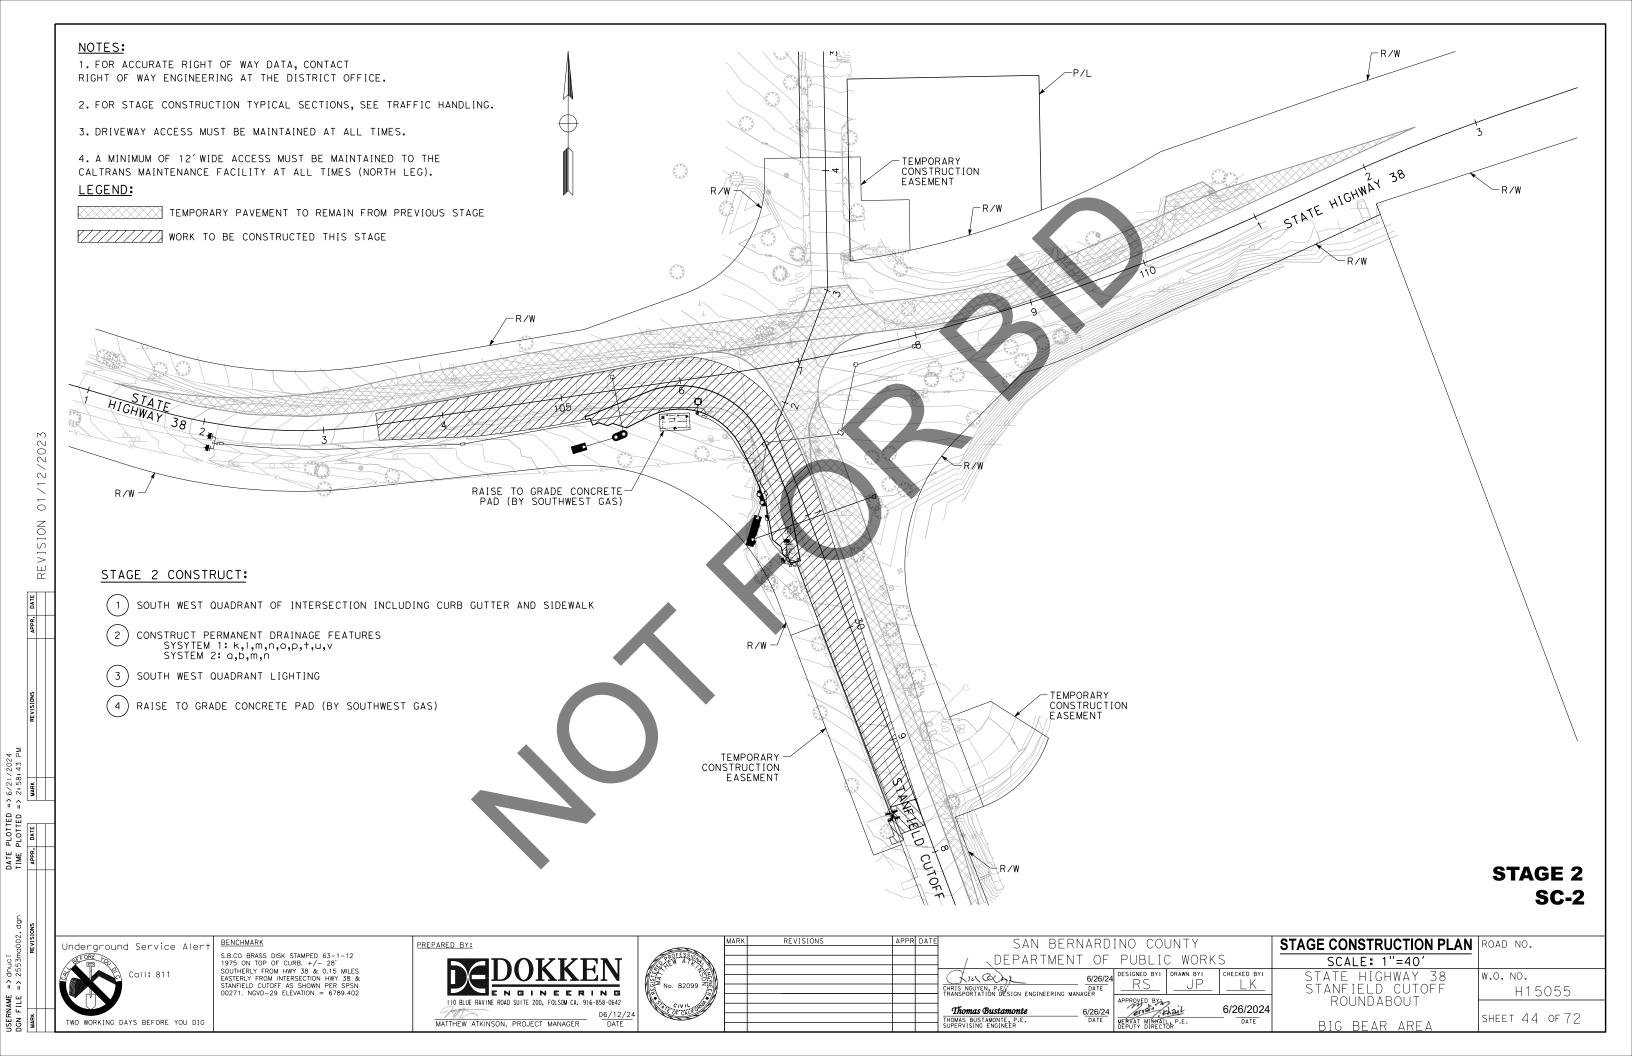


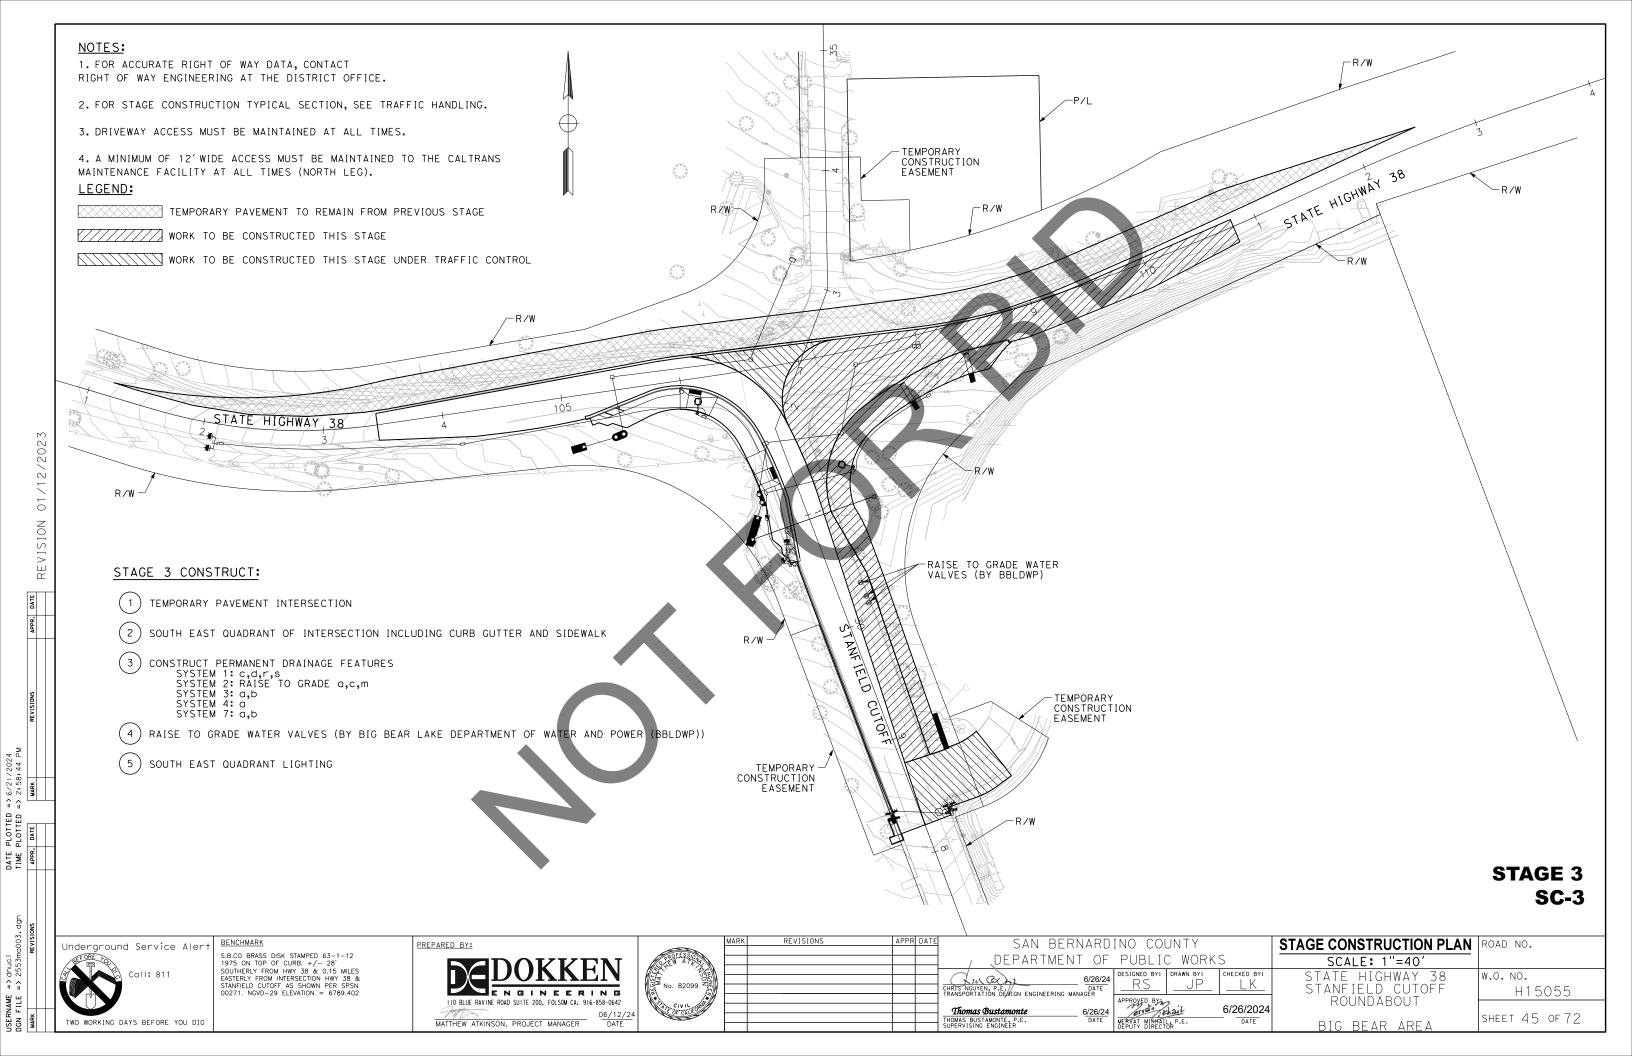


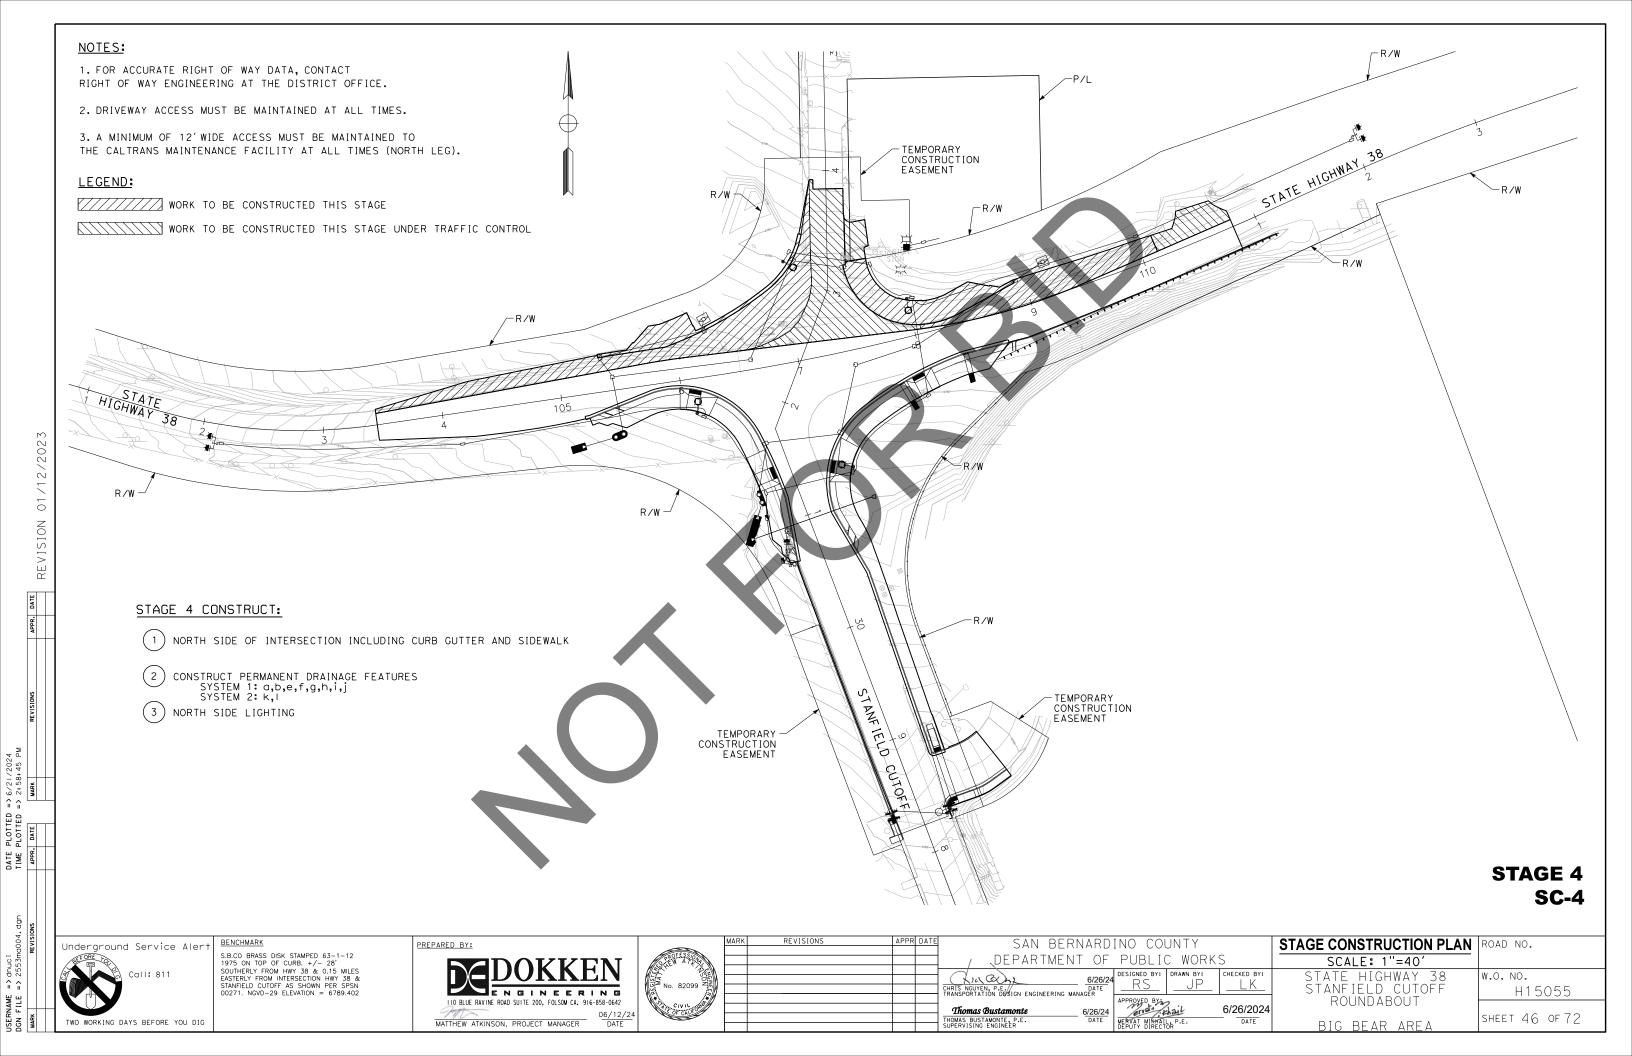


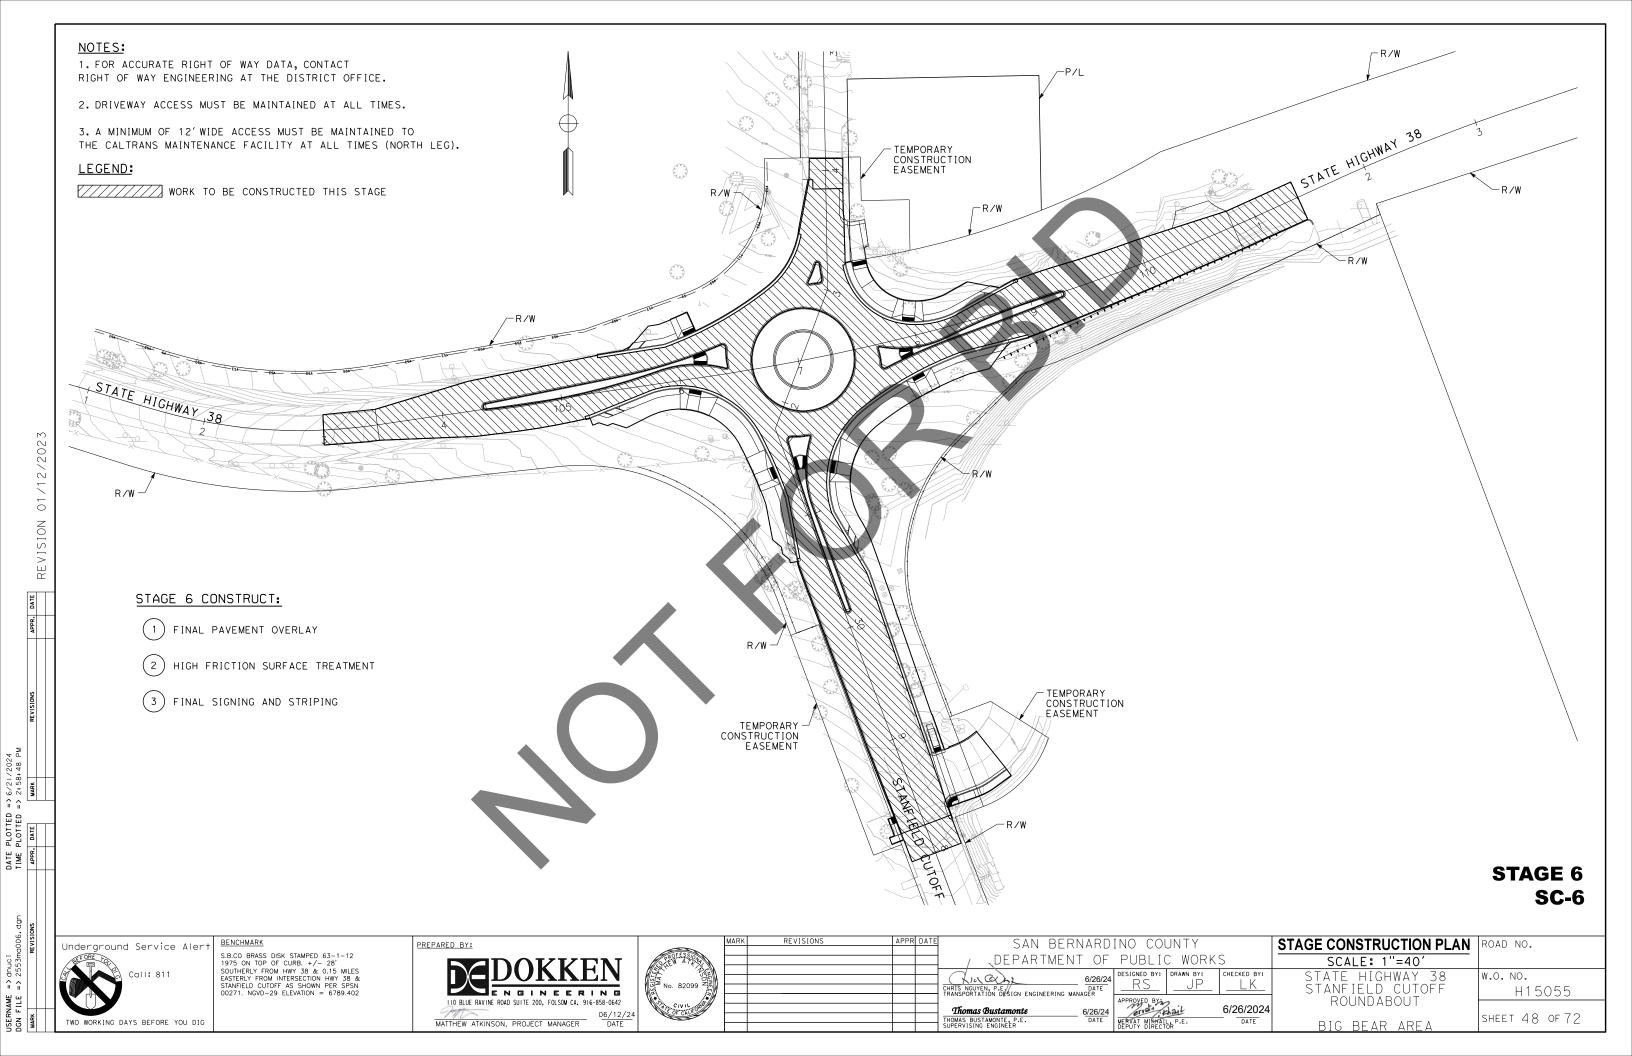


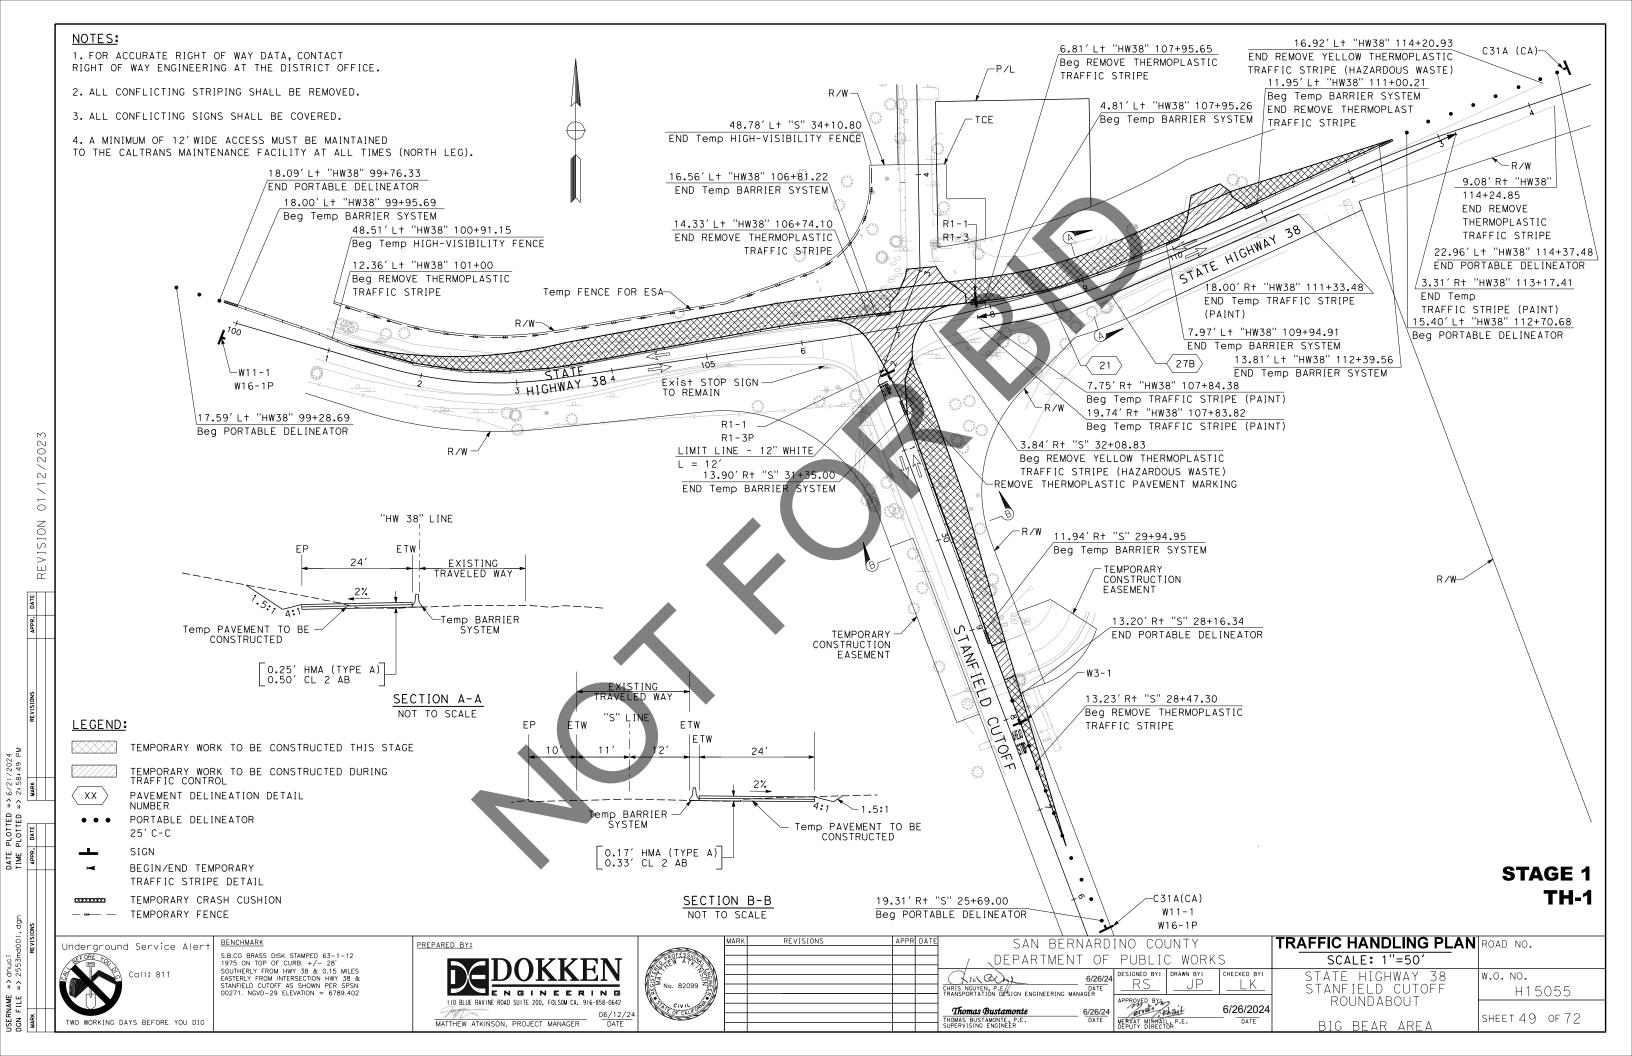


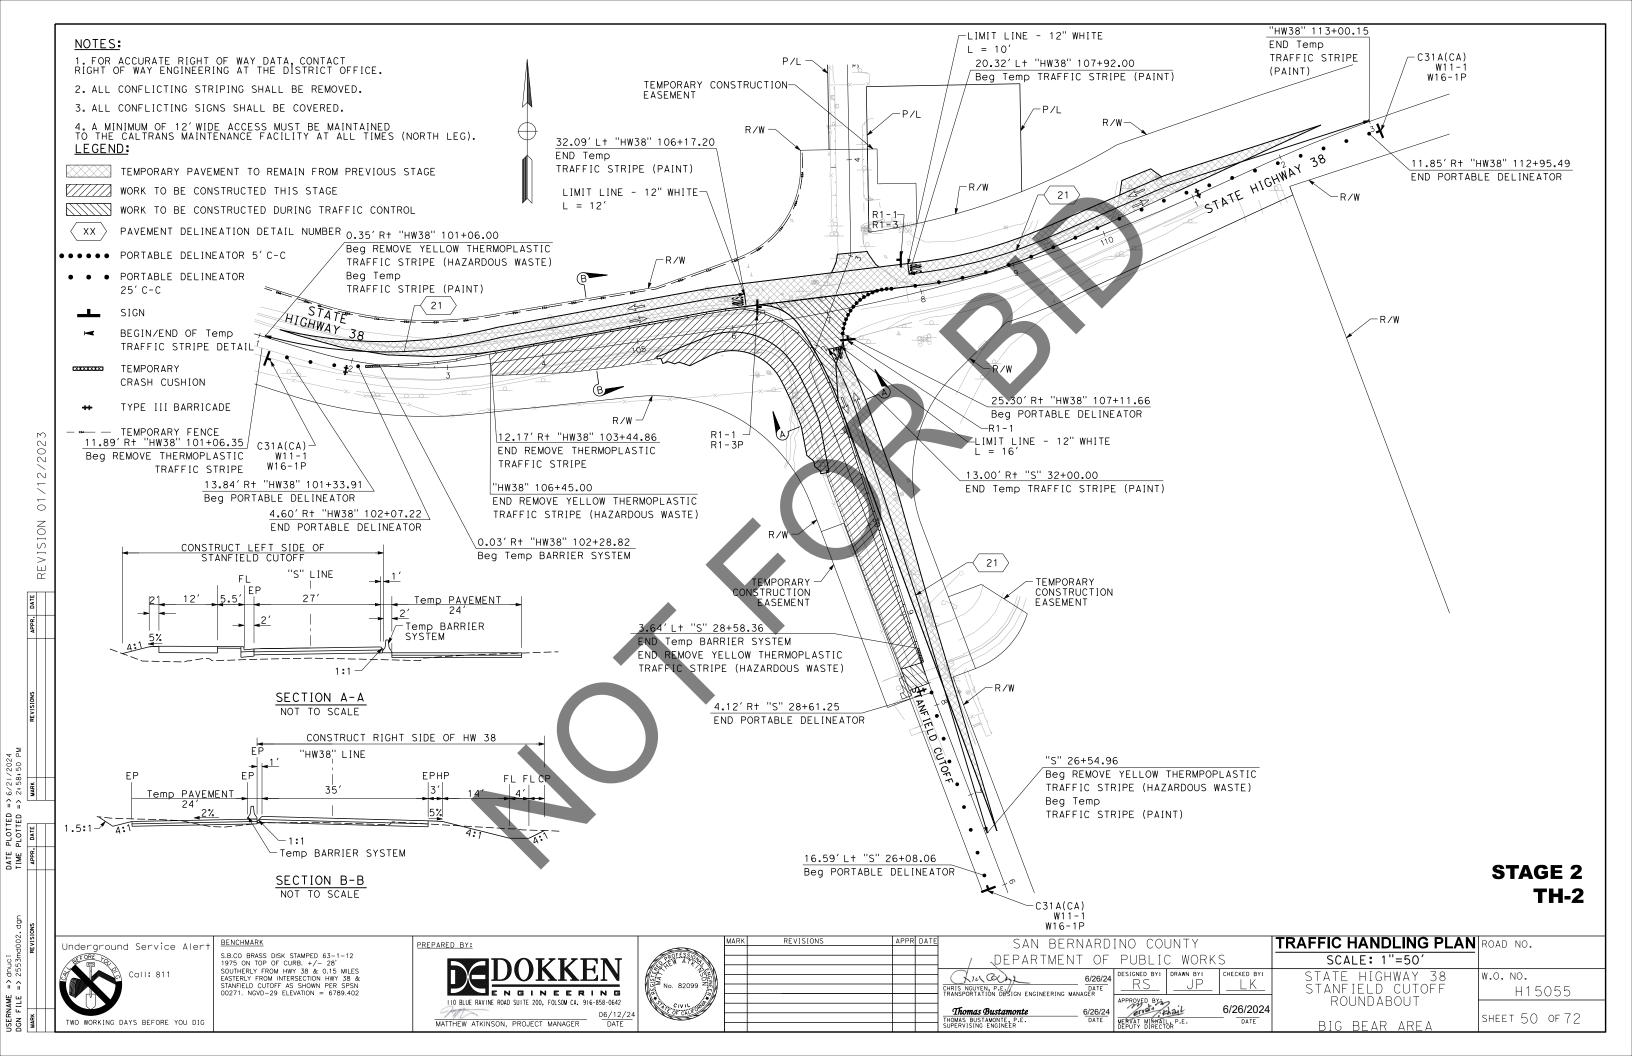

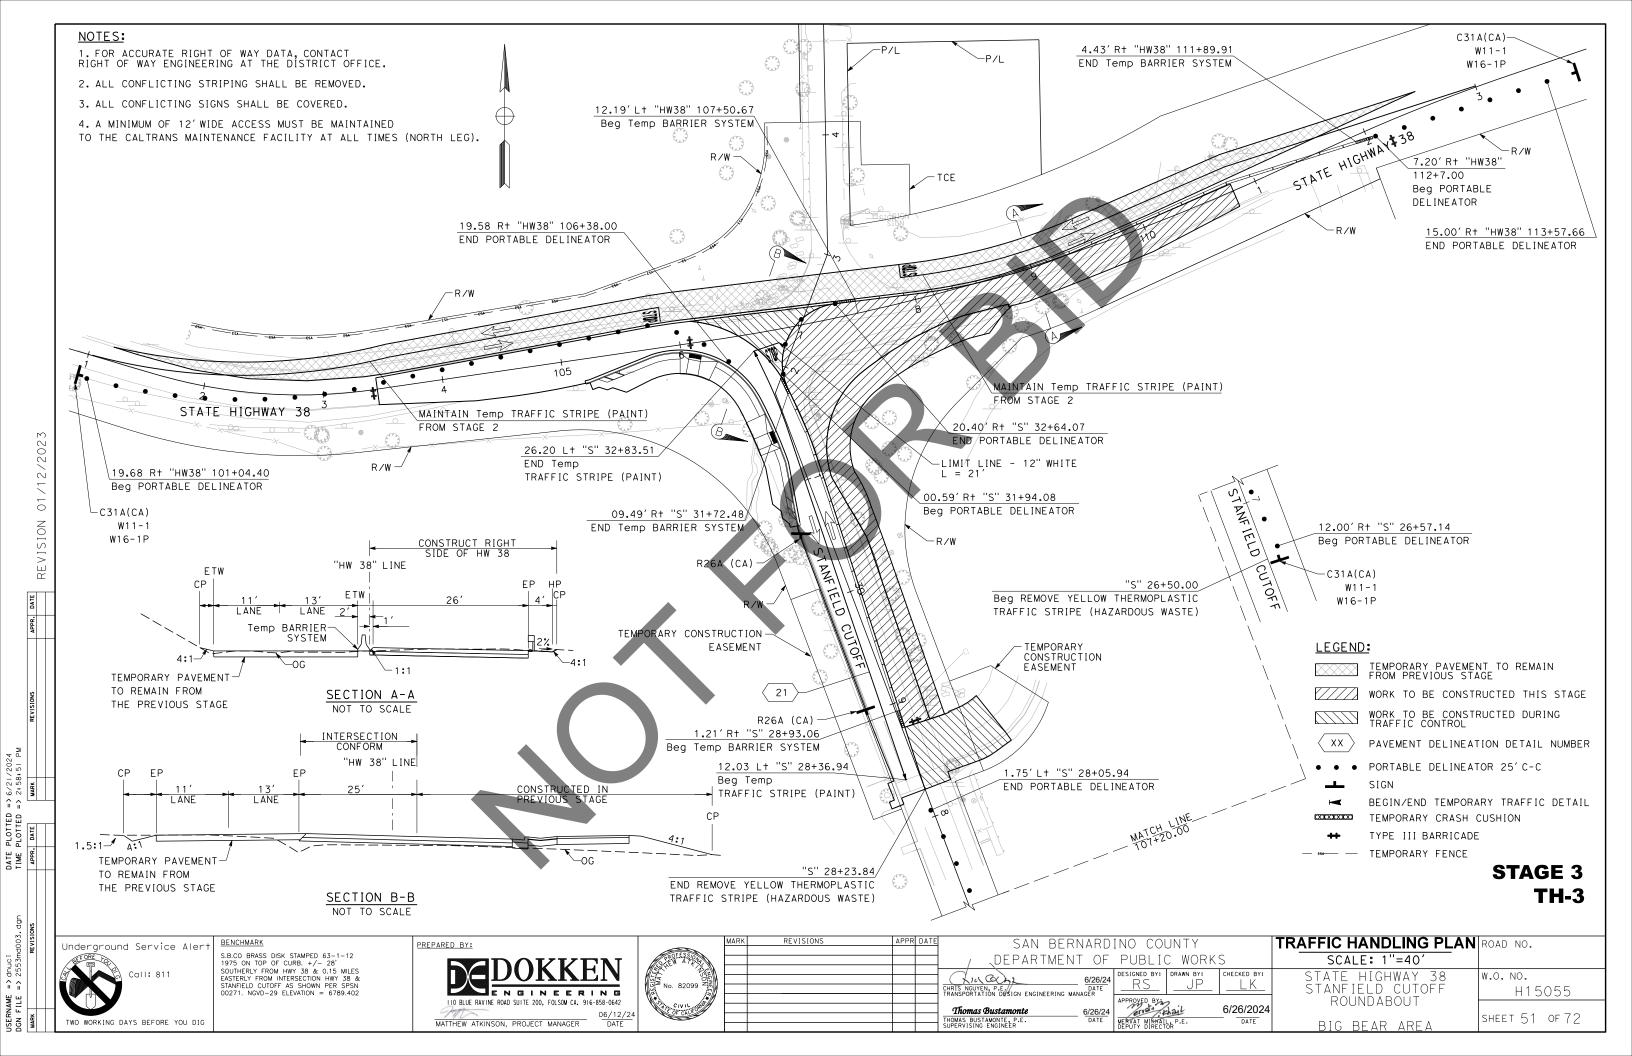

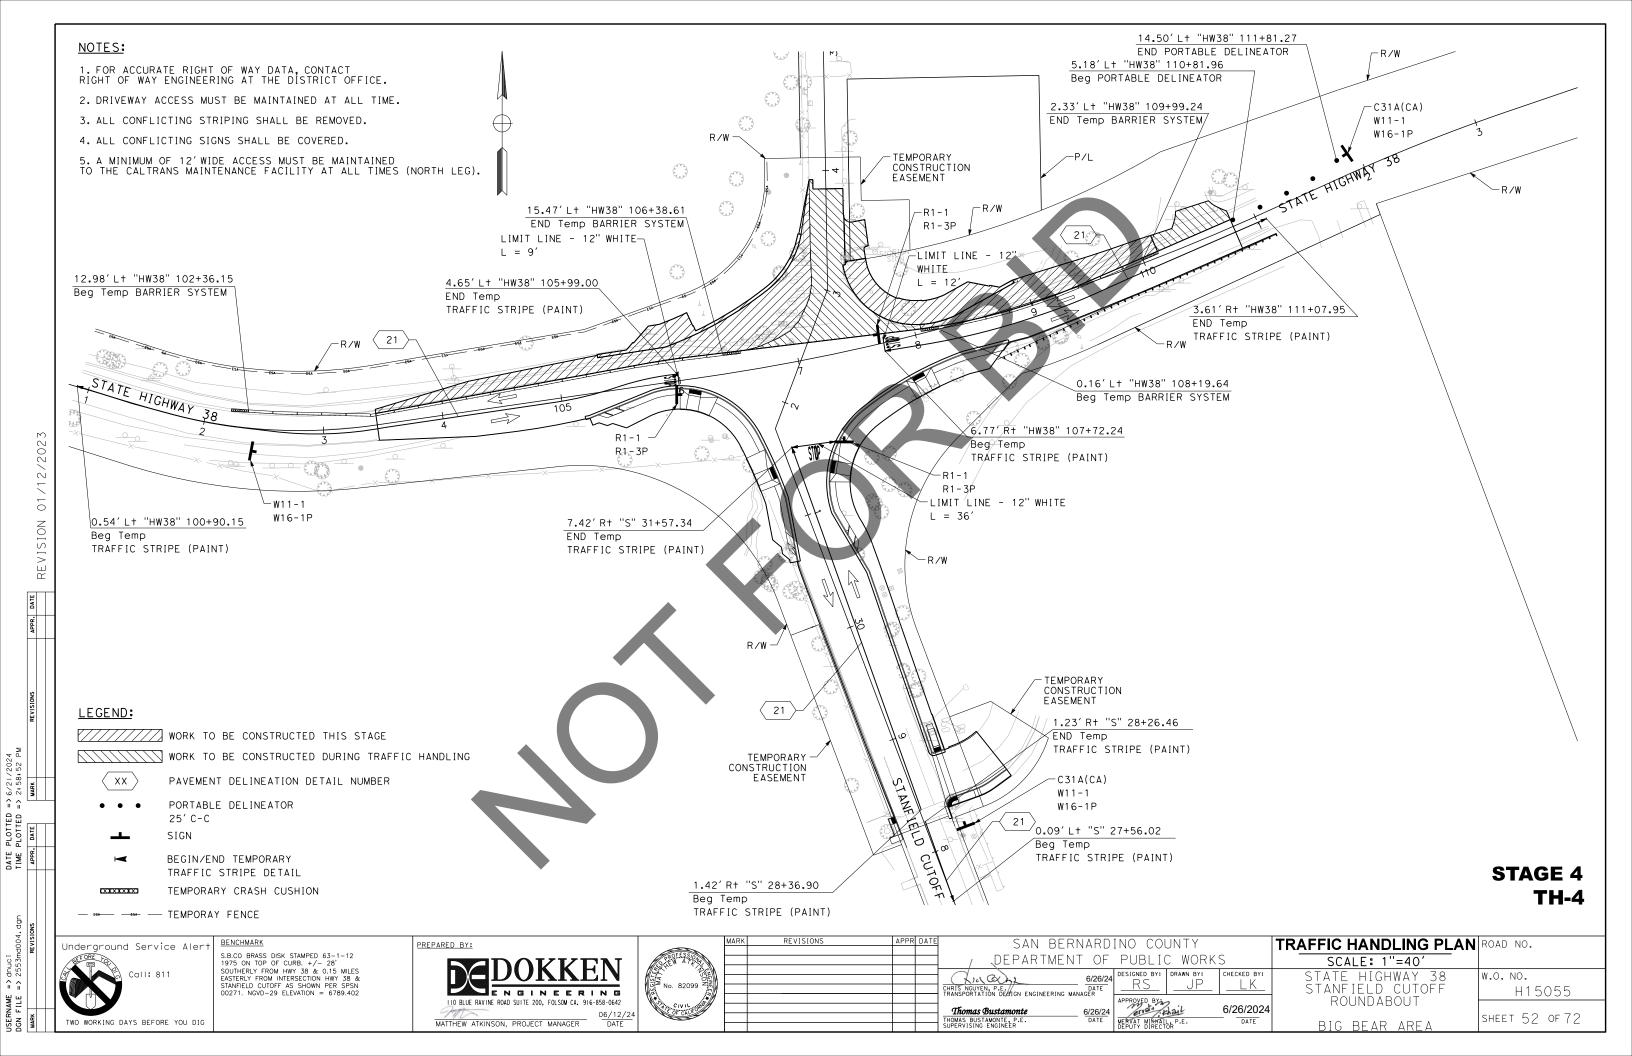

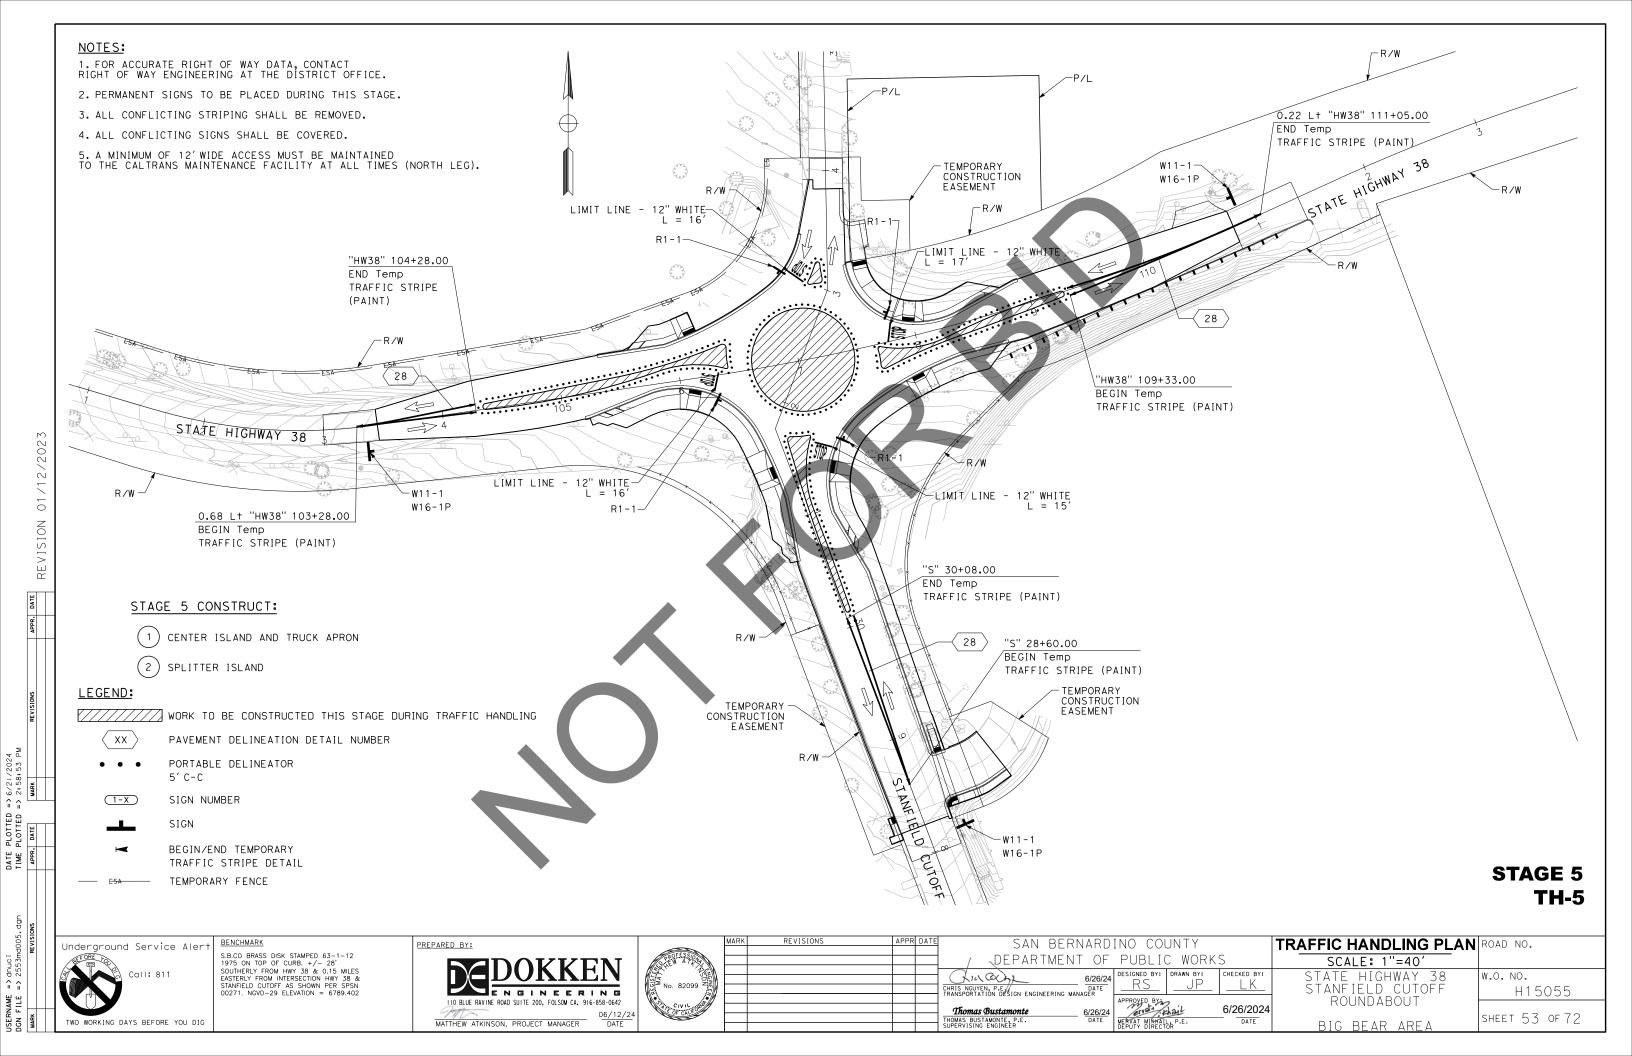

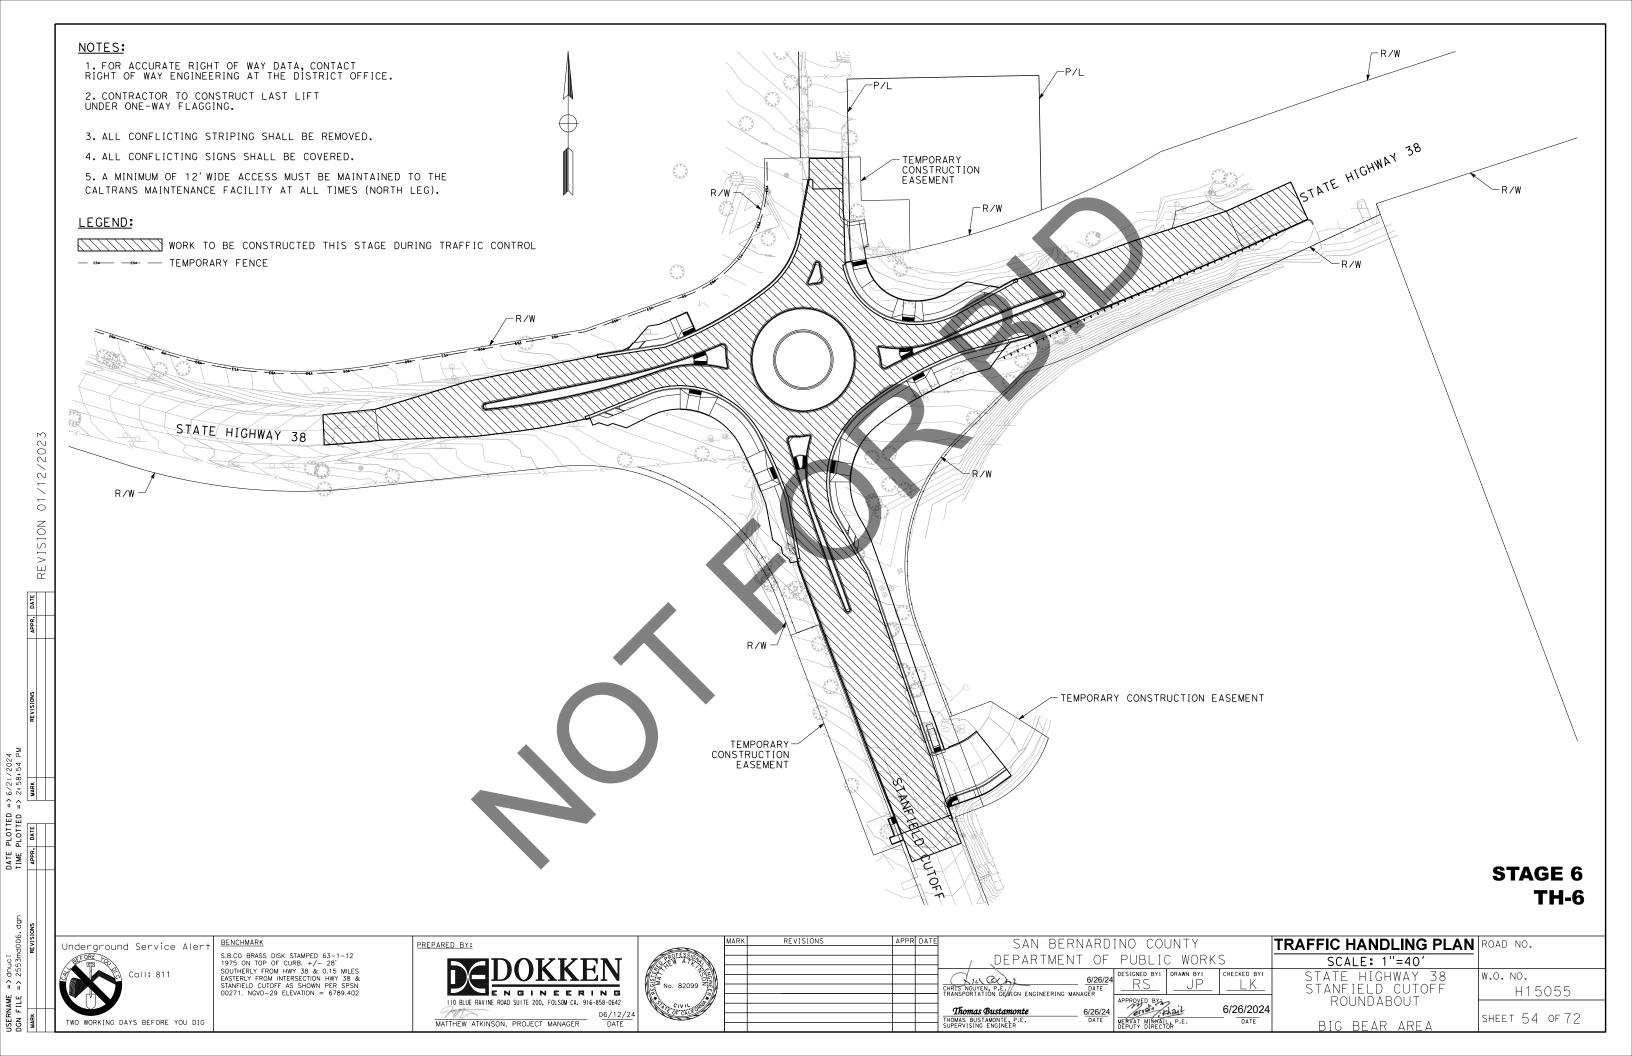

DGN FILE => 2553mf001, dgn MARK REVISIONS

TEMPORARY TRAFFIC STRIPES AND PAVEMENT MARKINGS

o	CT / CT			DETAIL :: 05	TEMPORARY TF (PA	RAFFIC STRIPE INT)	Temporary
SHEET	STAGE No.	STATION LIMITS	LOCATION	DETAIL NO. OR PAVEMENT MARKING	6" SOLID WHITE	6" SOLID YELLOW	Pavement Marking
					LF	LF	SQFT
		"HW38" 107+84 TO 113+17	CENTER	21		1072	
		"HW38" 107+84 TO 111+33	RIGHT	27B	354		
TH-1	1	"S" 31+75	RIGHT	STOP			22
10-1	'	"S" 31+75	RIGHT	LIMIT LINE (STOP LINE)			12
		"S" 27+65	RIGHT	STOP			22
		"S" 27+81	RIGHT	AHEAD			31
		"HW38" 101+06 TO 106+22	CENTER	21		1012	
		"HW38" 117+86 TO 113+00	CENTER	21		1014	
		"S" 26+55 TO 32+08	CENTER	21		1062	
		"HW38" 106+22	RIGHT	STOP			22
TH-2	2	"HW38" 106+22	RIGHT	LIMIT LINE (STOP LINE)			10
		"HW38" 117+86	LEFT	STOP			22
		"HW38" 117+86	LEFT	LIMIT LINE (STOP LINE)			10
		"S" 32+08	RIGHT	STOP			22
		"S" 32+08	RIGHT	LIMIT LINE (STOP LINE)			16
		"S" 28+36 TO 32+83	CENTER	21		760	
TH-3	3	"S" 32+83	RIGHT	STOP			22
		"S" 32+83	RIGHT	LIMIT LINE (STOP LINE)			21
		"HW38" 100+90 TO 106+00	CENTER	21		1020	
		"HW38" 107+72 TO 111+07	CENTER	21		680	
		"S" 27+56 TO 28+26	CENTER	21		142	
		"S" 28+36 TO 31+57	CENTER	21		642	
A		"HW38" 106+00	RIGHT	STOP			22
TH-4	4	"HW38" 106+00	RIGHT	LIMIT LINE (STOP LINE)			9
		"HW38" 107+72	RIGHT	STOP			22
		"HW38" 107+72	RIGHT	LIMIT LINE (STOP LINE)			12
		"S" 31+57	RIGHT	STOP			22
		"S" 31+57	RIGHT	LIMIT LINE (STOP LINE)			36
		"HW38" 103+28 TO 104+28	CENTER	28		400	
		"HW38" 109+33 TO 111+05	CENTER	28		634	
		"S" 28+60 TO 30+08	CENTER	28		592	
		"HW38" 106+24	RIGHT	STOP		Y	22
		"HW38" 106+24	RIGHT	LIMIT LINE (STOP LINE)			16
TH-5	5	"HW38" 107+85	LEFT	STOP			22
		"HW38" 107+86	LEFT	LIMIT LINE (STOP LINE)			17
		"S" 31+50	RIGHT	STOP			22
		"S" 31+51	RIGHT	LIMIT LINE (STOP LINE)			15
		"S" 33+12	LEFT	STOP			22
		"S" 33+12	LEFT	LIMIT LINE (STOP LINE)			16

TEMPORARY BARRIER SYSTEM

			· • · • · · ·	
SHEET No.	STAGE No.	STATION LIMITS	LOCATION	LF
		"HW38" 99+95 TO 106+81	LEFT	680
TH-1	1	"HW38" 107+95 TO 109+95	LEFT	200
1 1 1 1 1		"HW38" 111+00 TO 112+40	LEFT	140
		"S" 29+95 TO 31+35	RIGHT	240
TH-2	2	"HW38" 102+28 TO "S" 28+58	RIGHT	800
TH-3	3	"S" 28+93 TO 31+73	RIGHT	280
111-3		"HW38" 107+50 TO 111+90	RIGHT	440
TH-4	4	"HW38" 102+36 TO 106+38	LEFT	400
111-4	4	"HW38" 108+20 TO 110+00	LEFT	180
TOTAL				

PORTABLE DELINEATORS

SHEET No.	STAGE No.	STATION LIMITS	LOCATION	EA
		"HW38" 99+29 TO 99+76	LEFT	3
TH-1	1	"HW38" 112+95 TO 114+37	LEFT	8
		"S" 25+69 TO 28+16	RIGHT	12
		"HW38" 101+34 TO 102+07	LEFT	4
TH-2	2	"HW38" 107+11 TO 112+95	RIGHT	37
		"S" 26+08 TO 28+13	RIGHT	10
		"HW38" 101+04 TO 106+38	LEFT	23
TH-3	3	"HW38" 112+22 TO 113+73	RIGHT	7
IH-3	3	"S" 26+57 TO 28+06	RIGHT	7
		"S" 31+86 TO 32+64	RIGHT	5
TH-4	4	"HW38" 110+81 TO 111+81	LEFT	5
		"HW38"	WEST SPLITTER ISLAND	92
		"HW38"	EAST SPLITTER ISLAND	74
TH-5	5	"S"	SOUTH SPLITTER ISLAND	70
		"S"	NORTH SPLITTER ISLAND	13
		"S"	CENTER ISLAND	58
		TOTAL		428

TYPE III BARRICADE

SHEET No.	STAGE No.	STATION LIMITS	LOCATION	EΑ
		"HW38" 102+80	RIGHT	1
TH√2	2	"HW38" 111+05	RIGHT	1
		"S" 27+85	LEFT	1
	3	"HW38" 103+40	RIGHT	1
T11 7		"HW38" 110+90	RIGHT	1
TH-3		"HW38" 106+18	RIGHT	1
		"S" 28+78	RIGHT	1
TOTAL				

TEMPORARY HIGH-VISIBILITY FENCE

SHEET No.	STAGE No.	STATION LIMITS	LOCATION	LF
TH-1	1	"HW38" 100+91 TO 34+10	LEFT	650
		TOTAL		650

TEMPORARY CRASH CUSHION

SHEET No.	STAGE No.	STATION LIMITS	LOCATION	EΑ
		"HW38" 99+81	LEFT	1
		"HW38" 106+51	LEFT	1
		"HW38" 107+81	LEFT	1
TH-1	1	"HW38" 109+94	LEFT	1
10-1		"HW38" 111+00	LEFT	1
		"HW38" 112+40	LEFT	1
		"S" 25+81	RIGHT	1
		"S" 31+35	RIGHT	1
TH-2	2	"HW38" 102+14	RIGHT	1
IH-Z		"S" 28+44	LEFT	1
		"HW38" 107+36	RIGHT	1
TH-3	3	"HW38′111+90	RIGHT	1
1H-3)	"S" 28+79	RIGHT	1
		"S" 31+72	RIGHT	1
		"HW38" 102+22	LEFT	1
TII 4	_ ["HW38" 106+39	LEFT	1
TH-4	4	"HW38" 108+05	LEFT	1
		"HW38" 109+99	LEFT	1
TOTAL				

THQ-1

nderground Service Alert

TWO WORKING DAYS BEFORE YOU DIG

S.B.CO BRASS DISK STAMPED 63-1-12
1975 ON TOP OF CURB. +/- 28'
SOUTHERLY FROM HWY 38 & 0.15 MILES
EASTERLY FROM INTERSECTION HWY 38 &
STANFIELD CUTOFF AS SHOWN PER SPSN
00271. NGVD-29 ELEVATION = 6789.402

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IIO BLUE RAVINE ROAD SUITE 200, FOLSOM CA. 916-088-0642

MATTHEW ATKINSON, PROJECT MANAGER


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DATE



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ΤE	SAN BERNARD:	INO COL	YTNL		TR
	/ _DEPARTMENT OF	PUBLI(C WORK	S	
	CHRIS NGUYEN, P.E. DATE TRANSPORTATION DESIGN ENGINEERING MANAGER	DESIGNED BY:	DRAWN BY:	CHECKED BY:	
	Thomas Bustamonte THOMAS BUSTAMONTE, P.E. SUPERVISING ENGINEER DATE	MERVAT MIKHALI DEPUTY DIRECT	hail ōk P.E.	6/26/2024 DATE	

RAFFIC HANDLING QUANTITIES	ROAD NO.
NO SCALE	
STATE HIGHWAY 38	W.O. NO.
STANFIELD CUTOFF	H15055
ROUNDABOUT	CUEET EE 05.70
BIG BEAR AREA	SHEET 55 OF 72



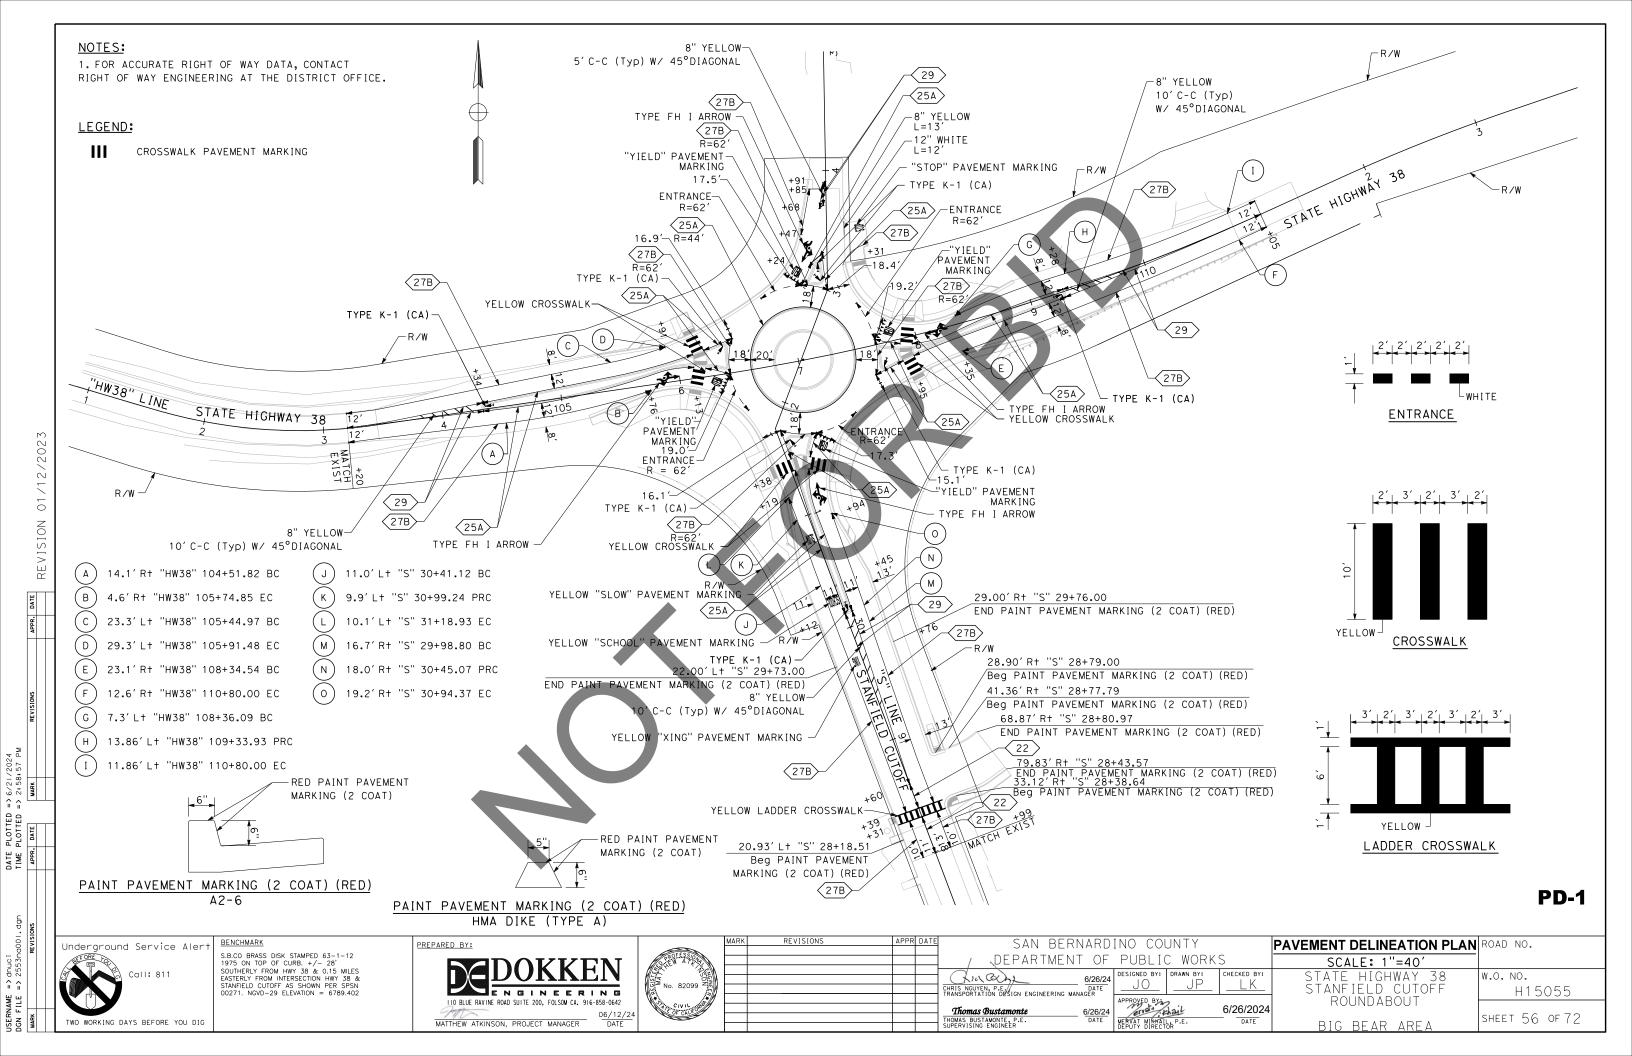

<u>BENCHMARK</u>

S.B.CO BRASS DISK STAMPED 63-1-12 1975 ON TOP OF CURB. +/- 28' SOUTHERLY FROM HWY 38 & 0.15 MILES EASTERLY FROM INTERSECTION HWY 38 & STANFIELD CUTOFF AS SHOWN PER SPSN 00271. NGVD-29 ELEVATION = 6789.402

PREPARED BY: MATTHEW ATKINSON, PROJECT MANAGER



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REVISIONS

APPR	DATE	SAN BERNARDINO COUNTY
		SAN BERNARBING COOKIT
		/ "DEPARTMENT OF PUBLIC WORKS
		DESIGNED BY: DRAWN BY: CHECKED BY:
		6/26/24 DESIGNED BI: DRAWN BI: CHECKED BI:
		CHRIS NGUYEN, P.E. / DATE TRANSPORTATION DEDIGN ENGINEERING MANAGER
		APPROVED BY
		Thomas Bustamonte 6/26/24 6/26/2024
		THOMAS BUSTAMONTE, P.E. DATE MERVAT MIKHAIL, P.E. DATE
		MERVAI MIRHAIL, F.C.

PD QUANTITIES
NO SCALE
STATE HIGHWAY 38 STANFIELD CUTOFF ROUNDABOUT

BIG BEAR AREA

W.O. NO. H15055


ROAD NO.


SHEET 57 OF 72

PAVEMENT DELINEATION QUANTITIES

	THERMOPL	ASTIC TRAF	FIC STRIPE					THERM	OPLASTIC P	PAVEMENT M	ARK ING						IT MARKER LECTIVE-		
		6''															RECESSED		
LOCATION	DETAIL 27B	DETAIL 25B	DETAIL 29	8" YELLOW	12" WHITE	YIELD LINE	"WELD"	"SLOW" (YELLOW)	"SCHOOL" (YELLOW)	"XING" (YELLOW)	"STOP"	ENTRANCE	CROSSWALK	CROSSWALK (YELLOW)	TYPE FH I ARROW	TYPE D	ТҮРЕ Н	PAINT PAVEMENT MARKING (2 COAT)	
	LF	LF	LF	SQFT	SQFT	SQFT	SQFT	SQFT	SQFT	SQFT	SQFT	SQFT	SQFT	SQFT	SQFT	EΑ	EΑ	SQFT	
"HW38" WEST	551	683	227	23		18	24					18	120		50	21	15		
"HW38" EAST	572	316	336	23		18	24					18	120		50	30	8		
"S" SOUTH	475	297	308	36		18	24	23	32	21		20	120	262	50	28	7	331	
"S" NORTH	74	52	42	23	12	18	24				22	12			50	6	2		
TOTAL	TOTAL 3933								12	273						1	16	331	

PDQ-1

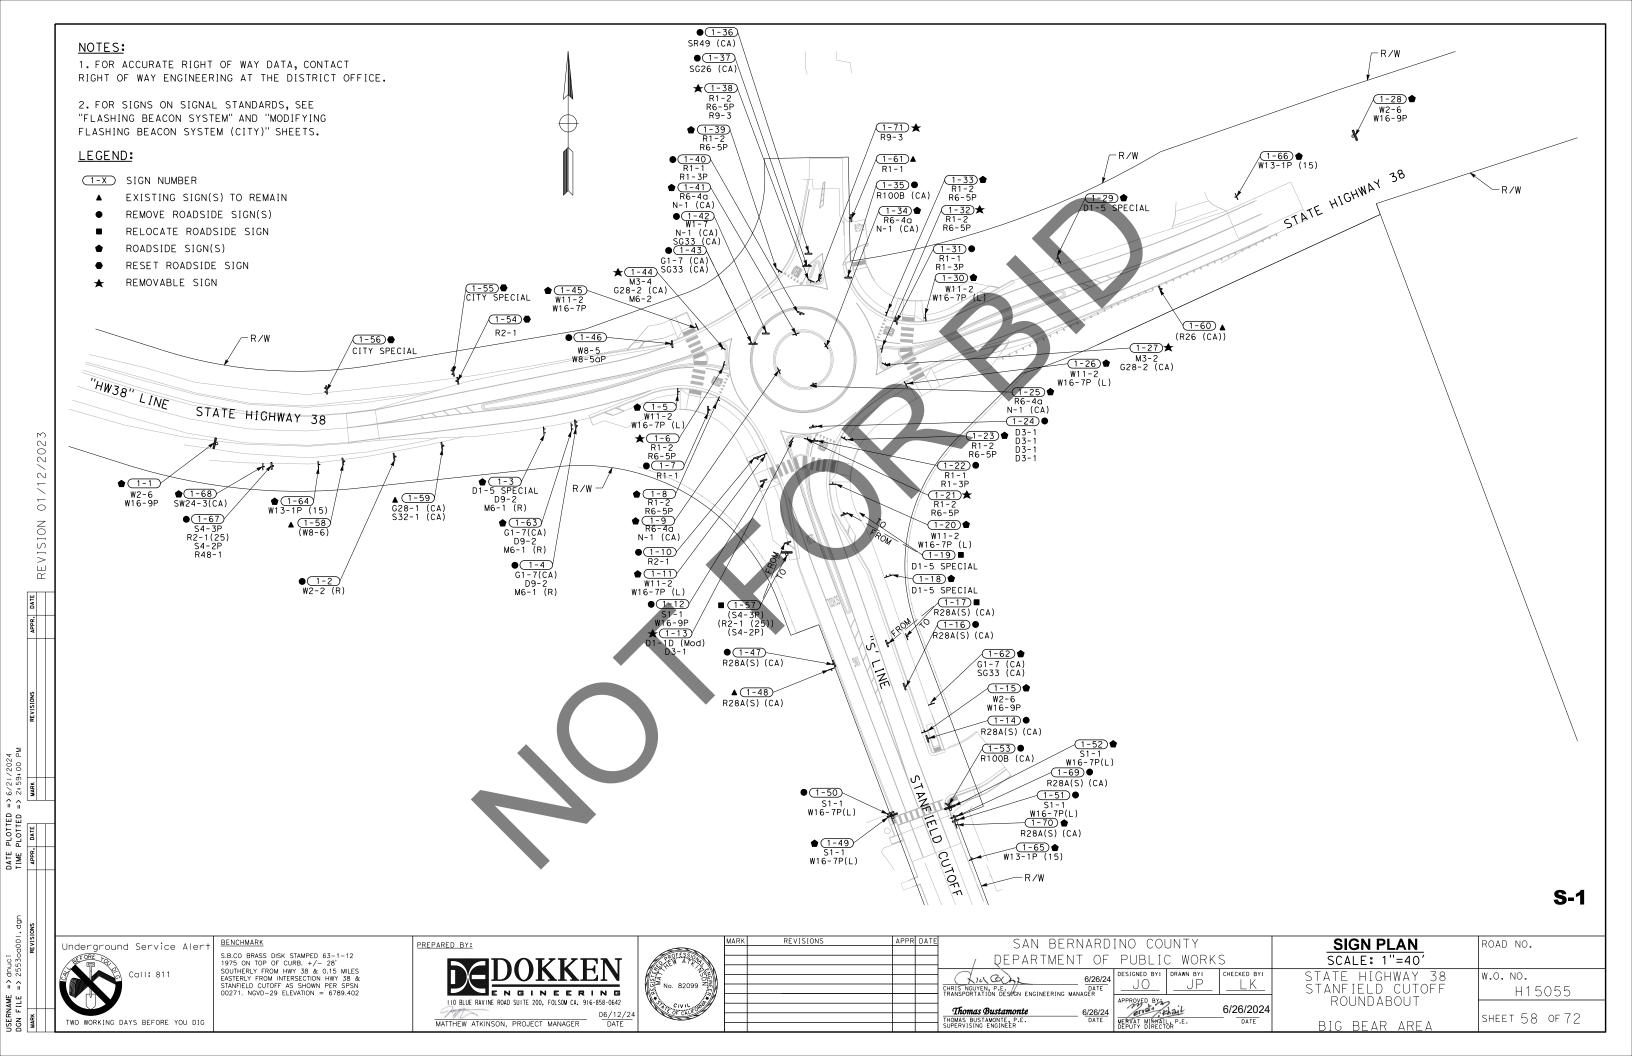

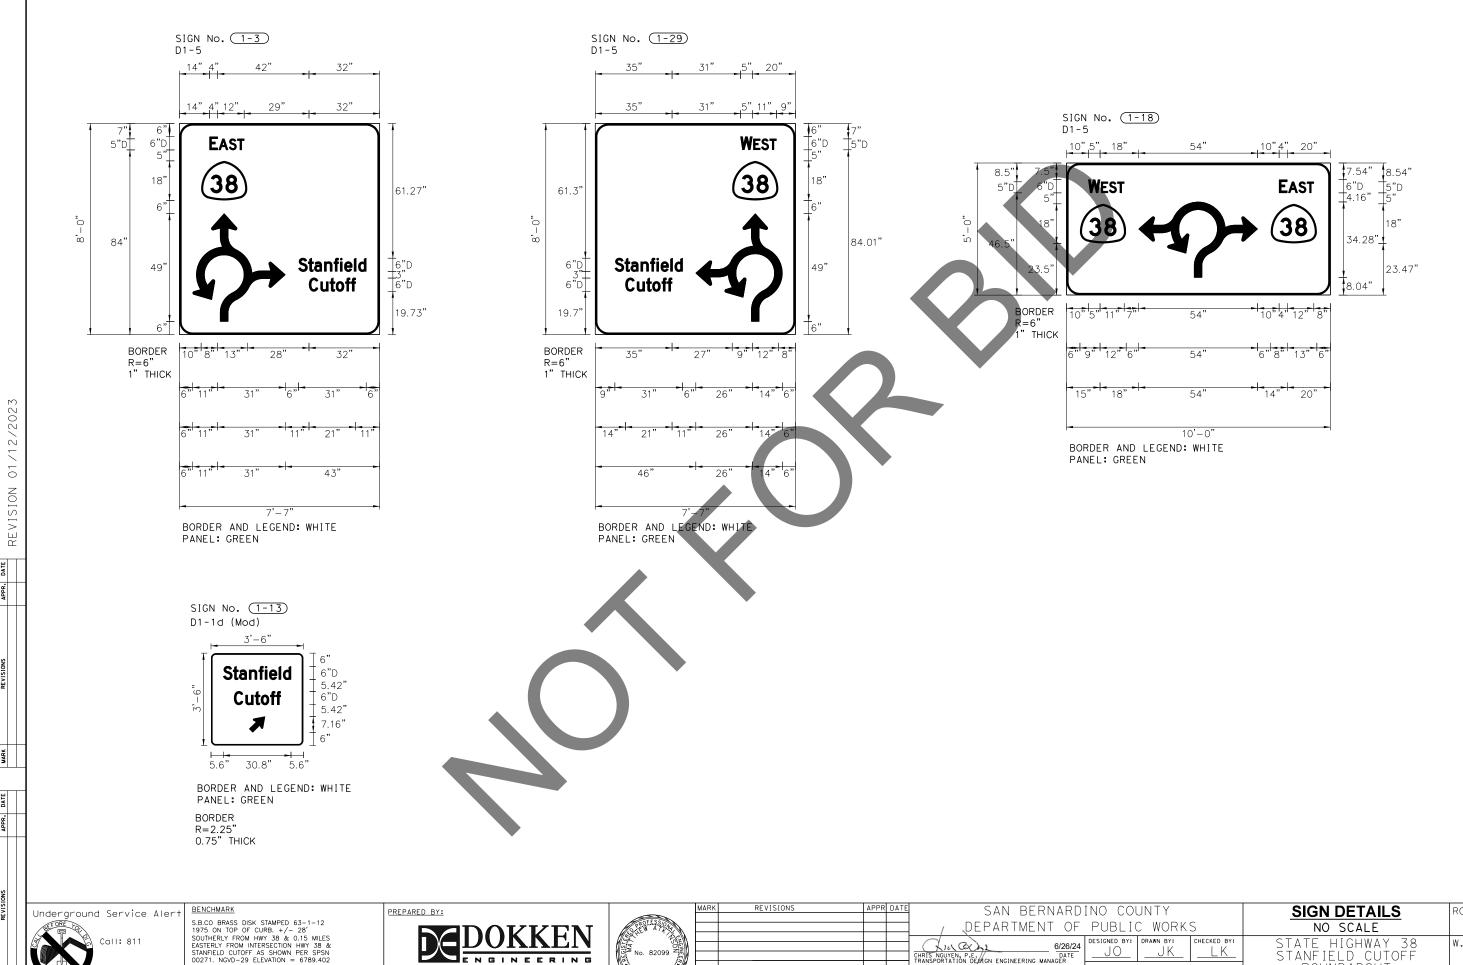

SD-1

TWO WORKING DAYS BEFORE YOU DIG

01/12/2023

DATE PLOTTED => 6/21/2024
TIME PLOTTED => 2:59:01 PM
APPR. DATE

S.B.CO BRASS DISK STAMPED 63-1-12 1975 ON TOP OF CURB. +/- 28' SOUTHERLY FROM HWY 38 & 0.15 MILES EASTERLY FROM INTERSECTION HWY 38 & STANFIELD CUTOFF AS SHOWN PER SPSN 00271. NGVD-29 ELEVATION = 6789.402

MATTHEW ATKINSON, PROJECT MANAGER



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SAN BERNARD	INO COUNTY	SIGN DETAILS	ROAD NO.
/ DEPARTMENT OF	PUBLIC WORKS	NO SCALE	
RIS NGUYEN, P.E. DATE ANSPORTATION DEPTON ENGINEERING MANAGER	DESIGNED BY: DRAWN BY: CHECKED BY:	STATE HIGHWAY 38 STANFIELD CUTOFF	W.o. No. H15055
Thomas Bustamonte OMAS BUSTAMONTE, P.E. PERVISING ENGINEER 6/26/24 DATE	APPROVED BY: MERVAT MIRHAEL P.E. DEPUTY DIRECTOR APPROVED BY: APPROV	ROUNDABOUT BIG BEAR AREA	SHEET 59 OF 72

2. MINIMUM POST LENGTHS WERE CALCULATED ASSUMING A LEVEL GROUND SURFACE FROM THE EP.

ENSURE C DIMENSION IS MET. POST LENGTHS MAY VARY DUE TO SITE CONDITIONS.

3. EXACT LOCATIONS OF SIGNS AND POSTS SHALL BE DETERMINED BY THE ENGINEER.

ROADSIDE SIGN QUANTITIES

SINGLE 2-POST POST SIGN SIGN

																		<i>-</i>									
	BACKGROUND								LE	EGEND	1																
		PAN SI.			POST	PO	ST SI	IZE		SIDE GN	E SIGN	ROADSIDE POST	ADSIDE POST	T ROADSIDE (TWO POST)	ROADSIDE	WOOD	FU	FURNISH SINGLE SHEET ALUMINUM SIGN		L SIGN ND SAD METHC	COLOR	ECTIVE	AC L	ASTM		≥	
		Horiz	Vert	•	MINIMUM F LENGTH	44	46		ONE POST	TWO POST	REMOVABL	RELOCATE SIGN-ONE	RESET ROADSIDE SIGN (ONE POST)	RESET RO SIGN (TWC	REMOVE R	TREATED WASTE	(RAMED n)	FRA (i	n)	INSTALL SIGN (STRAP AND SADDLE BRACKET METHOD)	SHEE TING CO	RETRO-REFLECTIVE ASTM TYPE	LEGEND COLOR	REFLECTIVE TYPE	BLACK (NON- REFLECTIVE)	PREMIUM FILM OVERLAY
SIGN No.	CODE	in	· in	C ft	_ ≥ f +	-	4×6 n x i		0 11	H &	LE.	EA	1 12 0	1 12 01	1 6 0	LB	0.063		0.063 QFT	0.08	EA	SHE	YET AST	EG	7 KF	3LA 3EF	# # # #
	W2-6	30	30	7.0	- ' '	ti	<u> </u>	H				I	I	Τ	T			<u></u>	T	$\overline{}$	1	YELLOW	IX	BLACK	XI	X	X
1-1	W16-9P	30	18	1.0	5.0	X															1	YELLOW	XI	BLACK	-	X	X
1-2	W2-2 (R)														1	26.07											
	D1-5 SPECIAL	96	78	7.0	19.5			Х		1									3.52			GREEN	ΙX	WHITE	ΧI		Х
1-3	D9-2	24	24																			BLUE	ΙX	WHITE	ΧI		X
	M6-1 (R)	21	15			\vdash										06.07						BLUE	ΧI	WHITE	ΧI		X
1-4	G1-7(CA) D9-2					\vdash									1	26.07							-				+
, 1-4 -	M6-1 (R)					\vdash								+	+						-						+
-	W11-2	36	36	7.0	14.5	+	Х		1												1	FLUOURESCENT YELLOW-GREEN	XI	BLACK	+ -	X	X
1-5	W16-7P (L)	36	36		11.5									1								FLUOURESCENT YELLOW-GREEN	XI	BLACK	+ -	X	X
	R1-2	36	36	7.0							1						9.00					WHITE	IX	RED	ΙXΙ		X
1-6	R6-5P	30	30														6.25					WHITE	ΙX	BLACK	_	Х	X
1 – 7	R1-1														1	26.07											
1-8	R1-2	36	36	7.0					1								9.00					WHITE	ΙX	RED	ΧI		Х
	R6-5P	30	30														6.25					WHITE	IX	BLACK	-	X	X
1-9	R6-4a	48	24	7.0											4			8.00				WHITE	IX	BLACK	-	X	X
	N-1 (CA)	18	18		5.0	X			1						14							YELLOW	ΧI	-	-		X
1-10	R2-1	7.0	7.0	7.0	1 / 5	\vdash			1						+ 1							FLUOURESCENT YELLOW-GREEN	VI	DI ACK		V	+
1-11	W11-2 W16-7P (L)	36 36	36 36	7.0	14.5		X															FLUOURESCENT YELLOW-GREEN	IX	BLACK BLACK	+-	X	X
-	S1-1	36	26												1							FLOODRESCENT TELLOW-GREEN	^1	DLACK	+-		 ^
1-12	W16-9P					\vdash									+ '-								-				-
	D1-1d (Mod)	60	18	7.0	13.0	\Box	X				1											GREEN	1 XI	WHITE	ΙXΙ		X
1-13	D3-1	VAR	18		1 3.3	\Box																GREEN	XI	WHITE	XI		X
1-14	R28A(S) (CA)														1												
1-15	W2-6	30	30	7.0																		YELLOW	ΧI	BLACK	ΧI	X	Х
1-13	W16-9P	30	18		5.0	Х			1													YELLOW	ΙX	BLACK	-	Х	Х
1-16	R28A(S) (CA)														1												
1-17	R28A(S) (CA)											1	7						<u> </u>								\perp
	D1-5 SPECIAL	96	78	7.0	19.5			X		1		ļ .	7						3.52			GREEN	ΧI	WHITE	ΧI		X
1-19	CITY SPECIAL	,	7.0	7.0	1 4 5	\vdash	.,	\vdash				1										FLUOUDECOENT VELLOW ORSES	VT	DI ACK	-		+
1-20	W11-2 W16-7P (L)	36 36	36 36	1.0	14.5	\vdash	X	\vdash						4	+	-						FLUOURESCENT YELLOW-CREEN	IX	BLACK BLACK	-	X	X
	R1-2	36	36	7.0		\vdash	X	1			1			+	+		9.00					FLUOURESCENT YELLOW-GREEN WHITE	IX	RED	XI	_ ^	X
1-21	R6-5P	30	30	1.0		\vdash	 ^	\vdash							+		6.25					WHITE	IX	BLACK	- ^1	Х	T X
$\overline{}$	R1-1		- 50												1	26.07	10.23					,,,,,,,,,,,,,,,,,,,,,,,,,,,,,,,,,,,,,,	1	DEAGN	1		
1-22	R1-3P														<u> </u>												
1 27	R1-2	36	36	7.0			Х		1								9.00					WHITE	ΙX	RED	ΧI		X
1-23	R6-5P	30	30						4								6.25					WHITE	ΙX	BLACK	_	Х	X

<u>BENCHMARK</u> S.B.CO BRASS DISK STAMPED 63-1-12
1975 ON TOP OF CURB. +/- 28'
SOUTHERLY FROM HWY 38 & 0.15 MILES
EASTERLY FROM INTERSECTION HWY 38 &
STANFIELD CUTOFF AS SHOWN PER SPSN
00271. NGVD-29 ELEVATION = 6789.402

MATTHEW ATKINSON, PROJECT MANAGER



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	MENT	WALLY TELEVISIONS	WALLY STONG ATT	MATTIN TO THE TOTAL THE TOTAL TO THE TOTAL THE TOTAL TO T

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1	/ DEPARTMENT	T OF	PUBLI	C WORK	S	_
	CHRIS NGUYEN, P.E. TRANSPORTATION DESIGN ENGINEERING MAN	6/26/24 DATE	DESIGNED BY:	DRAWN BY:	CHECKED BY:	
	Thomas Bustamonte THOMAS BUSTAMONTE, P.E.	6/26/24 DATE	APPROVED BY:	hail L. P.E.	6/26/2024	

SIGN QUANTITIES	ROAD NO.
NO SCALE	
STATE HIGHWAY 38	W.O. NO.
STANFIELD CUTOFF ROUNDABOUT	H15055
ROUNDABOUT	
BIG BEAR AREA	SHEET 60 OF 72

SQ-1

01/12/2023

REVISION

TWO WORKING DAYS BEFORE YOU DIG

01/12/2023

REVISION

DATE PLOTTED => 6/21/2024
TIME PLOTTED => 2:59:03 PM
APPR. DATE

1. FEDERAL MANUAL ON TRAFFIC CONTROL DEVICES (MUTCD) SIGN CODES ARE SHOWN UNLESS DESIGNATED (CA) INDICATING CALIFORNIA SIGN SPECIFICATIONS

2. MINIMUM POST LENGTHS WERE CALCULATED ASSUMING A LEVEL GROUND SURFACE FROM THE EP.
ENSURE C DIMENSION IS MET. POST LENGTHS MAY VARY DUE TO SITE CONDITIONS.

3. EXACT LOCATIONS OF SIGNS AND POSTS SHALL BE DETERMINED BY THE ENGINEER.

ROADSIDE SIGN QUANTITIES

)E) E	BACKGROUND		I.E	GEND		
			NE L I ZE		POST	P0:	ST SI	ZE	ROADS SIG		SIGN	ROADSIDE POST	DSIDE POST)	T ROADSIDE (TWO POST)	ROADSIDE	WOOD	FURNISH ALUMI	SINGLE S NUM SIGN		SIGN D SADDLE METHOD)	00 8	CTIVE		ASTM		
		z	+		MINIMUM PC LENGTH				⊢		OVABLE	RELOCATE SIGN-ONE	RESET ROADSIDE SIGN (ONE POST)	ET ROA N (TWO	REMOVE RO	TREATED W WASTE	UNFRAMED (in)		MED	INSTALL S	ING COL	-REFLE TYPE	D COLOR	REFLECTIVE TYPE	(NON- CTIVE)	JM FILM AY
SIGN No.	CODE	J. Horiz	J. Ver	C ft	T W I N		4x6		POS	POS	REMOV,	REL SIGI	RES SIGI	RESE	REM	MAS WAS	0.063 0.08	0.063	0.08	EA (STI	SHEETING	RETRO.	LEGEND	REFLE TYPE	BLACK REFLE(PREMIUM OVERLAY
	D3-1					Ï									1											\dagger
1-24	D3-1 D3-1																									\vdash
	D3-1																									
1-25	R6-4a	48	24	7.0													8.00				WHITE	IX	BLACK	_	X	X
	N-1 (CA)	18	18	7.0	5.0				1										, , , , , , , , , , , , , , , , , , ,		YELLOW	XI	- DI ACK	_	- V	X
1-26	W11-2 W16-7P (L)	36 36	36 36	7.0	14.5		X		1												FLUOURESCENT YELLOW-GREEN FLUOURESCENT YELLOW-GREEN	IX	BLACK BLACK		X	X
i	M3-2	36	18	7.0	12.0	X		\vdash			1					1					GREEN	XI	WHITE	IX	 ^	+ x
1-27				1		 					-							7			J E E 11	 		.,,		<u> </u>
	M6-2	21	15														2.19				WHITE	ΙX	BLACK	_	X	Х
1-28	W2-6	30	30	7.0																1	YELLOW	ΧI	BLACK	ΧI	X	X
	W16-9P	30	18	<u> </u>	5.0													_		1	YELLOW	ΧI	BLACK	_	X	X
1-29		96	78		19.5		.,	Х	4	1					1			3.52			GREEN	XI	WHITE	ΧI		X
1-30	W11-2 W16-7P (L)	36 36	36 36	7.0	14.5		Х		1												FLUOURESCENT YELLOW-GREEN FLUOURESCENT YELLOW-GREEN	XI	BLACK BLACK	-	X	X
1-31	R1-1	36	36												1	26.07					FLOOURESCENT TELLOW-GREEN		BLACK			
	R1-3P R1-2	7.0	7.0	7.0							1						0.00	+			WILLE	TV	חבה	V 1		
1-32	R6-5P	36 30	36 30	7.0			X				-						9.00 6.25	+			WHITE WHITE	IX	RED BLACK	IX -	X	X
	D1 = 2	36	36	7.0			Х		1					— —			9.00				WHITE	IX	RED	IX	 ^	 ^
1-33	R6-5P	30	30	1													6.25				WHITE	IX	BLACK	-	×	X
1-34	R6-4a	48	24	7.0													8.00				WHITE	ΙX	BLACK	-	Х	Х
	N-1 (CA)	18	18		5.0	X			1		4				4						YELLOW	ΧI	-	_		X
1-35				1					-						1	26.07		1				-				—
1-36 1-37										-4					1 1	26.07 26.07		+				-				-
1-31	R1-2	36	36	7.0			X				1				<u> </u>	20.07	9.00	+			WHITE	IX	RED	IX		X
1 - 38		30	30	1.0							\mathcal{A}						6.25				WHITE	IX	BLACK	-	X	T X
	R9-3	18	18														2.25	1			WHITE	IX	RED/BLK	IX		X
1-39	R1-2	36	36	7.0			Х		1								9.00				WHITE	IX	RED	ΙX		Х
1 39	R6-5P	30	30	L .							\perp				 	00.5-	6.25				WHITE	IX	BLACK	-	Х	X
1-40	R1-1 R1-3P			5.0							\dashv				1	26.07		+	-							_
	R6-4a	48	24	7.0			_										8.00				WHITE	IX	BLACK	_	X	X
1-41	N-1 (CA)	18	18	1.0	5.0	X			1		\dashv						0.00				YELLOW	XI	- BLACK	-	 ^	^
	W1 - 7	· •			1,0						-+				1	26.07						† ^ `				<u> </u>
1-42																										1
1 17	C1 - 7(CA)										-+				1	26.07										+-
1-43	SG33 (CA)																									
	M3-4	24	12	7.0	11.5	X					1										BLUE	ΧI	WHITE	ΧI		Х
1-44		31	30															1			GREEN	XI	WHITE	ΧI	ļ.,	X
	M6-2	21 36	15	7 ^	14.5				1						1		2.19	1	-		WHITE	IX	BLACK	-	X	X
1-45	W11-2 W16-7P (L)	36	36		14.5		X		1		\dashv				-			+	-		FLUOURESCENT YELLOW-GREEN FLUOURESCENT YELLOW-GREEN	IX	BLACK BLACK	 -	X	X
<u> </u>	WQ_5	"	30								\dashv				1			1			I LOCONESCENT TELLOW GIVEEN	1 1	DLACK		 ^	
1-46	W8-5aP													-	+	l		+	1	1		+	1	 		+-

SQ-2

Underground Service Alert

TWO WORKING DAYS BEFORE YOU DIG

<u>BENCHMARK</u> S.B.CO BRASS DISK STAMPED 63-1-12 1975 ON TOP OF CURB. +/- 28' SOUTHERLY FROM HWY 38 & 0.15 MILES EASTERLY FROM INTERSECTION HWY 38 & STANFIELD CUTOFF AS SHOWN PER SPSN 00271. NGVD-29 ELEVATION = 6789.402 PREPARED BY: MATTHEW ATKINSON, PROJECT MANAGER



	DATE	APPR	REVISIONS	MARK	
/					
\neg					
(101					
CHRIS NGUYEN, TRANSPORTATIO					
THAILST STITATE					
Thomas B					
THOMAS BUSTAN					
SUPERVISING E		1		1	

SAN BERNA	RD:	INO COL	YTNL		
/ QEPARTMENT	OF	PUBLI(C WORK	S	_
() - (- · · · · · · · · · · · · · · · · ·	/26/24 ATE	DESIGNED BY:	DRAWN BY:	CHECKED BY:	
as Bustamonte 6/2	26/24	APPROVED BY	hail	6/26/2024	
BUSTAMONTE, P.E. D SING ENGINEER	ATE	MERVAT MIKHALI DEPUTY DIRECT	L, P.E. OR	DATE	

SIGN QUANTITIES	ROAD NO.
NO SCALE	
STATE HIGHWAY 38 STANFIELD CUTOFF	w.o. No. H15055
ROUNDABOUT	
RIG REAR AREA	SHEET 61 OF 72

2. MINIMUM POST LENGTHS WERE CALCULATED ASSUMING A LEVEL GROUND SURFACE FROM THE EP. ENSURE C DIMENSION IS MET. POST LENGTHS MAY VARY DUE TO SITE CONDITIONS.

3. EXACT LOCATIONS OF SIGNS AND POSTS SHALL BE DETERMINED BY THE ENGINEER.

ROADSIDE SIGN QUANTITIES

1-49 W16-7P(L) 24 12 1 1 FLUOURESCENT YELLOW-GREEN XI 1-50 S1-1			X X X X X X X X X X X X X X X X X X X	X X X X X X X X X X X X X X X X X X X
SIGN CODE IN IN THE PRICE SET SET SET SET SET SET SET SET SET SE	RED XI BLACK BLACK BLACK BLACK BLACK	REFLECTIVE TYPE	X X X X X X X X X X X X X X X X X X X	X X X X X X X X X X X X X X X X X X X
No. CODE in in ft ft in x in EA LB SOET EA	RED XI BLACK BLACK BLACK		X X X X X X X X X X X X X X X X X X X	X X X X X X X X X X X X X X X X X X X
NO. CODE in in ff ff in x in EA LB SOFT EA	RED XI BLACK BLACK -		X X X	XXXXX
1-47 R28A(S) (CA)	RED XI BLACK BLACK -		X X X	XXXXX
1-48 R28A(S) (CA) 24 30 7.0 13.0 1 1-49 S1-1 30 30 7.0 14.0	BLACK -		X	X
1-49	BLACK -	-	X	X
Mid-7P(L) 24 12	BLACK -	-	X	X
1-50	BLACK	-	X	X
1-50		-		
1-51		-		
1-52		-		
1-52 W16-7P(L) 24 12		-		
1-53 R100B (CA) 1-54 R2-1 7.0 1-55 CITY SPECIAL 1-56 CITY SPECIAL 1-57 R2-1 S4-2P 1-58 W8-6 1-50 G28-1 (CA)	SLACK -	-	 	X
1-54 R2-1 7.0 1-55 CITY SPECIAL 1-56 CITY SPECIAL 1-57 R2-1 1-57 R2-1 1-58 W8-6 1-50 G28-1 (CA)				
1-55 CITY SPECIAL 1-56 CITY SPECIAL 1-57 R2-1 1-58 W8-6 1-50 G28-1 (CA)			1	+
1-56 CITY SPECIAL S4-3P 7.0 1-57 R2-1 S4-2P 1-58 W8-6 1-50 G28-1 (CA)	I			X
S4-3P 7.0 1 1 1 1 1 1 1 1 1				1 ×
1-57 R2-1 S4-2P 1-58 W8-6 1-50 G28-1 (CA)				+-^
S4-2P 1-58 W8-6 1-50 G28-1 (CA)				+-
1-58 W8-6 1-50 G28-1 (CA)				+-
1 50 G28-1 (CA)			+	X
				X
				T X
1-60 R26(CA)				T X
1-61 R1-1 1			1	$\frac{\hat{x}}{x}$
C1-7(CA) 48 24 7 0 CPEEN VI	VHITE XI	ΙX		X
1-62 SG33 (CA)	111112 XI			+
	VHITE XI	ıx		X
		XI	1	X
		ΙX	1	X
		ΙX	T X	X
		ΙX	X	X
		ΧI	X	X
S4-3P 1 26.07				
1.67 R2-1			1	\perp
S4-2P			1	
R48-1 (CA)			1	
	BLACK XI	ΧI	X	X
1-69 R28A (S) 1	DED		+	+
1-70 R28A (S) 7.0 1 1 0 WHITE IX	RED XI	IX	X	X
	D ADL A	X I	+	X -
TOTAL 22 4 7 3 1 2 23 313 147.0 32.0 11.0 11 - -	D/BLK XI	- 1	1 -	ı -

SQ-3

Underground Service Alert

TWO WORKING DAYS BEFORE YOU DIG

<u>BENCHMARK</u>

S.B.CO BRASS DISK STAMPED 63-1-12 1975 ON TOP OF CURB. +/- 28' SOUTHERLY FROM HWY 38 & 0.15 MILES EASTERLY FROM INTERSECTION HWY 38 & STANFIELD CUTOFF AS SHOWN PER SPSN 00271. NGVD-29 ELEVATION = 6789.402

PREPARED BY: MATTHEW ATKINSON, PROJECT MANAGER

06/12/24

DATE

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CHRIS NGUYEN, P.E./ TRANSPORTATION DESIGN E				
TRANSFORTATION DESIGN E				
Thomas Bustamonte				
THOMAS BUSTAMONTE, P.E. SUPERVISING ENGINEER				

SAN BERNARD	INO CO	YTNL		Г
/ DEPARTMENT OF	PUBLI	C WORK	S	-
A)CCC 1 6/26/24 NGUYEN, P.E. DATE ORTATION DEGICN ENGINEERING MANAGER	DESIGNED BY:	DRAWN BY:	CHECKED BY:	
omas Bustamonte 6/26/24		hail	6/26/2024	
S BUSTAMONTE, P.E. DATE //SING ENGINEER	MERVAT MIRHAL DEPUTY DIRECT	L. P.E. OR	DATE	

SIGN QUANTITIES	ROAD NO.
NO SCALE	
STATE HIGHWAY 38	W.O. NO.
STANFIELD CUTOFF	H15055
ROUNDABOUT	
BIG BEAR AREA	SHEET 62 OF 72

USERNAME => drucci
DGN FILE => 25530d003, dgn
MARK REVISIONS

DATE PLOTTED => 6/21/2024
TIME PLOTTED => 2:59:04 PM
APPR. DATE

01/12/2023

REVISION

ROADWAY QUANTITIES

MINOR CONCRETE SUMMARY

WE DESIGNATION		MINOR CONCRETE (SIDEWALK)	MINOR CONCRETE (ISLAND PAVING)	MINOR CONCRETE (CURB RAMP)	MINOR CONCRETE (CURB) (CY)	MINOR CONCRETE (CURB AND GUTTER)	CLASS 2 AGGREGATE BASE **
LINE	STATION	CY	CY	CY	CY	CY	CY
	ISLAND PAVING		49.0				96.2
	SIDEWALK	95.0					278.6
	CURB RAMP			42.0			125.0
	CURB				12.0		10.7
	CURB (TYPE A2-6)					73.4	120.0
	SPLITTER ISLAND CURB					53.7	76.1
	OUTSIDE TRUCK APRON CURB					12.3	17.4
	CENTER ISLAND APRON CURB					9.3	11.0
	TOTAL	95.0	49.0	42.0	12.0	149.0	735.0

EARTHWORK QUANTITIES

LINE DESIGNATION		ROADWAY EXCAVATION	ROADWAY EMBANKMENT (N)	DITCH EXCAVATION
	STATION	CY	CY	CY
HW38		1,909	532	378
S		636	733	89
	TOTAL	2,545	1,265	467

HOT MIX ASPHALT DIKE QUANTITIES

LINE DESIGNATION		PLACE HMA DIKE (TYPE C)	PLACE HMA DIKE (TYPE F)	PLACE HMA DIKE (TYPE A)	HMA (TYPE A) *
=	STATION	LF	LF	LF	TON
	NORTH APPROACH	·		46	1.1
	SOUTH APPROACH			261	6.5
	EAST APPROACH	119.00	157.00		2.3
	TOTAL	119	157	307	9.9

- * QUANTITIES FOR HOT MIX ASPHASLT (TYPE A) ARE INCLUDED IN ROADWAY QUANTITY TABLE ON Q-1 SHEET.
- ** QUANTITIES FOR CLASS 2 AGGREGATE BASE ARE INCLUDED IN ROADWAY QUANTITY TABLE ON Q-1 SHEET.

(N) - NO PAY ITEM

REMO			
RHIVIC	WEL	Δ NI	

E DESIGNATION		REMOVE TREE (N)	REMOVE FENCE	REMOVE PLANTER WALL (PORTION)	REMOVE CONCRETE SIDEWALK (SOYD)	REMOVE CONCRETE (CURB AND GUTTER)	REMOVE ASPHALT CONCRETE DIKE	REMOVE THERMOPLASTIC TRAFFIC STRIPE	REMOVE YELLOW THERMOPLASTIC TRAFFIC STRIPE (HAZARDOUS WASTE)	REMOVE THERMOPLASTIC PAVEMENT MARKING
LINE	STATION	EA	LF	LS	SQYD	LF	LF	LF	LF	SQFT
	SOUTH APPROACH	19			62	63	936	855	379	335
	NORTH APPROACH	2	68	1						49
	EAST APPROACH	10						390	690	35
	WEST APPROACH							737	240	42
	TOTAL	31	68	1	62	63	936	1982	1309	461

MISCELLANEOUS QUANTITIES

	DETECTABLE WARNING SURFACE	MIDWEST GUARDRAIL SYSTEM (STEEL POST)	VEGETATION CONTROL (MINOR CONCRETE)	END ANCHOR ASSEMBLY (TYPE SFI-M)	RECONSTRUCT WOOD FENCE	PLANTER WALL (ROCK FACE)	OBLITERATE SURFACING	SNOW POLE MARKER	CHAIN LINK FENCE (TYPE CL-8)
STATION	SQFT	LF	SQYD	EΑ	LF	LF	SQYD	EΑ	LF
SOUTH APPROACH	183				265		1125	7	330
WEST APPROACH	120						1238	4	
EAST APPROACH	120	205	85	2			1218	5	
NORTH APPROACH	32			·		6	426	3	
TOTAL	455	205	85	2	265	6	4,007	19	330

Q-1

TWO WORKING DAYS BEFORE YOU DIG

BENCHMARK S.B.CO BRASS DISK STAMPED 63-1-12 1975 ON TOP OF CURB. +/- 28' SOUTHERLY FROM HWY 38 & 0.15 MILES EASTERLY FROM INTERSECTION HWY 38 & STAMFIELD CUTOFF AS SHOWN PER SPSN 00271. NGVD-29 ELEVATION = 6789.402

MATTHEW ATKINSON, PROJECT MANAGER



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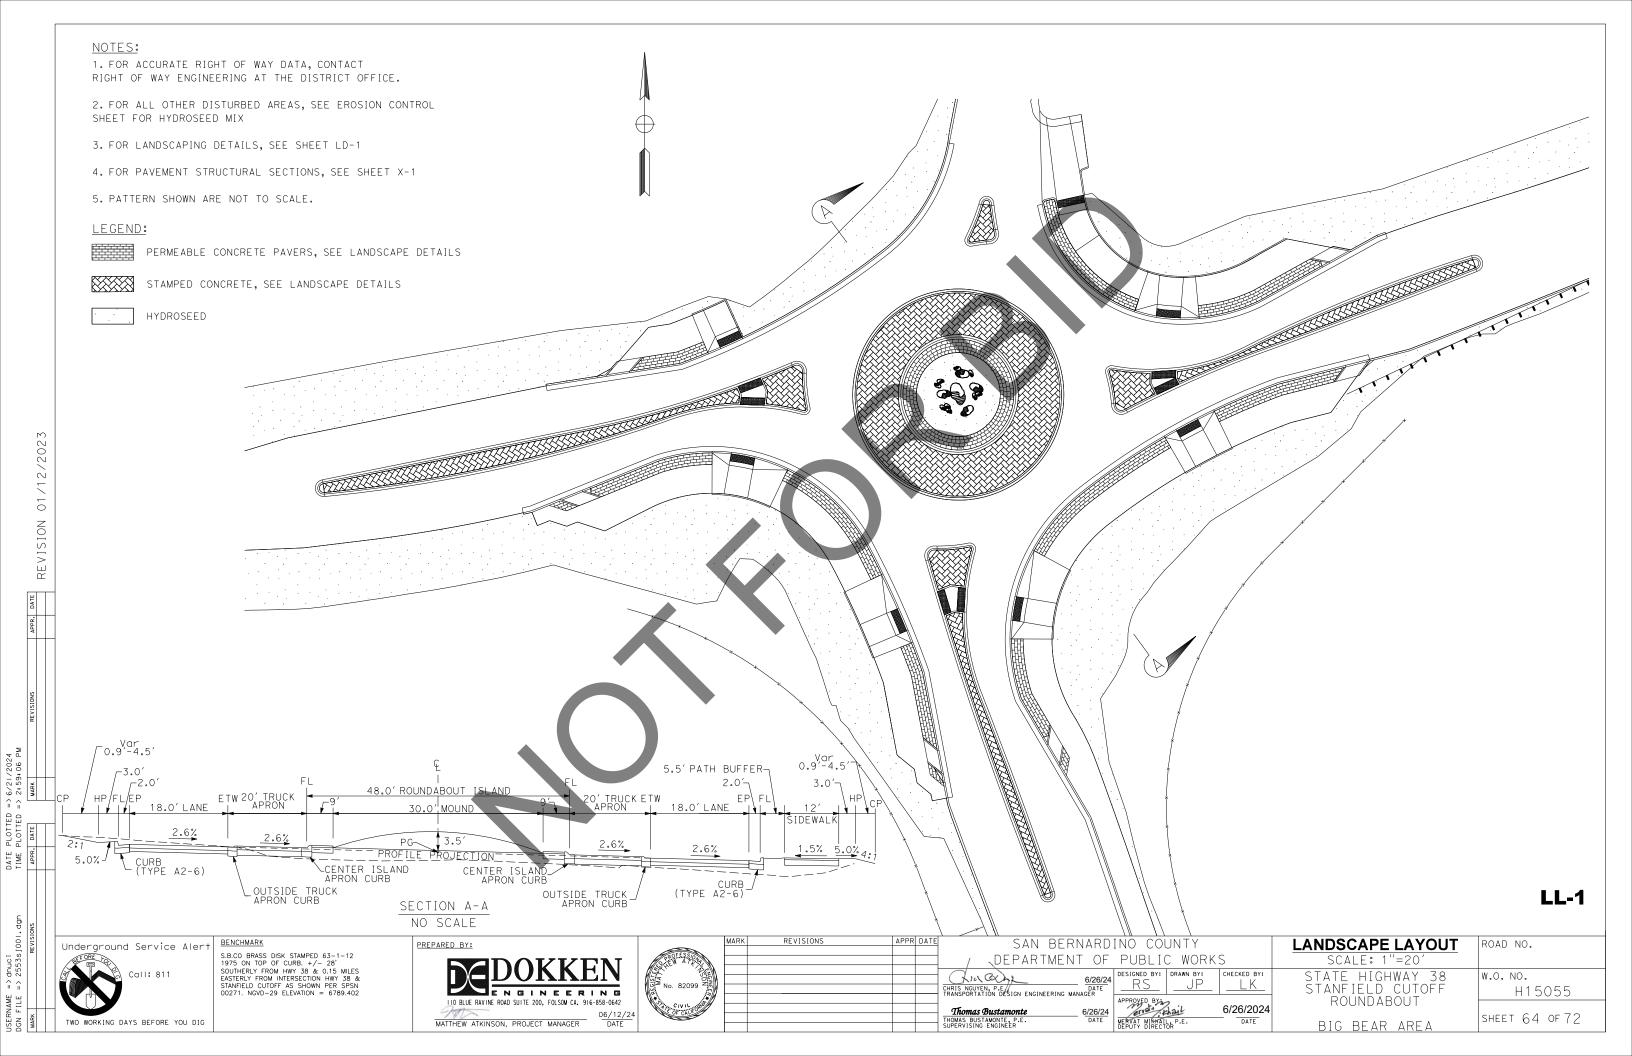
RK	REVISIONS	APPR	DATE	SAN BERN	ΔRD.	INO COL	INTY	
				JAN DEMM.	AIND.	1110 000	1111	
				/ \DEPARTMENT	OF	PUBLIC	C WORK	S
_				Charles by	0/00/04	DESIGNED BY:	DRAWN BY:	СНЕ
\rightarrow					6/26/24	RS	I IP	
				CHRIS NGUYEN, P.E. TRANSPORTATION DESIGN ENGINEERING MANAGE	DATE		I — UI	-
				TRANSFORTATION DESIGN ENGINEERING MANAGE	SEN .	APPROVED BY	2	
				Thomas Bustamonte 6	6/26/24	my of	lai <i>t</i>	6/
					DATE.	MERVAT MIKHALI	PF	_
\neg				THOMAS BUSTAMONTE, P.E. SUPERVISING ENGINEER		DEPUTY DIRECT	ōk	


	SUMMARY OF QUANTITIES	ROAD NO.
 S	NO SCALE	
CHECKED BY:	STANFIELD CUTOFF	w.o. no. H15055
6/26/2024 DATE	ROUNDABOUT BIG BEAR AREA	SHEET 63 OF 72

DATE PLOTTED => 6/21/2024
TIME PLOTTED => 2:59:05 PM
APPR. DATE

01/12/202

REVISION



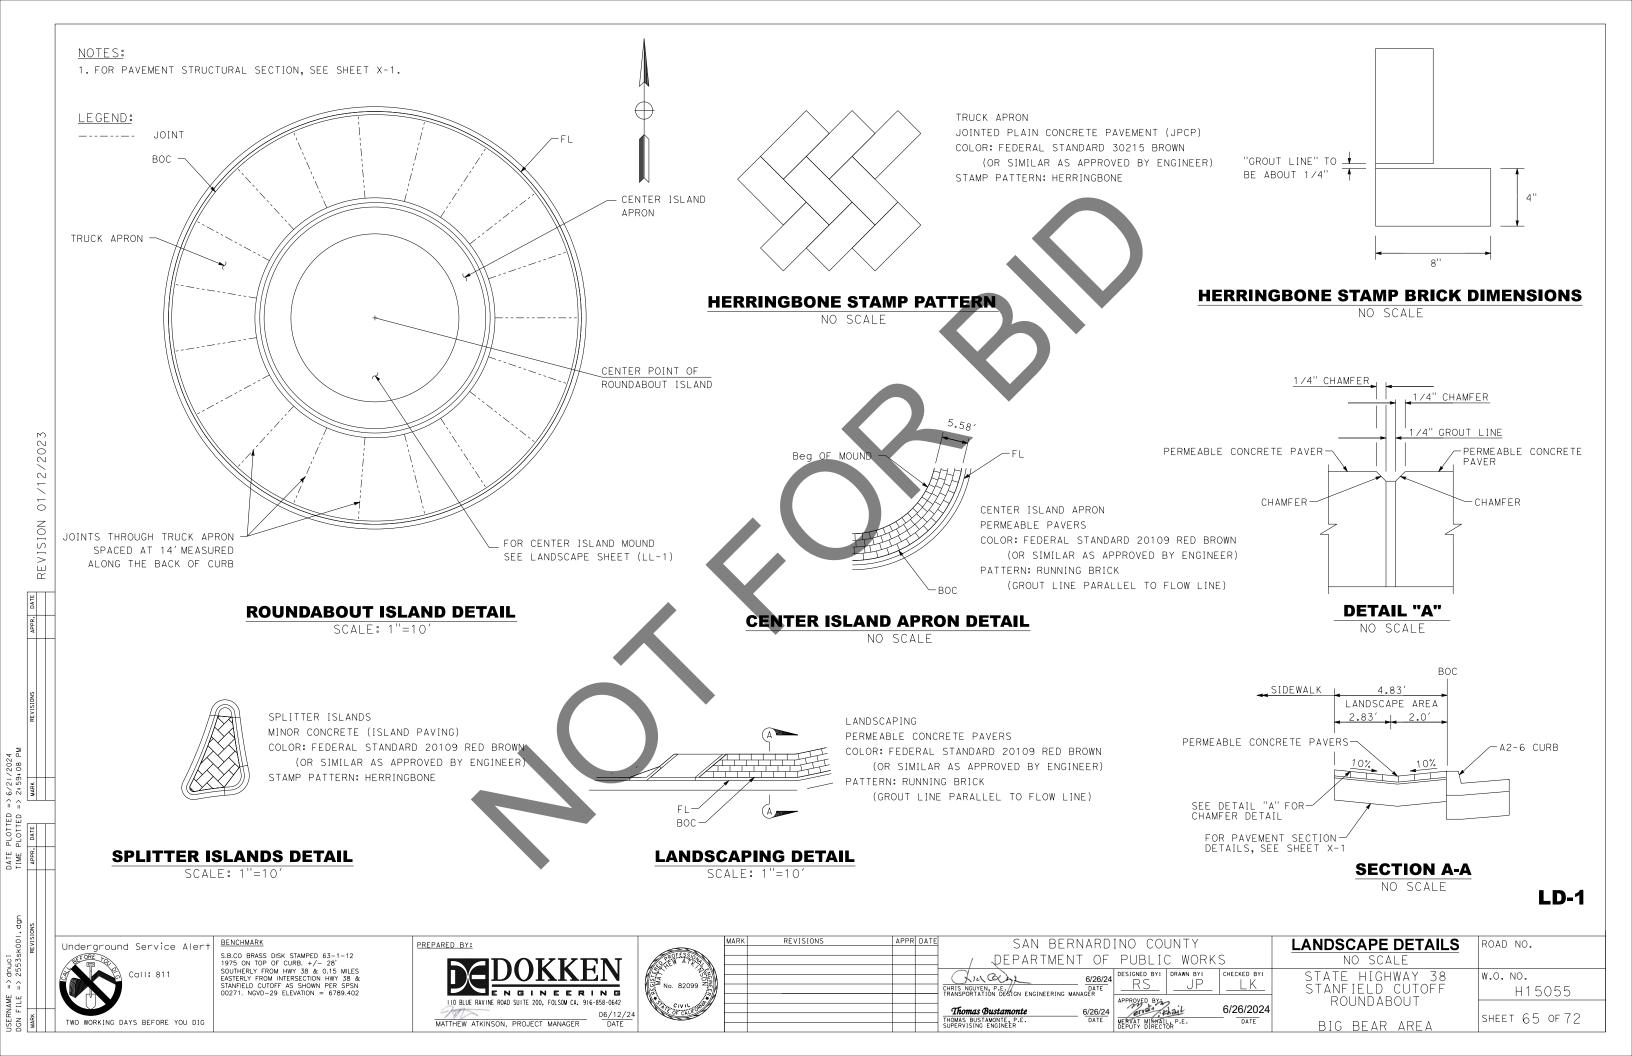


01/12/2023

REVISION


PINE NEEDLE MULCH

LOCATION	QUANTITY
CENTER ISLAND	4.5
TOTAL	4.5*

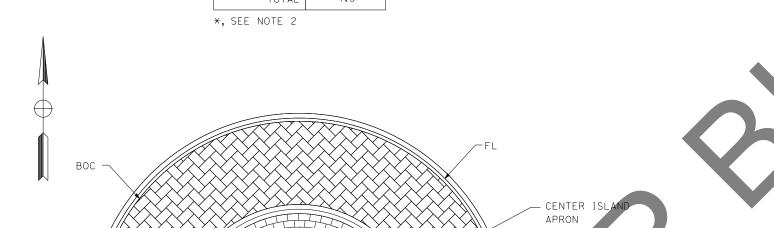


BOULDER INFORMATION

TYPE	SIZE	QUANTITY
	Dia	EΑ
LARGE	8.0′-9.0′	1
MEDIUM	5.0′-6.0′	4
SMALL	2.0'-3.0'	9
	14	

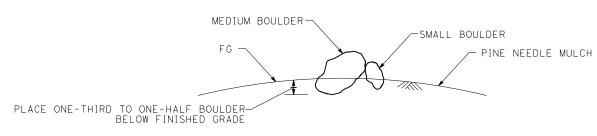

BOULDER PLACEMENT

NO SCALE

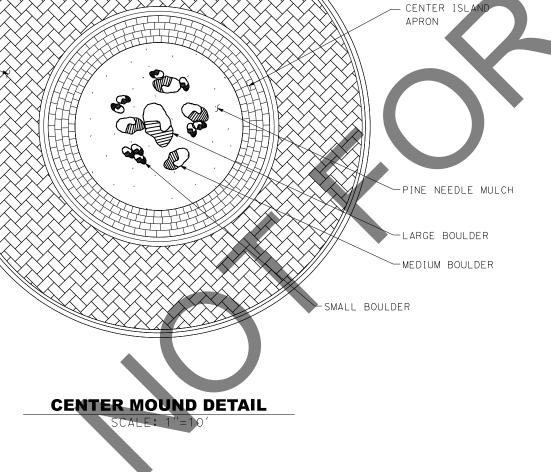

Underground Service Alert

TWO WORKING DAYS BEFORE YOU DIG

<u>BENCHMARK</u> SB.CO BRASS DISK STAMPED 63-1-12 1975 ON TOP OF CURB. +/- 28' SOUTHERLY FROM HWY 38 & 0.15 MILES EASTERLY FROM INTERSECTION HWY 38 & STANFIELD CUTOFF AS SHOWN PER SPSN 00271. NGVD-29 ELEVATION = 6789.402

TRUCK APRON

PREPARED BY: MATTHEW ATKINSON, PROJECT MANAGER 06/12/24



] / Department of	
			-
		(t) (CX) 6/26/24	١
		CHRIS NGUYEN, P.E. DATE TRANSPORTATION DESIGN ENGINEERING MANAGER	
		TRANSPORTATION DESIGN ENGINEERING MANAGER	1
		Thomas Bustamonte 6/26/24	
			ī
		THOMAS BUSTAMONTE, P.E. DATE SUPERVISING ENGINEER	Ü


APPR DATE


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MANA	6/26/24 DATE	DESIGNED BY: RS	DRAWN BY:	CHECKED BY:	
	6/26/24 DATE	APPROVED BY: MERVAT MIRHAL DEPUTY DIRECT	hail or P.E.	6/26/2024 DATE	


SAN BERNARDINO COUNTY

LANDSCAPE DETAILS	ROAD NO.
NO SCALE	
STATE HIGHWAY 38	W.O. NO.
STANFIELD CUTOFF	H15055
ROUNDABOUT	
BIG BEAR AREA	SHEET 66 OF 72

LD-2

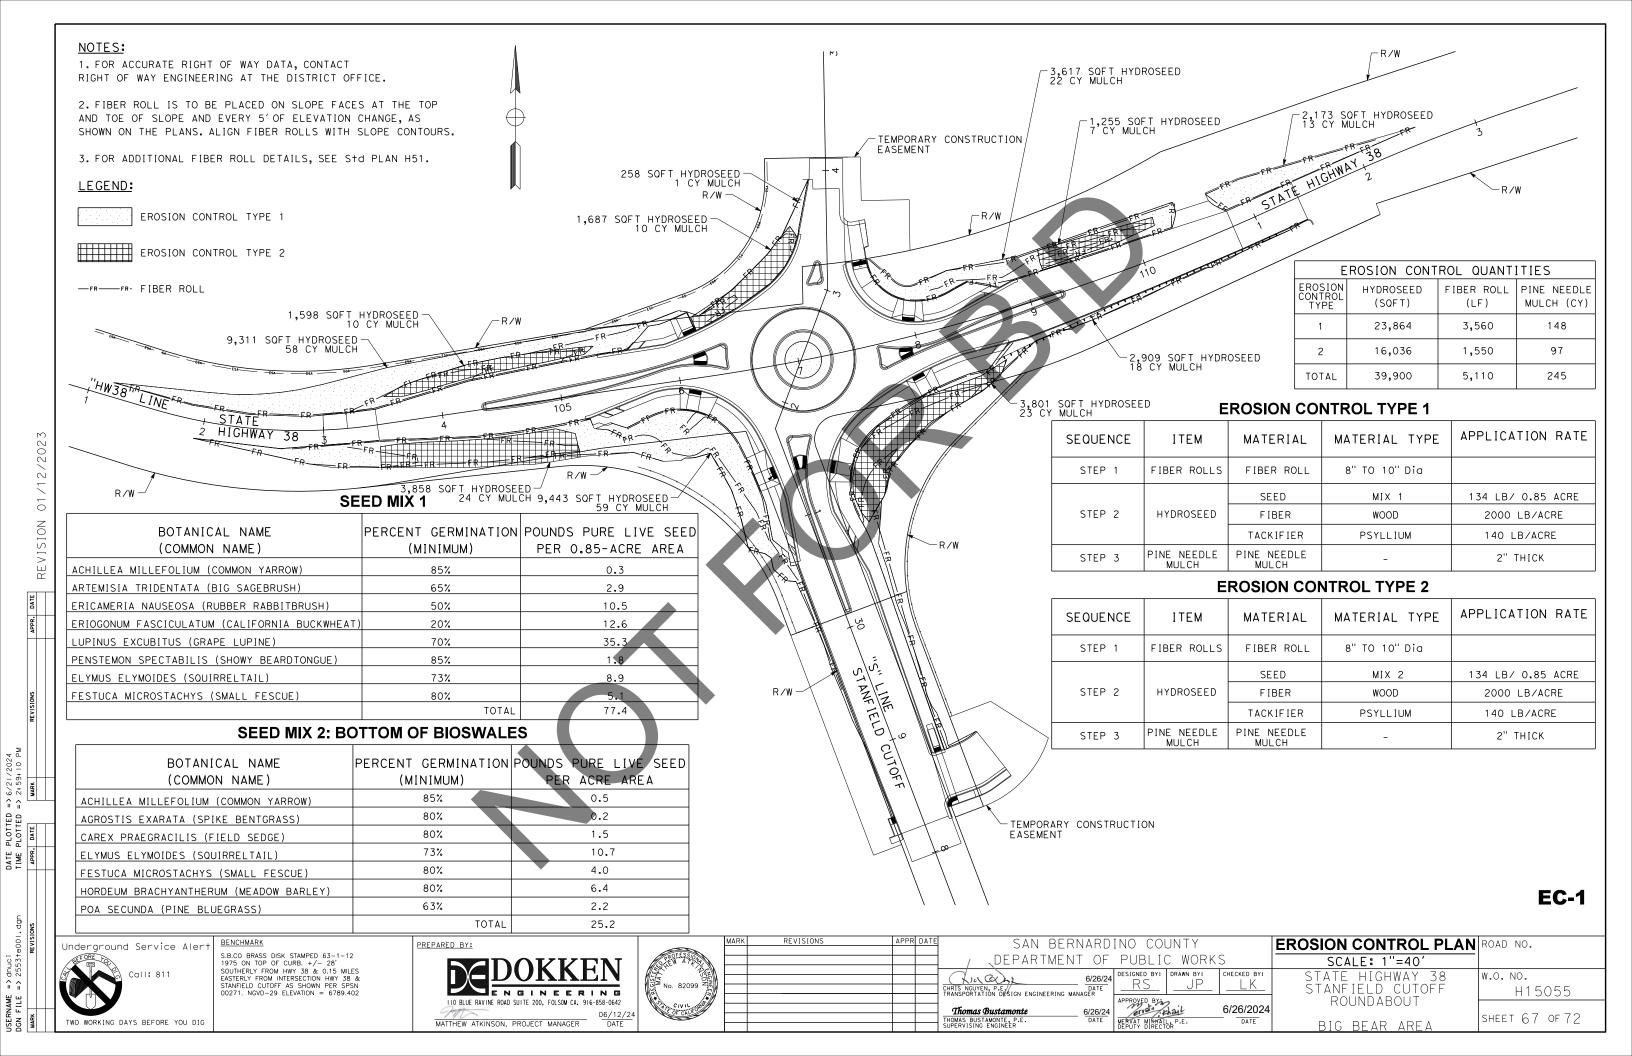

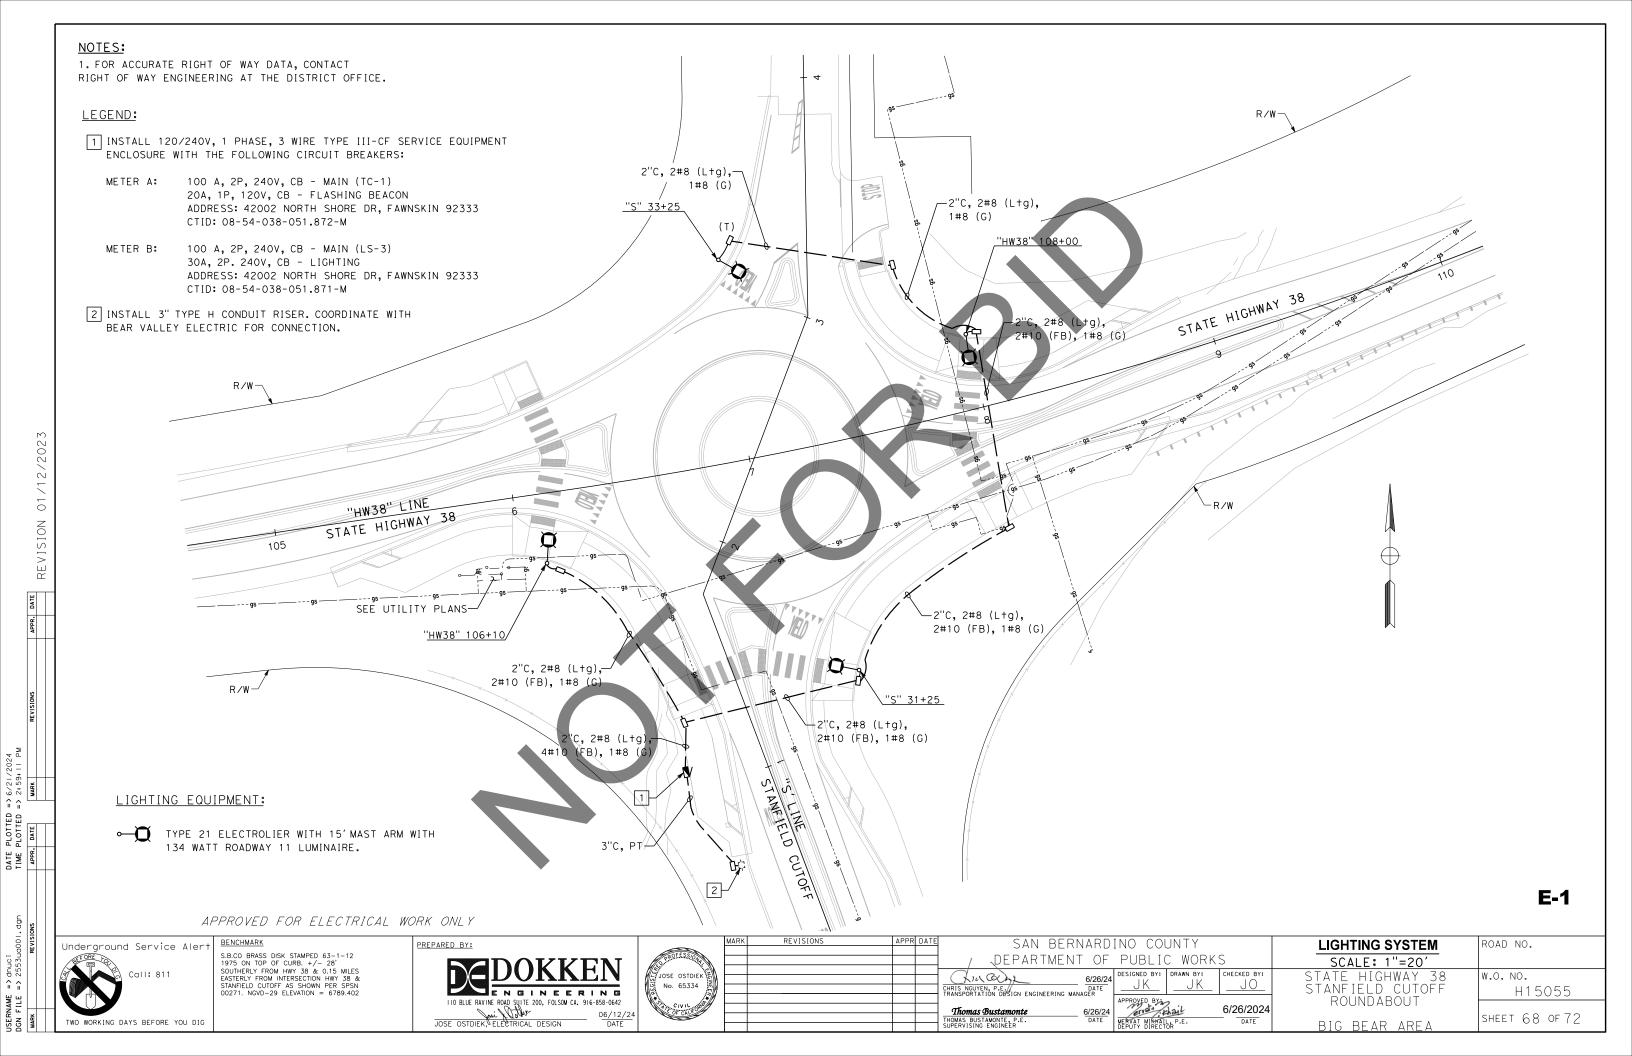

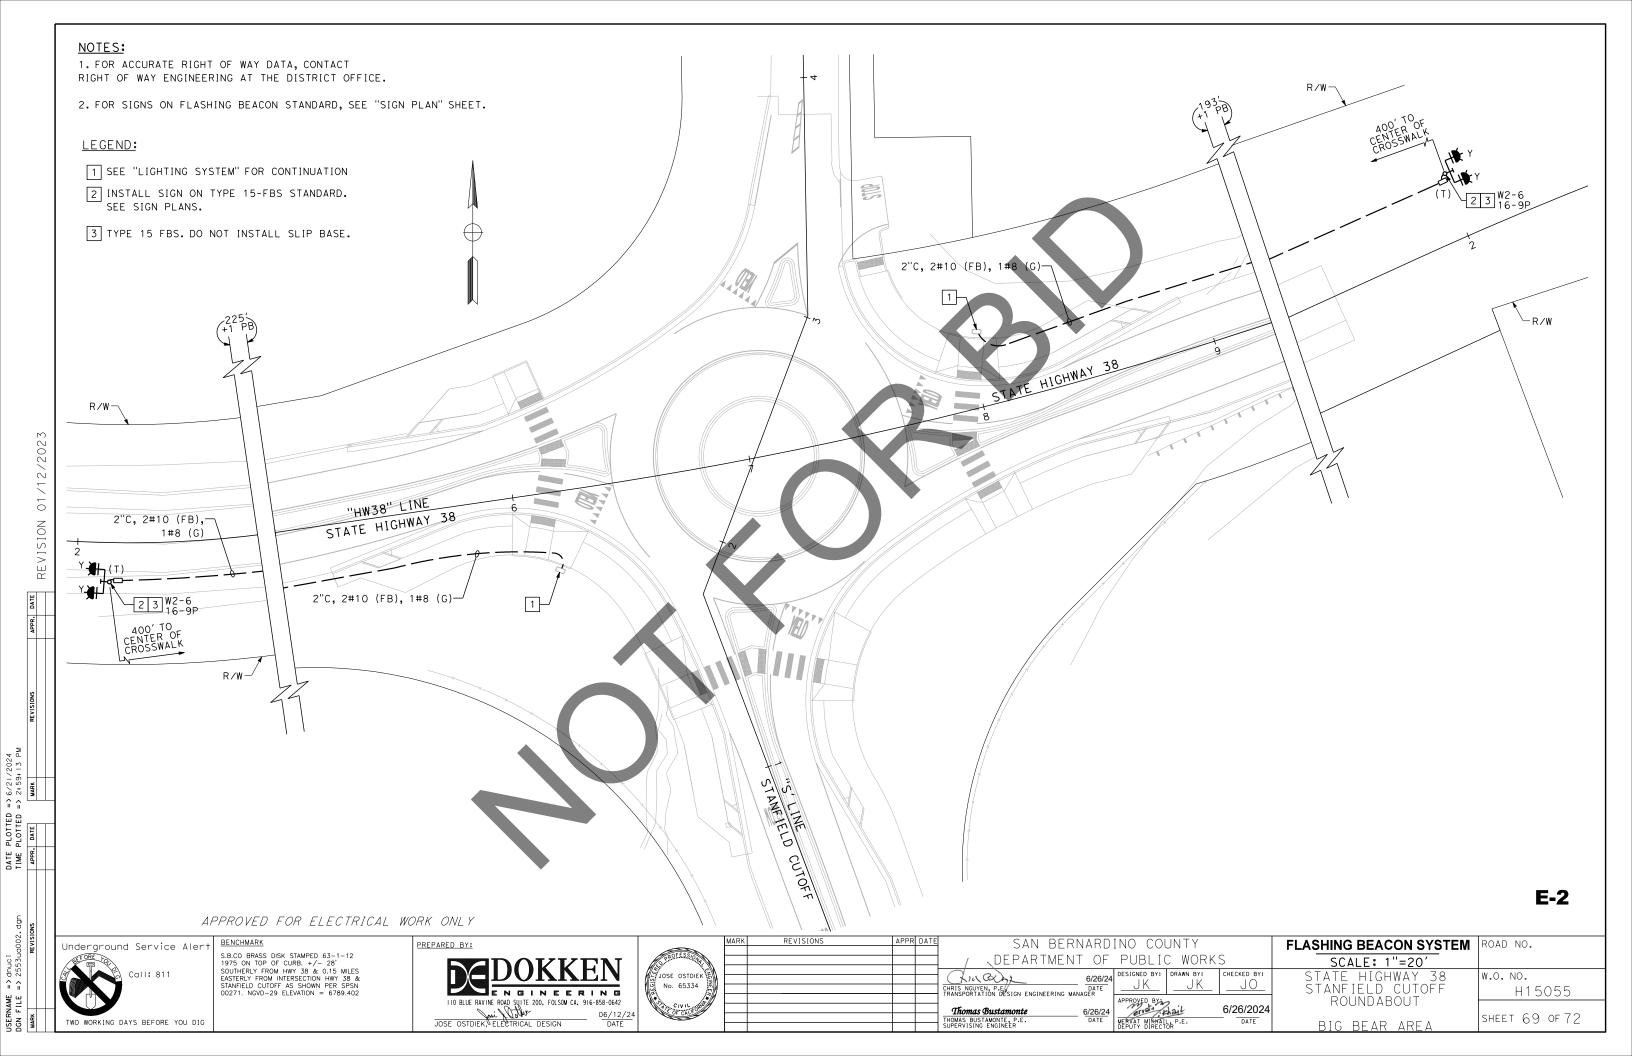

NOTES:

1. FOR ACCURATE RIGHT OF WAY DATA, CONTACT RIGHT OF WAY ENGINEERING AT THE DISTRICT OFFICE.

<u>LEGEND:</u>


- 1 REMOVE EXISTING FLOOD LIGHT ATTACHED TO TREE TO BE REMOVED. REMOVE EXISTING CONDUIT ATTACHED TO TREE.
- 2 INSTALL NEW 25' WOOD POLE (6' EMBEDMENT). MOUNT EXISTING FLOOD LIGHT TO NEW WOOD POLE NEAR TOP OR AS DIRECTED BY THE ENGINEER.
- 3 INTERCEPT EXISTING LIGHTING CONDUIT AND CONDUCTORS. PLACE PULL BOX (CALTRANS #3) AND SPLICE NEW CONDUCTOR TO EXISTING CONDUCTORS. NEW CONDUIT TO BE 1" GRS.
- 4 MOUNT CONDUIT TO NEW WOOD POLE AT LEAST 10' ABOVE EXISTING GRADE.
- 5 GROUND SYSTEM PER THE CALIFORNIA ELECTRIC

LIGHTING EQUIPMENT:

RELOCATED PARKING LOT LIGHT

EXISTING PARKING LOT LIGHT

NEW 25' WOOD POLE

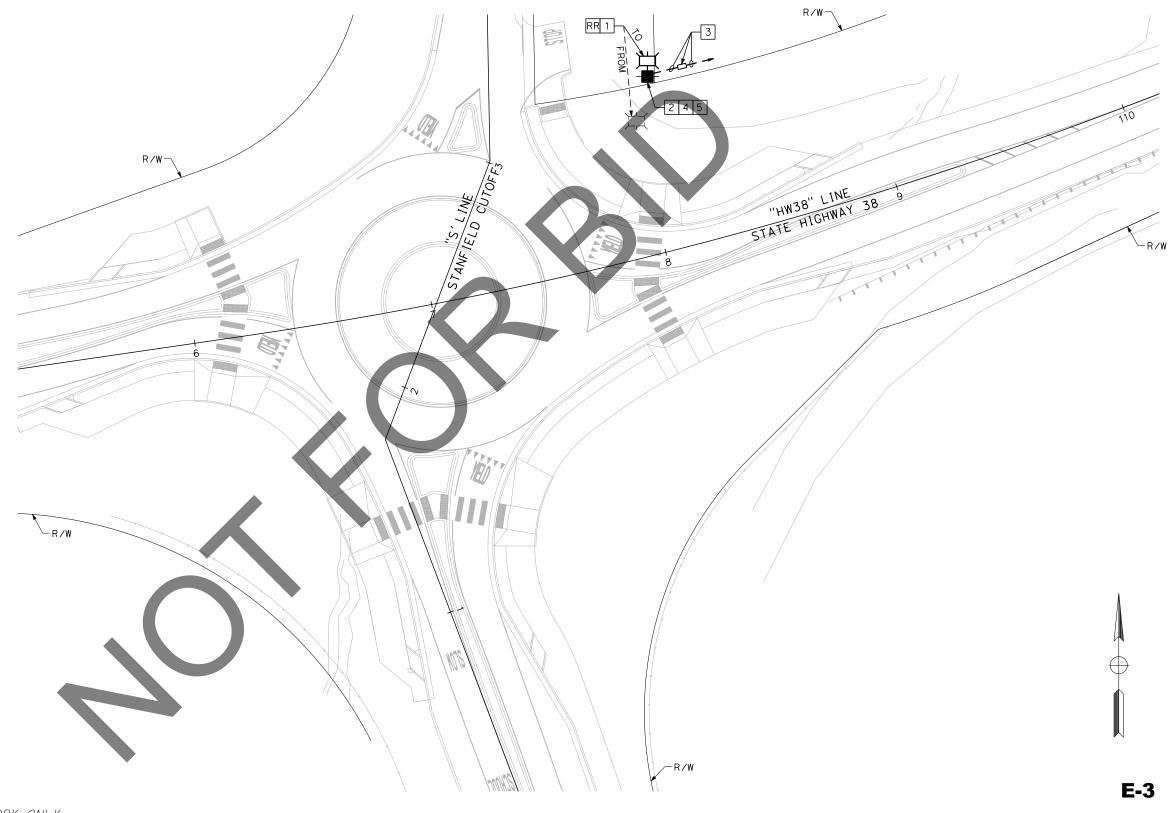

APPROVED FOR ELECTRICAL WORK ONLY

Underground Service Alert

TWO WORKING DAYS BEFORE YOU DIG


<u>BENCHMARK</u> SB.CO BRASS DISK STAMPED 63-1-12 1975 ON TOP OF CURB. +/- 28' SOUTHERLY FROM HWY 38 & 0.15 MILES EASTERLY FROM INTERSECTION HWY 38 & STANFIELD CUTOFF AS SHOWN PER SPSN 00271. NGVD-29 ELEVATION = 6789.402

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	JOSE OSTDIEK SON NO. 65334
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		CHRIS NGUYEN, P.E. TRANSPORTATION DESIGN ENGINEERING MAN	DATE	
		TRANSFORTATION DESIGN ENGINEERING MAIN	MOEN	APPROVED
		Thomas Bustamonte	6/26/24	mery's
		THOMAS BUSTAMONTE, P.E. SUPERVISING ENGINEER	DATE	MERVAT M DEPUTY D
	l	SUPERVISING ENGINEER		DEPUTY D

SAN BERNARDINO

COUNTY	MODIFYING PARKING LOT LIGHTING (PRIVATE)	ROAD NO.
BLIC WORKS	SCALE: 1"=20'	
ED BY: DRAWN BY: CHECKED BY:	STATE HIGHWAY 38 STANFIELD CUTOFF	w.o. no. H15055
/ED BY: GOVERNMENT OF THE PLES OF THE PROPERTY OF THE PROPERT	ROUNDABOUT BIG BEAR AREA	SHEET 70 OF 72

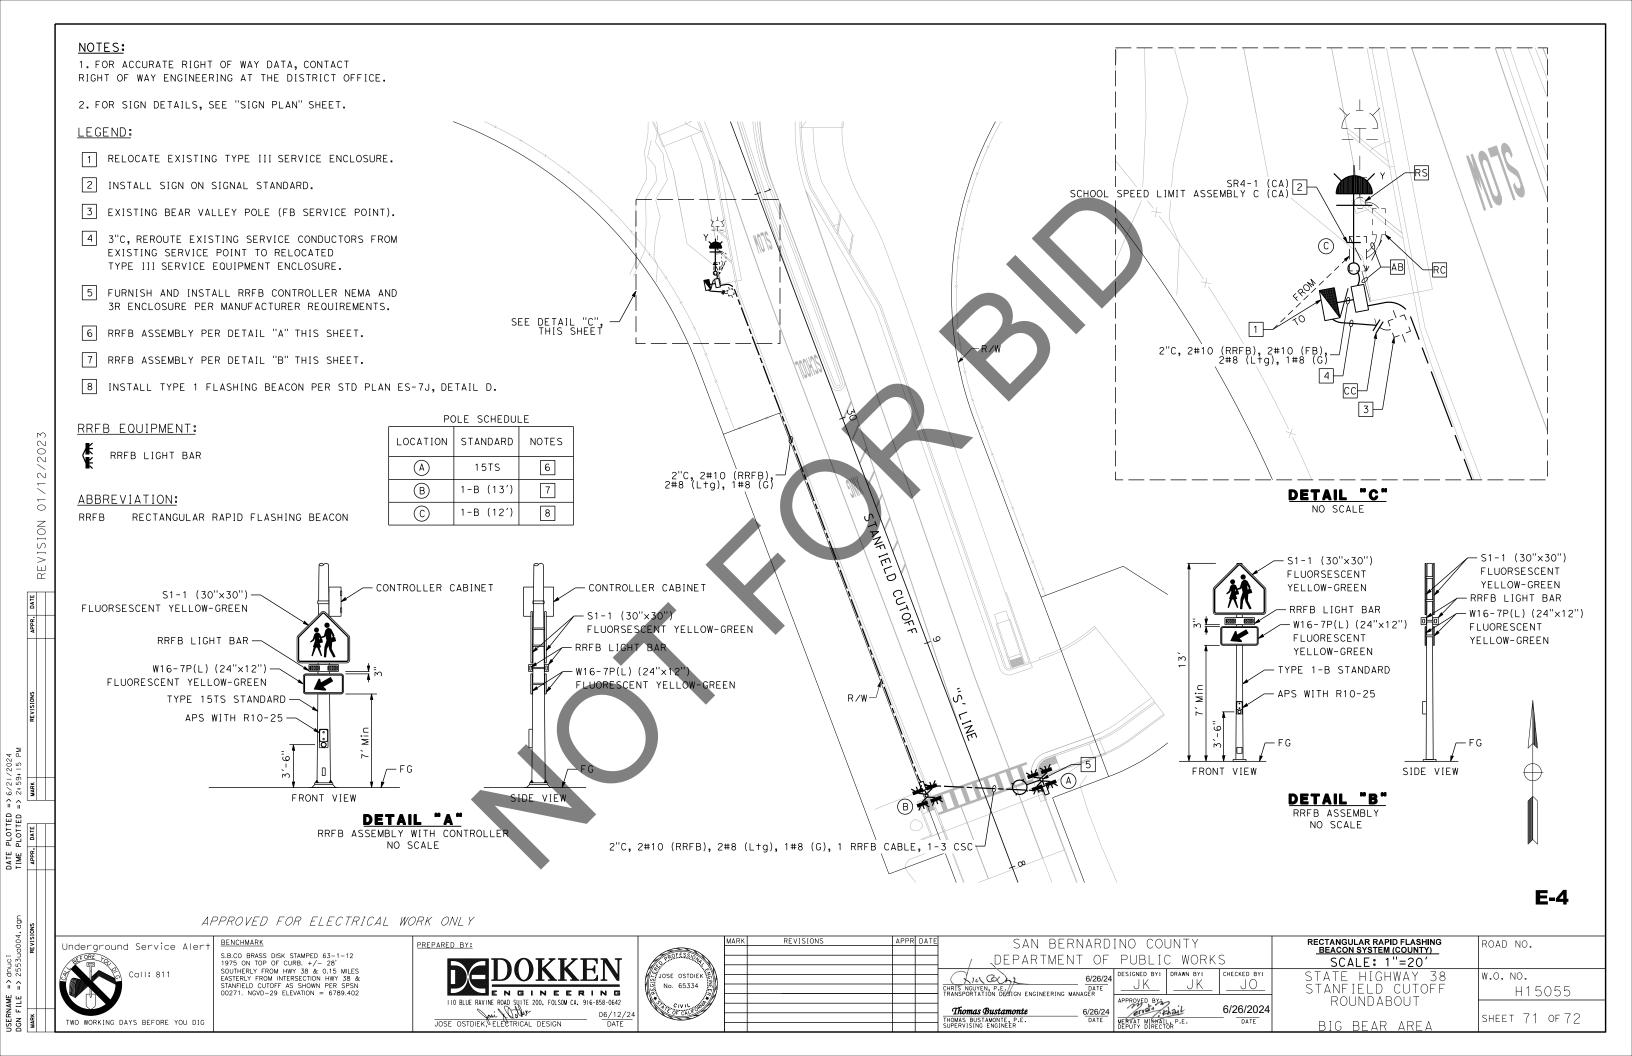

LIGHTING SYSTEM

	(N)	(N)	(N)	(N)	(N)	(N)	(N)	(N)	(N)	(N)
SHEET No.	TYPE III-CF SERVICE EQUIPMENT ENCLOSURE	TYPE 21 ELECTROLIER	No. 8 CONDUCTOR	No. 10 CONDUCTOR	2"C TYPE 3	3"C TYPE 3	PT	No. 5 PB	No. 5(T) PB	3" TYPE H RISER
	EA	EA	LF	LF	LF	LF	LF	EA	EA	EA
E-1	1	4	1,425	680	475	60	60	7	1	1
TOTAL	1	4	1,425	680	475	60	60	7	1	1
(N) - NO	T A SEPARATE BIC	ITEM	•	•		•		•	•	

MODIFYING PARKING LOT LIGHTING (PRIVATE)

	•								
	(N)	(N)	(N)	(N)					
SHEET No.	25' WOOD POLE	No. 3 PB	1"C TYPE GRS	RELOCATE LIGHT					
	EΑ	EΑ	LF	EA					
E-3	1	1	30	1					
TOTAL	1	1	30	1					

(N) - NOT A SEPARATE BID ITEM

FLASHING BEACON SYSTEM

	(N)	(N)	(N)	(N)	(N)	(N)
SHEET No.	TYPE 15-FBS	FLASHING BEACON	No. 8 CONDUCTOR	No. 10 CONDUCTOR	2"C TYPE 3	No.5(T) PB
	EΑ	EΑ	LF	LF	LF	EA
E-2	2	2	800	1,600	800	2
TOTAL	2	2	800	1,600	800	2

(N) - NOT A SEPARATE BID ITEM

RECTANGULAR RAPID FLASHING BEACON SYSTEM (COUNTY)

	(N)	(N)	(N)	(N)	(N)	(N)	(N)	(N)	(N)	(N)	(N)
SHEET No.	TYPE 15TS STANDARD WITH RRFB AND L+g EQUIPMENT	TYPE 1-B STANDARD WITH RRFB EQUIPMENT	RELOCATED TYPE III SERVICE ENCLOSURE	TYPE 1-B STANDARD WITH FLASHING BEACON	No.5 PB	1 RRFB CABLE	3 CSC	No. 8 CONDUCTOR	No. 10 CONDUCTOR	2"C TYPE 3	3"C TYPE 3
	EA	EΑ	EΑ	EΑ	EΑ	LF	LF	LF	LF	LF	LF
E-4	1	1	1	1	3	55	55	855	570	285	10
TOTAL	1	1	1	1	3	55	55	855	570	285	10

(N) - NOT A SEPARATE BID ITEM

TWO WORKING DAYS BEFORE YOU DIG

01/12/2023

SB.CO BRASS DISK STAMPED 63-1-12 1975 ON TOP OF CURB. +/- 28' SOUTHERLY FROM HWY 38 & 0.15 MILES EASTERLY FROM INTERSECTION HWY 38 & STANFIELD CUTOFF AS SHOWN PER SPSN 00271. NGVD-29 ELEVATION = 6789.402



	MARK	REVISIONS	APPR	DATE	
h.					
					/
NGINEE					$\overline{}$
[]M					(X10)
A)A					CHRIS NGUYEN
					TRANSPORTATI
y					Thomas B
					THOMAS BUSTA

SAN BERN	NARD	INO COL	YTNL		ELE
/ QEPARTMENT	r of	PUBLI	C WORK	S	
Children Comp	6/26/24 DATE	DESIGNED BY:	DRAWN BY:	CHECKED BY:	
RIS NGUYEN, P.E./ ANSPORTATION DESIGN ENGINEERING MAN	AGER				
Thomas Bustamonte	6/26/24	APPROVED BY	Lail	6/26/2024	

	ELECTRICAL SYSTEMS QUANTITIES	ROAD NO.			
	SCALE: 1"=20'				
вү:	STANFIELD CUTOFF	w.o. no. H15055			
2024 TE	ROUNDABOUT	SHEET 72 OF 72			

BIG BEAR AREA

EQ-1