



REVISIONS
DESCRIPTION DATE:

www.captiveaire.com



#### FOR REFERENCE ONLY, DESIGNED BY OTHERS

UNDERGROUND SERVICE ALERT

Call: TOLL FREE

1-809-227-2600
OR
811

TWO WORKING DAYS BEFORE YOU DIG

BENCHMARK:

BASIS OF BEARINGS:

BASIS OF BEARINGS:

BESSION

No. M342

FED. 12-31

OF CAL



			REVISIONS	PLANS APPROVED BY:									
						SAN BERNARDINO COUNTY - PUBLIC WORKS SPECIAL DISTRICTS							
						David R. Doublet Tools (Section Control Contro							
$\vdash$	_					ASSISTANT	DIRECTOR	DATE					
								INITIAL	DATE				
$\vdash$						APPROVALS	PROJECT MANAGER	Alfonso Fausto	Septidly signed by Moesa Fausto See: 2024 35.24 68.49.31 0790				
						ALLINOVALO	OPS, DĮVĮSĮON MANAGER	Henry Mac	College Space Co				
MARK	DATE	INITIAL	DESCRIPTION	APPR.	DATE	1	PM, DIVISION MANAGER	Noel Mondragon	Popular signal by Ned Mandagan Schiller, Carlott mediagon (Spiral Country) or 20 Sulfa State - Spiral Cotton, Dri Said Stateboom State 100, 2021 1003 200-101				

IMPROVEMENT PLANS

CSA 29 LUCERNE VALLEY COMMUNITY CENTER RENOVATION PROJECT HOOD PACKAGE

SHEET M-1.6

#### DUCTWORK #1 PARTS - JOB#6441874 DOUBLE WALL TAG PART# WEIGHT VELOCITY QTY DESCRIPTION DOUBLE WALL DUCT - 12" INNER DUCT, 29" LONG - 3 LAYERS ZERO CLEARANCE - 18" STAINLESS STEEL OUTER DW1229DWLT-3Z-S 44.03 DUCT TO CURB TRANSITION, 23" CURB TO 12" DUCT, 16 GA ALUMINIZED. MISC. NON-STANDARD TRANSITION PLATE P3 ASSEMBLED W/P2 O=B 8.02 SYSTEM AT P3 DUCT - 3M FIRE BARRIER 2000 PLUS SILICONE - USED AS SEALANT TO SEAL DUCT JOINTS. TOTAL WEIGHT

#### DOUBLE WALL FACTORY BUILT DUCTWORK

- ALL DUCTWORK IS REQUIRED TO BE INSTALLED WITH THE MAXIMUM SUPPORT SPACING LISTED BELOW
- FOR A COMPLETE LIST OF APPROVED SUPPORT METHODS, SEE THE ENTIRE INSTALLATION AND OPERATION MANUA
- DUCTWORK SHALL SLOPE NOT LESS THAN 1/16" PER LINEAR FOOT TOWARDS THE HOOD OR AN APPROVED GREASE COLLECTION RESERVOIR.

HORIZ	ZONTAL
DUCT DIAMETER	SUPPORT SPACING (FT)
5"	7'
6"	T*
7*	T*
8"	T
10"	T'
12"	7"
14"	7"
16"	7"
18"	5*
20"	5"
22"	5'
24"	5'
26"	5'
28"	5'
30"	5'
32"	5'
34"	5"
36"	5"

	VERTICAL						
TYPE	WALL SUPPORT (FT)	CURB SUPPORT (FT)	FLOOR SUPPORT (FT)				
2R & 2R HT (5"-16")	20'	24"	24"				
2R (18")	18"	24"	24"				
3R & 3Z (5"-24")	10'	24'	24'				
3Z (26" -36")	10'	20"	20"				

DO NOT LEAK TEST USING SMOKE BOMBS CONTAINING CHLORINES/CHLORIDES. CONSULT WITH CAPTIVEAIRE FOR PROPER LEAK TESTING METHODS.

GREASE DUCT & CHIMNEY SPECIFICATIONS:
PROVIDE GREASE DUCT EQUAL TO CAPTIVEAIRE SYSTEMS MODEL "DW"
ROUND 20 GAUGE 430 STAINLESS STEEL DUCTWORK, MODEL "DW"
IS LISTED TO UL-1978 AND IS INSTALLED USING "V" CLAMP LOCKING
CONNECTIONS SEALED WITH 3M FIRE BARRIER 2000 PLUS. MODEL "DW"
DOES NOT REQUIRE WELDING PROVIDING IT HAS BEEN INSTALLED PER
THE MANUFACTURES INSTALLATION GUIDE.
PROVIDE RATED ACCESS DOORS AT EVERY CHANGE IN DIRECTION AND EVERY 12" ON CENTER. PER
MANUFACTURES LISTING MODEL "DW" HORIZONTAL RUNS LESS THAN 75 FT. CAN BE SLOPED 1/16" PER 12",
HORIZONTAL RUNS MORE THAN 75 FT. CAN BE SLOPED 3/16" PER 12".
DUCT SHOULD BE SLOPED AS MUCH AS POSSIBLE TO REDUCE THE CHANCE OF GREASE ACCUMULATION IN
HORIZONTAL RUNS.

IF THE DUCT OR CHIMNEY IS WITHIN 18 INCHES OF COMBUSTIBLE MATERIAL, PROVIDE UL-2221 OR UL-103 HT LISTED DOUBLE WALL GREASE DUCT OR DOUBLE WALL CHIMNEY EQUAL TO CAPTIVEAIRE SYSTEMS MODEL "DW-2R, 2R TYPE HT, 3R, OR 32" ROUND 20 GAUGE 430 STAINLESS INNER DUCT INSULATED WITH A 24 GAUGE 430 STAINLESS OUTER SHELL.

CAPTIVEAIRE SYSTEMS RECOMMENDS THE USE OF LISTED, PRE-FABRICATED ROUND GREASE EXHAUST DUCT TO REDUCE STATIC PRESSURE IN THE SYSTEM, MINIMIZE INSTALLATION AND INSPECTION TIMES, AND ENSURE DUCT IS LIQUID TIGHT

VERIFY CEILING HEIGHT


CUSTOMER APPROVAL TO MANUFACTURE:

HVAC DISTRIBUTION NOTE

HIGH VELOCITY DIFFUSERS OR HVAC RETURNS SHOULD NOT BE PLACED WITHIN TEN (10) FEET OF THE EXHAUST HOOD, PERFORATED DIFFUSERS ARE RECOMMENDED.

BASIS OF BEARINGS:

#### **DUCTWORK #1 FRONT VIEW**

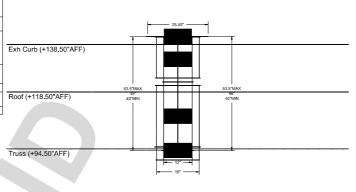

# CA, 95458 Lucerne Valley CC Lucerne, (

REVISIONS

DRAWN BY: DAB **SCALE:** 3/4" = 1'-0" MASTER DRAWING

DATE: 12/15/2023

SHEET NO.

06-20-2024

#### FOR REFERENCE ONLY, DESIGNED BY OTHERS



BENCHMARK:

Call: TOLL FREE






Т				REVISIONS		PLANS APPROVED								
						] SAN	N BERNARDINO COUNTY		RKS					
							SPECIAL DISTRICTS  David R. Doublet 10 to							
							ASSISTANT DIRECTOR DATE							
					-	_			INITIAL	DATE				
					+		APPROVALS	PROJECT MANAGER	Alfonso Fausto	Ogrady signed by Alloma Fausto Date: 2004-25,04 68-49-40-5700				
							AFFROVALS	OPS, DĮVĮSĮON MANAGER	Henry Mac	Chally reported these figures and the control of th				
	MARK	DATE	NITIAL	DESCRIPTION	APPR,	DATE	1	PM, DIVISION MANAGER	Noel Mondragon	Pagety spread by find Membagon and Cold, Europe membagon from demonstrator of the Notes, Special Lawren, Dri Seed Secretary and Pagety Seed (1997).				

CSA 29 LUCERNE VALLEY COMMUNITY CENTER RENOVATION PROJECT **HOOD PACKAGE** 

DWG NO. IMPROVEMENT PLANS FILE NO. SHEET M-1.7

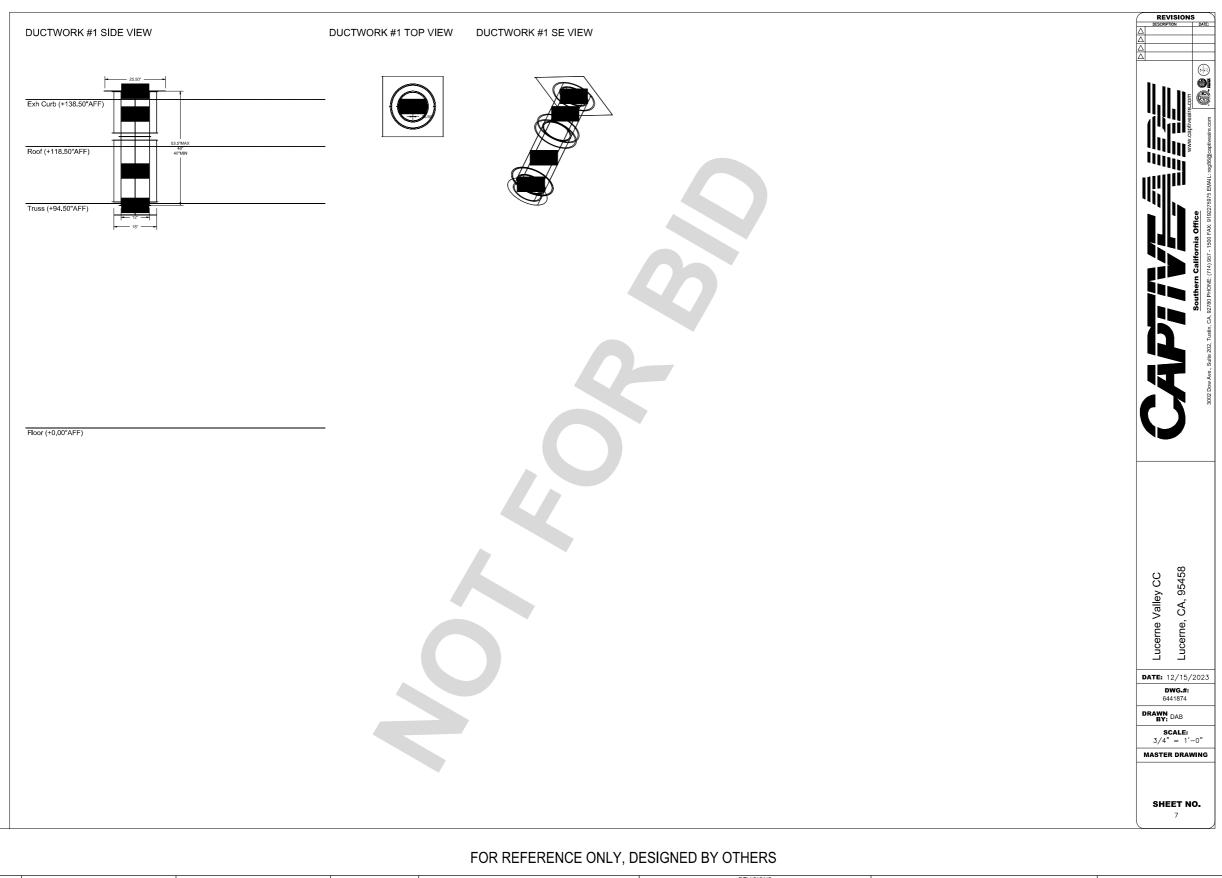

:

UNDERGROUND SERVICE ALERT

Call: TOLL FREE

1-800-227-2600
OR
811

TWO WORKING DAYS BEFORE YOU DIG

I: TOLL FREE
100-227-2600
OR
811





1 8	\$ 951.742.7171
\$ 85 N	Q STUDIO A-400 EVERSIDE, CA 9250
	A see tideilasanes can

							-
							,
							APF
Г							
MA	RK	DATE	INITIAL	DESCRIPTION	APPR.	DATE	


PLANS APPROVED BY:	
SAN BERNARDINO COUNTY - PUBLIC W	ORKS
SPECIAL DISTRICTS	
David R. Doublet The special process, finds	


SISTANT DIRECTOR DATE						
		INITIAL	DATE			
OVALS	PROJECT MANAGER	Alfonso Fausto	Optially signed by Altonio Possite ode: 3004.06.04.00.4855.0700			
	OPS, DĮVĮSĮON MANAGER	Henry Mac	The projection has been as a company of the projection of the proj			
	PM, DÍVÍSION MANAGER	Noel Mondragon	Digitally signed by Tard Mandrague 1961 C. Lift. F. vanish mandrague Belgers name Space Orbitals White to Spanish Dates in Chiefma Mondrague 1968 (COLONAL SISSEE) (COL			

IMPROVEMENT PLANS	

CSA 29 LUCERNE VALLEY COMMUNITY CENTER
RENOVATION PROJECT
HOOD PACKAGE



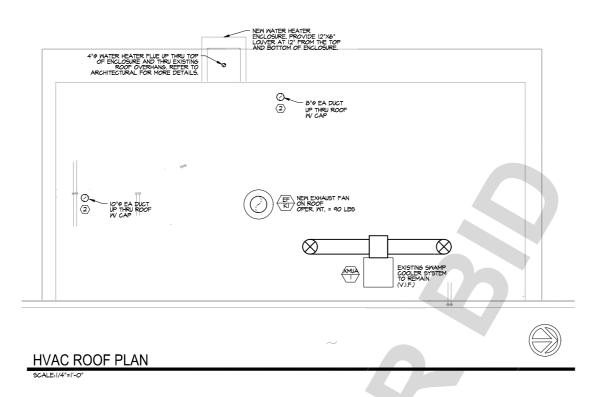

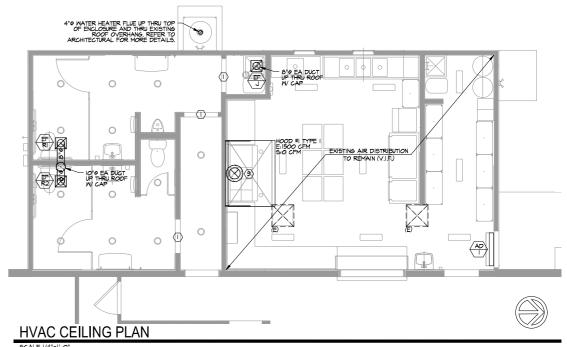

#### **HVAC KEYED NOTES**

- DOOR LOUVER FOR MAKEUP AIR, REFER TO ARCHITECTURAL PLANS DOOR SCHEDULE AND DETAILS.
- (2) KEEP IOFT CLEAR FROM ANY FRESH AIR INTAKES, SPT FROM BUILDING OPENINGS, AND SPT FROM PROPERTY LINES (Y.I.P.).

  (3) IZ'0 ID, IS'0 OP FACTORY BUILT DOUBLE WALL GREASE DUCT UP TO ET-KI ON ROOF, YEL 2 HIG PPM

## IMPORTANT BID NOTES

CONTRACTOR IS RESPONSIBLE TO VERIFY EXISTING MECHANICAL EQUIPMENT AND DUCTNORK IN FIELD, REUSE EXISTING DUCTNORK WHERE POSSIBLE, NOTIFY ARCHITECT/ENSINEER IF MAJOR DISCREPANCY IS FOUND, NO COMPENSATION WILL BE MADE AFTER BID.



39 Rancho Pkwy. 8, Ste 120 Lake Forest, CA 92630 Tel 949-267-9005 06-20-2024

DWG NO.

UNDERGROUND SERVICE ALERT

Call: TOLL FREE

1-800-227-2600
OR
811

TWO WORKING DAYS BEFORE YOU DIG

BENCHMARK: BASIS OF BEARINGS:





ı			11211010110			
						-
						APF
MARK	DATE	INITIAL	DESCRIPTION	APPR.	DATE	

PLANS APPROVED BY:

SAN BERNARDINO COUNTY - PUBLIC WORKS
SPECIAL DISTRICTS

David R. Doublet Control for a finish and a control for all and a control for a finish and a control for a

David R. Doublet In the season and the control of t

IMPROVEMENT PLANS

csa 29 Lucerne valley community center renovation project HVAC CEILING & ROOF PLAN

FILE NO.

SHEET M-2.0

STATE OF CALIFORNIA			STATE OF CAUFORNIA			STATE OF CALIFORNIA			
Process Systems		CALIFORNIA ENERGY COMMISSION	Process Systems		CALIFORNIA ENERGY COMMISSION	Process Systems			CALIFORNIA ENERGY COMIN
CERTIFICATE OF COMPLIANCE		NRCC-PRC-E	CERTIFICATE OF COMPLIANCE		NRCC-PRC-E	CERTIFICATE OF COMPLIANCE			NRC
Project Name: 23-938 Lucerne Community Valley Center Renovation	Report Page: Date Prepared:	(Page 3 of 6) 2024-01-02T10:34:30-05:00	Project Name: 23-938 Lucerne Community Valley Center Renovation	Report Page: Date Prepared:	(Page 2 of 6) 2024-01-02710-34:30-05:00	This form is used to document any process system or prescriptive requirements in 140.9. This compli			ing compliance with mandatory requirements in 120.6/ lects.
	Desc Propares:	2024-01-02110:34:30-05:00		wate repared:	2024-01-02110:34:30-05:00	Project Name: 23-938 Lucerne Community Valley (		Report Page:	(Pag
						Project Address:		Date Prepared:	2024-01-02710:34:3
[									
H. ENCLOSED PARKING GARAGE EXHAUST			C. COMPLIANCE RESULTS			A. GENERAL INFORMATION			
This section does not apply to this project.			Results in this table are automatically calculated from data input and calculati to Table D. Exceptional Conditions for guidance or see applicable Table referen		ble says "COMPLIES with Exceptional Conditions" refer	01 Project Location (city)	Lucerne Valley	04 Total Conditioned	Floor Area 500
Annual Control of Cont				07 08 09 10	11 12 13 14	02 Climate Zone	14	05 Total Unconditioner	d Floor Area 0
I. PROCESS BOILER			Refrigerate			03 Occupancy Types	Within Project:	06 # of Stories (Habitable	Above Grade) 1
This section does not apply to this project.			d Commercial Forming Process Commercial Elevators	Moving Computer Commercial Laboratory/ Factory	Controlled Steam Multifamily	All Other Occupancies    Office			
			Warehouse Reingeratio Exhaust Bollers Air Cortame 120.0(1)/	Walloway Nooms Kitchens Cohaget	Environment Traps Pool/Spa Horticulture 120.6(i) 160.7 Compliance				
J. COMPRESSED AIR SYSTEMS		1	130.6(a) (See Table 120.6(c) 120.6(d) 120.6(e) (See Table	120.6(g)   140.9(d)   140.9(d)   140.9(d)	120.6(h) (See (See Table Results	-			
This section does not apply to this project.			(See Table G) (See Table I) (See Table 2) K)		(See Table P) Table Q) R)	B. PROJECT SCOPE			
		1	f) nj	3		This table includes process systems that are within requirements in 140.9.	in the scope of the permit application an	nd are demonstrating compliance w	with mandatory requirements in 120.6 / 160.7 or preso
K. ELEVATOR LIGHTING AND VENTILATION				Yes	COMPUES	My project consists of: (check all that apply):			
			-			my project consists on (check an eliat appropri		T	02
This section does not apply to this project.			D. EXCEPTIONAL CONDITIONS			☐ Refrigerated Spaces <3,000 ft² Total (no	Title 24 Pt6 requirements	☐ Fscalator & Moving	Walkway Speed Controls (mandatory 120.6(g))
			This table is auto-filled with uneditable comments because of selections made	or data entered in tables throughout the form.		☐ Refrigerated Spaces >= 3,000 ft <sup>2</sup> Total (r	770000000		mandatory 120.6(j) and prescriptive 140.9(a))1
L. ESCALATORS AND MOVING WALKWAYS SPEED CONTROLS						Food /Beverage Stores >8,000 ft <sup>2</sup> cfa (n	The second secon		Ventilation/Exhaust (prescriptive 140.9(b)) <sup>1</sup>
This section does not apply to this project.			E. ADDITIONAL REMARKS			☐ Enclosed Parking Garage Exhaust >= 10,			/Factory Exhaust & Fume Hood (prescriptive 140.9(c)) <sup>1</sup>
			This table includes remarks made by the permit applicant to the Authority Hav	vina lurisdiction		☐ Newly Installed Process Boilers (manda	TESCOL STANCE FOR THE STANCE OF THE STANCE O	☐ Pool/Spa (mandator	
M. COMPUTER ROOM SYSTEM SUMMARY			The same memorial remains move by the period applicable to the Authority not	mg an administra		☐ Compressed Air Systems Combined HP			ment Horticulture (mandatory 120.6(h))
This section does not apply to this project.			F			☐ Elevator Lighting & Ventilation Controls	4 - 4	☐ New Steam Traps (m	
			F. REFRIGERATED WAREHOUSES/SPACES			<sup>2</sup> FOOTNOTES: These building features can compl			ese features, compliance should be demonstrated on th
N. COMMERCIAL KITCHEN EXHAUST AND VENTILATION			This section does not apply to this project.			NRCC-PRF-E.	¥ ****		
This table contains all new and replacement hoods being installed within the	scope of the permit application. Table N is used to demonstrat	te compliance with prescriptive requirements	2		- 57				
found in 140.9(b). Kitchen Ventilation 140.9(b)2			G. COMMERCIAL REFRIGERATION						
	ng replaced as part of an addition or alteration (do not need to	o meet requirements	This section does not apply to this project.						
Exacting stichen hoods not be	Requirements	o meat redonaments)							
CA Building Energy Efficiency Standards - 2022 Nonresidential Compliance	Generated Date/Time:  Report Version: 2022.0.000 Schema Version: rev 20220101	Documentation Software: Energy Code Ace Compliance ID: 167698-0124-0002 Report Generated: 2024-01-02 07:34:34	CA Building Energy Efficiency Standards - 2022 Nonresidential Compliance	Generated Date/Time: Report Version: 2022 0.000 Schema Version: rev 20220101	Documentation Software: Energy Code Ace Compliance ID: 167698-0124-0002 Report Generated: 2024-01-02 07:34:34	CA Building Energy Efficiency Standards - 2022 Nonre	sidential Compliance Repo	erated Date/Time: ort Version: 2022.0.000 ema Version: rev 20220101	Documentation Software: Energy Co Compliance ID: 167698-012 Report Generated: 2024-01-02-0:
			<del> </del>					AT THE STATE OF TH	
STATE OF CALIFORNIA			STATE OF CALIFORNIA			STATE OF CALIFORNIA			
Process Systems		CALIFORNIA ENERGY COMMISSION	Process Systems		CALIFORNIA ENERGY COMMISSION	Process Systems			CALIFORNIA ENERGY COMM
CERTIFICATE OF COMPLIANCE	Francis Const.	NRCC-PRC-E	CERTIFICATE OF COMPLIANCE		NRCC-PRC-E	CERTIFICATE OF COMPLIANCE	Company Brook had been	- In	NRC
Project Name: 23-938 Lucerne Community Valley Center Renovation  Project Address:	Report Page: Date Prepared:	(Page 6 of 6) 2024-01-02T10:34:30-05:00	Project Name: 23-938 Lucerne Community Valley Center Renovation	Report Page: Date Prepared:	(Page 5 of 6) 2024-01-02710-34:30-05:00	Project Name: 23-938 Lucerne Community Valley I	Deliter heriovation	Report Page: Date Prepared:	(Pag 2024-01-02T10:34:3
								1	
						2000-1000-00-00-00-00-00-00-00-00-00-00-0			
DOCUMENTATION AUTHOR'S DECLARATION STATEMENT			R. Pool & SPAs			N. COMMERCIAL KITCHEN EXHAUST AND VI	ENTILATION		
I certify that this Certificate of Compliance documentation is accura-	e and complete.					02		to Hood Compliance Method 140.9	
Documentation Author Name:	Documentation Author Signature: Will	Coulton	This section does not apply to this project.	<u></u>			Providing replacement air directly to the		
Will Cariton	Senimino flute:	w- and				03 Mechanically cooled			ned per 140.9(b)2A to not exceed the greater of:
GMEP Engineers	01/02/2024		S. DECLARATION OF REQUIRED CERTIFICATES OF INSTALLATION			27		nus the available transfer air from a	
Activess: 26439 Rancho Pkwy, Suite 120	CEA/ HERS Certification Identification (if applicable):		Selections have been made based an information provided in this document. I		ant, an explanation should be included in Table E.		nat is supplying transfer air:	d to a cidlo connection of	Kitchen"/>
City/Sets/Zer Lake Forest, CA 92630	Phone: 949.267.9095 ext. 320		Additional Remarks. These documents must be provided to the building inspec https://www.energy.ca.gov/programs-and-topics/programs/building-energy-		14	05			is designed to have one of the following per 140.9(b)2(
RESPONSIBLE PERSON'S DECLARATION STATEMENT I certify the following under penalty of perjury, under the laws of the State of California:						Kitchen Exhaust: Airflow Rate 140.9(b)1B	Not a kitchen/ dining facility having a to	туре гани туре и киспеп пооб	consess difficw face > 2,000 Cim
<ol> <li>The information provided on this Certificate of Compliance is true and correct.</li> </ol>				Form/Title				A NORTH OF SERVICE ASSET	NA: Kitchen/ dining facility has a total Type I and Type
<ol> <li>I am eligible under Division 3 of the Business and Professions Code to accept resper</li> <li>The energy features and performance specifications, materials, components, and re</li> </ol>			NRCI-PRC-01-E - Covered Process			01 Kitchen Name or Item Tag	Kitchen Compl	lance Method per 140.9(b)18	kitchen hood exhaust airflow rate <= 5,000 cfm
of Title 24, Part 1 and Part 6 of the California Code of Regulations						02 03	04 05	06	97 98
<ol> <li>The building design features or system design features identified on this Certificate plans and specifications submitted to the enforcement agency for approval with this</li> </ol>	s building permit application.		T. DECLARATION OF REQUIRED CERTIFICATES OF ACCEPTANCE			Name or Item Hood Type <sup>1</sup>	Hood Style Hood Leng		Design Hood Exhaust Rate Max Hood Exhaust
<ol> <li>I will ensure that a completed signed copy of this Certificate of Compliance shall be inspections. I understand that a completed signed copy of this Certificate of Compliance.</li> </ol>			Selections have been made based on information provided in this document. I			1dE	ricos sepic (ft)	Sara (ISSN STORY)	CFM Allowed CFM
	Responsible Designer Signature: Onesa Than		Additional Remarks. These documents must be provided to the building inspec Provider (ATTCP). Far more information visit: http://www.energy.ca.gov/title2	tor during construction and must be completed through	ugh an Acceptance Test Technician Certification	Hood 1 Type I		4	1500
Company GMEP Engineers	Date Signed: 01/02/2024				Systems (Course To the Civile)	<sup>1</sup> FOOTNOTES: Type II hoods do not have a max ho	ood exhaust air rate per 140.9(b)18		
20439 Rancho Pkwy, Suite 120	M34279		form/	Title	Systems/Spaces To Be Field Verified				
City/Scate/Zay: Lake Forest, CA 92630	949,267,9095		NRCA-PRC-02-F Kachen Exhaust		Kitchen	O. LABORATORY AND FACTORY EXHAUST AF	ND FUME HOODS		
						This section does not apply to this project.			
						P. CONTROLLED ENVIRONMENT HORTICULT	LIRE		
						A Company of the company of the second secon	ONE		
						This section does not apply to this project.			
						Q. STEAM TRAPS IN INDUSTRIAL FACILITIES			
						This section does not apply to this project.			
	Generated Date/Time:	Documentation Software: Energy Code Ace		Generated Date/Time:	Documentation Software: Energy Code Ace		Gene	erated Date/Time:	Documentation Software: Energy Co
							and the same of th		
CA Building Energy Efficiency Standards - 2022 Nonresidential Compliance	Report Version: 2022.0.000	Compliance ID: 167598-0124-0002	CA Building Energy Efficiency Standards - 2022 Nonresidential Compliance	Report Version: 2022.0.000	Compliance   D: 167698-0124-0002	CA Building Energy Efficiency Standards - 2022 Nonre		ort Version: 2022.0,000	Compliance ID: 167698-012
CA Building Energy Efficiency Standards - 2022 Nonresidential Compliance	Report Version: 2022.0.000 Schema Version: rev 20220101	Compliance ID: 167598-0124-0002 Report Generated: 2024-01-02 07:34:34	CA Building Energy Efficiency Standards - 2022 Nonresidential Compliance	Report Version: 2022.0.000 Schema Version: rev 20220101	Compliance ID: 167698-0124-0002 Report Generated: 2024-01-02 07:34:34	CA Building Energy Efficiency Standards - 2022 Nonre		ort Version: 2022.0.000 ema Version: rev 20220101	Compliance ID: 167698-012 Report Generated: 2024-01-02 0
CA Building Energy Efficiency Standards - 2022 Nonresidential Compliance			CA Building Energy Efficiency Standards - 2022 Nonvesidential Compliance			CA Building Energy Efficiency Standards - 2022 Nonre			



DWG NO.

UNDERGROUND SERVICE ALERT

Call: TOLL FREE

1-800-227-2600
OR
811

TWO WORKING DAYS BEFORE YOU DIG

MARK: BASIS OF BEARINGS:





						_						
	REVISIONS											
						Α						
MARK	DATE	INITIAL	DESCRIPTION	APPR.	DATE							

PLANS APPROVED BY: SAN BERNARDINO COUNTY - PUBLIC WORKS SPECIAL DISTRICTS										
David R. Doublet To serve the fix Code  To se										
		INITIAL	DATE							
APPROVALS	PROJECT MANAGER	Alfonso Fausto	Uptaily signed by Afterso Foacis Cale: 2004;0524 08:53 88-0700							
AI I NOVALO	OPS, DĮVĮSĮON MANAGER	Henry Mac	Physical control of B.E.V. a resolved region. A pr. Distriction may be a submission of the physical or submission of the physical or submission.							
	PM, DIVISION MANAGER	Noel Mondragon	Digitally against by Tool Montagon DMC-CAT. Extraordings of the constraints of the factor against Catholic Catholic Montagon DMC-CATHOLIC CATHOLIC CATHOLIC CATHOLIC CATHOLIC CATHOLIC CATHOLIC CATHOLIC CATHOLIC CATHOLIC CA							

IMPROVEMENT PLANS

CSA 29 LUCERNE VALLEY COMMUNITY

csa 29 lucerne valley community center renovation project TITLE 24 FORMS

FILE NO.

06-20-2024

SHEET **T-24.0** 



GENERAL PLUMBING NOTES

EXISTING CONDITIONS ARE BASED ON LIMITED FIELD VERIFICATION CONTRACTOR SHALL ADJUST TO ACTUAL FIELD CONDITIONS AT NO ADDITIONAL EXPENSE TO THE OWNER.

ALL CONTRACTORS SHALL REVIEW A COMPLETE SET OF CONSTRUCTION DOCUMENTS, PLUMBING CONTRACTOR SHOULD COORDINATE HIS MORK NITH ALL OTHER TRADES. THIS INCLUDES COORDINATING THE LOCATION AND SIZE OF ALL OTENINGS, LOCATIONS OF EQUIPMENT PAD, AND CHANGES OF

CONTRACTOR SHALL FAMILIARIZE HIMSELF WITH DEMOLITION RESPONSIBLE TO BIDDING AND START OF MORK, CONTRACTOR IS RESPONSIBLE ALL EXISTING AS REQUIRED FOR INSTALLATION/CONSTRUCTION OF NEW MORK,

CONTRACTOR SHALL BE RESPONSIBLE FOR FIELD VERIFICATION OF ALL EXISTING CONDITIONS FRIOR TO SUBMITTING HIS BID. VERIFY LOCATION, ELEVATIONS, AND SIZES OF ALL EXISTING PLUMBING AND INFORM THE ARCHITECT OF ANY DISCREPANCIES, NO ADDITIONAL COMPENSATION MILL BRADE FOR ANY EXTRAS DUE TO CONTRACTOR'S FAILURE TO VISIT THE JOBSITE AND/OR PREDETERMINE ALL EXISTING CONDITIONS BEFORE SUBMITTING HIS BID. ANY DISCREPANCIES SHALL BE IMMEDIATELY REPORTED TO THE ARCHITECT FOR RESOLUTION. NO EXCEPTION.

CONTRACTOR SHALL BE RESPONSIBLE FOR THE FIELD VERIFICATION OF ALL UTILITY RINS, INDERSEAUND AND ABOVE GROUND PIPING AND/OR OTHER IMPROVEMENTS LOCATED ON THE PREMISES, CONTRACTOR SHALL ALSO BE RESPONSIBLE FOR ALL COSTS RELATING TO THE RELOCATION OF DAMAGE TO, REPAIR OF ANY EXISTING UTILITY RINS AND/OR IMPROVEMENTS WHICH ARE DAMAGED AS A RESULT OF MORK IN OR AROUND THE PREMISES.

IT IS THE CONTRACTOR'S RESPONSIBILITY TO PREPARE ACCURATE AS-BUILT DRAWINGS DURING CONSTRUCTION AND SUBMIT FOR APPROVAL UPON COMPLETION OF INSTALLATION.

CONTRACTOR SHALL FINISH ALL MATERIALS, LABOR, EQUIPMENT CONTROLOR SHELL FINDER LE MALERIAND, LABOR, EQUIPPIENT, TRANSPORTATION AND SERVICES REQUIRED FOR COMPLETING THE WORK. ALL MATERIALS AND WORK SHALL COMPLY WITH APPLICABLE CODES AND REGULATIONS AND MEET THE APPROVAL OF STATE & LOCAL JURISDICTION.

WATER HEATER SHALL BE CERTIFIED BY THE MANUFACTURER AND MUST COMPLY WITH THE EFFICIENCY STANDARDS OF THE CALIFORNIA ENERGY COMMISSION, 2019 EDITION.

ALL HOT WATER PIPING SHALL BE INSULATED WITH ARMSTRONG "ARMAFLE) INSULATION PER SECTION 609.12 OF THE 2022 PLIMBING CODE AND TABLE 120.3-A, SECTION 120.3 OF THE 2022 CALIFORNIA ENERGY CODE.

CONTRACTOR SHALL VERIFY WATER PRESSURE CONDITIONS AT THE PROJECT SITE. CONTRACTOR SHALL PROVIDE INSTALL A PRESSURE REGULATOR WHERE THE SUPPLY PRESSURE EXCEEDS 80 PSI.

ALL PIPING SHALL BE SUPPORTED AT INTERVAL NOT TO EXCEED THOSE SHOWN IN CPC TABLE 313.3

ALL POTABLE WATER OUTLETS WITH HOSE ATTACHMENTS, SUCH AS HOSE BIBS, AND MOP SINKS ARE TO BE PROVIDED WITH A BACKFLOW/ANTI-SIPHON DEVICE.

ALL CONCEALED PIPING SHALL BE INSTALLED PER CALIFORNIA PLUMBING CODE 2022. NO EXCEPTION.

IS LAVATORIES IN PUBLIC RESTROOMS SHALL BE LIMITED TO 0.5GPM

ALL FAUCETS SHALL COMPLY WITH CALIFORNIA PROPOSITION 65 AND SHALL BE CERTIFIED TO NSF STANDARD 61 SECTION 9 FOR DRINKING WATER COMPONENTS.

ALL REQUIRED CLEANOUTS SHALL BE INSTALLED AS PER SEC. 101.0 & 719.0 OF THE 2022 CALIFORNIA PLUMBING CODE.

FLOOR DRAINS OR SIMILAR TRAPS DIRECTLY CONNECTED TO THE DRAINAGE SYSTEM AND SUBJECT TO INFREQUENT USE SHALL BE PROVIDED WITH AN APPROVED AUTOMATIC MEANS OF MAINTAINING THEIR WATER SEALS.

NEW WATER CLOSET AND ASSOCIATED FLUSHMETER VALVES SHALL BE NO MORE THAN I.26 GALLONS PER FLUSH AND SHALL MEET THE AMERICAN STANDARDS INSTITUTE STANDARD AII2.19.2 H&S CODE, SECTION 17921.3(B).

NEW URINALS AND ASSOCIATED FLUSHMETER VALVES SHALL BE NO MORE THAN 0.125 GALLONS PER FLUSH AND SHALL MEET THE AMERICAN STANDARDS INSTITUTE STANDARD AII2.19.2 H&S CODE, SECTION 17921.3(B).

ALL PLUMBING VENTS SHALL TERMINATE NOT LESS THAN TEN(IO) FEET FROM OR AT LEAST THREE (3) FEET ABOVE ANY DOOR, OPENING, FRESH AIR INTAKE OR VENT SHAFT.

SLOPE ALL CONDENSATE DRAIN LINES AT 1% AND SLOPE ALL SEWER PIPING MINIMUM OF 2%.

MASTE & VENT PIPING MATERIAL; SHALL BE ABS/PVC OR AB&I SERVICE MEIGHT CAST IRON NO-HUB SOIL PIPE AND FITTINGS MITH NO-HUB CLAMPS, MUST CONFORM TO CISPI STANDARD 301.040 & 30.04 AND CLEARLY MARKED MITH THE CAST IRON SOIL PIPE INSTITUTE TRADEMARK, MANUFACTURER'S NAME AND COUNTRY OF ORIGIN, ABS/PVC CAN BE USED IF ALLOWED BY LOCAL AUTHORITY HAVING JURISDICTION.

WRAP ALL IRON AND COPPER PIPE AND FITTINGS BELOW SLAB OR GRADE WITH 8 MIL POLYETHYLENE WRAP AND 6" MINIMUM ENVELOPE OF CLEAN SAND. ALL ROUND PIPE IN ACCORDANCE WITH NSI/AWWA STANDARD CIOS/A215-62.

WATER PIPE SHALL BE TYPE "L" ABOVE GRADE, HARD DRAWN COPPER TUBING, WITH MROUGHT COPPER FITTINGS, SOLDER ALL JOINTS WITH LEAD-FREE SOLDER.

CONDENSATE DRAIN PIPE SHALL BE TYPE "DWV" HARD DRAWN COPPER TUBING WITH MROUGHT COPPER FITTINGS, 50-50 SOLDERED JOINTS, INSULATE ALL CONDENSATE DRAIN PIPING WITHIN BULLDING INTERIOR.

NEW OR REPAIRED PORTABLE WATER SYSTEMS SHALL BE DISINFECTED PRIOR TO USE ACCORDING TO THE METHODS IN CPC 2022 609.10. NO EXCEPTION.

CONTRACTOR TO PROVIDE THERMOSTATIC MIXING VALVES FOR PUBLIC-USE LAYATORIES TO LIMIT TEMPERATURE TO A MAXIMUM OF 120 DEGREES FAHRENHEIT (2022 CPC 4013).

THIS DOCUMENT IS NOT FOR BID OR CONSTRUCTION UNTIL THE PLAN HAS THIS DECOMENT IS NOT FOR SID OR COMPINENTIAL THE TEAM OF THE BEAN REVIEWED AND APPROVED BY ALL AUTHORITIES HAVING JURISDIAND THE PERMIT IS OBTAINED. NO COMPENSATION WILL BE MADE FOR ADDITIONAL WORK DUE TO THE VIOLATION OF THIS REQUIREMENT.

30. THIS PROJECT MUST COMPLY WITH THE CALIFORNIA PLUMBING CODE 2022.



			DOME	STIC WATER		DRA	NAGE
FIXTURE TYPE	atr	FIXTURE DEMAND	HOT DEMAND	TOTAL WATER DEMAND (WSFU)	TOTAL HOT WATER DEMAND	DFU	TOTAL
WATER CLOSET, FLUSH TANK	3	2.5	0.0	7.5	0.0	4	12
LAVATORY	2	1.0	1.0	2.0	2.0	ı	2
URINAL, WATERLESS	I	0.0	0.0	0.0	0.0	2	2
PREP SINK	1	1.5	1.5	1.5	1.5	2	2
HAND SINK	1	1.5	1.5	1.5	1.5	2	2
3-COMP SINK	1	3.0	3.0	3.0	3.0	3	3
MOP SINK	2	3.0	3.0	6.0	6.0	3	6
ICE MAKER/DRINKING FOUNTAIN	3	0.5	0.0	1.5	0.0	0	0
FLOOR SINK/DRAIN	8	0.0	0.0	0.0	0.0	2	16
TOTAL FIXTURE UNITS	·		•	23.0	14.0		45
EQUIVALENT WATER DEMAND IN GPM				16	II		
REQUIRED MINIMUM PIPE SIZE				I.	I.		4"

PIPING SYMBOLS

SYMBOL DOMESTIC COLD WATER DOMESTIC HOT WATER DOMESTIC H.W. CIRCULATING SANITARY SEWER VENT PIPING

STORM DRAIN PIPING GREASE WASTE — cp — CONDENSATE DRAIN

SYMBOI MEANING FLOOR SINK  $\Theta$ FLOOR CLEANOUT WALL CLEANOUT FLOOR DRAIN GAS COCK TUB-I PLUMBING FIXTURE CONNECT TO EXISTING

SHUT-OFF VALVE  $\sim$ 1 <del>-</del>0⁄-RECIRCULATION PUME PIPE CAP PIPE ELBOW DOWN

**-**∋ PIPE ELBOW UP

**KEYED PLAN** SCALE:NONE

BENCHMARK:

Call: TOLL FREE 1-800-227-2600

UNDERGROUND SERVICE ALERT

TWO WORKING DAYS BEFORE YOU DIG



BASIS OF BEARINGS:



REVISIONS											
						-					
						,					
						APP					
						/					
MARK	DATE	INITIAL	DESCRIPTION	APPR.	DATE						
MARK	DATE	INITIAL	DESCRIPTION	APPR.	DATE	AP					

SAN BERNARDINO COUNTY - PUBLIC WORKS SPECIAL DISTRICTS

David R. Doublet INITIAL DATE Alfonso Fausto | Bendy signed by Alfonso Fausto OPS, DĮVĮSĮON MANAGER Henry Mac PM, DIVISION MANAGER Noel Mondragon


	06-2
IMPROVEMENT PLANS	DWG NO.

CSA 29 LUCERNE VALLEY COMMUNITY CENTER FILE NO. RENOVATION PROJECT PLUMBING

SHEET **P-1.0 GENERAL NOTES** 

ENGINEERS

26439 Rancho Pkwy. S., Ste 12 Lake Forest, CA 92630 06-20-2024

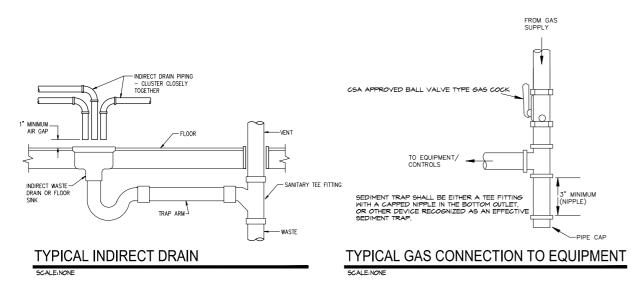


& PRESSURE RELIEF VALVE

DRAIN VALVE-

PLUG COCK

CHECK VALVE

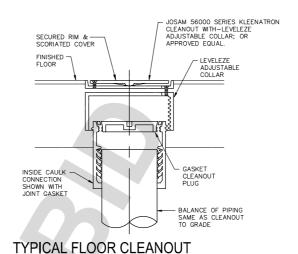



BASE FLASHING BY GEN'L. CONT'R.

SCALE:NONE BALL VALVE - WATER SUPPLY TRAP PRIMER VALVE DISTRIBUTION
UNIT AS REQ'D
2 TO 4 OPN'G CONNECTION TO FL DR TRAP (TYPICAL)

CRIMP EDGE OVER PIPE IN A NEAT MANNER TO PREVENT REDUCTION OF EFFECTIVE VENT AREA.

SHEET COPPER OR LEAD COUNTER FLASHING BY PLBG. CONT'R. (TO MATCH MATERIAL OF BASE FLASHING).

REFER TO ARCH. DWGS. FOR ROOF CONSTRUCTION.

## TYPICAL TRAP PRIMER DETAIL

FINISHED FLOOR -WATER-PROOF MEMBRANE STRUCTURAL SLAB PIPE SIZE AS NOTED ON PLAN

NOTE: INDIRECT WASTE PIPING EXCEEDING 5'
IN LENGTH SHALL BE TRAPPED WITH THE
EXCEPTION OF CLEAR WATER WASTES. TYPICAL FLOOR SINK

SCALE: NONE



06-20-2024

- MAY EXTEND AS A WASTE OR VENT CLEAN -OUT PLUGGED TEE W/CLEANOUT BALL-TYPE SHUT-OFF VALVE (TYP.) COLD WATER SUPPLY AMTROL THERMAL BALANCE OF PIPING SAME AS CLEANOUT TO GRADE. EXPANSION TANK MODEL ST-12 HOT WATER OUTLET TEMPERATURE TYPICAL WALL CLEANOUT

GAS WATER HEATER DETAIL (W/RECIRCULATION LOOP) SCALE:NONE

WATER

**HEATER** 

3-Compartment Sink Sanitize Wash Sink Sink Sink 2" Outlet to Floor Sink

THREE COMPARTMENT SINK

UNDERGROUND SERVICE ALERT BENCHMARK: BASIS OF BEARINGS: Call: TOLL FREE 1-800-227-2600

TWO WORKING DAYS BEFORE YOU DIG

DISCHARGE PIPE SHALL DISCHARGE OUTSIDE OF THE BUILDING WITH THE END OF THE PIPE NOT EXCEEDING 2 FEET AND NOT LESS THAN 6 INCHES ABOVE THE GROUND AND POINTING DOWNARDS

RECIRC LINE

LINE TEMP. CONTROL

CIRCULATING

PUMP  $(\underline{CP-1})$ 

FOR SEISMIC BRACING.






			REVISIONS			
						ASS
						ASS
						APPRO
MARK	DATE	INITIAL	DESCRIPTION	APPR.	DATE	

PLANS APPROVED BY: SAN BERNARDINO COUNTY - PUBLIC WORKS SPECIAL DISTRICTS										
avid R. Double Type project process, Security of Charlest Country										
ISTANT	DIRECTOR		DATE							
		INITIAL	DATE							
VALS PROJECT MANAGER Alfonso Fausto Projective de transforme										
OPS, DIVISION MANAGER Henry Mac										
	DM DIVISION MANACED	Neel Mendrages	Digitally righted by No. Montrages.  DNO 60. 5 - revision or group project contribution.	1						

DWG NO. IMPROVEMENT PLANS CSA 29 LUCERNE VALLEY COMMUNITY CENTER FILE NO. RENOVATION PROJECT **PLUMBING** SHEET **P-1.1 DETAILS** 

CONCRETE PAD

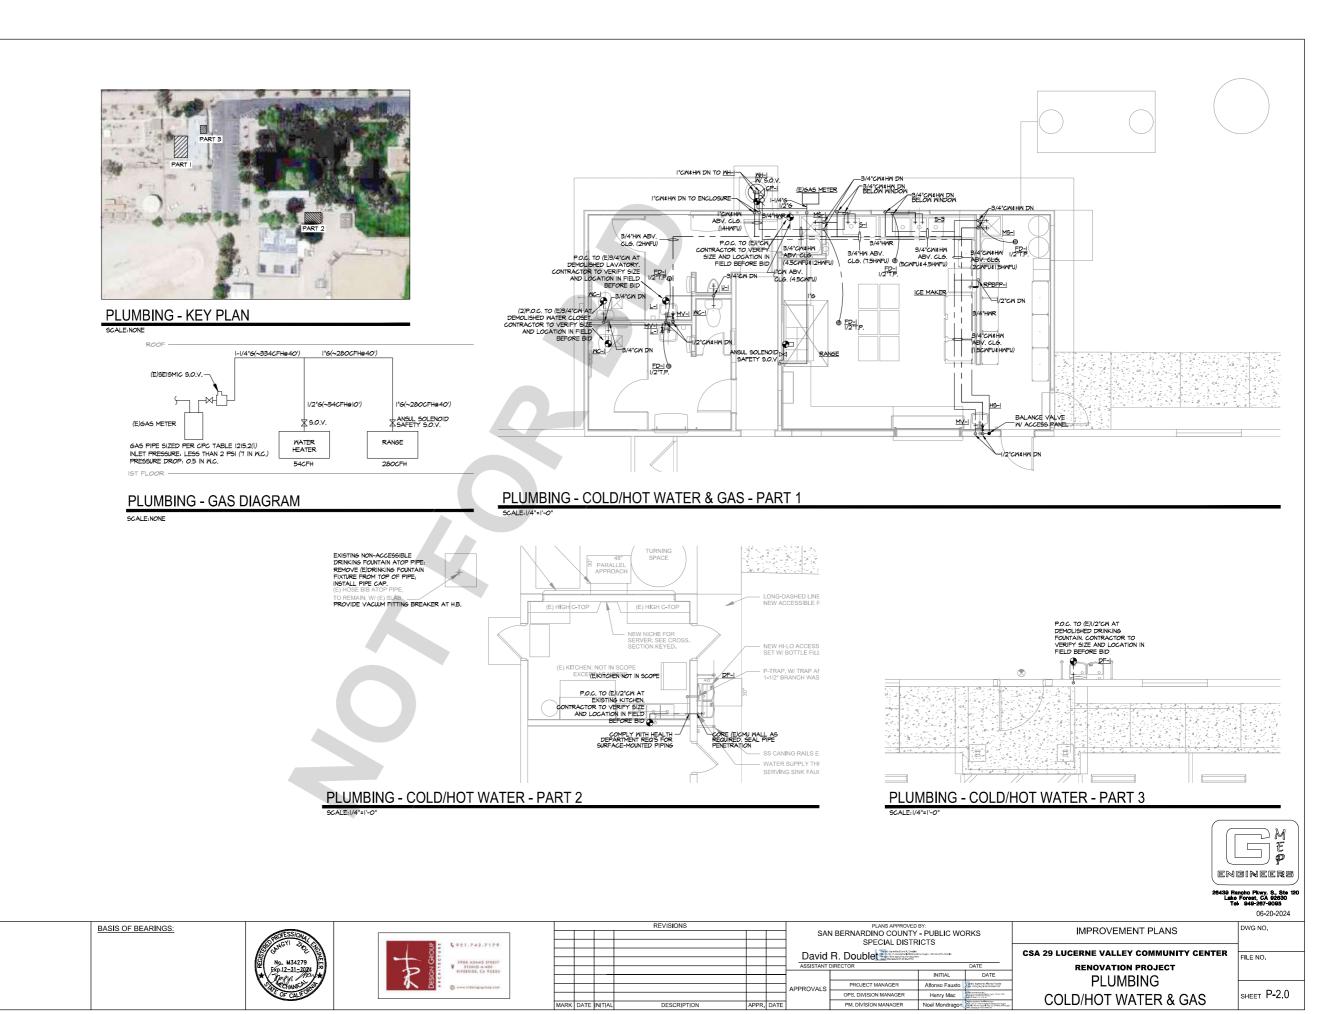


UNDERGROUND SERVICE ALERT

TWO WORKING DAYS BEFORE YOU DIG


Call: TOLL FREE


BENCHMARK:

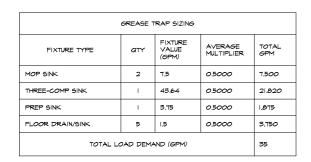




## PLUMBING - KEY PLAN

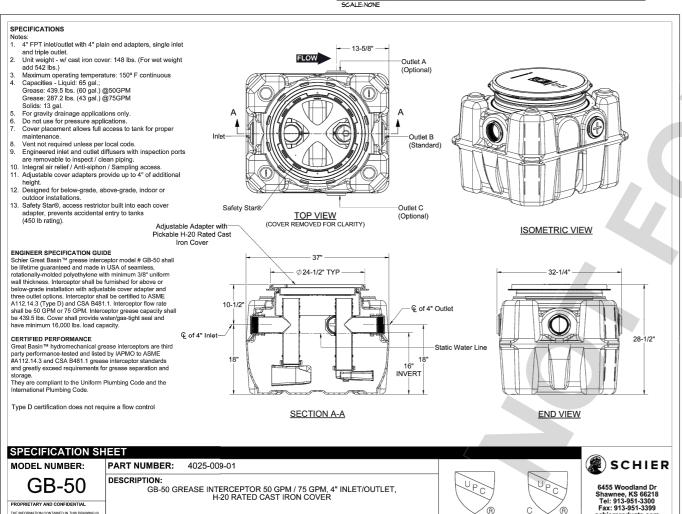

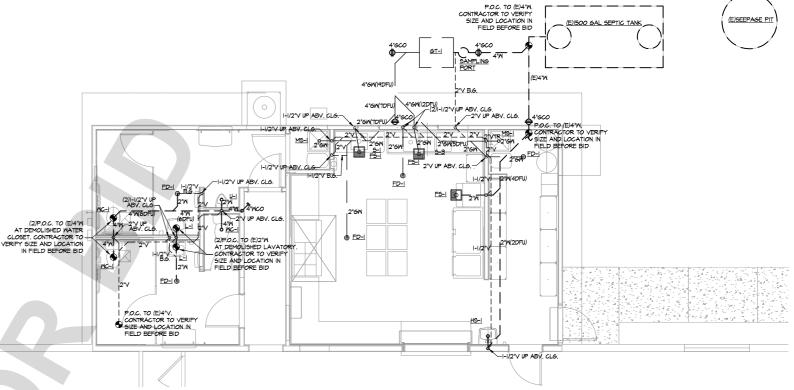

#### PLUMBING - WASTE & VENT - PART 1

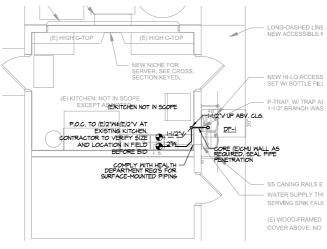

PLUMBING - WASTE & VENT - PART 2

PLUMBING - WASTE & VENT - PART 3

# ENGINEERS

#### GREASE INTERCEPTOR SPECIFICATION

THE REPORTUDING CONTINUED IN THIS DISJUNCTION OF THE PRODUCTS ANY REPORTUDING ANY REPORTUDING

SCALE:NONE

PROPRIETARY AND CONFIDENTIAL



TWO WORKING DAYS BEFORE YOU DIG

Call: TOLL FREE 1-800-227-2600

BASIS OF BEARINGS:





			REVISIONS			
						D
						ASS
						ASS
						APPRO
MARK	DATE	INITIAL	DESCRIPTION	APPR.	DATE	

PLANS APPROVED BY: SAN BERNARDINO COUNTY - PUBLIC WORKS SPECIAL DISTRICTS David R. Doublet Alfonso Fausto Henry Mac OPS, DĮVĮSĮON MANAGER

PM, DIVISION MANAGER

06-20-2024 DWG NO. IMPROVEMENT PLANS CSA 29 LUCERNE VALLEY COMMUNITY CENTER FILE NO. RENOVATION PROJECT PLUMBING SHEET **P-3.0 WASTE & VENT** 

#### LIGHTING FIXTURE SCHEDULE INPLIT LEGEND VOLT MOUNT DESCRIPTION MANUFACTURER MODEL NUMBER LAMPS NOTES COUNT WATTS A 12.6 APPROVED 0 VF6 LED 30K MW 12.6 120 RECESSED 6" DOWNLIGHT LED LITHONIA EQUAL ( <del>B</del> 44 ) AWKEYE T8 OR APPROVED 120 SURFACE 4' VAPOR TIGHT LINEAR LED PRIME LIGHTS LINEAR LED LED 44 9 OR APPROVED 120 2 SURFACE OUTDOOR WALL PACK LED 11 LITHONIA TWX1 LED 翌 EQUAL $\begin{pmatrix} X \\ 4 \end{pmatrix}$ LED EXIT W/ EMERGENCY LIGHTING 90 MINUTE BACKUP OR APPROVED 120 SURFACE LITHONIA ECRG HO SQ M6

) VERIFY WITH OWNER OR ARCHITECT BEFORE PURCHASING THE LIGHTING FIXTURES. LIGHTING ABOVE FOOD OR UTENSILS SHALL BE SHATTERPROOF.

#### ELECTRICAL WIRING METHODS

- o) FOR UNDERGROUND AND EXPOSED UP TO +5'-0", OR DAMP LOCATION, THE CONDUIT SHALL BE RIGID STEEL GALVANIZED IMC. NO RUNNING THREADS ARE PERMITTED.
- b) GALVANIZED EMT SHALL BE USED IN DRY CONCEALED LOCATIONS AND EXPOSED
- c) GALVANIZED FLEXIBLE CONDUIT SHALL BE USED ONLY FOR MOTOR AND FIXTURE CONNECTIONS IN LENGTHS NOT TO EXCEED 6'.
- d) CONDUITS PENETRATING THE ROOF SHALL BE FLASHED AND COUNTER FLASHED.
- e) PVC SCHEDULE 40 MAY BE USED UNDER FLOOR SLABS OR UNDERGROUND WITH GROUND WIRE. PVC UNDERGROUND TO HAVE 24 INCH COVER.
- f) SERVICE CONDUITS SHALL BE PVC SCHEDULE 40 OR AS SPECIFIED BY UTILITY
- g) INSTALL FITTINGS, SPECIAL DEVICES AND MATERIAL, WHICH MAY BE REQUIRED FOR THE PROPER INSTALLATION OF THE CONDUIT SYSTEM.
- REFER TO NEC 300.5 FOR UNDERGROUND INSTALLATION REQUIREMENTS AND DETAILS NEC 300.6 FOR CORROSION AND DETERIORATION AREAS.

ngs Rd

OLD WOMAN SPRINGS RD

AREA OF WORK

100

247

- a) ALL EQUIPMENT MUST BE U.L. LISTED. NO EXCEPTION.
- PROVIDE U,L LISTED THERMAL BARRIER WHERE LIGHTING FIXTURES IN CONTACT WITH
- WHEN LIGHTING FIXTURES ARE INSTALLED IN FIRE RATED CEILINGS OR WALLS, AN APPROVED FIRE RESISTIVE MANNER CONSISTENT WITH FIRE RATING OF CEILING OR WALLS MUST BE PROVIDED. NO EXCEPTION.
- e) REFER TO LATEST ARCHITECTRAL REFLECTED CEILING PLAN FOR EXACT LIGHTING
- CONFIRM WITH ARCHITECTURE FOR LIGHTING FIXTURE SPECIFICATIONS PRIOR TO ANY
- ALL FLUORESCENT LIGHTING FIXTURES MUST BE EQUIPPED WITH INTERNAL SWITCH TO DISCONNECT ALL CONDUCTORS TO BALLAST FROM THE SOURCE SIMULTANEOUSLY, INCLUDING THE GROUNDED CONDUCTOR IF ANY.
- LIGHTING STANDARDS REQUIRE A SEPARATE PERMIT. ALL SIGN REQUIRE SEPARATE PERMITS AND APPROVALS ALSO. NO EXCEPTION.

#### **GENERAL ELECTRICAL NOTES**

- VERIFY IN FIELD. ADJUST THE LOCATIONS OF HOMERUNS AND CIRCUIT NUMBERS ACCORDING TO EXISTING CONDITIONS IF NEEDED. COMMUNICATE WITH ENGINEER IF DESIGN SHOULD BE ALTERNATED. NO EXCEPTION.
- IDENTIFY ANY OBMOUS EXISTING CODE VIOLATIONS THAT OCCURS AS AN EXISTING CONDITION AND PROVIDE SEPARATE PRICING TO CORRECT THE CONDITION SO THAT IN THE END, THE ENTIRE ELECTRICAL INSTALLATION COMPLES WITH THE NATIONAL SELECTRICAL CODES AND ALL OTHER LOCAL CODES. IN THE END, THE ENTIRE ELECTRICAL INSTALLATION ELECTRICAL CODE AND ALL OTHER LOCAL CODES.
- ) IF THERE IS ANY DEVIATION FROM THE CIRCUITRY SHOWN, PROVIDE AS-BUILT DRAWINGS INDICATING SUCH
- AT THE COMPLETION OF CONSTRUCTION WORK, AND PRIOR TO THE FINAL REVIEW BY THE ARCHITECT, PROVIDE PANEL DIRECTORIES IN PANELBOARD FRONTS REFLE ALL CHANGES MADE DURING CONSTRUCTION.
- THIS DOCUMENT IS NOT FOR BID OR CONSTRUCTION UNTIL THE PLAN HAS BEEN REVIEWED AND APPROVED BY ALL AUTHORITIES HAVING JURISDICTION AND THE PERMIT IS OBTAINED. NO COMPENSATION WILL BE MADE FOR ADDITIONAL WORK DUE TO THE VIOLATION OF THIS REQUIREMENT.

#### LIGHTING FIXTURE NOTES

- INSULATION. OR PROVIDE 3" MINIMUM CLEARANCE

- o) THE DRAWINGS SHOW THE WORK TO BE IN PLACE AT THE COMPLETION OF INSTALLATION. MAKE NECESSARY ALTERNATIONS TO COORDINATE AND CONNECT THE EXISTING ELECTRICAL WORK WITH THE NEW SUCH THAT, WHEN THE WORK IS DONE, THE ENTIRE ELECTRICAL INSTALLATION, EXISTING AND NEW, IS IN COMPLETE

**DEMOLITION NOTES** 

CAUTION

THAT MAY OCCUR SHOULD FINAL BIDS AND/OR CONSTRUCTION BASED ON THESE DOCUMENTS BE STARTED PRIOR TO ELECTRICAL PLAN CHECK APPROVAL.

GMEP ENGINEERS SHALL NOT BE RESPONSIBLE FOR ANY ELECTRICAL CHANGE ORDERS

ALL WORK TO COMPLY WITH THE 2022 CBC, CPC AND CMC AND THE 2022 CEC (2020

ALL EQUIPMENT SHALL BE U.L. LISTED AND INSTALLED ACCORDING TO THE LISTING.

ALL CONDUCTORS SHALL BE COPPER AS FOLLOWS:

#10 AWG AND LARGER - STRANDED, THWN, THHN OR XHHW

MOUNTING HEIGHT FOR RECEPTACLES AND CONTROL DEVICES:

d) THE BOTTOM OF ELECTRICAL AND COMMUNICATION RECEPTACLES INTENDED TO BE USED BY THE OCCUPANT SHALL BE LOCATED NO LESS THAN 15". [ADA ACCESSIBIT

c) THE TOP OF SWITCHES SHALL BE INSTALLED NOT LESS THAN  $36^{\prime\prime}$  NOR MORE THAN

d) THERMOSTAT CONTROLS SHALL BE LOCATED NOT LESS THAN 36" NOR MORE THAN

O) DUE TO THE SMALL SCALE OF DRAWINGS, IT IS NOT ALWAYS POSSIBLE TO SHOW ALL DEVICES WHICH MAYBE REQUIRED. CONTRACTOR SHALL BE RESPONSIBLE TO VERIFY ALL EXISTING CONDITIONS BEFORE SUBMITTING HIS BID. NO ADDITIONAL COMPENSATION WILL BE MADE FOR EXTRA DUE TO CONTRACTOR'S FAILURE TO VISIT THE JOB SITE AND/OR FAILURE TO DETERMINE ALL EXISTING CONDITIONS BEFORE

b) RECEPTACLE OUTLETS SHALL BE LOCATED ABOVE, BUT NOT MORE THAN 20 IN.

ABOVE, THE COUNTERTOP. SUGGESTION HEIGHT IS 6" [NEC 210.52.C(5)]

ALL CONDUCTORS SIZES ARE BASED ON 75°C TEMPERATURE RATING

#12 AWG AND SMALLER - SOLID, TW

CONDUCTORS:

(CEC. 2022 TABLE 310.16)

GUIDELINES 4.27.3]

46" ABOVE THE FINISH FLOOR.

46" ABOVE FINISH FLOOR LINE

IMPORTANT BID NOTES:

SUBMITTING HIS BID.

- UNLESS SPECIFICALLY NOTED ON THE CONTRARY, ALL EXISTING LIGHTING FIXTURES, SWITCHES, CONTROLS AND OTHER MATERIALS OR EQUIPMENTS WHICH ARE REPLACED BY NEW AND ARE NOT INDICATED TO BE REUSED SHALL BE RETURNED TO THE OWNER OR BE DISPOSED AS DIRECTED BY THE OWNER.
- C) EXISTING MATERIAL TO REMAIN UPON COMPLETION IS INDICATED ON DRAWINGS AS EXISTING. FEEDERS (CONDUIT AND WIRES) ARE EXISTING TO THEIR RESPECTIVE SOURCE. ALTHOUGH NOT INDICATED ON THE DRAWINGS, TEMPORARY REMOVAL OR RE-ROUTE CONDUITS AND REPLACE EXISTING WIRES WITH NEW DURING CONSTRUCTION WORK MAYBE REQUIRED.
- d) PROVIDE AND INSTALL NEW COVER PLATES FOR ALL REMOVED OUTLETS, SWITCHES, LIGHT FIXTURES, AND OTHER ELECTRICAL DEVICES WHEN THE OUTLET BOX IS TO
- e) REMOVE ALL EXISTING ABANDONED FEEDERS (CONDUITS AND WIRES) BACK TO PANEL BOARDS. LABEL NEW PANEL DIRECTORY AS "SPARE".
- MAINTAIN CONTINUITY OF ALL ELECTRICAL SYSTEMS, EQUIPMENT, ETC., FED BY ABANDONED OUTLET. THEY SHOULD BE IN OPERATION AFTER THE WORK IS DONE. MAINTAINING CONTINUITY SHALL CONSIST OF RE-ROUTING OF CONDUIT AND WRING, AS REQUIRED TO SUIT THE EXISTING CONDITIONS.
- q) DASHED J-BOX DENOTES APPROXIMATE LOCATION OF EXISTING BOXES IN ACCESSIBLE CEILING SPACE. ALL CONDUIT SHOWN FROM J-BOX IS NEW UNLESS SHOWN OTHERWISE AS DASHED. REFER TO ELECTRICAL SYMBOL LIST.
- h) EXISTING LOADS SHOWN ON PANEL SCHEDULES ARE BASED ON ASSUMPTIONS MADE BY FIELD VISIT, ELECTRICAL BILLS OR PUBLIC RESOURCES. NOTIFY ENGINEER IMMEDIATELY IF LOADS EXCEED 16 AMPS ON ANY 20A /1P CIRCUIT.
- CAREFULLY REVIEW ARCHITECT'S DEMO DRAWINGS FOR LOCATION OF WALLS BEING REMOVED UNDER THIS SCOPE OF THIS WORK AND REMOVE ALL FEEDERS (CONDUITS AND WIRES) BACK TO LAST DEVICE LEFT IN SERVICE. DO NOT LEAVE ABANDONED.
- CAREFULLY REVIEW ARCHITECT'S DEMO DRAWINGS FOR EXISTING FLOOR BOXES BEING REMOVED LINDER THIS SCOPE OF WORK REMOVE FLOOR BOXES AND ALL FEEDERS (CONDUITS AND WIRES) BACK TO LAST DEVICE LEFT IN SERVICE. DO NOT LEAVE

#### ELECTRICAL SYMBOL LIST DESCRIPTION HOMERUN TO PANEL OR EQUIPMENT AS NOTED CONDUIT RUN CONCEALED IN WALL OR ABOVE FINISHED CEILING OR AS NOTED. —*//////*— 3/4°C.-8#12 ---- CONDUIT IN OR UNDER SURFACE AS NOTED, 3/4" MINIMUM SIZE. CONDUIT RUN WITH EQUIPMENT GROUNDING CONDUCTOR, SAME SIZE AS CIRCUIT CONDUCTORS, OR AS NOTED. CONDUCTORS, OR AS NOTED. CONDUCTORS, OR AS NOTED. CONDUCTORS, OR AS NOTED. —EM — CONDUIT WITH EMERGENCY CIRCUIT \_\_\_X \_\_\_ EXISTING CONDUIT TO REMAIN. \_\_\_\_R \_\_\_ EXISTING CONDUIT TO BE REMOVED. SECTION 2. EQUIPMENTS ELECTRICAL PANELBOARD, FLUSH OR SURFACE MOUNTED AS INDICATED LETTERED BALLOON INDICATES DESIGNATION JUNCTION BOX, ABOVE CEILING, OR AS REQUIRED TO SUIT THE APPLICATION APPROXIMATE LOCATION OF EXISTING J-BOX IN ACCESSIBLE CEILING SPACE DATA OUTLET IN WALL +18" OR AS NOTED. SINGLE GANG OUTLET BOX WITH 3/4" CONDUIT AND PULL WIRE TO ACCESSIBLE CHILING SPACE. $\wedge$ COMBINATION TELE/DATA OUTLET BOX, +18" OR AS NOTED. SINGLE GANG OUTLET WITH 3/4" CONDUIT AND PULL WIRE TO ACCESSIBLE CEILING SPACE Δ **(** WALL MOUNTED 2 HOUR BY PASS TIMER (TORK #A500 SERIES) b) REFER TO COMPLETE ARCHITECTURAL, MECHANICAL, ELECTRICAL, AND PLUMBING DRAWNOS FOR ADDITIONAL NOTES, SPECIFICATIONS, DETAILS, CONTROLS, ETC. REPORT TO ARCHITECTURE IMMEDIATLY IF ANY CONFLICTS OCCUR BETWEEN THE DRAWNGS AND INCLUDE ALL COST PER ARCHITECTURE'S CLARFICATION IN BASE BID. THIS REQUIREMENT WILL BE STRICTLY ENFORCED. NO CHANGE ORDERS WILL BE ALLOWED IF THE CONTRACTOR FAILS TO PERFORM THIS FUNCTION. EXHAUST FAN SWITCH, +48" OR AS NOTED ON MECHANICAL DRAWINGS \$EXH EXHAUST FAN, F.B.M., WIRED BY ELECTRICAL • FUSED DISCONNECT SWITCH, SIZE AND FUSED AS NOTED ON PLAN 마 \$ SINGLE POLE SWITCH, +42" OR AS NOTED HDO WALL MOUNTED DIMMER, 1000 WATT RATING OR AS NOTED. HEIGHTMOUNTING +42" A.F.F. OR AS NOTED. HDO.S. WALL MOUNTED DIMMER W/ OSCUPANCY SENSOR, LUTRON MAESTRO OR APPROVED EQUAL, HEIGHTMOUNTING +42" A.F.F. OR AS NOTED. DUPLEX RECEPTACLE FLUSH IN FLOOR BOX WITH DUPLEX HINGE COVERS $\varnothing$ DUPLEX RECEPTACLE IN WALL 120V, 20AMPS, +18" A.F.F, 3" ABOVE COUNTER $\Rightarrow$ OR AS NOTED. # TWO-GANG DUPLEX RECEPTACLE (QUADPLEX) IN WALL, +18" A.F.F OR AS NOTED <del>O</del>GFI GFI DUPLEX RECEPTACLE IN WALL, +42" A.F.F OR AS NOTED DUPLEX RECEPTACLE (20 AMP) +18" OR AS NOTED (ON A SEPARATE CIRCUIT) <del>=</del> SPECIAL RECEPTACLE NEMA TYPE AS DESIGNATED, +18" OR AS NOTED €

FLUSH POKE THRU COMBINATION TELE/DATA AND DUPLEX

| WALL MOUNTED MOTION SENSOR (THE WATT STOPPER "WA-300"). | OR EQUIVALENT.

DENOTES EXISTING RELOCATED DEVICE AT NEW LOCATION

0

• UP

o DN

(E)

(R)

SECTION 4. SENSORS

SECTION 5. MISCELLANEOUS

REFERENCE TO PLAN NOTES

CONDUIT STUBBED UP

CONDUIT STUBBED DOWN

DENOTES EXISTING TO REMAIN

DENOTES NEW TO MATCH EXISTING

DUPLEX PLUG RECEPTACLE, 120V, 20A, SHADED SIDE INDICATES "ISOLATED GROUND" TYPE DUPLEX ECEPTACLE. 18"A.F.F, 3" ABOVE COUNTER OR AS NOTED, DEVICE TO BE "ORANGE" IN COLOR.



icho Pkwy. 8., 8te 1 Forest, CA 92630 06-20-2024

DWG NO.

UNDERGROUND SERVICE ALERT



BENCHMARK



KEYED PLAN



				REVISIONS			Г
							H
							ĺΑ
	MARK	DATE	INITIAL	DESCRIPTION	APPR.	DATE	
_							_

SAN BERNARDINO COUNTY - PUBLIC WORKS SPECIAL DISTRICTS David R. Doublet

INITIAL DATE OPS, DĮVĮSJON MANAGER Henry Mac PM, DÍVÍSION MANAGER

IMPROVEMENT PLANS


CSA 29 LUCERNE VALLEY COMMUNITY CENTER RENOVATION PROJECT ELECTRICAL GENERAL NOTES

& SINGLE LINE

FILE NO. SHEET **E-1.0** 

TWO WORKING DAYS BEFORE YOU DIC

BASIS OF BEARINGS:

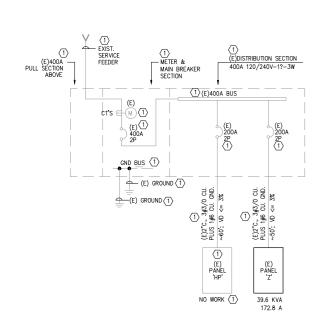

#### SINGLE-LINE DIAGRAM GENERAL NOTES

a) ALL CONDUCTORS SHALL BE COPPER AS FOLLOWS:

#12 AWG AND SMALLER - SOLID, TW

#10 AWG AND LARGER - STRANDED, THWN, THHN OR XHHW ALL CONDUCTORS SIZES ARE BASED ON 752C TEMPERATURE RATING (CEC. 2022 TABLE 310.16)


- b) ALL NEW CIRCUIT BREAKERS, FUSIBLE SWITCHES IN MAINSWITCHBOARD OR PANEL BOARDS SHALL BE SERIES RATED TO MATCH EXISTING AIC RATING OR APPROVED EQUAL OR 65KAIC, UNLESS NOTED OTHERWISE.
- ) MOTOR CIRCUIT PROTECTORS SHALL NOT BE A PART OF A SERIES COMBINATION INTERRUPTING RATING.
- d) Series combination aic rating shall not be used when the secondary equipment in the series is subjected to a total connected full load motor current of more than 1% of its aic rating.
- e) EQUIPMENT ENCLOSURES SHALL BE CLEARLY MARKED "CAUTION-SERIES RATED SYSTEM — 65KAMPS AVAILABLE, IDENTIFIED REPLACEMENT COMPONENTS REQUIRED", IN COMPLIANCE WITH 2022 CEC (2020 NEC) SECTION 110-22. END USE EQUIPMENT SHALL ALSO BE MARKED WITH THE HIGHER SERIES COMBINATION INTERRUPTING RATING AS PER 2022 CEC SECTION 240-83(C). NO EXCEPTION.
- FUSES SHALL BE PROVIDED WITH REJECTION TYPE FUSE HOLDERS.
- g) ELECTRICAL EQUIPMENT SHALL BE LISTED BY THE CITY, WHERE THE PROJECT IS LOCATED, RECOGNIZED ELECTRICAL TESTING LABORATORY OR APPROVED BY THE DEPARTMENT.
- h) NO PIPING, DUCTS OR EQUIPMENT FOREIGN TO ELECTRICAL EQUIPMENT SHALL BE PERMITTED TO BE LOCATED WITHIN THE DEDICATED SPACE ABOVE THE ELECTRICAL EQUIPMENT.
- MAIN SERVICE WILL NOT ENERGIZED PRIOR TO THE BUILDING INSPECTOR'S RECEIPT OF A THIRD PARTY "NRTL" TESTING LABORATORY PERFORMANCE TEST CERTIFICATION FOR THE SERVICE GROUND FAULT PROTECTION. 2020 NEC 230.95


#### SINGLE-LINE DIAGRAM KEYED NOTES

THE EQUIPMENT SHOWN IS EXISTING UNDER A PREVIOUS APPROVED CONSTRUCTION PERMIT, NOT A PART OF THIS SUBMITTAL, UNLESS NOTED AS NEW.

## ELECTRICAL SINGLE LINE

(EXISTING PANI	EL)														
PANEL 'Z'		LOCATION MAIN (AM			FICE L.0				BUS	S R	AT.	NG	200A		/240 V 1 Ø 3 W ITING: RECESSED
DESCRIPTION	VOLT ØA	AMPS Z/B		R C	I BKR	CKT NO	BUS BA BB	CKT	BKR	M I S	R E C	L T G	VOLT ØA	AMPS Z/B	DESCRIPTION
(E)CONF ROOM REC	360		П		20-	1 1	+	2	20-1				180		(E)FLOOR RECEP
(E)LIGHTS NORTH		250	П		20-	3	<b>├</b>	4	20-1			П		200	(E)LIGHTS SOUTH
(E)OFFICE REC	540		П		20-	1 5	+	6	20-1				360		(E)RECEPS
(E)REC NORTH CTRL	R₩	720			20-	1 7	<b>│</b>	8	20-1					540	(E)RECEPS NE
(E)RECEPS	360				20-	1 9	l <del>+</del> -	10	20-1				360		(E)COMPUTER REC
(E)ROOF RECEPS		360			20-	111	┿	12	40/					3600	(E)A/C
(E)PHOTO CTRL LTG	180					1 13	l <del>+</del> -	14					3600		
(E)SUBPANEL 'Z2'		9600			100	15	<b>├</b>	16	20-1					360	(E)MAIN OFF RECEPS
	9600				/2	17	l <del>+</del> -	18	20-1				30		EXERTIOR SCONCES
DRINKING FOUNTAIN		180			20-	1 19	<b>├</b>	20	20-1					600	KITCHEN+STORAGE LT
DRINKING FOUNTAIN	180				20-	1 21	l <del>+</del> -		20-1				500		HOOD POWER+LTG
HOOD CTRL PANEL		1800			20-	23	<b>├</b>	24	20-1					864	AIR CURTAIN
SPARE					20-	1 25	l <del>+</del> -	26	30-1				2592		3-DOOR REFRIG
SPARE					20-	1 27	<b>├</b>	28	20-1					1656	EF-K1
SPARE			П		20-	1 29	+	30	20-1						SPARE
SUB-TOTAL		ØA=	188	42	VA		ÆB=	207	30VA	1					
	/A =	39572		JTE											
LCL @ 125 %	0 =	0		_					UIT	BRE	AK	ER '	TO REMA	dN; ALL	OTHERS ARE NEW
TOTAL OTHER LOAD	=	0			TO MA	TCH	EXISTING.								
PANEL LOAD		.6 KVA	$\vdash$												
FEEDER AMPS	= 1	72.8 A													

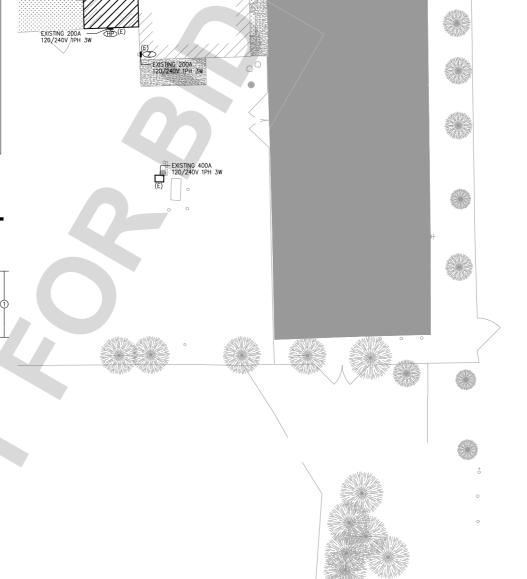

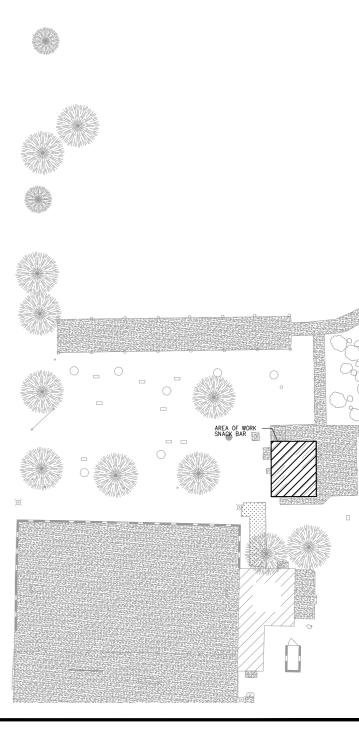

**ELECTRICAL SITE PLAN** 

AREA OF WORK



UNDERGROUND SERVICE ALERT Call: TOLL FREE TWO WORKING DAYS BEFORE YOU DIG

BASIS OF BEARINGS:






	11271010110									
ח										
D										
ASS										
APPRO										
	DATE	APPR.	. DESCRIPTION	INITIAL	DATE	MARK				

PLANS APPROVED BY:						
SAN BERNARDINO COUNTY - PUBLIC WORKS						
SPECIAL DISTRICTS						
David R. Double Total Control						
ASSISTANT DIRECTOR	DATE					


viu	n. Doublet supplied the second	rt				
TANT	DIRECTOR	DATE				
		INITIAL	DATE			
ALS	PROJECT MANAGER	Alfonso Fausto	Eightily signed by Alberta Facato Tele: 2024 26:24 06:51 42 1710			
ALO.	OPS, DĮVĮSĮON MANAGER	Henry Mac	Market Statement Potents			
	PM DÍVÍSION MANAGER	Noel Mondragon	MEDIA specify had the busin MEDIA. Front members blow door busin.			

IMPROVEMENT PLANS	DWG	
CSA 29 LUCERNE VALLEY COMMUNITY CENTER		
RENOVATION PROJECT		
ELECTRICAL SITE PLAN & SINGLE LINE		
& PANEL SCHEDULE	SHEE	


G NO. NO. SHEET **E-2.0** 

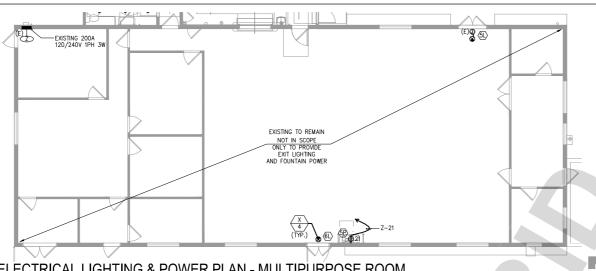

ELECTRICAL LIGHTING & POWER PLAN - MULTIPURPOSE ROOM

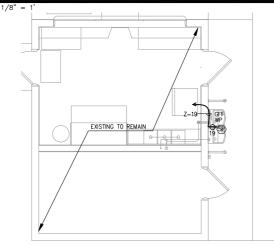

## ELECTRICAL POWER PLAN - SNACK BAR

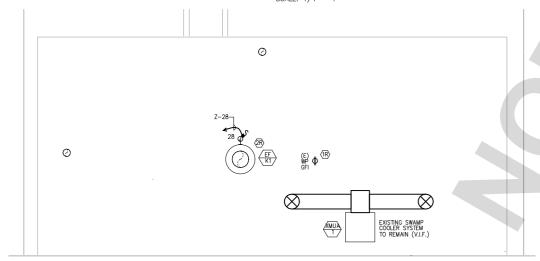

BASIS OF BEARINGS:

## ELECTRICAL HVAC PLAN

#### GENERAL NOTES FOR KITCHEN AREA

- a) CONTRACTOR MUST REFER TO BOTH ELECTRICAL DESIGN AND KITCHEN EQUIPMENT DESIGN FROM KITCHEN EQUIPMENT CONSULTANT (K.E.C). INCLUDE ALL WORK IN BASE BID. PAY ATTENTION TO THE ADDITIONAL WORK NOT SHOWN ON ELECTRICAL DESIGN BUT INCLUDED. SUCH AS
  - INCLUDED, SOUCH AS JUNCTION BOXES, AND RECEPTACLES IN SERVICE AND COOLING AREA COUNTERS, CONNECTIONS TO K.E.C FURNISHED LIGHTS, SWITCHES, BALLASTES, JUNCTION BOXES AND OTHER ACCESSORIES.
  - 2. REFER TO K.E.C ELECTRICAL ROUGH—IN SCHEDULE FOR CORDS, CAPS, RECEPTACLES OR OTHER MISCELLANEOUS EQUIPMENTS. 3. REFER TO K.E.C DRAWNGS FOR EXTENT OF WORK AND ELECTRICAL ROUGH—IN SCHEDULE TO DETERMINE THE LOCATION OF REFRIGERATION AND DRINK DISPENSING LINES. ELECTRICAL CONTRACTOR SHOULD COMPLY WITH ELECTRICAL DEVICES FOR A COMPLETE AND OPERATIONAL SYSTEM. NO EXCEPTION.
- REFER TO K.E.C DRAWINGS FOR P.V.C CONDUIT SLEEVES AND PULL BOXES FOR REFRIGERATION AND DRINKING DISPENSING LINES TO BE FURNISHED AND INSTALLED BY ELECTRICAL CONTRACTOR. COMPLY WITH ALL DETAILS AND INSTALLATION INSTRUCTIONS AND PROVIDE ALL CONDUITS (PVC OR EMT AS REQUIRED)
- VERIFY EXACT LOCATION OF ALL CONNECTION POINTS FOR MECHANICAL AND PLUMBING EQUIPMENTS AND EXACT LOCATION OF CONTROL DEVICES, SUCH AS THERMOSTAT, WITH RESPECTIVE CONTRACTORS PRIOR TO INSTALLING CONDUITS.
- VERIFY EXACT LOCATION OF ALL CONNECTION POINTS FOR MECHANICAL AND PLUMBING EQUIPMENTS AND EXACT LOCATION OF CONTROL DEVICES, SUCH AS THERMOSTAT, WITH RESPECTIVE CONTRACTORS PRIOR TO INSTALLING CONDUITS.
- IN FOOD PREPARATION AREA, ALL RECEPTACLE COVERS SHALL HAVE BRUSHED STAINLESS STEEL COVERS, WIRING DEVICES SHALL BE BLACK IN COLOR.
- REFER TO K.E.C DRAWING AND PROVIDE MISCELLANEOUS 120V/20A/3W GROUNDING RECEPTACLES WHERE INDICATED AND 120V/3W GROUND PLUGS WITH #12/3C SO CORD IN LENGTH AS REQUIRED BY K.E.C. PROVIDE ALL DIRECT CONNECTIONS AND CORDS/CAPS AS REQUIRED. ALL RECEPTACLES WITHIN 6' FROM SINKS SHALL BE GF TYPE.
- g) PROVIDE CONDUIT SEALS WITH 12" OF PENETRATION FOR ALL CONDUITS ENTERING OR LEAVING WALK-IN COOLERS, FREEZERS, COLD BOXES, ETC.
- ALL ELECTRICAL CIRCUITS BELOW COOKING HOOD MUST HAVE AUTOMATICALLY DE-ENERGIZED UPON ACTIVATION OF FIRE SUPPRESSION SYSTEM.
- ELECTRICAL CONTRACTOR SHALL RUN GROUNDING WIRES TO ALL KITCHEN EQUIPMENT
- THOUGH ALL KITCHEN EQUIPMENTS ARE FURNISHED BY OTHERS, ELECTRICAL CONTRACTOR IS RESPONSIBLE FOR FINAL CONNECTIONS.
- k) ALL KITCHEN EQUIPMENT JUNCTION BOXES SHALL INCLUDE FINAL CONNECTION TO THEIR RESPECTIVE KITCHEN EQUIPMENT.
- VERIFY WITH EQUIPMENT'S INSTILLATION REQUIRMENT FOR EXACT LOCATION OF ELECTRICAL CONNECTIONS, TYPE OF CONNECTIONS, NEMA NUMBERS ETC. COORDINATE WITH EQUIPMENT SUPPLIER AND CONTRACTORS FOR A COMPLETE AND OPERATIONAL SYSTEM.
- ) ALL 120V RECEPTACLES IN KITCHEN AREA EQUAL OR LESS THAN 20AMPS RATING SHALL BE GFI PROTECTED. ALL GFCI DEVICES SHALL BE READILY ACCESSIBLE. NO EXCEPTION.


#### ELECTRICAL HVAC KEYED NOTES

- PROVIDE J-BOX WITH 20A/1P MOTOR RATED SWITCH FOR CONNECTION TO EF-KI

#### ELECTRICAL LIGHTING PLAN - KITCHEN & RESTROOM

EXISTING 200A - 120/240V 1PH 3W

-EXISTING 200A 120/240V 1PH 3W

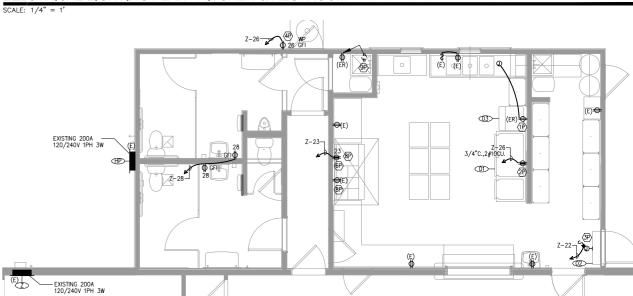

#### ELECTRICAL POWER PLAN - KITCHEN & RESTROOM

(E)

#### **ELECTRICAL POWER KEYED NOTES**

- EXISTING OUTLETS FOR EXISTING EQUIPMENT TO BE RELOCATED TO NEW LOCATION. CONTRACTOR TO MAINTAIN CIRCUITRY AS BEST AS POSSIBLE. VERIFY EXACT LOCATION AND POWER REQUIREMENTS BEFORE ROUGH IN. CLEARLY UPDATE NAME ON ELECTRICAL PANEL FOR CIRCUIT UPON COMPLETION.
- DENOTES CEILING RECEPTACLE FOR CONNECTION TO REFRIGERATOR. VERIFY WITH ARCHITECT BEFORE ROUGH IN FOR EXACT LOCATION.

  PROVIDE J-BOX WITH 20A/IP MOTOR RATED SWITCH FOR CONNECTION TO AIR CURTAIN. VERIFY EXACT FOWER REQUIREMENTS BEFORE ROUGH-IN.

- PROVIDE RECEPTACLE FOR WATER HEATER IGNITION. VERIFY EXACT HEIGHT AND LOCATION BEFORE ROUGH-IN.
- PROVIDE DEDICATED OUTLET FOR CONNECTION TO DRINKING FOUNTAIN. VERIFY EXACT POWER REQUIREMENT AND LOCATION BEFORE ROUGH-IN.
- PROVIDE POWER TO HOOD CONTROL PANEL
- EXISTING OUTLET TO BE RELOCATED TO NEW LOCATION. CONTRACTOR TO MAINTAIN CIRCUITRY AS BEST AS POSSIBLE.
- RECEPTACLES UNDERNEATH THE KITCHEN HOOD SHOULD BE SHUNT TRI
  RECEPTACLES CONTROLLED BY THE ANSIL HOOD STORMER SHUNT TRI

#### ELECTRICAL EQUIPMENT SCHEDULE

1 PRIMARY DAYLIGHT ZON

SECONDARY DAYLIGHT

AG	DESCRIPTION	MANUFACTURER	MODEL	POWER USAGE
	3-SECTION FULL LENGTH REACH IN REFRIGERATOR/FREEZER	TRAULSEN	RDT332NUT-FHS	115 1PH 21.6A
2	AIR DOOR	SAVE-T	AIR-PRO SERIES AP	120V 1PH 864W
3	ICE MAKER	EXISTING RELOCATED	EXISTING RELOCATED	EXISTING RELOCATED

#### **ELECTRICAL LIGHTING KEYED NOTES**

- THE TOTAL LIGHTING POWER IN THE DAYLIGHT ZONE IS LESS THAN IZOWATT. PER SECTION ISO.I(d), NO DAYLIGHT CONTROL IS REQUIRED.
- PROVIDE J-BOX FOR EXHAUST HOOD WITH LIGHTS.
- ROUGH IN.

  SID PROVIDE POWER TO THE NEW EXIT SIGN BUG LIGHT COMBO VIA THE EXISTING EMPT
  J-BOX. VERIFY EXACT LOCATION PRIOR TO ROUGH IN.

  CID REPLACE THE EXISTING EXIT SIGN WITH A NEW EXIT SIGN BUG LIGHT COMBO.

  MAINTAIN EXISTING CIRCUITRY AND VERIFY EXACT LOCATION PRIOR TO ROUGH IN.



DWG NO.

FILE NO.

UNDERGROUND SERVICE ALERT Call: TOLL FREE

TWO WORKING DAYS BEFORE YOU DIG





REVISIONS							
						1	
						1	
						1	
						1	
						_	
		_					
$\vdash$				-		AP	
-						AP	
	D. T.		DECOMPTON.	4000	D. T.		
MARK	DATE	INITIAL	DESCRIPTION	APPR.	DATE		

PLANS APPROVED BY:
SAN BERNARDINO COUNTY - PUBLIC WORKS
SPECIAL DISTRICTS
David R. Doublet Tolk to a control to the control t

INITIAL DATE Alfonso Fausto OPS, DĮVĮSĮON MANAGER PM, DÍVÍSION MANAGER Noel Mondrago

#### IMPROVEMENT PLANS

CSA 29 LUCERNE VALLEY COMMUNITY CENTER RENOVATION PROJECT

**ELECTRICAL PLANS & EQUIPMENT SCHEDULE** 

SHEET **E-2.1** 

VONE OF CA. PORMA Indicar Lightling GERFFLORE OF COMPANAGE Preject Name: Locarte Valley Community Center forevacion Prepar Trigo Oute Propared Oute Propared	CALIFORNIA ENERGY COMMISSION MRCC-CPI-E (Page 3 of 8) 2023-12-08T(6-42-37-66-08)	STREET OF COLUMN AS INCIDENT AS A STREET OF COLUMN AS A STREET OF COMPANIES.  PROJECT NAME LICENSE VARIES COMMUNITY CONTRA RECOLUCION.	Report Page:	A CHERCY COMMISSION NRCC-(THE (Fage 2 of 9) 1029 32 08T46-422T 05-00	nonresidential and hate/matei accupance	is. It is also used to document compliance with i nely includes dormitary and senior living facilitie	150.0, 130.1, 140.6 and 141.0/b)2 for under lighter requirements in 160.5, 176.2/e) and 180.2(b)4 for in 3.	CALIFORNIA ENERGY st, scopes using the prescriptive adoor lighting scopes using the
B 4*VAPOR TIGHT LINEAR LED No NA 44 Mitt Spec 9 No Not Design Worth Design Worth Confidence of the Not Design Worth Service Conditional TOOTHOTE Design Worth Service and color charging winnhards which quality per 140 spland for in activated large manner than explained, the period special activity exists plant setting in training to training to the Not Service of the Service setting to the Service Servic	09	Control   Cont	Adjusted Lighting Power per 140.6(e) / 370.2(e)	Compliance Recults 09 05 must be >= 08 240.6 / 370.2(e) COMPLIES COMPLIES	Prides Address 33187 OH Worses Scrige!  A. GENERAL INFORMATION Of project Societion (org.) OCCUPATION OF THE OFFICE OF THE OFFI OS DECIGIENTS Types Width Project (selection of the Other Societies)  B. PROJECT SCOPE  B. PROJECT SCOPE	Lucerne Valler, CA 92356  Lucerne Valley  Lat   Stat   Sta	Date Preservel:  GI Treat Conditioned Floor Area (11*)  GI Treat Conditioned C	3005-12-061  349- 0 1 1 Unconditioned Space Discontinued in 14G, 6  Ca-custon Method N/A N/A 14/A
H. MOOGR LIGHTING CONTROLS Not Including FAF5  That sobe including injerting controls for conditioned species.  Building Level Controls  CE Q2  Mandatory Demand Response 169.12(c) Shut off controls 133.1(c) / 140.1  Nik < 4,83,304 s.lbpct to ms.thlevel See Ansa/spocs Level Control  CA turicing Every Ifficercy Standards - 2012 horinoidansis Congilines  EA turicing Every Ifficercy Standards - 2012 horinoidansis Congilines  Report on views 2012, 1005  Schart Version are 202220201	natio cont	CA that they being officiency Standards - 2022 November (In) Compilation Recover	cated DalayTime Dala, montator S in 1984 - 1992 - 1994 - 1994 - 1994 - 1994 - 1994 - 1994 - 1994 - 1994 - 1994	othware Sneegy Code Sco was 17 - 555745 1275-0000 med-2023-12-06 13 42-23	CA Subling though efficiency Standards - 2022	Nonresidential Compiliance Nation	cales Discyflime: 11 Version: 2623-000 The Version: de 2020/05	Occumentation loctularie for Compliance to Lecture Report Garanded 2023-3
Indoor Lighting CERTIFICE CONFUNCE Project Name: Locard Vultar Community Center Renewation (Date Project Name: Locard Vultar Community Center Renewation (Date Project Name: Locard Name Name Name Name Name Name Name Name	CALIFORNIA ENERGY COMMISSION MRCC LTI 4 (Page 5 of 8) 2022-12-08718-12-27-05-00	Indian Lighting Connect or Coverance Lights with the Connect Conference Conference People Minima Lights only Connectly Conference Co	Report Page:	A ENERGY COMMUNISSION NRCC 1714 (Page 5 of 8) 1078-72-08716:42-27-05:00	Indoor Lighting CERTIFICATE OF COMPLANCE Project Name: Lucarne Valley Community L	Senter Resolvation	Report Fage: Date Prepared:	CALIFORNIA ENERGY 2021-12-081
C., RATED POWER REDUCTION COMPLIANCE FOR ONE-FOR-ONE ALTERATIONS  Phil section does not apply to this project.  R. 80% LIGHTINGS POWER FOR ALL ALTERATIONS - CONTROLS EXCEPTIONS  This section does not apply to this project.  S. DAYLIGHT DESIGN POWER ADJUSTMENT FACTOR (PAP)  This section does not apply to this project.		L. LIGHTING POWER ALLOWANCE: COMPLETE BUILDING OR AREA CATEGORY M CORRODOR REPORT REPORT CHARLES GENERAL CENTRAL LABORATORIA ALLOWANCE: AREA CATEGORY METHOD QUALIFYING LIGHTING Fig. SOCIETION ALLOWANCE: AREA CATEGORY METHOD QUALIFYING LIGHTING Fig. SOCIETION ALLOWANCE: AREA CATEGORY METHOD QUALIFYING LIGHTING FIG. SOCIETION ALLOWANCE LIGHTING POWER ALLOWANCE	C.4 60 24 No. 0.55 389 364.8 No. TOTALS 845 622,2 See Tabl	tion Ro Ro kins.l., or P for data if	Area Description Categor	65 0e 0 00 00 00 00 00 00 00 00 00 00 00 0	Article   Shut-Off Controls   Shut-Off Contr	ht ng Systems   Fickl
T. DWELLING UNIT LIGHTING The section does not apply to this project.  U. DECLARATION OF REQUIRED CENTIFICATES OF INSTALLATION Softwares have been made leased or information provided in this occurrent. Jump viscations have been changed by permit applicant, additional Removes, have occurrent must be provided for the business required earning constructions and on the Sound online.	t, an explanation smould be included in Table E.	Tax vertion even not variefy to this project  L. ADDITIONAL LIGHTING ALLOWANCE: TRILDRED WALL DISPLEY TAX section data not copyle to 90% project.  M. ADDITIONAL LIGHTING ALLOWANCE: TRILDRED FLOOR AND TASK LIGHTING			CORRIDGE	Restracin Accessible NA. Roc Reading Accessible Clima Accessible Clima Accessible Clima Accessible Clima Accessible Clima	mer Auto Time Switch NA	Nut No □
Form/Title  Mich.17 E - Maxil be submitted for all buildings  Caronised David Trees	Diconvention Software Energy Code Acts Complaint E. 198740-223-2002	CA Building Triengy ETI Jerscy Standards - 2022 Novresidential Compliance Report	CTOR (PAS))  roted Date/Time Description  19 Wester 2022-0000 Carafar	othwar rangy inde for use 17: 1537491222-9002	Each area consolying asing the Comulete 8 140.6(c) or adjustments per 140.6(a) are a Conditioned Spaces 01	ong sind.  02 Onghice Building or Arias Category Primary Function Area Commercial Industrial Storage Area Restroom Sinne Nasimularisis Compliance Rese	G3	Middlewall Againing prover offense age  Additional Allowance Area Craegory No No Commission Software: No Commission Colonials: No Commission Colonials Colonials: No C
Schorz Senson and AUDIUS  Schorz Senson and AUDIUS  Indoor Lighting  CERTIFICATION COMMUNICE  Project States: Leavers Value Communic/Center Birocustors  Project States: Leavers Value Communic/Center Birocustors  Project States: Leavers Value Communic/Center Birocustors  Communication Communicati	REPORT SEARCHER THE FLAGS TO A SEA THE COMMISSION SECURITY SEC	Sthet Sant Councilia Indoor Lighting Connected Communics Project Name: Locarios Valley Community Carter Resource	CU-FORMS Report Page:	IN ENGLAS 14-47-10  IA ENGLASY CURPARISSION  RECCLIFIC  [Page 7 of 8]  1223-12-2011 6-42-27-45-00		Schee	184 - 184 - Report Senerabel XVS
DOCUMENTATION AUTHOR'S DECLARATION STATEMENT  Evertify that this Certificate of Compliance documentation is accurate and complete.  Eccuration Asher lines.  Countries of Countries of Asher lines.  Countries of	kd.  White of Completes I responsible disalgram from the Confidence of Considence conforms the restalements.	V. DCCLARATION OF REQUIRED CERTIFICATES OF ACCEPTANCE Silections have leven more board on algorithms provided in the document of any select Additions for the Activities of the Comment of any select for footnotion Configuration Provider APT 29. For more information that highly leaves to during a formation of the Activities of the Activ	creatization and any with "A" in the form number must be completed the regy on, good his of 4-botton formalism. Here!  System is STON.  STON.  SCORN	Co-included in Nobe 2.  Cough as Asseptions: employees to be set of verificed AGE, RESTROOM; DOC, RICHEN ATES				
Projection Lindrocated that a crydinal grant grid grid fill to Certificate of Complemen in registered to be delighter on this documentation of Lindrocate (Incomplementation of Lindrocate (Incompleme								ENGIN
CA Buildean Dienna Efficience Standards - 2022 Notwicklendial Corspiance Report Versione: 2022 8 COS Schema Version: 179 20200133	Documentation Software Chergy Code Ros Compliance 0: 50246-122-002 Report Sinnersteck 2028-12-08 12-82-31	DA Building Energy Officiency Standards - 2022 howresidential Compiler on Report	rt Version: 2022.0.000 Covalian	io/bwort: 5nergy Culle Aut rose (D: 163743-1227-0302 abod: 2023-12-08 13:42:11				26439 Rancho F Lake Fores Tel: 949
OFESSION.		REVISIONS		PLANS APPROVED BY: DINO COUNTY - P PECIAL DISTRICT		IMPRO	OVEMENT PLANS	DWG



BASIS OF BEA





ILEVISIONS							
						_	
						Α	
MARK	DATE	INITIAL	DESCRIPTION	APPR.	DATE		

	PLANS APPROVED BY: SAN BERNARDINO COUNTY - PUBLIC WORKS SPECIAL DISTRICTS							
	David R. Doublet Total Doublet Total Control of the							
ASSISTANT DIRECTOR DATE								
			INITIAL	DATE				
	APPROVALS	PROJECT MANAGER	Alfonso Fausto	Optially signed by Alterso Passite Calls Science Color de Sit OHC/ 00*				
AFFROVALS	OPS, DĮVĮSĮON MANAGER	Henry Mac	The Proposition of the State of					
1	PM, DÍVÍSION MANAGER	Noel Mondragon	Digitally separately first Bristopes (SAC-ALC, Extractional superflows assurable per Ellipsian W. Sac Special Film via Chilling, Marchagan Same 2000 (ACR) in SERENT 2000					
	APPROVALS			Manufactures.				

•	06-20-2024
IMPROVEMENT PLANS	DWG NO.
CSA 29 LUCERNE VALLEY COMMUNITY CENTER RENOVATION PROJECT	FILE NO.
ELECTRICAL T24 - INDOOR	SHEET E-LTI

STEET OF CHIPMAN  Outdoor Lighting  CAL FORMA FIREFOR COMMISSION  AND COMMISSI	SOCIO CALIFORNIA EN FREN COMMISSION  Outdoor Lighting  CALIFORNIA EN FREN COMMISSION  ARCCORD	SOUTO COLUMNA OUtdoor Lighting CALIFORNIA FIFFEY COMMASSI ORDERET OF COMPLIANCE MICCATO
CERTIFICATION OF COMPANANCE MEDICAL PROPERTY OF COMPANANCE MED	CERTIFICATIO & COMPULATION Fraient Name: Societic Africa Center Annualism Report Page: Shape 2 of 7; Don 6 reported. 5003-11-00719-32-44-09.00	This document is used to demonstrate compliance with requirements in 10.94, 130.0, 130.2, 140.7, and 141.03(1) for author lighting scapes using the periority report party for innovationally and hard-framed acceptance in a done used to accument compliance with recurrences in 100.9, 170.2(4), 100.2(4), 100.2(4), and 100.3(4)(4) for subdoor lighting scapes using the personagement paint preclaims and an interface occurrences. Multiplient in their extension parts as exercit Value facilities.
		Project Russe: Interne Yaday, Carmonity Corton Bendustion. Bendust Page: \$\$\text{\$\text{\$\text{\$\text{\$\text{\$\text{\$\text{\$\text{\$\text{\$\text{\$\text{\$\text{\$\text{\$\text{\$\text{\$\text{\$\text{\$\text{\$\text{\$\text{\$\text{\$\text{\$\text{\$\text{\$\text{\$\text{\$\text{\$\text{\$\text{\$\text{\$\text{\$\text{\$\text{\$\text{\$\text{\$\text{\$\text{\$\text{\$\text{\$\text{\$\text{\$\text{\$\text{\$\text{\$\text{\$\text{\$\text{\$\text{\$\text{\$\text{\$\text{\$\text{\$\text{\$\text{\$\text{\$\text{\$\text{\$\text{\$\text{\$\text{\$\text{\$\text{\$\text{\$\text{\$\text{\$\text{\$\text{\$\text{\$\text{\$\text{\$\text{\$\text{\$\text{\$\text{\$\text{\$\text{\$\text{\$\text{\$\text{\$\text{\$\text{\$\text{\$\text{\$\text{\$\text{\$\text{\$\text{\$\text{\$\text{\$\text{\$\text{\$\text{\$\text{\$\text{\$\text{\$\text{\$\text{\$\text{\$\text{\$\text{\$\text{\$\text{\$\text{\$\text{\$\text{\$\text{\$\text{\$\text{\$\text{\$\text{\$\text{\$\text{\$\text{\$\text{\$\text{\$\text{\$\text{\$\text{\$\text{\$\text{\$\text{\$\text{\$\text{\$\text{\$\text{\$\text{\$\text{\$\text{\$\text{\$\text{\$\text{\$\text{\$\text{\$\text{\$\text{\$\text{\$\text{\$\text{\$\text{\$\text{\$\text{\$\text{\$\text{\$\text{\$\text{\$\text{\$\text{\$\text{\$\text{\$\text{\$\text{\$\text{\$\text{\$\text{\$\text{\$\text{\$\text{\$\text{\$\text{\$\text{\$\text{\$\text{\$\text{\$\text{\$\text{\$\text{\$\text{\$\text{\$\text{\$\text{\$\text{\$\text{\$\text{\$\text{\$\text{\$\text{\$\text{\$\text{\$\text{\$\text{\$\text{\$\text{\$\text{\$\text{\$\text{\$\text{\$\text{\$\text{\$\text{\$\text{\$\text{\$\text{\$\text{\$\text{\$\text{\$\text{\$\text{\$\text{\$\text{\$\text{\$\text{\$\text{\$\text{\$\text{\$\text{\$\text{\$\text{\$\text{\$\text{\$\text{\$\text{\$\text{\$\text{\$\text{\$\text{\$\text{\$\text{\$\text{\$\text{\$\text{\$\text{\$\text{\$\text{\$\text{\$\text{\$\text{\$\text{\$\text{\$\text{\$\text{\$\text{\$\text{\$\text{\$\text{\$\text{\$\text{\$\text{\$\text{\$\text{\$\text{\$\text{\$\text{\$\text{\$\text{\$\text{\$\text{\$\text{\$\text{\$\text{\$\text{\$\text{\$\text{\$\text{\$\text{\$\text{\$\text{\$\text{\$\text{\$\text{\$\text{\$\text{\$\text{\$\text{\$\text{\$\text{\$\text{\$\text{\$\text{\$\text{\$\text{\$\text{\$\text{\$\text{\$\text{\$\text{\$\text{\$\text{\$\text{\$\text{\$\text{\$\tex{
F. OUTDOOR LIGHTING FIXTURE SCHEDULE  For new or obsered digiting systems demonstrating compliance with 140.7 (170.2) of year, are when ever being installed and any avoiding luminoires remaining or being moved within	C. COMPLIANCE RESULTS	Landon Landon 25/00 (A) Martin Bull Bull 17() of Article (19 2020)
the spaces covered by the semit application on included in the Table because, for altered Spining systems using the Editing News much days "ALLEDIX only new Limitatives being installed and repacement Particulates being included as sort of the policit scope are included for, existing uniminars remaining or existing Junivarians using muscula are not included.  Outdoor lighting activated to rescribing buildings and continued plans the existing of existing and are much activated in the in are one not contacted these. All other must formly positive	Results or this facility or automatically collaborate from data lands and articulations in tables. If moved in M. Note: If my cell on this table says "COMPLES with Exceptional Conditions" refer to Table 0. Exceptional Conditions and Table 1, and the conditions are to published for the referenced below.  Collaborations of Table Allowed Lighting Towar (Watts) 1967 / 1702/16/6 or 141.36(1)(2), 1.180.2(6)(4)	A. GENERAL INFORMATION  EL Project (common (obj.)  Lucarno Valley
Saleing Is included here.	Circulations or local actioned trigging rower (National Section 2) 2	C2 Climate Zone 14 04 Total (Burnisment Hardscape Area (fr*) 900
Designed Wottage:	General Fer Sales Onamental Per Specific Existing Fencer	C3 Outdoor Lighting Zone per Title 24 Part 110.314 or as designated by Authority Having Nutradiction (AHI):  [20: Very Jow - Underveloped Parkland   ] [22: Moderate - Urban Clusters   ] [22: Nigh - Must be reviewed by CA Energy Commission for Approval
Catoff Req. > Soid	discounce = Application = Feerings = 14C.7(4)C = Area  on Table   40.7(4)C = Feerings = 14C.7(4)C   Area  on Table   40.7(4)C   Area  on Ta	□ 12.3: Low-Rural Areas □ 12.3: Moderately High - Urban Areas
Name or item Tag Complice Luminaire Description 1/4g (Intrinsipe 1/4)  Name or item 1/4g (Intrinsipe 1/4g (Int	170.2(a)6	E5 Daniparry Types within Project  •
153.5611 <sup>4</sup>   153.5611 <sup>4</sup>	304.9 + - + - + - + - OR 304.9 b 22 COMPUES  Shielding Compliance (See Table & for Details)  N/A	B. PROJECT SCOPE
Total Design Watts: 22	Controls Compliance (See Table II for Details) COMPLES	This table includes outdoor highing systems that are within the scope of the permit application and are demonstrating compliance using the prescriptive path auchined in 140.7 / 170.2(4)6 or 141.2(4)41 / 180.2(4)40/ for alterations.
* NOTEs. Selection with a * require a reta in the sases below opining how compliance in achieved.  So commone a Agricing or Secret, EXECUTION 2 to ESSLING!	D. EXCEPTIONAL CONDITIONS	Inty Project Combiss of
*FOCTHORES. Authority Howing Limitation may ask for turnimore cut shoots to confirm noting o used for complemor por 128 (Eq.) (56.5%).  *For their Turnicies, suchage intend the indicated as NVF transpal of Watts Confirm. Total Invest feet should be indicated in astume DF instead of number of Ambas has	This table is auto filled with aneddable comments because of selections made or data entered in tables throughout the form.	Must Comply with Allowardes from 140.7 / 170.2(e)6
* Select "New" for new furnisaines in a new audition hybring project, or for coded kniminaines in an alteration. Select "Mitteed" for replacement landwisheres in an afteriotion. Select "Existing to illemniah" for existing to the project of the pr	F. ADDITIONAL REMARKS	Altered Lighting System Is your alteration increasing the connected lighting load (Watts)?   Yes   No
the project stage.  * Complaints with manufacing shipping requirements in contrast with milital barea pulpan ~ 6.200 units seem page by 130.2004 (190.50).	This table includes remarks made by the plannic applicant to the Authority Having Autistician.	03 04 05  th of Existing Luminatines Being Alternaci <sup>1</sup> Sum Total of Luminatines Being Added on Alternal Collection Method
A STATE OF PARTIES AND	A 25	□ = 10% □ ~ 10% and < 50% □ ~ 50%
G. SHIELDING REQUIREMENTS (BUG)		Please proceed to Table F. Outdoor Lighting Finture Schedule to define the project's luminoines.
This section does not apply to this project.		ACCINITIES IN of Existing Luminaers Being Altered - (Sum Tale) of Luminaers Being Added or Oberea / Existing Luminaers within the Scope of the Ferral Application) is 2011
Generated Date/Time: Documentation Software: Energy Code Ace	Generates OuterTime: Cocumentation Software: Energy Coce Ace	Generated Date/Time: Ecoumentation Software: Energy Coce Act
CA Suiting Energy Efficience Standards - 2022 Normaldential Compilance Report Veniore: 2022.0003 Compilance ID. 155740-1225-0003 Schema Veniore not 7,07/2001 Report Generalized: 7,075-17-18: 19.3-57	CA Building Energy Bibliotricy Sur-Gards - 2022 Normal Century Survey (Compilance Survey) Survey Service (19. 153746-1225-0005 Schieral Service) (19. 153746-1225-0005	CA Building Energy Efficiency Systematic - 2022 Normal decital Compliance Supervisor, 2022-9,000 Compliance (0, 103740-1225-000 Memory 1000010) Report General of JULY-1226-02-1226
And the control of th	and the second s	and the second s
Outdoor Lighting California Heli-roy Commission	STATE OF EMPIRITION  CALL FORMULE HILL-REV CEMMA SSACRE  CALL FORM	Outdoor Lighting Caliburnia Hierry Commission
CERTIFICATE OF COMPLIANCE NREC-2TO-1	CERTIFICATE OF COMPLIANCE NECC4TO-4	CERTIFECETE DE COMPLIANES. NECCATO
Project Name:   urene Yalley Community Centre Normation Separa Page: (Page in 17)   Date Propagate() 2004-10-2017-2-2-2-2-2-2-2-2-2-2-2-2-2-2-2-2-2-2-2	Project Rame   usernir Valley Community Ferman Secondaria   Segan Page:   \$200 A 27	Project Raine: Lucenie Valley Community Center Rendestron Read Page (Page 4 of Date Prepared: 074-02-0311972-04-051
M. LIGHTING ALLOWANCE: PER SPECIFIC AREA This written does not apply to this grouper.  M. EXISTING CONDITIONS POWER ALLOWANCE (alteretions only) This weder does not apply to this project.	LIGHTING POWER ALLOWANCE (per 190.7 / 170.2 (e))  This Libbs includes cerea withy elementar excluditions per 140.7 / 170.2 (e), General eventregar afficiency in per Tober (e.g., 2 of Plane 170.2 4 active 10th in ordinary elementary elementary expression (e.g., 2 of Plane 170.2 5 in force eventre elementary elementary expression (e.g., 2 of Plane 170.2 5 in force eventre elementary elementary elementary expression (e.g., 2 of Plane 170.2 5 in force eventre elementary el	H. CUTDOOR LIGHTING CONTROLS This table demonstrates considerate with controls requirements for oil ner or others of small small relevant sources to be included in this table use of they are within the source covered by the period application. In a small period application. Contacts in black period represents which are removed and coverabled (always print) also not need to be included in this table use of they are within the source covered by the period application. Contacts in black period for agreement of the period application of the period application of the period application. Manufacts by the contact of controlled from the valid of of lawforg and a controlled from the period application of the period controlled from the valid of of lawforg and a controlled from the period of the period o
	cutioor lighting is incided here.	C1 02 03 04 05
O. DECLARATION OF REQUIRED CERTIFICATES OF INSTALLATION Solvetions have been made based on information provided in this document. If any solvetion has been changed by permit applicant, on explanation should be included in Table E.	Cythyleted General Handscape Lighting Power Allonance are Table 140.7-A for Normalizantial & Hotel/Wotel   81	Area Description Shi,1-Off Auto-Schedule Woll, as Sensor Field Inspector 130,2(c)1 / 160,5(c) 132,2(c)2 / 160,5(c) 132,2(c)3 / 160,5(c)
Selections have been made based on injurnation provided in this document. If any selection has been companied by permit applicant, on explanels an included in labeles.  Additional Hameriks. These documents must be provided to the Building Inspector during construction and can be found online.	Area Wattage Allowance (AWA) Linco Wattage Allowance (JWA) Idea General	Pass Fall
Form/Title	Area Description	OUTDOOR ENTRANCE/DRT. Astronomical Times Provided NA: Each Luminaire cu dó Watts.
NACL LTC E - Must be submitted for all buildings	OUTDOOR ENTRANCE/EXIT 900 0.021 19.9 180 0.2 36 54.9	FADOTNOTE. The laws seen addressined, phose refor to Table 166.5 A se conform compliance with the specific light source restmologies lided.  Fault or by truing intraction may not for cutchness or other documentation to confirm compliance of EgAt source.
	Instal Wattage Allowance for Entire State (Watta): 250	*Resourced harmstores mentated for use in fine-roted installations, and measured luminosities destabled to non-enactored artificial core encourses from all and (V).
R. DECLARATION OF REQUIRED CERTIFICATES OF ACCEPTANCE  Selections have been made based on information provided in this document. If any selection has been charged by certific quarties on evaluation of based on Table E.	Instances of initial Wattage Allowance (LZ D only) <sup>1</sup> Total General Hardscape Allowance (Watta): 304.5	
Selections have been made based on information provided in this document. If was referrable has been changed by cernal qualitant on evaluation of basis be included in Table E. Additional Armania. This particular was to provided to the building inspector auting conduction and must be complished through an Appendix on Particular Information Certification Provided (APTIC) for more information in this deployment representation provided in the Certifician Certification.		
Systems/Spaces To Be Field	J. LIGHTING ALLOWANCE: PER APPLICATION	
Verified  NRCN-LTO-02-A - Must be submitted for all outdoor lighting controls except for aberations where controls are added to <= 20 luminalizes.  OUTDOOR ENTRANCE/EXIT:	This section does not apply to this project.	
,#h,	IX. LIGHTING ALLOWANCE: SALES FRONTAGE	
	This section does not apply to this project.	
	I. LIGHTING ALLOWANCE: ORNAMENTAL	
	This section does not apply to the project.	
Generated Date/Time Documentation Software Energy Code Sce	Generated Data/Time: Decumenation Software: I negy Coce Ace	Generated Gute/Time: Cocumentation Software: Energy Coce Ac
CA Multing Princy Afficiency Standards - 2022 Beautoidential Corollans   Report Prince 2022 BOBS   Corps and 1 165746-1725-2005   Schema Vosion, new 2022/0101   Report Generated: 2023-22-06 15-23-52	CA Rulling Honey Standards - 2022 Normal Manual Compilation Report Version: 7827 0.000 Compilation In 1972 0.0001 Schoma Version: rev 20220101, Report Generated: 2023-1248-16-29-52	CA habiting fronty Pfficienty Visitorias - 2022 deemos niertial Compiliance Report Visitoria 2022 0.000 (negatiario illi 185740-1929-0.000 Sebama Visition nel 2022/000) deport Generaled (2023-1246 16-235
	Outdoor Lighting Custmoute or constance: Project Braine Learne Valley Constance; Project Braine Description (Lighting) DOCUMENTATION AUTHOR'S DECLARATION	Date Prepared: 2228-12-39T10 28-84-55-00
	I certify that this Certificate of Compilance	documentation is accurate and complete
	Documentizes Author Name	Discretization Autor Squaries Comma Than





UNDERGROUND	SERVICE ALERT
	Call: TOLL FREE 1-800-227-2600 OR 811
TWO WORKING DAY	'S BEFORE YOU DIG

BENCHMARK:

BASIS OF BEARINGS:





							_
REVISIONS							
[							1
[							1
1							
Ī							⊢
1							1
1							APF
1							
1	MARK	DATE	INITIAL	DESCRIPTION AP	PR.	DATE	1

-					
PLANS APPROVED BY: SAN BERNARDINO COUNTY - PUBLIC WORKS SPECIAL DISTRICTS					
David R. Double Topic profits for Experience Conclusion, Conclusio					
ASSISTANT DIRECTOR		DATE			
APPROVALS		INITIAL	DATE		
	PROJECT MANAGER	Alfonso Fausto	Oglady signed by Altonso Passite Odlar Scinicación de Sit 15-07-de		
	OPS, DĮVĮSĮON MANAGER	Henry Mac	The Property of the State of th		
	PM, DIVISION MANAGER	Noel Mondragon	Digitally algored by fired Westingers DMC-calc. Ex-main receivages Endparameter Region St. Balder Wester, Squared Trian von Chilabase Manul again Date: Society for the String 2000		

	06-20-202
IMPROVEMENT PLANS	DWG NO.
CSA 29 LUCERNE VALLEY COMMUNITY CENTER	FILE NO.
RENOVATION PROJECT	
ELECTRICAL T24 - OUTDOOR	
	SHEET E-L