3. PEOPLE AND ANIMAL LEVELS

The new facility for the county will serve the unincorporated communities located in the Central Valley Region of the County and the cities of Highland, Yucaipa, Rialto, Fontana, Colton, and Grand Terrace as shown on Exhibit A. The total people population of the service area was approximately 589,366 for 2021. The number of animals received at the existing Animal Care Centers in the service area in 2021 was approximately 9,214. This total is composed of approximately 3,881 dogs, 4,400 cats, and 933 other species. (47% dogs and 53% cats)

Nationally, the number of animals normally received at local Animal Care Centers annually is 2-3% of the human population served. The 9,214 animals received at the existing Devore facility in the service area in 2021 is only 1.56% of the human population of 589,366. This means the number of animals received per year at the existing Animal Care Centers is slightly below the range of the national norm. While the number of animals received may be below national norm there is still an animal overpopulation challenge.

Over the next 20 years, the population of the County's service area is projected to increase to approximately 660,491, an 12% increase.

More extensive preventative programs including low cost and subsidized spay/neuter procedures, public education promoting responsible pet ownership, and developing progressive ordinances is part of the solution to reducing unwanted and stray animals. The underlying overpopulation of pets is caused by irresponsible pet ownership and uncontrolled breeding of pets. Although animal overpopulation is beginning to come down nationwide due to remedial programs, it can be countered by increasing human population and continued irresponsible pet ownership.

Of the 4,960 dogs, cats, and other animals dispositioned at the existing Devore Animal Care Center in 2021 the breakdown is as follows:

Adoption: approximately 3,267, or approximately, 65.9% are adopted or transferred. The number of adoptions is fair compared to many modern Animal Care Centers that have adoption rates of 70 – 80% but improvements are still needed.

Returned to Owner: approximately 352, or approximately 7.1%, are returned to their owners. The number of returns to owners is slightly below average when compared to many modern Animal Care Centers that have return to owner rates between 10-20%.

Euthanized: approximately 1,246, or about 25.1%, were euthanized which is higher than the range of many modern Animal Care Centers that have rates of 10–20%. There is a strong push nationally to move to a 90% live release rate.

Died in Shelter: approximately 95, or about 1.9%, die in the shelter which is slightly higher than normal.

Projected Animal Housing Need

Before we discuss the proposed animal housing for the new Animal Care Center, we want to discuss an important question.

"Will Holding More Animals for Longer Periods of Time Increase the Number of Animals Adopted?"

"If we hold more animals for longer times won't more be adopted?" The two following examples can help individuals understand this frequently misunderstood question. Before we examine the questions however, we want to emphasize the importance of all healthy animals being provided a reasonable stay. As long as animals are emotionally and physically healthy, and kennels are not overcrowded, it is reasonable to extend their stay. However, dogs should not be kenneled so long that it adversely affects their behavior, causing neurotic behavior such as pacing, spinning and aggression.

This issue often becomes confusing for many people when trying to understand the value (or lack thereof) of building bigger Animal Care Centers and holding more and more animals for longer periods. The following examples will help facilitate understanding:

1. In the first example, assume the Animal Care Center holds animals an average of ONE week each during a one-year period. During the year, 400 people (or pet rescue groups) visit per month with the intention to adopt a pet. How many animals could be adopted in that year? If every visitor adopted, you would adopt 4,800 animals.

Now, assume you kept every animal for FOUR weeks (four times longer) during a one-year period. The same 400 people per month visited with the intention to adopt a pet. How many animals could be adopted in a year? If every visitor adopted, you would still adopt 4,800 animals. As you can clearly see, holding the animals longer, by itself, did not affect adoptions.



It is important that your Animal Care Center makes an informed decision of how many animals to hold at any given time and how long to hold each animal to provide the best opportunity for adoption and have humane treatment.

2. In this second example the Animal Care Center houses about 400 animals available for adoption at all times. The same 400 people visit per month with the intention to adopt a pet. How many will be adopted in one year? If every visitor adopts, you will have 4,800 adoptions in one year.

Now, assume the organization builds an Animal Care Center to house twice as many animals, <u>holding about 800 animals</u> at all times, how many will then be adopted? If all of the 400 visitors adopted, you would still adopt 4,800 animals. As you can see, holding twice as many animals does not affect the number adopted.

The conclusion of these two examples is simply this: The only factor that truly affects the number of animals you adopt is the number of people (or rescue groups) who visit the Animal Care Center with the intention of adopting. **Holding animals longer and holding many more animals does not significantly increase adoptions.**

NOTE: (An Animal Care Center may hold an animal an extended period of time and finally get it adopted, but other animals are being euthanized to allow that one animal the space to stay longer. This is the scenario that causes people to think <u>incorrectly</u>, "If we could just hold all animals longer, they would all eventually be adopted".)

TO INCREASE ADOPTIONS, YOU MUST INCREASE THE NUMBER OF VISITORS (WHO WANT TO ADOPT). This is done through a good visible location, visibility of all animals, weekend and evening hours, web-site pet listings, an attractive welcoming Animal Care Center, well-groomed and healthy animals, friendly staff, adoption requirements that are not too restrictive, reasonably low adoption fees, promotion of adoptions in all local media, special adoption events, the help of rescue groups and transfer programs.

The more effective approach an animal care center can take rather than warehousing animals is to help get all pets in their service area spayed or neutered and educate their community about responsible pet ownership. This will eventually solve the pet overpopulation problem in a community. A community simply cannot "shelter their way" out of an animal overpopulation problem.

For the new Animal Care Center, the County plans to add the following four additional cities to their service area: Rialto, Fontana, Colton, and Grand Terrace. Refer to Exhibit A that shows the summary of the existing Devore Animal Care Center's current and projected animal intake and proposed animal housing for each of the cities proposed for the new Animal Care Center.

Dog Housing Capacity

The existing Devore Animal Care Center has an 18 day Average Length of Stay (ALS) for the approximate 1,861 dogs handled per year with the present dog housing capacity of 90.

For the new Animal Care Center, we propose housing for 191 dogs, which results in an approximate 16 day ALS based on the expanded service area and a 20 year planning horizon.

The Building Space Program, EXHIBIT B, includes housing for 191 dogs which is an increase of 112% over the existing Animal Care Center. Refer to the Animal Housing section of the Building Space Program for the breakdown of the proposed Dog Housing.

Cats Housing Capacity

The existing Devore Animal Care Center has a 12 day Average Length of Stay (ALS) for the approximate 2,449 cats received per year with the present cat housing capacity of 81. For the new Animal Care Center, we propose cat housing for 162 cats, which results in a 12 ALS based on the expanded service area and a 20 year planning horizon.

The Building Space Program EXHIBIT B includes housing for 162 cats which is a increase of 100% over the existing Animal Care Center. Refer to the Animal Housing Section of the Building Space Program for the breakdown of the proposed cat housing.

Other Animal Species

The Animal Care Center received approximately 640 other animals made up of a wide variety of species such as rabbits, lizards, snakes, turtles, etc.

It is recommended that a separate room be provided to accommodate these animals.

4. BUILDING SPACE PROGRAM

The Building Space Program is a detailed listing of each room or space proposed to accommodate SBACC's needs based on a 20 year planning horizon. The net area of each room or space is listed. Net area is defined as the inside dimensions of the space but does not include the wall thickness and corridors. The quantity of each type of room or space is also listed. The rooms are sub-divided into major groupings such as Administrative, Medical, Animal Housing, Animals support areas. The net area totals are listed at the bottom of each section and then a grossing factor is applied to the net area. The grossing factor projects the estimated SF needed to accommodate the wall thickness, corridors and any other unidentified space. This helps to determine the total SF needed. The total SF is critical to developing an Opinion of Probable Cost.

Refer to attached EXHIBIT B dated 11-29-22 for the Proposed Building Space Program.

5. SITE CONSIDERATIONS

The following items need to be included in the site design:

A. Parking: Adequate parking is very important for the success of an animal care center. The parking needed for the Animal Care Center, based on function, is estimated as follows:

Total	138
Trailers/special vehicles	8
ACO Vehicles	10
Staff	55
Foster Parking	3
Public and Volunteer Visitors	62

The County of San Bernardino's required parking is 1 space for each 250 SF of office and professional services. For the building size proposed in the Building Space Program, the County will require 232 parking spaces. However, sometimes a variance is required because the Authority Having Jurisdiction's required parking is not appropriate to the needs of an animal care center because much of the square foot area of the building is dedicated to animal housing.

Parking should be arranged to provide good visible parking for visitors and located for easy access to the main entrance. Staff parking should be separate and located to the side near a separate staff entrance. Animal Care Center vehicles should be provided with simple to navigate routes with adequate turning radius and concealed from public view in a screened service yard.

- **B. Other Outdoor Features:** Space for designated areas for outdoor features is also important when considering the site. The following items are requested.
 - 1. Six dog exercise yards with covered bench area for volunteers or staff
 - 2. Four outdoor dog exercise yards
 - Possible outdoor walking trails
 - 4. 20' x 40' covered pavilion (if space allows)

6. RECOMMENDED FEATURES

A. Design Concept





An example of a welcoming new animal care center by "Shelter Planners of America" of about the size needed for SBACC

The Animal Care Center should have low-maintenance, heavy-duty materials. The interior should be brightly lighted and open with pleasing colors and pleasant public spaces. Animal housing areas should provide as much health protection, safety and comfort as possible with today's new materials and designs.

For the new Animal Care Center, we recommend one-story buildings for the animal areas. The structure would be a slab on grade, depending on the soil condition, with masonry and framed walls and sloped or low slope roofs. The exterior should avoid an institutional look, preferring a human scale and welcoming feel. It should be compatible with the community and be attractive and inviting to the public. Natural lighting should be provided to all public areas, animal housing areas and staff work areas.

Attractive landscaping will be very important to the appearance of the Animal Care Center. We recommend that an extensive landscaping plan, be a part of the building project.

1. Dog Housing – SPA presented several dog housing options to San Bernardino County for consideration and they selected convertible kennels. It is important that each dog has two spaces: a primary enclosure where their food, water, and bedding is located and a secondary space where they can eliminate away from their primary enclosure allowing them to live in their normal behaviors. The indoor portion of the kennel will allow the dogs to be comfortable both the summer and winter.

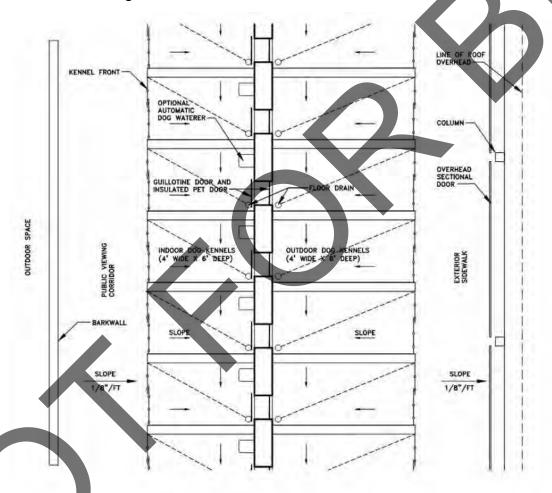


DIAGRAM OF CONVERTIBLE DOG KENNELS (NOT TO SCALE)

The two-compartment kennel design will allow dogs to be kept safe and dry during the cleaning procedure by moving dogs to the covered outside run. This allows for efficient daily cleaning. Floors will be sloped to individual drains thereby eliminating trench drains which are difficult to clean and can cause cross contamination.

There should be special sound control materials used in the design to keep the noise level down. Dog Kennels should be arranged where dogs are not looking at each other across the aisle which can cause stress and increase barking.



Photo of indoor portion of convertible kennels with garage doors open



Photo of indoor portion of convertible kennels with garage doors closedc



Photo of outdoor portion of convertible kennels with garage doors open



Photo of outdoor portion of convertible kennels with garage doors closed

2. Cat Housing

SPA recommends two compartment housing for cats which is consistent with recommendations of the Association of Shelter Veterinarians. This allows the cat cages to be spot cleaned on one side while the cat is in the other compartment. This eliminates the need to move the cats out of their cages for cleaning. This reduces the potential transfer of disease and reduces stress for the cats.



Mason Cat Towers



Shor-line Stainless Steel Cat Suite



Shor-line "Comfort Suite" with individual exhaust in each litterbox.



Cat Community Room with free roam cats



Catio with free roam cats

B. Interior Features

Animal Care Centers built in the past did not have the advantage of using many of the new innovative materials and equipment available only in recent years. Animal Care Centers of today are no longer just "warehouse structures" with cages lined down the walls.

Animal Care Centers are very specialized buildings which are more like hospitals and shopping malls than warehouses in construction.

A high level of quality is needed if the facility is to be able to keep animals healthy and to hold up under heavy wear. This is especially important for an Animal Care Center that is striving to present an attractive, welcoming image to the public.



An attractive, spacious, quiet front lobby is important in an Animal Care Center.

This improves customer satisfaction and increases adoptions.

The goal is to make the Animal Care Center a place where employees feel positive and the public enjoys visiting for pet adoption, pet retrieval, pet owner education and other animal services. Most importantly, the Animal Care Center must house animals in the healthiest, least stressful manner possible.

Today, modern Animal Care Centers are designed to include central washing equipment, automatic animal watering systems, individual kennel floor drains, fresh air

with heat exchangers for economy, heated kennel floors, noise control systems and long-lasting, easily disinfected wall and floor finishes.

Special equipment can be utilized in a new Animal Care Center. During the preparation of the construction drawings and specifications in Step 3 we will review with you all of the details and choices that are available including performances, features, pros & cons, and the cost implications of the various options. Some of the equipment and finishes are pictured below.



STONTEC

Decorative Flake Finish Flooring Systems

Dense, stain resistant, epoxy and ursthane-based systems in an extensive range of flake finishes and n teams for applications from pharma labs to university concourses. color options. P installations.



The special epoxy on kennel floor finish comes in an attractive array of earth tone colors to make kennels cheerful and bright. It also halts bacteria growth.



BiteGuard KennelPlex™

Commercial Dog Doors



Featuring Two Energy Efficient Designs:

Single Panel Top Swing

and

Dual Panel Saloon Style

Kennel Doors



Versatility for all types of installations

Models engineered for the requirements of professional kennels worldwide

Shelter Planners of America uses special Guillotine doors with an insulated Pet door that prevents loss of heated or cooled air from the kennel.

AUTOMATIC KENNEL WATERER

Provides a constant supply of fresh water. Eliminates the time-consuming task of refilling water bowls. Saves on the expense of replacing damaged water bowls. Conserves water.

DRINKING BOWL CLEANS FAST AND EASY



A quick 1/4 turn of optional water line valve shuts off water flow.



Slide latch bar with thumb to release the stainless steel drinking bowl.



 The drinking bowl disconnects from the wall bracket and lifts out from under the float valve. Takes less than 10 seconds.

Each dog Kennel is equipped with an automatic waterer so that dogs always have fresh water available with no staff time required refilling bowls.



Attractive Kennels with bright lighting levels, epoxy floor finishes and sound absorbing ceilings make quiet, inviting public spaces.



Professional grooming tub that animals can be walked into through a swinging door.

C. Heating, Ventilating, Air Conditioning (HVAC)

Heating, ventilating and air conditioning systems must be designed to provide clean, odor free and uncontaminated air throughout all animal housing areas. This is essential to control the spread of air borne disease.

The HVAC system will be custom designed to provide a high volume of fresh air to kennels with a specific number of air changes per hour at the proper temperature and humidity range. The system will be designed to provide ceiling air supply above public walkways with a ceiling exhaust above dog runs opposite each supply providing the best odor control for the visiting public and staff.

Additionally, the systems will be fitted with heat exchangers to recapture energy before it is exhausted. This helps keep utility bills as low as possible. There will also be supplemental roof mounted exhaust fans (with separate switches on timers, with red lights) to pull out moist air during and immediately following kennel cleaning.

The facility should be served by multiple, separate, smaller HVAC systems, each to serve a portion of the facility. This smaller equipment is less expensive to install and service and if a system fails, you still have portions of the building heated and cooled until the system is repaired. Animals can be doubled up until repairs are made. The administrative areas are on a separate air system to prevent odors from entering the staff areas.

7. STAFFING

The proposed staff for the new Animal Care Center consists of the following staff positions:

	Position		per of aff
	Position	Full	Part
		Time	Time
1	Animal Control Officer Trainee	6	
2	Animal Behaviorist	1	
3	Animal License Checker I	9	
4	Fiscal Assistant	1	
5	Chief, Animal Care and Control	1	
6	General Services Worker II	10	
7	Health Education Specialist II	2	
8	Health Education Specialist I	1	
9	Office Assistant II	10	
10	Office Assistant IV	2	
11	Public Health Manager	1	
12	Registered Veterinarian Tech	4	
13	Supervising Animal Control Officer I	2	
14	Supervising Animal Control Officer II	3	
15	Veterinarians	2	
	Total	55	

This staffing level is consistent with most Animal Care Centers across the Country handling approximately the same number of animals and having similar adoption results. The Building Space Program including in this in this Report is designed to accommodate the proposed staffing.

Also, in a new Animal Care Center that is a more pleasant environment, it should be possible to have a successful volunteer program. Volunteers can help with a wide variety of activities at the Animal Care Center to promote adoption.

8. OPERATION COST

The proposed annual operating cost for the new Animal Care Center is \$6,376,436.38. The average cost per animal handled will be approximately \$617 based on the 10,326 animals the new Animal Care Center could intake. The proposed operating cost is consistent with operating costs we have observed around the United States.



9. OPINION OF PROBABLE COST

Construction cost of Animal Care Centers vary significantly, based on the national economy, the region of the country they are constructed in, when they are constructed, the individual market factors at that time and the method of project delivery. Other important factors are the size of the Animal Care Center, the site conditions such as soil and topography, quality of finishes and materials, HVAC systems included and the quality of animal equipment. Since detailed design drawings and engineering have not been prepared at this time, only estimated costs can be presented.

The Opinion of Probable Cost presented is based on actual costs of several good.

quality Animal Care Centers we have designed. We have taken those costs and adjusted the cost for Anaheim, CA in 2022 based on the R.S Means cost guide. Refer to EXHIBIT D for examples of Animal Care Centers built around the country with the estimated cost per sf adjusted for Anaheim, CA. Unfortunately, there is not construction cost data available specifically for Bloomington, CA It is possible the costs in Bloomington could be lower, but we are not certain.

Please note that modern Animal Care Centers are more like a combination of a hospital and a shopping mall than a warehouse or other industrial use. The cost of modern Animal Care Centers often surprises people because the cost is actually more than many buildings they may be familiar with. The following are some reasons for this:

- 1. Animal Care Center foundations are complicated because there will be slopes within the animal housing areas to drains and this requires additional labor beyond most buildings like schools or office buildings.
- 2. The floor finishes in animal housing areas are perhaps 3 times the cost of typical carpet or other floor finishes in most buildings.
- 3. Animal Care Centers have animal equipment that can add \$20 to \$30/SF on top of the cost of most buildings. Occasionally, the costs people hear about other Animal Care Centers they do not know if this equipment is included in the price or not. For the estimate in this report, we have included the animal equipment.

- 4. Animal Care Centers have more walls per SF than most any other building type. For example, dog kennels walls are usually 4 feet to 6 feet apart whereas classrooms in schools are more like 20 feet apart.
- 5. The Heating, Ventilation and Air-Conditioning (HVAC) systems in the animal housing portions of Animal Care Centers are more expensive than other buildings to reduce disease transmission.
- 6. The wall finishes in the animal housing portions of Animal Care Centers need to be a non-porous and durable finish to prevent disease transmission and to stand up to the daily washing. Glazed structural tile is a common material but costs significantly more than other materials.
- 7. Sound control within Animal Care Centers is generally more cost than many building types due to the dogs barking. This requires the walls being extended to the roof deck to prevent sound transmission to other areas and this requires sound absorption materials that cost more than normal materials.

Refer to Exhibit C dated 11-29-2022 for the Opinion of Probable Cost. We have included Construction Costs including Site Work as well as for soft costs and contingency that should be considered. Please note, the cost of land is not included.



1227 SAN BERNADINO COUNTY ANIMAL CARE CENTER

EXISTING AND PROJECTED HUMAN POPULATION AND ANIMAL INTAKE - 20 Year Projection

11/29/2022

Existing Shelter	Area Served	2021 Human Population For Service Area		Intake		% of Intake to Human Population		Housing Units		Projected Human Population in 20 years 2041	2041 Projeced Intake Ratio		I Current I			umber of Animals to be bused for New SBCACC		
			Dogs	1,861	Dogs	0.91%	Dogs	80	16		Dogs	0.91%	2,004	16		88		
Devore Animal	Unicorporated communities located in the Central Valley Region of the	203,630	Cats	2,449	Cats	1.20%	Cats	81	12	220,247	Cats	1.20%	2,643	12	If Serving Devore Animal Shelter Area	87		
Shelter	County and contract cities of Highland and Yucaipa	203,030	Others	640	Others	0.31%	Others	50	29	220,247	Others	0.31%	683	14	Only	26		
	3		Total	4,950	Total	2.43%	Total	211			Total	2.43%	5,352					
			Dogs	548	Dogs	0.53%	Dogs	N/A	N/A		Dogs	0.53%	594	16	_	26		
Rialto	City of Rialto	103,743	Cats	575	Cats	0.55%	Cats	N/A	N/A	112,500	Cats	0.55%	624	12	Housing Units to add if including City of Rialto	20		
Marto	city of fillance	103,7 13	Others	47	Others	0.05%	Others	N/A	N/A	111,000	Others	0.05%	51	14	Service Area	2		
			Total	1,170	Total	1.13%	Total	N/A	N/A		Total	1.13%	1,269					
	City of Fontana		Dogs	1,081	Dogs	0.50%	Dogs	N/A	N/A		Dogs	0.50%	1,305	16	_	57		
Fontana		215,753	Cats	960	Cats	0.44%	Cats	N/A	N/A	260,407	Cats	0.44%	1,159	12	Housing Units to add if including City of	38		
Torrearia			Others	141	Others	0.07%	Others	N/A	N/A		Others	0.07%	170	14	Fontana Service Area	7		
			Total	2,182	Total	1.01%	Total	N/A	N/A		Total	1.01%	2,634					
				Dogs	342	Dogs	0.63%	Dogs	N/A	N/A		Dogs	0.63%	349	16		15	
Colton	City of Colton	54,008	Cats	383	Cats	0.71%	Cats	N/A	N/A	55,076	Cats	0.71%	391	12	Housing Units to add if including City of Colton -	13		
Conton	City of Collon	2 1,000	Others	61	Others	0.11%	Others	N/A	N/A	35,676	Others	0.11%	62	14	Service Area	2		
			Total	786	Total	1.46%	Total	N/A	N/A		Total	1.46%	802					
			Dogs	49	Dogs	0.40%	Dogs	N/A	N/A		Dogs	0.40%	49	16		2		
Grand Terrace	City of Grand Terrace	12,232	Cats	33	Cats	0.27%	Cats	N/A	N/A	12,261	Cats	0.27%	33	12	Housing Units to add if including City of Grand -	1		
Grana remace	city or craina remade	,	Others	44	Others	0.36%	Others	N/A	N/A	,	Others	0.36%	44	29	Terrace Service Area	4		
			Total	126	Total	1.03%	Total	N/A	N/A		Total	1.03%	126					
			Dogs	3,881	Dogs	0.66%	Dogs	N/A	N/A		Dogs	0.66%	4,349	16		191		
	Total of All Service Areas	Total of All Service Areas	589.366	Cats	4,400	Cats	0.75%	Cats	N/A	N/A	660,491	Cats	0.75%	4,931	12	Total Housing Units of	162	
			Total of All Service Areas	589,366	Others	933	Others	0.16%	Others	N/A	N/A	660,491	Others	0.16%	1,046	14	All Service Areas	40
						Total	9,214	Total	1.56%	Total	N/A	N/A		Total	1.56%	10,326		

BUILDING SPACE PROGRAM - 20 YEAR PROJECTION SAN BERNARDINO COUNTY, CA

DATE: 11-29-22

Summary:		Interior	Exterior
A. Administrative		16,151	
B. Medical Clinic		3,178	
C. Animal Housing (Interior)		17,249	
D. Animal Housing (Outdoor Covered)			10,094
E. Animal Support Area (Interior)		6,917	
F. Animal Support Area (Unfinished space)			4,500
	TOTAL SF	43,496	14,594
	COMBINED SF	58,090	

SECTION A - ADMINISTRATIVE

<u> </u>	SECTION A - ADMINISTRATIVE												
	Room or Space	No. of Rooms			SF of Each		Total SF	Adjacent to or Near	Equipment / Comments				
	PUBLIC AREAS												
1	Adoption Lobby	1			1,000		1,000		Visitor seating for 20. Approximate 10' wall for retail display shelves viewable from Customer Service Counter. Consider wall space for sponsor wall and 2 or 3 large screen TVs. Space for computer kiosks for services. Tall space with lots of natural light and some "wow factor"				
2	Vestibule for Adoption Lobby	1			80		80	Adoption Lobby					
3	Animal Admission Lobby	1			300		300	Near public parking	Visitor seating for 5, wall to separate from Adoption Lobby.				
4	Vestibule for Admissions Lobby	1			80		80	•	separated from Adoption entrance by 20' and separate sidewalk up to entrance				
5	Customer Service Counter (4 Customer Service Representatives)	1			300			Animal Admission Lobby	Arrange counter to serve both the Adoption Lobby and the Animal Admission Lobby. Space for 3 staff at Adoption Lobby and 1 staff at Animal Admission Lobby. The two service counters arranged to be connected to conserve staff time. Wall behind the front desk reserved for logo or artwork. Use multipurpose printers in lieu of full size copier. Space off to the side and out of view for donations.				
6	Adoption Interview Space	3			120		360	adjacent to the Customer Service Counter accessible by public on one side and staff on the other side	Semi-private cubicles with counter at sit down height				

		ı			-		adiacont to the	Countarian with upper achinate concealed
7	Workroom for Customer Service	1			100	100	adjacent to the Customer Service	Countertop with upper cabinets concealed from public view.
'	Workloom for Customer Service	'			100	100	Counter	Inom public view.
8	Volunteer Check-In	1			50	50	Adoption Lobby	Kiosk Computer for Check-In & name tags.
٣	Volunteer Officer in	'			- 50		near Animal	Arrange counter to serve the Animal
							Admission Lobby	Admission Lobby. Space for 3 staff at to
	Dog Licensing Service Counter (3 Customer						,,	interact with the public. Discuss with SBC if
9	Service Representatives)	1			180	180		they need this to be adjacent to the Call
	,							center on the Second Floor. Built-in safe for
								money. Verify location
							Adjacent to Lobby and	Seating for 60 at training tables or 100 in rows
							arranged for after-	of chairs. To be used for staff training and
10	Multi-Purpose Room	1			1,500	1,500	hours use, including	similar meetings but will also be used for
							use of toilet	animal events such as obedience training,
								vaccine clinics.
١.,	01 : 17 11 01				400	400	Adjacent to Multi-	To store tables and chairs when not in use
11	Chair and Table Storage	1			120	120	Purpose Room	and other materials to support meeting room.
-								
12	Agility Equipment Storage	1			120	120	Adjacent to Multi-	To store agility equipment for dog training
'-	7 tgy = qpe e te. e.g.e						Purpose Room	
							adjacent to Multi-	Countertop with sink, full size refrigerator,
12	Kitchen	1			100	100	Purpose Room and	microwave, coffee maker
13	Richen	'			100	100	Staff Break Room if	
							possible	
14	Public Toilets	4			60	240	Male and Female	All Gender toilets- Verify code minimum.
							separate	Character two wanding machines accessible
15	Vending Machine Alcove	1			50	50		Space for two vending machines accessible by pubic and staff
								by public and stain
		No. of			SF of			
	Room or Space	Rooms		No. of People	Each	Total SF	Adjacent to or Near	Equipment / Comments
	OFFICES							
	0111020			·				
16	Chief, Animal Care and Control	1		1	200	200		Verify size of all office to comply with County
	,	'		'		200		standards
	Public Health Manager	1		1	120	120		
	Heath Education Specialist II	2		1	100	200		
	Heath Education Specialist I	1		1	100	100		
	Office Assistant IV	1		1	100	100		
	Supervising Animal Control Officer I	2		1	100	200		
	Supervising Animal Control Officer II Animal Control Officer- Group Office	3		6	100 64	300 384		
23	Animal Control Officer- Group Office			U	04	304		Animal License Checker I
.								countertop on top. verify number of file
24	Animal Licensing Group Office			9	70	630		cabinets but their exist office has 4. Built-in
								drop safe for money. verify location.
								and bearing in the state of the
								1 Fiscal Assistant
25	General Group Office	1		21	70	1,470		

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	OTHER ADMINISTRATION SPACES								
26	Workroom	1			120			up stairs with administrative offices	countertops, upper cabinets, 2 copy machines. Built-in safe for money for
27	Conference Room	1		20	300		300		administration. Verify location conference table for 10 plus seats on the
28	Fie Room	1			400		400		perimeter 400 SF can house 36 file cabinets
29	Staff Breakroom	2			200			one near Administration and one near animal housing	Counter with sink, microwave, refrigerator, coffee maker, seating at a table for 8
30	Staff Coffee Bar	2			10		20	one near Administration and one near animal	provide if the primary breakroom is too far away from some staff.
31	Staff Locker Alcove	1			60		60	in a staff only corridor	60 lockers, 1'-0" wide x 1'-6" deep for hangers and 3'-0" tall.
32	Staff Toilets- Administration	4			200			in administration building	Separate male and female toilets , womens to have 3 water closet stalls and 2 lavatories at a counter. Verify code minimum
33	Staff Toilets- Animal Care	4			60		240	near animal housing	single person toilets (all gender) distributed as needed for reasonable travel distance for staff
34	Staff shower and Dressing Stall	1			60			near animal housing and grouped with a set of staff toilets	shower room with dressing bench per ADA
35	Volunteer Breakroom	1			200		200		Counter with sink, microwave, refrigerator, coffee maker, seating at table for 4. 20 lockers 1'-0" wide X 1'-6" deep for hangers and 3'-0" tall.
36	Volunteer Work Area	1			100		100	near volunteer Breakroom and Toilet	Countertop with two computer work stations. Discuss a staff position as "Volunteer Coordinator" and does this space need to be near that person?
37	Volunteer Toilet	1			60		60	near Volunteer Breakroom	single person toilet (all gender)
	Storage Room for Office Area	1			80		80		
	Mechanical/ Elec Room	1			150		150		
	Data Room- MDF	1			120		120		check County standards
	Data Room- IDF	2			80		160		check County standards
	Fire Riser Room Janitorial Closet	3			100 50		100 150	distributed around	verify requirements with AHJ
		1						campus Foster Coordinator	
	Foster Waiting Foster Storage	1			80 80		80	Medical Lobby	Space for litter, food, formula, crates provided to Fosters
46	Evidence Storage	0			-		-		Not required per SBC, this function will be housed at Devore
	Subtotal:						11,964		
							·		
	Net to Gross SF Factor 35%: Departmental Gross Area:				4,187 16,151				
	Departmental Gross Area:			10,151					

SECTION B - MEDICAL CLINIC

	Room or Space	No. of Rooms		No. of People	SF of Each		Total SF	Adjacent to or Near	Equipment / Comments
1	Medical Lobby	1			120		120	access from public parking	open space for standing only
2	Medical Reception Desk for check in for spay neuter services to the public	1			64		64	adjacent to Medical Lobby	
3	Exam Room	2			120		240		Countertop with sink, exam table, door from Lobby and door to Clinic (pass-through concept)
4	Prep/Treatment Room	1			360		360		2 peninsula style wet exam tables, scrub sink
5	Pre-Op/Post-Op Holding - Dogs	1			150		150		15 cages
6	Pre-Op/Post-Op Holding - Cats	1			130		130		16 cages (6 large, 4 medium) and 4 runs 4'x4'
7	Surgery Room	1			300		300		Two surgery tables, instrument storage cabinets, space for 4 dogs to recover on floor (TBD), view windows to prep area, dog Pre-Op /Post-Op and Cat Pre-Op/ Post-Op.
8	Work Stations for Vet Techs	1		2	30		60		4 Vet Techs will share, 2 work stations
9	Veterinary File Storage	1			80		80		
10	Laboratory - Pharmacy Alcove	1			100		100		Countertop approximately 12' long with two compartment sink, full size refrigerator with upper cabinets above. Space for microscope, slides, centrifuge, blood rocker, and blood analyzer
11	Medical Storage	1			80	7	80		shelving for medical supplies
	Medical Gas Storage Room	0							Use oxygen generators built into anesthesia machines. Not cylinders or a built-in oxygen generator
13	X-Ray Room	1			120		120		
14	Clean Up Area	1	X		100		100		Countertop with two compartment sink, 2 autoclaves, pass- through from Surgery rooms if possible
15	Staff Toilet for Medical staff	1			50		50		Multi-gender type
16	Medical Laundry	1			60		60		Residential size commercial washer and dryer. This laundry is only for sterile drapes, surgical towels and similar items.
17	Veterinarian Office	1		2	140		140		
18	ICU	1			200		200		separate room for sick animals being cared for. Space for 10 large cages. Consider electrical outlets for heating pads, oxygen generator, and away to hang IV s
19	Access to mobile unit	1			50		50		parking space outside of Clinic to park mobile Spay/Neuter Unit
	Subtotal:						2,354	_	
	Net to Gross SF Factor 35%:						824		
	Departmental Gross Area:						3,178		

SECTION C - ANIMAL HOUSING - INTERIOR

	Room or Space	No. of Spaces		Animals to be Housed	5	Size	,	SF of Each	SF of Walkway	Total SF	Adjacent to or Near	Equipment / Comments
1	Adoption Dogs/ Stray Dogs	9	1	9	6.0	х	6.0	36	30	594		See corresponding Exterior Run
	Adoption Dog Runs - Standard	110	1	110	4.3	х	6.0	26	22	5,239		See corresponding Exterior Run
	Stray Dog Runs - Jumbo	3	1	3	6.0	х	6.0	36	30	198		See corresponding Exterior Run
4	Stray Dog Runs - Standard	37	1	37	4.3	х	6.0	26	22	1,762		See corresponding Exterior Run
5	Nursing Mother Dogs - Jumbo	0	1	0	6.0	Х	6.0	36	30	-		See corresponding Exterior Run
6	Medical Observation Dog Runs	17	1	17	4.3	Х	6.0	26	22	810		See corresponding Exterior Run
7	Medical Isolation Dog Runs	11	0	11	4.3	Х	6.0	26	22	524		See corresponding Exterior Run
8	Quarantine Dog Runs	0	1	0	4.3	Х	6.0	26	22			
9	Puppy Pens	0	0	0	4.3	Х	6.0	26	25	-		
10	Foster Dog Runs - Jumbo	1	0	1	6.0	Х	6.0	36	30	66		See corresponding Exterior Run
11	Foster Dog Runs - Standard	3	1	3	4.3	Х	6.0	26	22	142		See corresponding Exterior Run
	TOTAL DOGS:			191								
12	Adoption Cat Room	36	1	36				5	12	612		Each cat is housed in a 2-compartment cage.
	Stray Cat Room	30	1	30				5	12	510		Each cat is housed in a 2-compartment cage.
14	Cat Community Rooms (18 SF / cat Free Roam)	2	4	8	8.0	х	9.0	72		144		
15	Fractious Cat Room	72	1	72				5	12	1,224		Each cat is housed in a 2-compartment cage. Some viewable through glass
16	Not Used	0	0	0				18	12	-		
17	Not Used	0		0				5	12	<u>-</u>		
18	Nursing Mother Cats	0		0				5	12	-		
19	Medical Isolation Cats - Non-Viewable	8	1	8				5	12	136		Each cat is housed in a 2-compartment cage.
20	Strict Medical Isolation Cats - Non-Viewable	8	1	8				5	12	136		Each cat is housed in a 2-compartment cage.
21	Quarantine Cat Room	0		0				18	12	-		Each cat is housed in a 2-compartment cage.
	TOTAL CATS:			162								
22	Other Animals	1		40				5	12	680		One room with cages or space for habitats for reptiles, snakes, lizards, turtles, rabbits and other species
								-	-	-		
								-	-	-		
	Subtotal:									12,777		
	Net to Gross SF Factor 35%:			4,472								
	Departmental Gross Area:			17,249								

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SECTION D - ANIMAL HOUSING - OUTDOOR COVERED

	Room or Space	No. of Spaces	Animals per Space	5	Size				Size		Size		Size		Size		SF of Each	SF of Walkway	Total SF	Adjacent to or Near	Equipment / Comments
1	Adoption Dog Runs - Jumbo	9		6.0	Х	8.0	48	30	702		See corresponding Interior Run										
2	Adoption Dog Runs - Standard	110		4.3	Х	8.0	35	22	6,192		See corresponding Interior Run										
3	Stray Dog Runs - Jumbo	3		6.0	Х	8.0	48	30	234		See corresponding Interior Run										
4	Stray Dog Runs - Standard	37		4.3	Х	8.0	34	22	1,273		See corresponding Interior Run										
5	Nursing Mother Dog Runs - Jumbo	ı		6.0	Х	8.0	48	30			See corresponding Interior Run										
	Medical Observation Dog Runs	17		4.3	Х	8.0	34	22	950		See corresponding Interior Run										
7	Medical Isolation Dog Runs	11		4.3	Х	8.0	34	22	615		See corresponding Interior Run										
8	Dog Quarantine Runs	-		4.3	х	8.0	34	22			See corresponding Interior Run										
9	Puppy Runs -	-		-	х	-	-		1		See corresponding Interior Run										
	Foster Dog Runs - Jumbo	1		-	х	-	-		-		See corresponding Interior Run										
	Foster Dog Runs - Standard	3		-	Х	-	-				See corresponding Interior Run										
12	Cat Sun Porch	2		8.0	Х	8.0	64		128		See corresponding Interior Cat Free Roam										
									Y												
	Subtotal:			10,094																	
	Departmental Gross Area:				10,094																

SECTION E - ANIMAL SUPPORT AREA - INTERIOR

	Room or Space	No. of Rooms		SF of Each	Total SF	Adjacent to or Near	Equipment / Comments
1	Animal Receiving (exam room)	2		250	500	One near Animal Admissions Lobby and one near Sally Port	Countertop with sink, refrigerator, scales for dogs and cats, space for computer station, microscope, space to photograph animals
2	Dog Intake Holding	2		72	144	Animal Receiving	2 dog pens (4' x 4' in size) in a separate room
3	Cat Intake Holding	2		40	80	Animal Receiving	2 cat cages in a separate room
4	Dog Get Acquainted Area	2		120	240	near dog housing	
5	Cat Get Acquainted Area	2		80	160	near cat housing	
6	Behavior Assessment	1		150	150		
7	Behavior Training	0		400	-		Plan to use Multi-Purpose Room
8	Animal Kitchen	4		150	600		Study benefits of a central kitchen verses decentralized kitchens. Counter with 3-compartment sink, commercial dishwasher, and refrigerator
9	Food and Litter Storage	1		400	400		metal lined walls
10	Food Storage for Giveaway Program	0		-	-		not required per SBC
11	Laundry	1		480	480		2 or 3 Commercial washers and 2 or 3 dryers. Space for folding table, shelves for clean laundry and space for soiled linen carts. SBC to confirm number of lbs. of laundry per day per animal
12	Cleaning Equipment Room	4		80	320	One near Adoption Dogs, Stray Dogs, Medical Dogs and Cats	
13	Grooming Room	1		200		verify location. Is it in public view so volunteers can access or in a "staff only" area	2 Grooming tubs & 2 Grooming tables
14	Photo Room	1		180	180		space for photographing animals for adoption photos with back drops, lighting and photography equipment
15	Maintenance room	1		120	120		Work bench, tool storage
20	Euthanasia Room	1		150	150		Countertop with sink, exam table, refrigerator
21	Post Euthanasia Room	0		150	-		Need to discuss the need for these spaces with SBC
22	Post Euthanasia Holding	0		100	-		Need to discuss the need for these spaces with SBC
23	Walk-in Freezer	1		200	200	Euthanasia	Access to Service Drive
	Mechanical Room	6		200	1,200		
	Subtotal	:			5,124		
	Net to Gross SF Factor 35%	:			1,793		
	Departmental Gross Area	:			6,917		

SECTION F - ANIMAL SUPPORT AREA -UNFINISHED SPACE

	Room or Space	No. of Rooms		SF of Each	Total SF	Adjacent to or Near	Equipment	/ Comments	
1	Enclosed Sally Port	0		1,600	-		Fully enclosed building space for Sally Port is not required per SBC. Just driveway space enclosed with 8' tall chain-link fencing is desired.		
2	Covered Sally Port	0		1,600			Covered building space for Sally Port is not required per SBC. Just driveway space enclosed with 8' tall chain-link fencing is desired.		
3	Crematory	0		250	-		Not required per SBC		
	Event Storage	1		100	100				
5	Trap Storage	1		100	100		limited space needed be at Devore	pecause most traps will	
6	Carrier/ Crate Storage	1		200	200				
7	Storage for Animal-Related Items	1		800	800				
8	Covered Truck Washing Area	1		500	500				
9	Disaster Storage	1		2,500	2,500				
10	Power Generator Building	1		300	300				
	Subtotal:				4,500				
	Departmental Gross Area:				4,500				

OPINION OF PROBABLE COST - 20 YEAR PROJECTION

SAN BERNARDINO COUNTY, CA

DATE: 11-29-22

Based on New Construction on a New Site:

Fully Enclosed Space - SF : 43,496
Exterior Space - SF : 14,594

Total SF : 58,090

				LOW		HIGH
		New	T	otal Cost at	To	otal Cost at
		Construction		\$524		\$583
	Fully Enclosed Space	Total SF		Per SF		Per SF
Α	Administrative Areas	16,151	1			
В	Medical Clinic	3,178				
В	Animal Housing - Interior	17,249				
С	Animal Support Areas - Interior	6,917				
	Subtotals:	43,496	\$	22,791,827	\$	25,358,082
					T	otal Cost at
				\$393		\$40 8
	Exterior Space	Total SF		Per SF		Per SF
D	Animal Housing - OUTDOOR COVERED	10,094				
Ε	Animal Support Areas - Exterior - UNFINISHED SPACE	4,500				
	Subtotals:	14,594	\$	5,735,403	\$	5,955,771
	Building - Sub-Totals:	58,090	\$	28,527,229	\$	31,313,853
	Low High					
	Site Work & Parking 10% 15%		\$	2,852,723	\$	4,697,078
	Total Construction Cost		\$	31,379,952	\$	36,010,930
		Total Cost / SF	\$	540	\$	620
	Consider Budgeting for the following:					
	Soft Costs 15%					
	(AE Fees, Civil Engineering, Surveying, Soil Tests,					
	Construction Materials Testing, Air Balancing,		_	4 700 000	•	5 404 040
	Furnishing, Loose Equipment, Computers & Phone		\$	4,706,993	\$	5,401,640
	System, etc.)					
	Contingency 5%		\$	1,804,347	\$	2,070,629
	Estimated Total Project Cost		\$	37,891,292	\$	43,483,199

*Note: This does not include the cost of land.



EXHIBIT D - COST EXAMPLES OF OTHER SHELTERS

Arlington Animal Service Center Arlington, TX



Project Information:

- Publicly Bid
- Project Delivery Method: Competitive
- Type of Construction: Steel Frame and crawl space type foundation due to soil conditions
- Dog Kenneling Material: Chain-link
- Flooring in Dog Kennels: Epoxy Resinous

- 100% of Outside Air for Animals
- Project Size: 20,000 SF
- Site Size: 4 acres (limited size work)
- · Quality: High
- All indoor dog kennels with single compartment housing which is not normally recommended.

PROBABLE CONSTRUCTION COST IN 2022, ANAHEIM, CA DOLLARS \$420/SF


This is a City owned facility that features an "Adoption Mall" concept and a full animal hospital. The facility houses 131 Dogs and 128 Cats.





Arlington Animal Service Center Arlington, TX



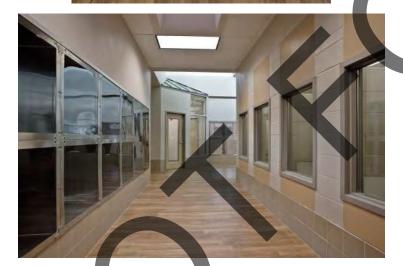







Beaufort County Animal Services & Hilton Head Humane Association



Project Information:

- · Publicly Bid
- Project Delivery Method: Competitive
- Type of Construction: Wood Frame
- Flooring in Dog Kennels: Epoxy Resinous
- Project Size: 20,000 SF
- Site Size: 4 acres (extensive site
 - work)
- Quality: High

PROBABLE CONSTRUCTION COST IN 2022, ANAHEIM, CA DOLLARS \$561/SF


This is a County owned facility that is Jointly Operated. The campus contains the County's Animal Control Department, the Hilton Head Humane Association's Adoption Center, and a large Spay-Neuter Clinic that performs over 7,500 surgeries per year, for not only the County shelter, but provides low cost services to the public. The facility houses 61 Dogs and 88 Cats.



Beaufort County Animal Services & Hilton Head Humane Association

Beaufort County, SC



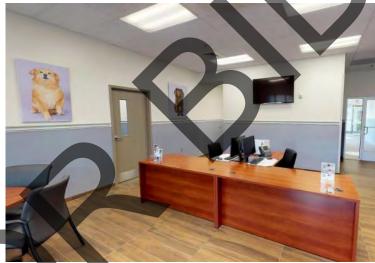











Chatham County Animal Services Facility Pittsboro, NC



Project Information:

- Publicly Bid
- Project Delivery Method: CMAR
- Type of Construction: Steel Frame
- Dog Kenneling Material: Welded Stainless Steel
- Flooring in Dog Kennels: Epoxy Resinous
- HVAC System: 100% of Outside Air for Animals
- Project Building Size: 15,600 including a 4,000 SF renovation.
- Developed Area: 3 acres
- Total Land Area: 10 acres
- All indoor Quick-Clean dog kennels
- · Quality: High

PROBABLE CONSTRUCTION COST IN 2022, ANAHEIM CA DOLLARS \$531/SF

This is a County owned and operated animal shelter with housing for 40 dogs and 60 cats.



Chatham County Animal Services Facility Pittsboro, NC











Harris County Pet Resource Center Houston, TX



Project Information:

- Publicly Bid
- Project Delivery Method: CMAR
- Type of Construction: Steel Frame
- Dog Kenneling Material: Welded Stainless Steel
- Flooring in Dog Kennels: Epoxy Resinous
- 100% Outside Air for Animals
- Project Size: 57,830 SF
- Site Size: 10 acres
- Quality: High

PROBABLE CONSTRUCTION COST IN 2022, ANAHEIM, CA DOLLARS \$576/SF

This is a County owned and operated facility that houses 250 dogs and 200 cats. It has 2 medical clinics, one for shelter animals and one that serves the public.



Harris County Pet Resource Center Houston, TX















Harris County Pet Resource Center Houston, TX









Lafayette Animal Shelter and Care Center Lafayette, LA



Project Information:

- Publicly Bid
- Project Delivery Method: CMAR
- Type of Construction: Steel Frame
- Dog Kenneling Material: Welded Stainless-Steel
- Flooring in Dog Kennels: Epoxy Resinous
- Project Size: 21,400 SF
- Site Size: 4.5 acres
- Quality: High

PROBABLE CONSTRUCTION COST IN 2022, ANAHEIM, CA DOLLARS \$495/SF

The facility houses 96 Dogs and 80 Cats.



Lafayette Animal Shelter and Care Center Lafayette, LA















Operation Kindness Carrollton, TX



Project Information:


- Private Bid
- Project Delivery Method: CMAR
- Type of Construction: Wood Frame
- Dog Kenneling Material: Glazed CMU and Welded Stainless Steel
- Flooring in Dog Kennels: Epoxy Resinous
- HVAC System: 100% outside air in Animal area
- Project Size: 32,471 SF, includes 9,000 SF remodeled area
- Site Size: 4 acres (extensive site work)
- · Quality: High

PROBABLE CONSTRUCTION COST IN 2022, ANAHEIM, CA DOLLARS \$481/SF

This is a privately operated non-profit facility that pulls animals from local government shelters that have special medical needs. The facility features a large animal hospital and medical recovery wing. The facility is designed to house 142 Dogs and 120 Cats.




Operation Kindness Carrollton, TX

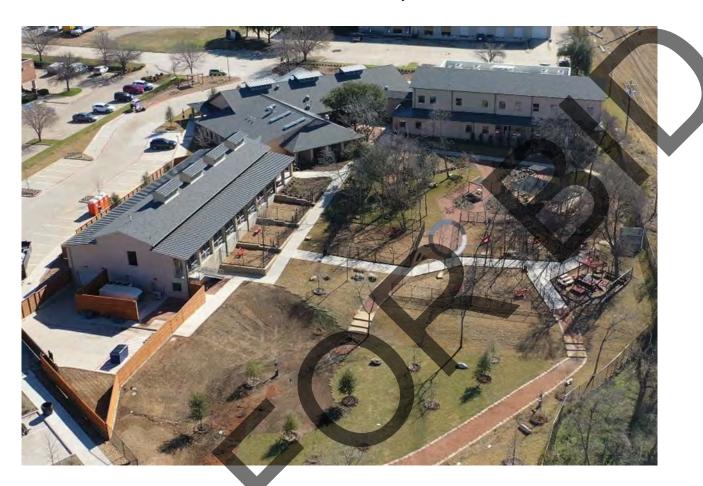





Operation Kindness Carrollton, TX

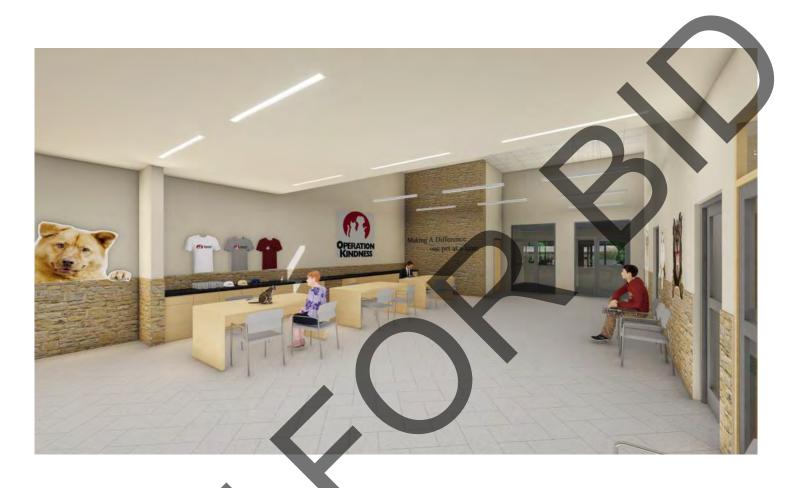





Springdale Animal Shelter Springdale, AR



Project Information:

Public Bid

Project Delivery Method: CMAR

Type of Construction: Wood Frame

Flooring in Dog Kennels: Epoxy Resinous

• Project Size: 12,780 SF

Site Size: 3 acres

Quality: High

PROBABLE CONSTRUCTION COST IN 2022, ANAHEIM CA DOLLARS \$548/SF

Springdale Animal Services is owned and operated by the City of Springdale. This area is experiencing significate population growth. The facility is designed to house 76 Dogs and 72 Cats.



Springdale Animal Shelter Springdale, AR











"Shelter Planners of America" Williamson County Animal Care Center Franklin, Tennessee



Project Information:


- **Public Bid**
- Project Delivery Method: CMAR
- Type of Construction: Wood Frame
- Flooring in Dog Kennels: Epoxy Resinous
- Dog Kenneling: Adoption Kennels are Glazed CMU and others are Epoxy paint on CMU. All kenneling is welded stainless steel
- HVAC System: 100% Outside Air for Animal Areas
- Project Size: 32,138 SF
- Site Size: 7.25 acres
- Quality: High

PROBABLE CONSTRUCTION COST IN 2022, ANEHEIM, CA DOLLARS \$491/SF

Williamson County Animal Care Center is a county owned and operated animal shelter that serves Williamson County, TN. It features a full Medical Clinic for the animals, an indoor dog play area, and a large Education Center. The facility is designed to house 96 Dogs and 182 Cats.



Williamson County Animal Care Center Franklin, Tennessee

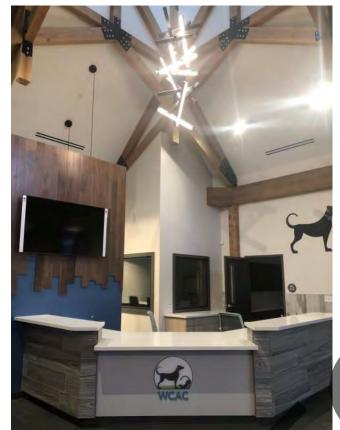







APPENDIX 3

PROJECT PLANS

BET

BRG

CAB

CAD CB

CEM

CER

CFT

CLG

between

BLDG building

BLKG blocking

BLK block

bituminous

bench marl

bottom

MT mount(ed, ing)

panic bar

pedestal

PERF perforate(d)

PL property line

plate

paint(ed)

REFR refrigerator

return

RH right hand

ROW right of way

solid core

schedule

storm drain

shelf, shelvin

stainless stee

SPEC specification(s

station

SYM symmetry(ical)

STR structural

PLYWD

PNL panel

precast concrete

PFL pounds per linear foot

poured in place

pounds per cubic foot

plywood

pounds per square foot

reinforced concrete pipe

T&G

THK thick(ness)

urinal

without

water close

water heater

WWF welded wire fabric

wrought iron

UNO unless noted otherwise

TYP typical

bronze built up roofing machine bolt both ways member MC medicine cabinet MED medium cabinet MET metal cadmium catch basin MFR manufacture(er) cement manhole minimum ceramic cubic foot mirror MISC miscellaneous cast iron CIRC circumference millimeter

MTL material(s) contract limit line clear(ance) CLS closure north centimeter CMU concrete masonry unit NAT natural not in contract COMB combination NOM nominal NTS not to scale COMP composition CONC concrete CONT continuous/ continue CONTR contract(or) overall CONST construction obscure CORR corrugated on center CPR copper outside diameter carpet(ed) overhead CYD cubic yard OPG opening OPP

DEMO demolish, demolition PAR DH double hung DIAG diagonal DIAM diameter DIM dimension division PRE.FAB. prefabricate(d) DS downspou DTL detail DWG drawing drawe PLAS plaster

each face ELEV elevation ELEC electric(al) ENC enclosure electrical panelboard PVC polyvinyl chloride EQUIP equipment RAD radius EWC electric water cooler EXHST exhaust EXP exposed

floor drain fire extinguisher finished floor elevation RO rough opening finished floor line finish(ed) floor(ina) FLUOR fluorescent

gage, gauge

galvanized iron galvanized pipe galvanized stee hollow core HDR header HDW hardware HGT height

hollow meta horizontal HVAC heating / ventilating ai HWD hardwood

ABBREVIATIONS

— SHEET NUMBER

SHEET NUMBER

WALL LETTER/NO

SHEET NUMBER

- INTERIOR ELEVATION

- DETAIL

Room name ROOM NAME

SYMBOLS

101X← ROOM NUMBER

ANIMAL CARE CENTER

18313 VALLEY BLVD. BLOOMINGTON, CA 92313

Design Development Approval County of San Bernardino

Director of Public Health, Josh Dugas

Assistant Director of Public Health, Jennifer Osorio

Chief of Animal Care and Control, Brian Cronin

PROJECT TITLE

Building Data:

BUILDING AREA FIRST FLOOR -SECOND FLOOR -TOTAL BUILDING AREA

TYPE OF CONSTRUCTION: OCCUPANCY CLASSIFICATION: **AUTOMATIC FIRE SPRINKLERS:** LAND USE DISTRICT: NATURE OF BUSINESS OCCUPANT LOAD:

Code Data:

ALL CONSTRUCTION SHALL MEET THE MINIMUM REQUIREMENTS OF THE: 2019 CALIFORNIA BUILDING CODE, VOLUMES 1 AND 2

 2019 CALIFORNIA PLUMBING CODE 2019 CALIFORNIA MECHANICAL CODE • 2019 CALIFORNIA ELECTRICAL CODE

2019 CALIFORNIA ENERGY CODE

 2019 CALIFORNIA GREEN BUILDING CODE • 2019 CALIFORNIA FIRE CODE 2019 CALIFORNIA REFERENCED STANDARDS CODE

General Notes:

QUANTITIES LISTED ON THESE DOCUMENTS ARE FOR AGENCY APPROVAL ONLY. THE CONTRACTOR IS RESPONSIBLE FOR VERIFYING ALL QUANTITIES FOR BIDDING PURPOSES.

Deferred Submittals

THE FOLLOWING ITEMS ARE THE RESPONSIBILITY OF THE GENERAL CONTRACTOR AND SHALL BE SUBMITTED AND APPROVED PRIOR TO 1. FIRE ALARM AND FIRE SPRINKLER PLANS. SYSTEM SHALL BE DESIGNED TO MEET ALL REQUIREMENTS OF NFPA13 AND LOCAL JURISDICTION REQUIREMENTS.

Site Data:

BUILDING AREA -

PARKING AREA -

LANDSCAPE AREA -

PROPERTY AREA LOT COVERAGE

XXXX SQ. FT. (XX ACRES) XXXX SQ. F.T. (XX%) XXXX SQ. F.T. (XX%)

PARKING REQUIRED - XX/XXX = XXX SPACES HANDICAP PARKING PER TABLE 11B-208.2

PARKING LOT LANDSCAPE - XXXX SQ. F.T. (XX%)

PARKING PROVIDED

PUBLIC PARKING 9' x 18' PUBLIC PARKING ADA 5' VAN 9' x 18' STAFF PARKING 9' x 19' STAFF PARKING ADA 8' VAN 9' x 19'

Legal Description:

PARCEL NO. 1: (APN: 0252-161-09)

THAT PORTION OF LOT 101, OF THE SUBDIVISION OF MARYGOLD ACRES, IN THE COUNTY OF SAN BERNARDINO, STATE OF CALIFORNIA, AS PER MAP RECORDED IN BOOK 19, PAGE 15 OF MAPS, IN THE OFFICE OF THE COUNTY RECORDER OF SAID COUNTY, DESCRIBED AS FOLLOWS:

BEGINNING AT THE NORTHWEST CORNER OF SAID LOT 101: THENCE FASTERLY ALONG THE NORTHERLY LINE OF SAID LOT, 111 FEET TO THE NORTHWEST CORNER OF THE LAND CONVEYED. TO V K AUXIER ET UX BY DEED RECORDED DECEMBER 12 1946 IN BOOK 1976 PAGE 257 OF OFFICIAL RECORDS: THENCE SOUTHERLY ALONG THE WESTERLY LINE OF SAID LAND TO A POINT IN THE NORTHERLY LINE OF PROPERTY CONVEYED TO THE STATE OF CALIFORNIA, BY DEED RECORDED MAY 23. 1945, IN BOOK 1791 OF OFFICIAL RECORDS, PAGE 29; THENCE WESTERLY ALONG THE NORTHERLY LINE OF SAID PROPERTY CONVEYED TO THE STATE OF CALIFORNIA TO THE WESTERLY LINE OF SAID LOT 101; THENCE NORTHERLY ALONG SAID WESTERLY LINE TO THE POINT BEGINNING.

EXCEPT THEREFROM THAT PORTION CONVEYED TO THE STATE OF CALIFORNIA, BY GRANT DEED RECORDED APRIL 19, 1982 AS INSTRUMENT NO. 82-074750 OF OFFICIAL RECORDS. PARCEL NO. 2: (APN 0252-161-10)

LOT 102, MARYGOLD ACRES, IN THE COUNTY OF SAN BERNARDINO, STATE OF CALIFORNIA, AS PER MAP RECORDED IN BOOK 19, PAGE 15 OF MAPS, IN THE OFFICE OF THE COUNTY RECORDER


EXCEPTING THEREFROM THE WEST 2 ACRES THEREOF. ALSO EXCEPTING THEREFROM THAT PORTION CONVEYED TO THE STATE OF CALIFORNIA FOR THE

ALSO EXCEPTING THEREFROM THAT PORTION CONVEYED TO THE STATE OF CALIFORNIA, BY

GRANT DEED RECORDED APRIL19, 1982 AS INSTRUMENT NO. 82-074750 OF OFFICIAL RECORDS

PURPOSE OF A FREEWAY BY DEED RECORDED JANUARY 30, 1945 IN BOOK 1732 PAGE 220 OF

PROJECT INFORMATION

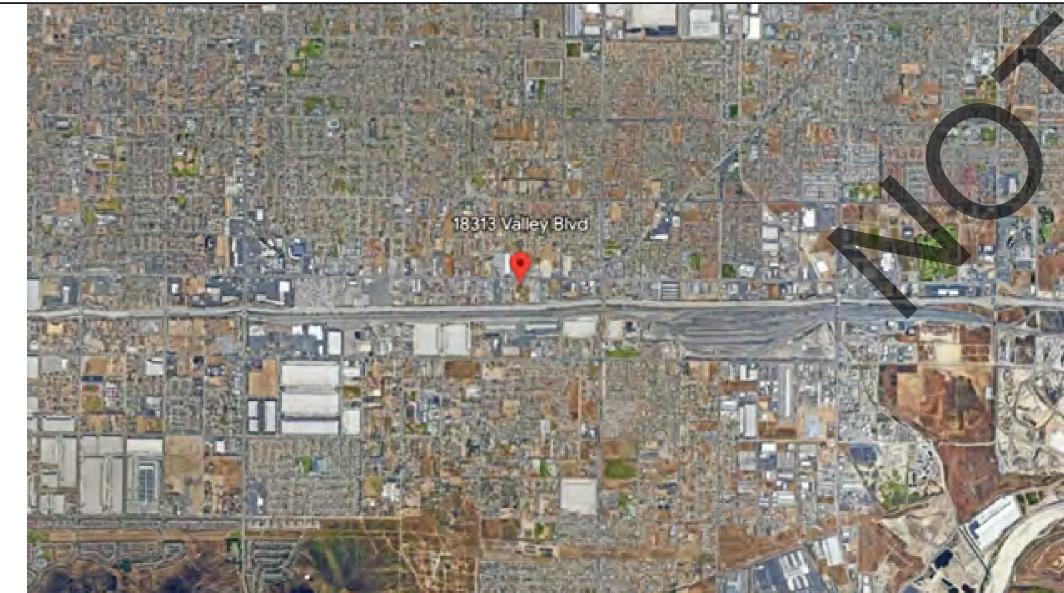

VICINITY MAP

EXTERIOR ELEVATION

— SHEET NUMBER

KEYNOTE NUMBER

DOOR NUMBER

WINDOW TYPE

HEIGHT ABOVE FINISH



THE PARTY OF THE PROPERTY OF THE PARTY OF TH

ARCHITECTURAL TITLE SHEET **EQUIPMENT** ANIMAL EQUIPMENT PLAN- ADMINISTRATION FIRST CODE ANALYSIS SITE PLAN ANIMAL EQUIPMENT PLAN- CAT AND OTHER ANIMALS ADMINISTRATION BUILDING- FIRST FLOOR PLAN ADMINISTRATION BUILDING- SECOND FLOOR PLAN ANIMAL EQUIPMENT PLAN- SUPPORT BUILDING ADMINISTRATION BUILDING- FIRST FLOOR REFLECTED AND STRAY DOG BUILDING ADMINISTRATION BUILDING- SECOND FLOOR ANIMAL EQUIPMENT PLAN- MEDICAL BUILDING REFLECTED CEILING PLAN ANIMAL EQUIPMENT DETAILS ADMINISTRATION BUILDING- ROOF PLAN ANIMAL EQUIPMENT DETAILS ADMINISTRATION BUILDING- EXTERIOR ELEVATIONS ANIMAL EQUIPMENT DETAILS ADMINISTRATION BUILDING-BUILDING SECTIONS ADMINISTRATION BUILDING- WALL SECTIONS FIRE ALARM MEDICAL CLINIC AND DOG CLINIC- FLOOR PLAN FIRE ALARM COVERSHEET MEDICAL CLINIC AND DOG CLINIC- REFLECTED CEILING **SCHEDULES** FA 200 **DETAILS** MEDICAL CLINIC AND DOG CLINIC- ROOF PLAN FIRE ALARM SITE PLAN MEDICAL CLINIC AND DOG CLINIC- EXTERIOR **ELEVATIONS** MEDICAL CLINIC AND DOG CLINIC- BUILDING SECTIONS MEDICAL CLINIC AND DOG CLINIC- WALL SECTIONS ADMINISTRATION BUILDING FIRE ALARM SECOND FLOOR PLAN CAT AND OTHER ANIMALS BUILDING-FLOOR PLAN FABC 201 | MEDICAL CLINICFIRE ALARM FLOOR PLAN CAT AND OTHER ANIMALS BUILDING- REFLECTED CAT & OTHER ANIMALS BUILDINGFIRE ALARM FLOOR CAT AND OTHER ANIMALS BUILDING- ROOF PLAN ADOPTION DOG BUILDING 1FIRE ALARM FLOOR PLAN CAT AND OTHER ANIMALS BUILDING-EXTERIOR ELEVATIONS ADOPTION DOG BUILDING 2FIRE ALARM FLOOR PLAN CAT AND OTHER ANIMALS ADOPTION DOG BUILDING 3FIRE ALARM FLOOR PLAN **DING-BUILDING** STRAY DOG BUILDINGFIRE ALARM FLOOR PLAN CAT AND OTHER ANIMALS BUILDING- WALL SECTIONS SUPPORT BUILDINGFIRE ALARM FLOOR PLAN ADOPTION DOG BUILDINGS E, F, AND G-FLOOR PLAN ADOPTION DOG BUILDINGS E, F, AND G- REFLECTED MECHANICAL MECHANICAL COVERSHEET ION DOG BUILDINGS E, F, AND G- ROOF PLAN SCHEDULES ADORTION DOG BUILDINGS E. F. AND G- EXTERIOR MECHANICAL SITE PLAN

TRAY DOG BUILDING- FLOOR PLAN STRAY DOG BUILDING- REFLECTED CEILING PLAN STRAY DOG BUILDING- ROOF PLAN STRAY DOG BUILDING- EXTERIOR ELEVATIONS STRAY DOG BUILDING-BUILDING SECTIONS AH 303 STRAY DOG BUILDING- WALL SECTIONS SUPPORT BUILDING- FLOOR PLAN SUPPORT BUILDING- REFLECTED CEILING PLAN SUPPORT BUILDING- ROOF PLAN SUPPORT BUILDING- EXTERIOR ELEVATIONS SUPPORT BUILDING-BUILDING SECTIONS SUPPORT BUILDING- WALL SECTIONS ELECTRICAL ELECTRICAL COVERSHEET SINGLE LINE DIAGRAM

ION DOG BUILDINGS E, F, AND G-BUILDING

TION DOG BUILDINGS E, F, AND G- WALL

AS 102

AA102

AA 103

IAA 301

AA 303

SINGLE LINE DIAGRAM LUMINAIRE SCHEDULE ELECTRICAL SCHEDULES ELECTRICAL SCHEDULES ELECTRICAL SCHEDULES DISTRIBUTION SCHEDULES POWER SITE PLAN LIGHTING SITE PLAN ADMINISTRATION BUILDING LIGHTING FIRST FLOOR EA 102 ADMINISTRATION BUILDING LIGHTING SECOND FLOOR ADMINISTRATION BUILDING POWER FIRST FLOOR PLAN ADMINISTRATION BUILDING POWERL SECOND FLOOR ADMINISTRATION BUILDING POWER ROOF PLAN MEDICAL CLINIC LIGHTING FLOOR PLAN MEDICAL CLINIC POWER FLOOR PLAN MEDICAL CLINIC POWER ROOF PLAN

CAT & OTHER ANIMALS BUILDING LIGHTING FLOOR PLAN CAT & OTHER ANIMALS BUILDING POWER FLOOR PLAN ED 202 CAT & OTHER ANIMALS BUILDING POWER ROOF PLAN ADOPTION DOG BUILDING 1 LIGHTING FLOOR PLAN ADOPTION DOG BUILDING 1 POWER FLOOR PLAN ADOPTION DOG BUILDING 1 POWER ROOF PLAN ADOPTION DOG BUILDING 2 LIGHTING FLOOR PLAN EF 201 ADOPTION DOG BUILDING 2 POWER FLOOR PLAN EF 202 ADOPTION DOG BUILDING 2 POWER ROOF PLAN EG 101 ADOPTION DOG BUILDING 3 LIGHTING FLOOR PLAN ADOPTION DOG BUILDING 3 POWER FLOOR PLAN EG 201

EG 202 ADOPTION DOG BUILDING 3 POWER ROOF PLAN STRAY DOG BUILDING LIGHTING FLOOR PLAN IEH 201 STRAY DOG BUILDING POWER FLOOR PLAN EH 202 STRAY DOG BUILDING POWER ROOF PLAN EI 101 SUPPORT BUILDING LIGHTING FLOOR PLAN SUPPORT BUILDING POWER FLOOR PLAN SUPPORT BUILDING POWER ROOF PLAN E 300 DETAILS

ADMINISTRATION BUILDING MECHANICAL FIRST FLOOR ADMINISTRATION BUILDING MECHANICAL SECOND ADMINISTRATION BUILDING MECHANICAL ROOF PLAN MEDICAL CLINIC MECHANICAL FLOOR PLAN MEDICAL CLINIC MECHANICAL ROOF PLAN CAT & OTHER ANIMALS BUILDING MECHANICAL FLOOR ADOPTION DOG BUILDING 1 MECHANICAL FLOOR PLAN ADOPTION DOG BUILDING 1 MECHANICAL ROOF PLAN ADOPTION DOG BUILDING 2 MECHANICAL FLOOR PLAN ADOPTION DOG BUILDING 2 MECHANICAL ROOF PLAN ADOPTION DOG BUILDING 3 MECHANICAL FLOOR PLAN ADOPTION DOG BUILDING 3 MECHANICAL ROOF PLAN STRAY DOG BUILDING MECHANICAL FLOOR PLAN STRAY DOG BUILDING MECHANICAL ROOF PLAN SUPPORT BUILDING MECHANICAL FLOOR PLAN MECHANICAL DETAILS **PLUMBING** PLUMBING COVERSHEET **SCHEDULES CALCULATIONS** PLUMBING SITE PLAN ADMINISTRATION BUILDING PLUMBING UNDERFLOOR ADMINISTRATION BUILDING PLUMBING FIRST FLOOR ADMINISTRATION BUILDING PLUMBING SECOND FLOOR ADMINISTRATION BUILDING PLUMBING ROOF PLAN MEDICAL CLINIC PLUMBING UNDERFLOOR PLANV MEDICAL CLINIC PLUMBING FLOOR PLANV MEDICAL CLINIC PLUMBING ROOF PLAN CAT & OTHER ANIMALS BUILDING PLUMBING JNDERFLOOR PLAN CAT & OTHER ANIMALS BUILDING PLUMBING FLOOR CAT & OTHER ANIMALS BUILDING PLUMBING ROOF PLAN TA 102 ADOPTION DOG BUILDING 1 PLUMBING UNDERFLOOR ADOPTION DOG BUILDING 1 PLUMBING FLOOR PLAN ADOPTION DOG BUILDING 1 PLUMBING ROOF PLAN ADOPTION DOG BUILDING 2 PLUMBING UNDERFLOOR ADOPTION DOG BUILDING 2 PLUMBING FLOOR PLAN ADOPTION DOG BUILDING 2 PLUMBING ROOF PLAN ADOPTION DOG BUILDING 3 PLUMBING UNDERFLOOR ADOPTION DOG BUILDING 3 PLUMBING FLOOR PLAN

ANIMAL EQUIPMENT PLAN- ADOPTION DOG BUILDINGS ADMINISTRATION BUILDING FIRE ALARM FIRST FLOOR

ADOPTION DOG BUILDING 3 PLUMBING ROOF PLAN STRAY DOG BUILDING PLUMBING UNDERFLOOR PLAN STRAY DOG BUILDING PLUMBING FLOOR PLAN STRAY DOG BUILDING PLUMBING ROOF PLAN SUPPORT BUILDING PLUMBING UNDERFLOOR PLAN SUPPORT BUILDING PLUMBING FLOOR PLAN SUPPORT BUILDING PLUMBING ROOF PLAN

PLUMBING DETAILS

P 300

PLUMBING ENLARGED PLANS PLUMBING ENLARGED PLANS **PROJECT OWNER:**

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CONTACT: Peter Sophoclis (909) 942-5553 Peter.F.Sophpclis@imegcorp.com

LANDSCAPE ARCHITECT:

STB LANDSCAPE ARCHITECTS, INC. 15 SOUTH 5TH STREET REDLANDS, CA 92373 SHAWN BURCH 909-798-7490 909-307-8235 shawn@stblandarch.com

DIRECTORY

GENERAL NOTES GENERAL NOTES ADMINISTRATION BUILDING FOUNDATION PLAN ADMINISTRATION BUILDING STRUCTURAL SECOND FLOOR FRAMING PLAN ADMINISTRATION BUILDING STRUCTURAL ROOF PLAN MEDICAL CLINIC STRUCTURAL FLOOR PLAN MEDICAL CLINIC STRUCTURAL ROOF PLAN CAT & OTHER ANIMALS BUILDING STRUCTURAL FLOOR CAT & OTHER ANIMALS BUILDING STRUCTURAL ROOF

ADOPTION DOG BUILDING 1 FOUNDATION PLAN ADOPTION DOG BUILDING 1 STRUCTURAL ROOF PLAN ADOPTION DOG BUILDING 2 STRUCTURAL FLOOR PLAN ADOPTION DOG BUILDING 2 STRUCTURAL ROOF PLAN ADOPTION DOG BUILDING 3 STRUCTURAL FLOOR PLAN ADOPTION DOG BUILDING 3 STRUCTURAL ROOF PLAN STRAY DOG BUILDING STRUCTURAL FLOOR PLAN STRAY DOG BUILDING STRUCTURAL ROOF PLAN

SUPPORT BUILDING STRUCTURAL ROOF PLAN SS 201 SITE PLAN **TECHNOLOGY** TECHNOLOGY COVERSHEET 101 TECHNOLOGY SITE PLAN ADMINISTRATION BUILDING TECHNOLOGY FIRST FLOOR

ADMINISTRATION BUILDING TECHNOLOGY SECOND ADMINISTRATION BUILDING TECHNOLOGY ENLARGED

SUPPORT BUILDING STRUCTURAL FLOOR PLAN

MEDICAL CLINIC TECHNOLOGY FLOOR PLAN

CAT & OTHER ANIMALS BUILDING TECHNOLOGY FLOOR ADOPTION DOG BUILDING 1 TECHNOLOGY FLOOR PLAN ADOPTION DOG BUILDING 2 TECHNOLOGY FLOOR PLAN ADOPTION DOG BUILDING 3 TECHNOLOGY FLOOR PLAN STRAY DOG BUILDING TECHNOLOGY FLOOR PLAN SUPPORT BUILDING TECHNOLOGY FLOOR PLAN

200 TOTAL: 184

STANDARD NOTES

sheet name

TITLE SHEET

sheet number

LOCATION MAP


SHEET INDEX

EI 201

architecture interiors planning




1177 Idaho Street, Suite 200 Redlands, CA 92374 Phone: 909-335-7400 Fax: 909-335-7299 info@miller-aip.com

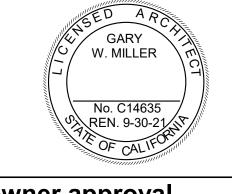

owner approval initials | date revisions/addenda

project information Project Number: 1227 Drawn By: Checked By: 05/08/23 Issue Date:

G001

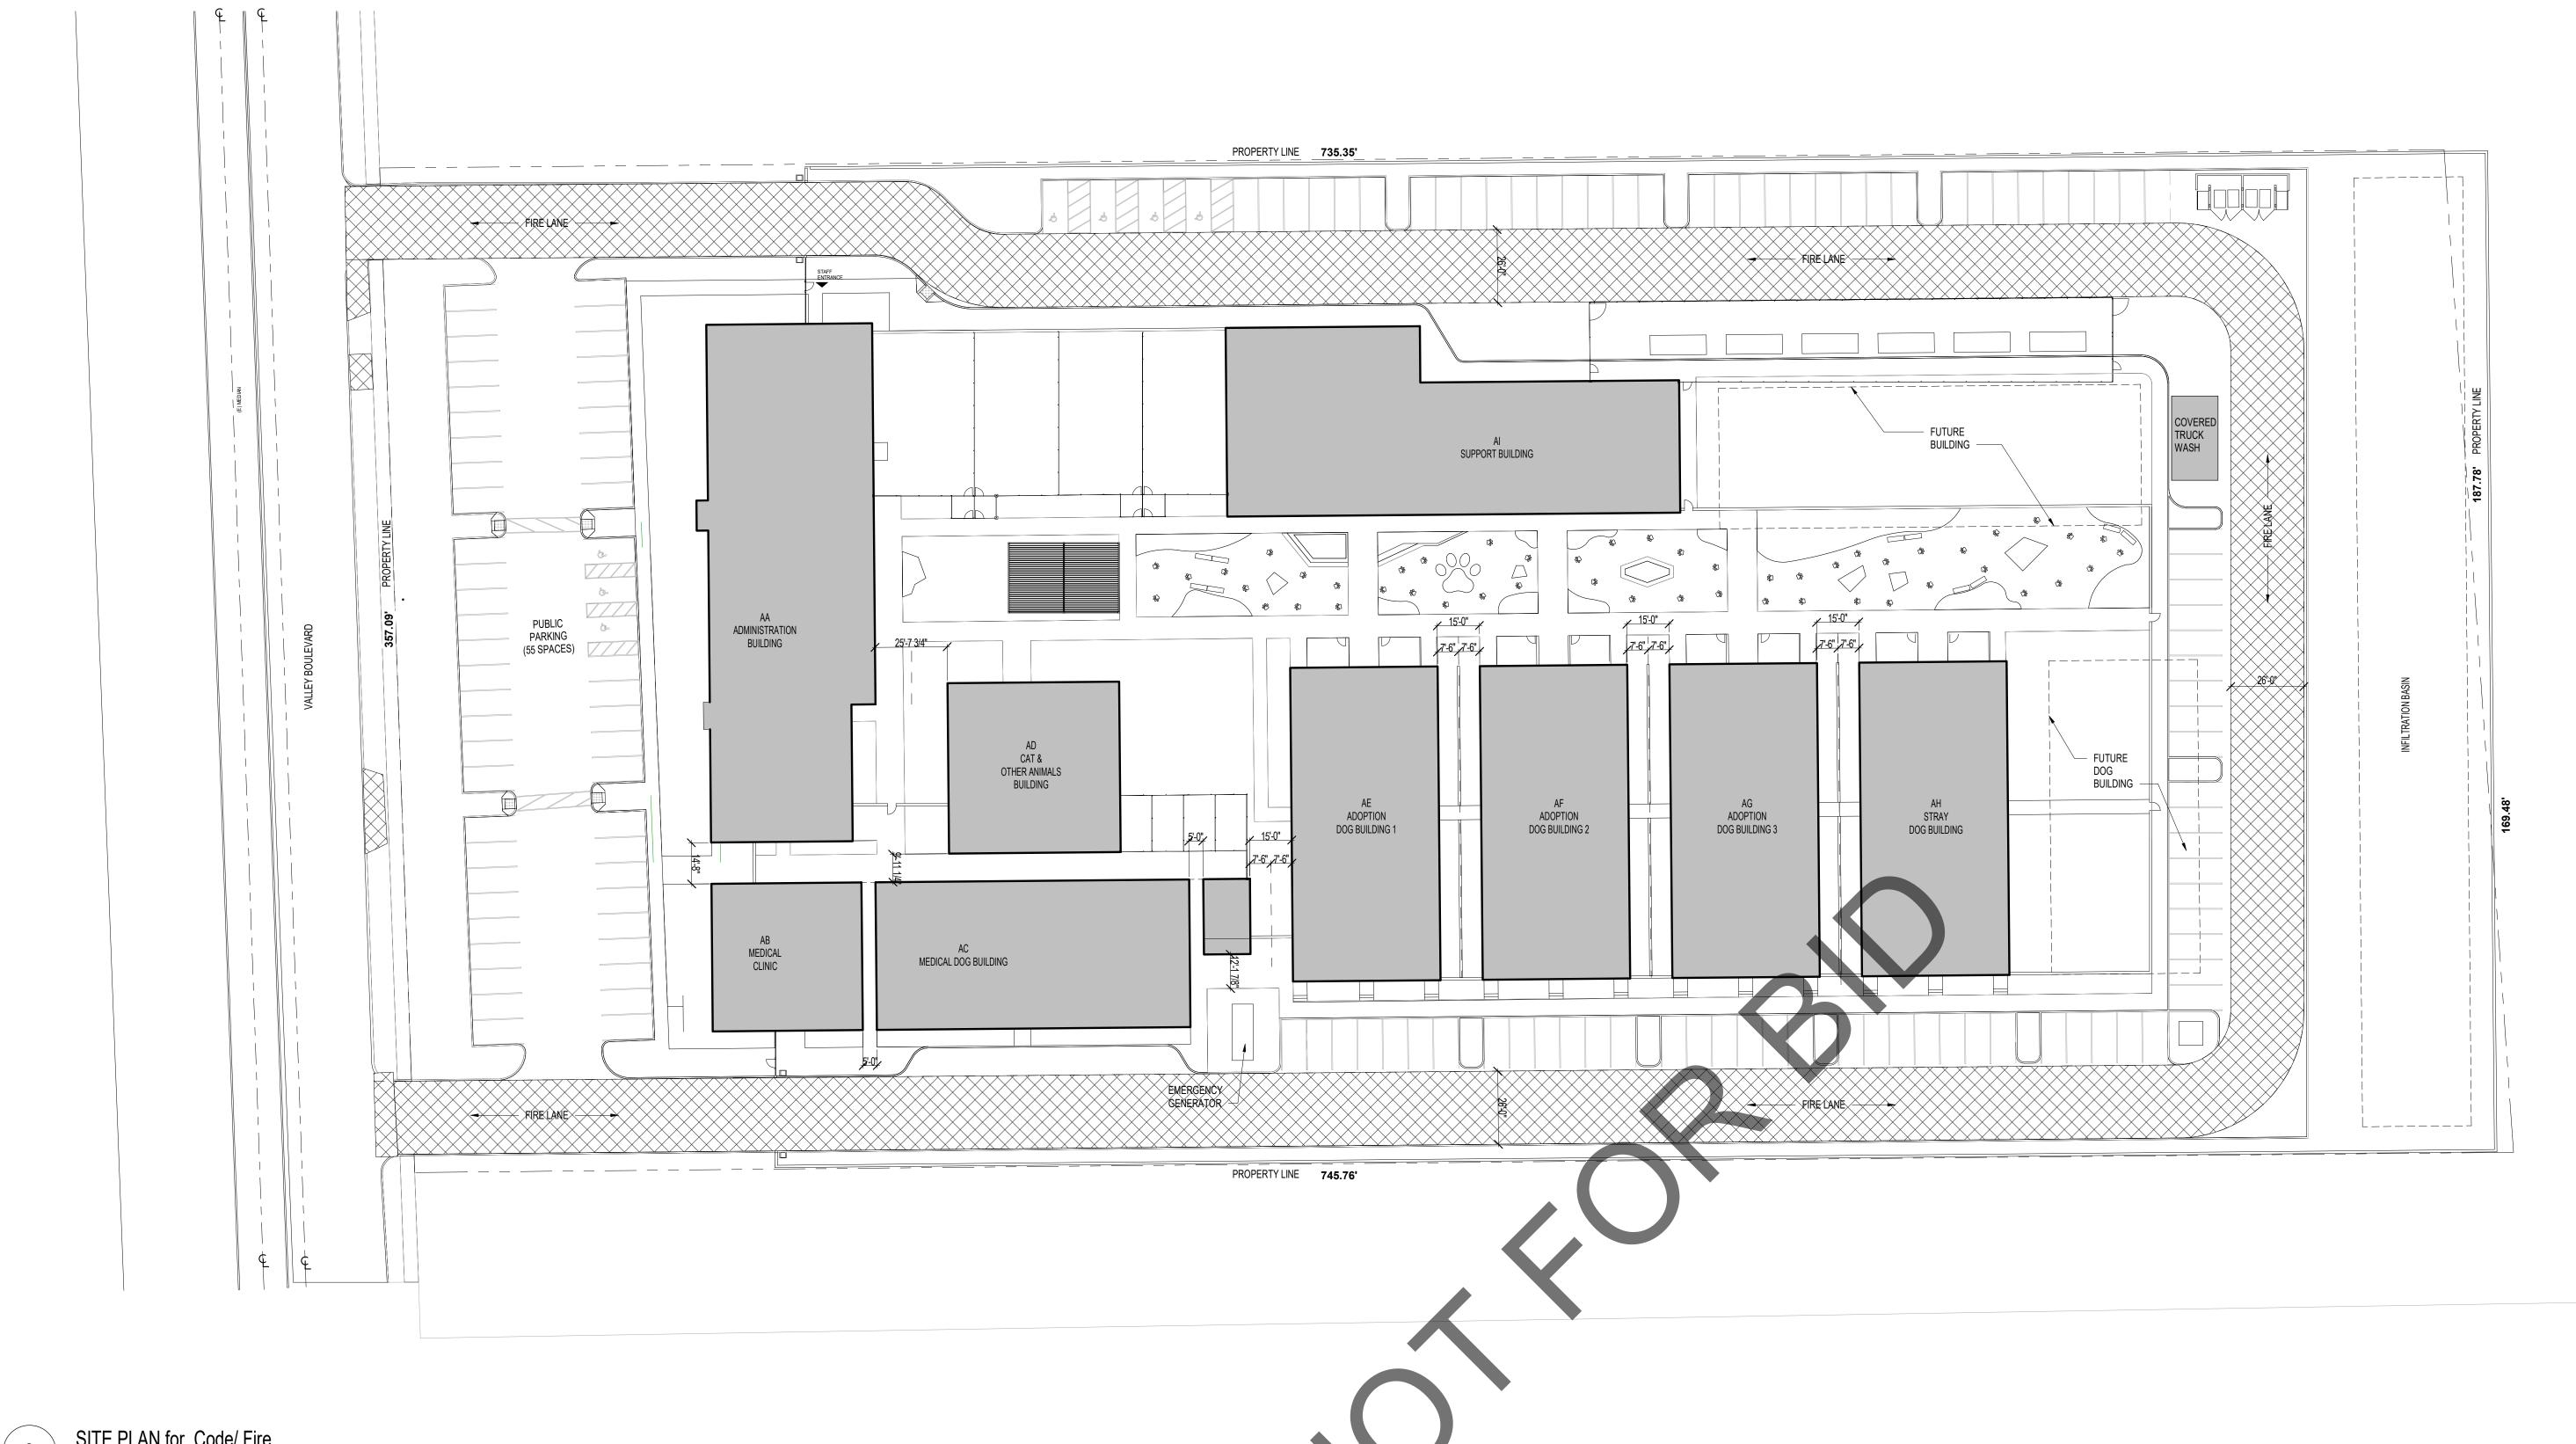

2 SITE PLAN for Code/ Fire
1" = 30'-0"


BUILD. NO.	NAME	OCC.	CONST.	SPRINK.	STORIES	STORIES	HEIGHT	HEIGHT	SF	FRONTAGE	SF	MIXED OCCUPANCY	AREA/ OCC. SEP.	RESI	T. WAI STANC	CE RA	TING	
	INAIVIL	<u> </u>	TYPE		ALLOWED	ACTUAL	ALLOWED	ACTUAL	ALLOWED	FACTOR	ACTUAL	CALC.	SEP.	N	S	E	W	
AA	ADMINISTRATION- 1ST FLOOR	В	III B	Y, PER 903.3.1.1	(S) 4	2	(S) 75'	30'	(SM) 57,000	NA	10,483	NA	NA			0	1	
	ADMINISTRATION- 2ND FLOOR								(SM) 57,000	NA	4,343	NA	NA	4	U	U	1	
AB	MEDICAL CLINIC	В	VB	Y, PER 903.3.1.1	(S) 3	1	(S) 60'	22'- 4 7/8"	(S1) 36,000	NA	2,797	NA	NA	0	1	1	0	
AC	DOG CLINIC	В	III B	Y, PER 903.3.1.1	(S) 4	1	(S) 75'	20'-1/2"	(S1) 76,000	NA	5,845	NA	NA	1	1	1	0	
	EUTHANASIA	В	VB	Y, PER 903.3.1.1	(S) 3	1	(S) 60'	15'- 6 1/8"	(S1) 36,000	NA	444	NA	NA	1	1	0	0	L
AD	CAT AND OTHER ANIMALS	В	VB	Y, PER 903.3.1.1	(S) 3	1	(S) 60'	20'- 2 1/2"	(S1) 36,000	NA	3,690	NA	NA	0	0	0	1	Ц
AE	ADOPTION DOG	В	III B	Y, PER 903.3.1.1	(S) 4	1	(S) 75'	20'- 2 1/2"	(S1) 76,000	NA	6,159	NA	NA	1	1	0	0	
AF	ADOPTION DOG	В	III B	Y, PER 903.3.1.1	(S) 4	1	(S) 75'	20'- 2 1/2"	(S1) 76,000	NA	6,159	NA	NA	1	1	0	0	
AG	ADOPTION DOG	В	III B	Y, PER 903.3.1.1	(S) 4	1	(S) 75'	20'- 2 1/2"	(S1) 76,000	NA	6,159	NA	NA	1	1	0	0	
AH AH	STRAY DOG	В	III B	Y, PER 903.3.1.1	(S) 4	1	(S) 75'	20'- 2 1/2"	(S1) 76,000	NA	6,159	NA	NA	1	0	0	0	
entral File spena	SUPPORT- ANIMAL SERVICES	В	V/D	V DED 002 2 1 1	(S) 3	1	(S) 60'	24'- 3 7/16"	(S1) 36,000	NA	4,612	4,612/ 36,000 = .13 + = .21 < 1, OK 4,284/ 54,000 = .08	1-HOUR	0		0		pr o
	SUPPORT- STORAGE	S-2*	VB	Y, PER 903.3.1.1					(S1) 54,000	NA	4,284				U	U	U	O Proj Dra



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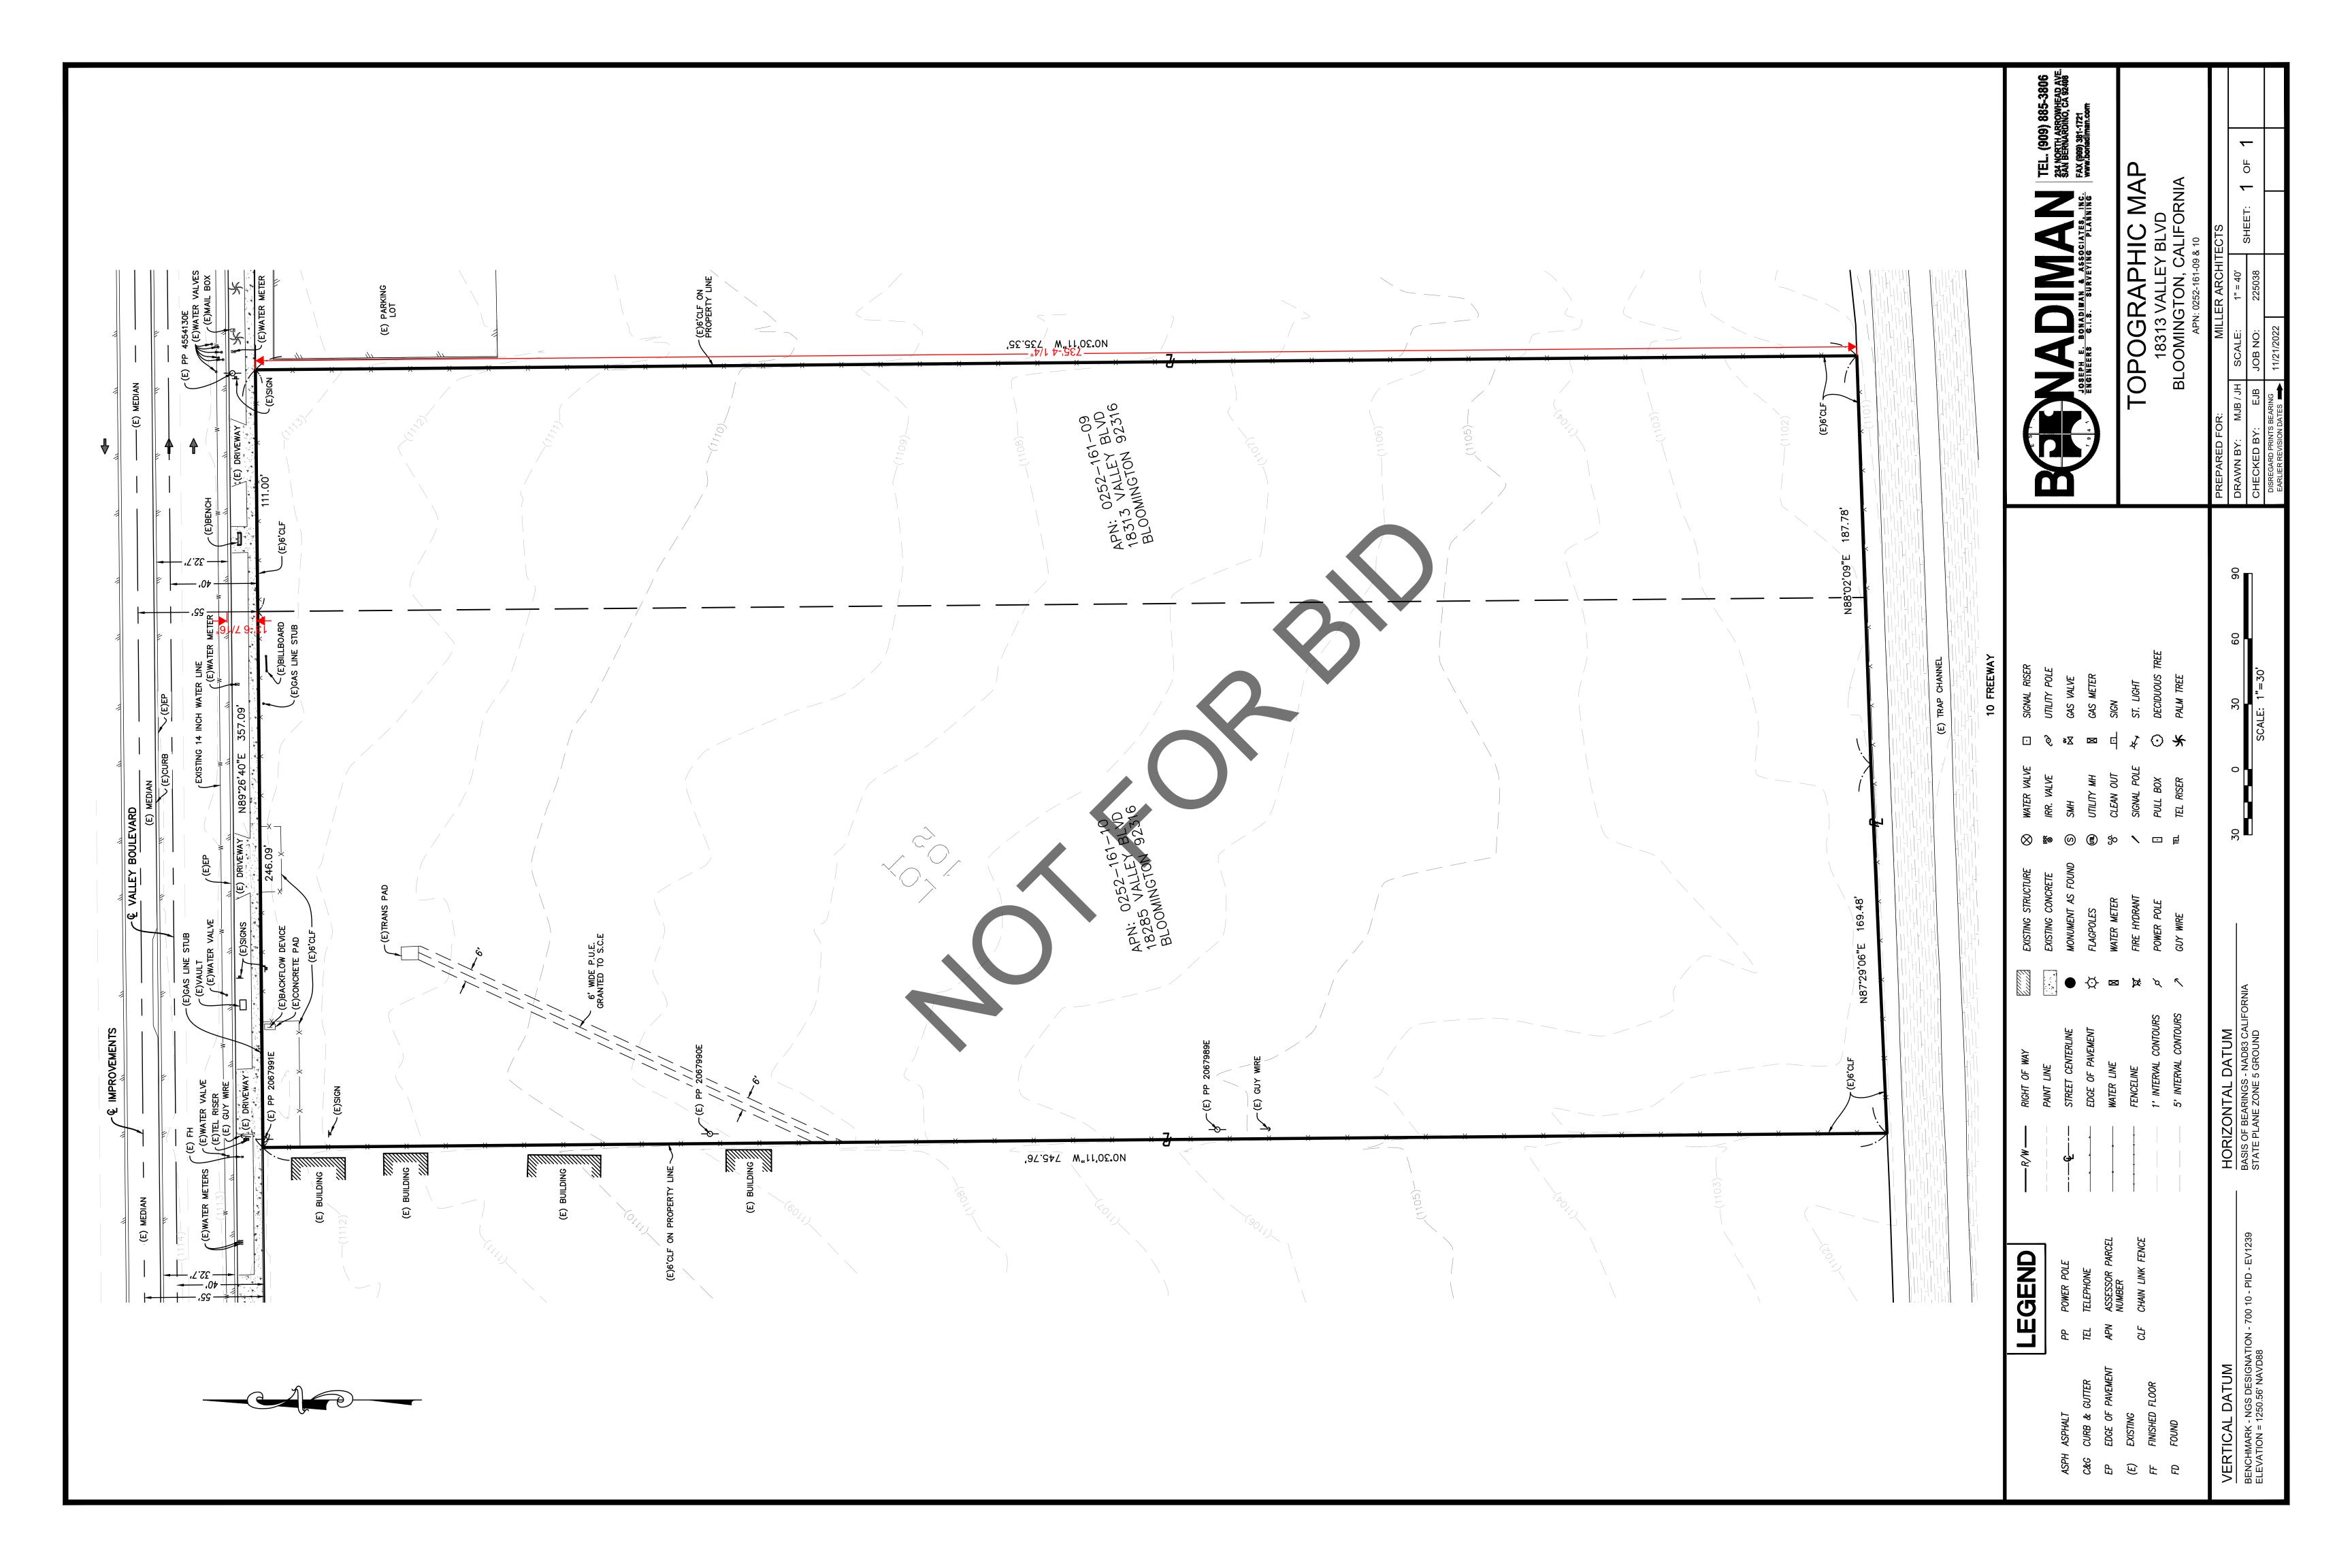
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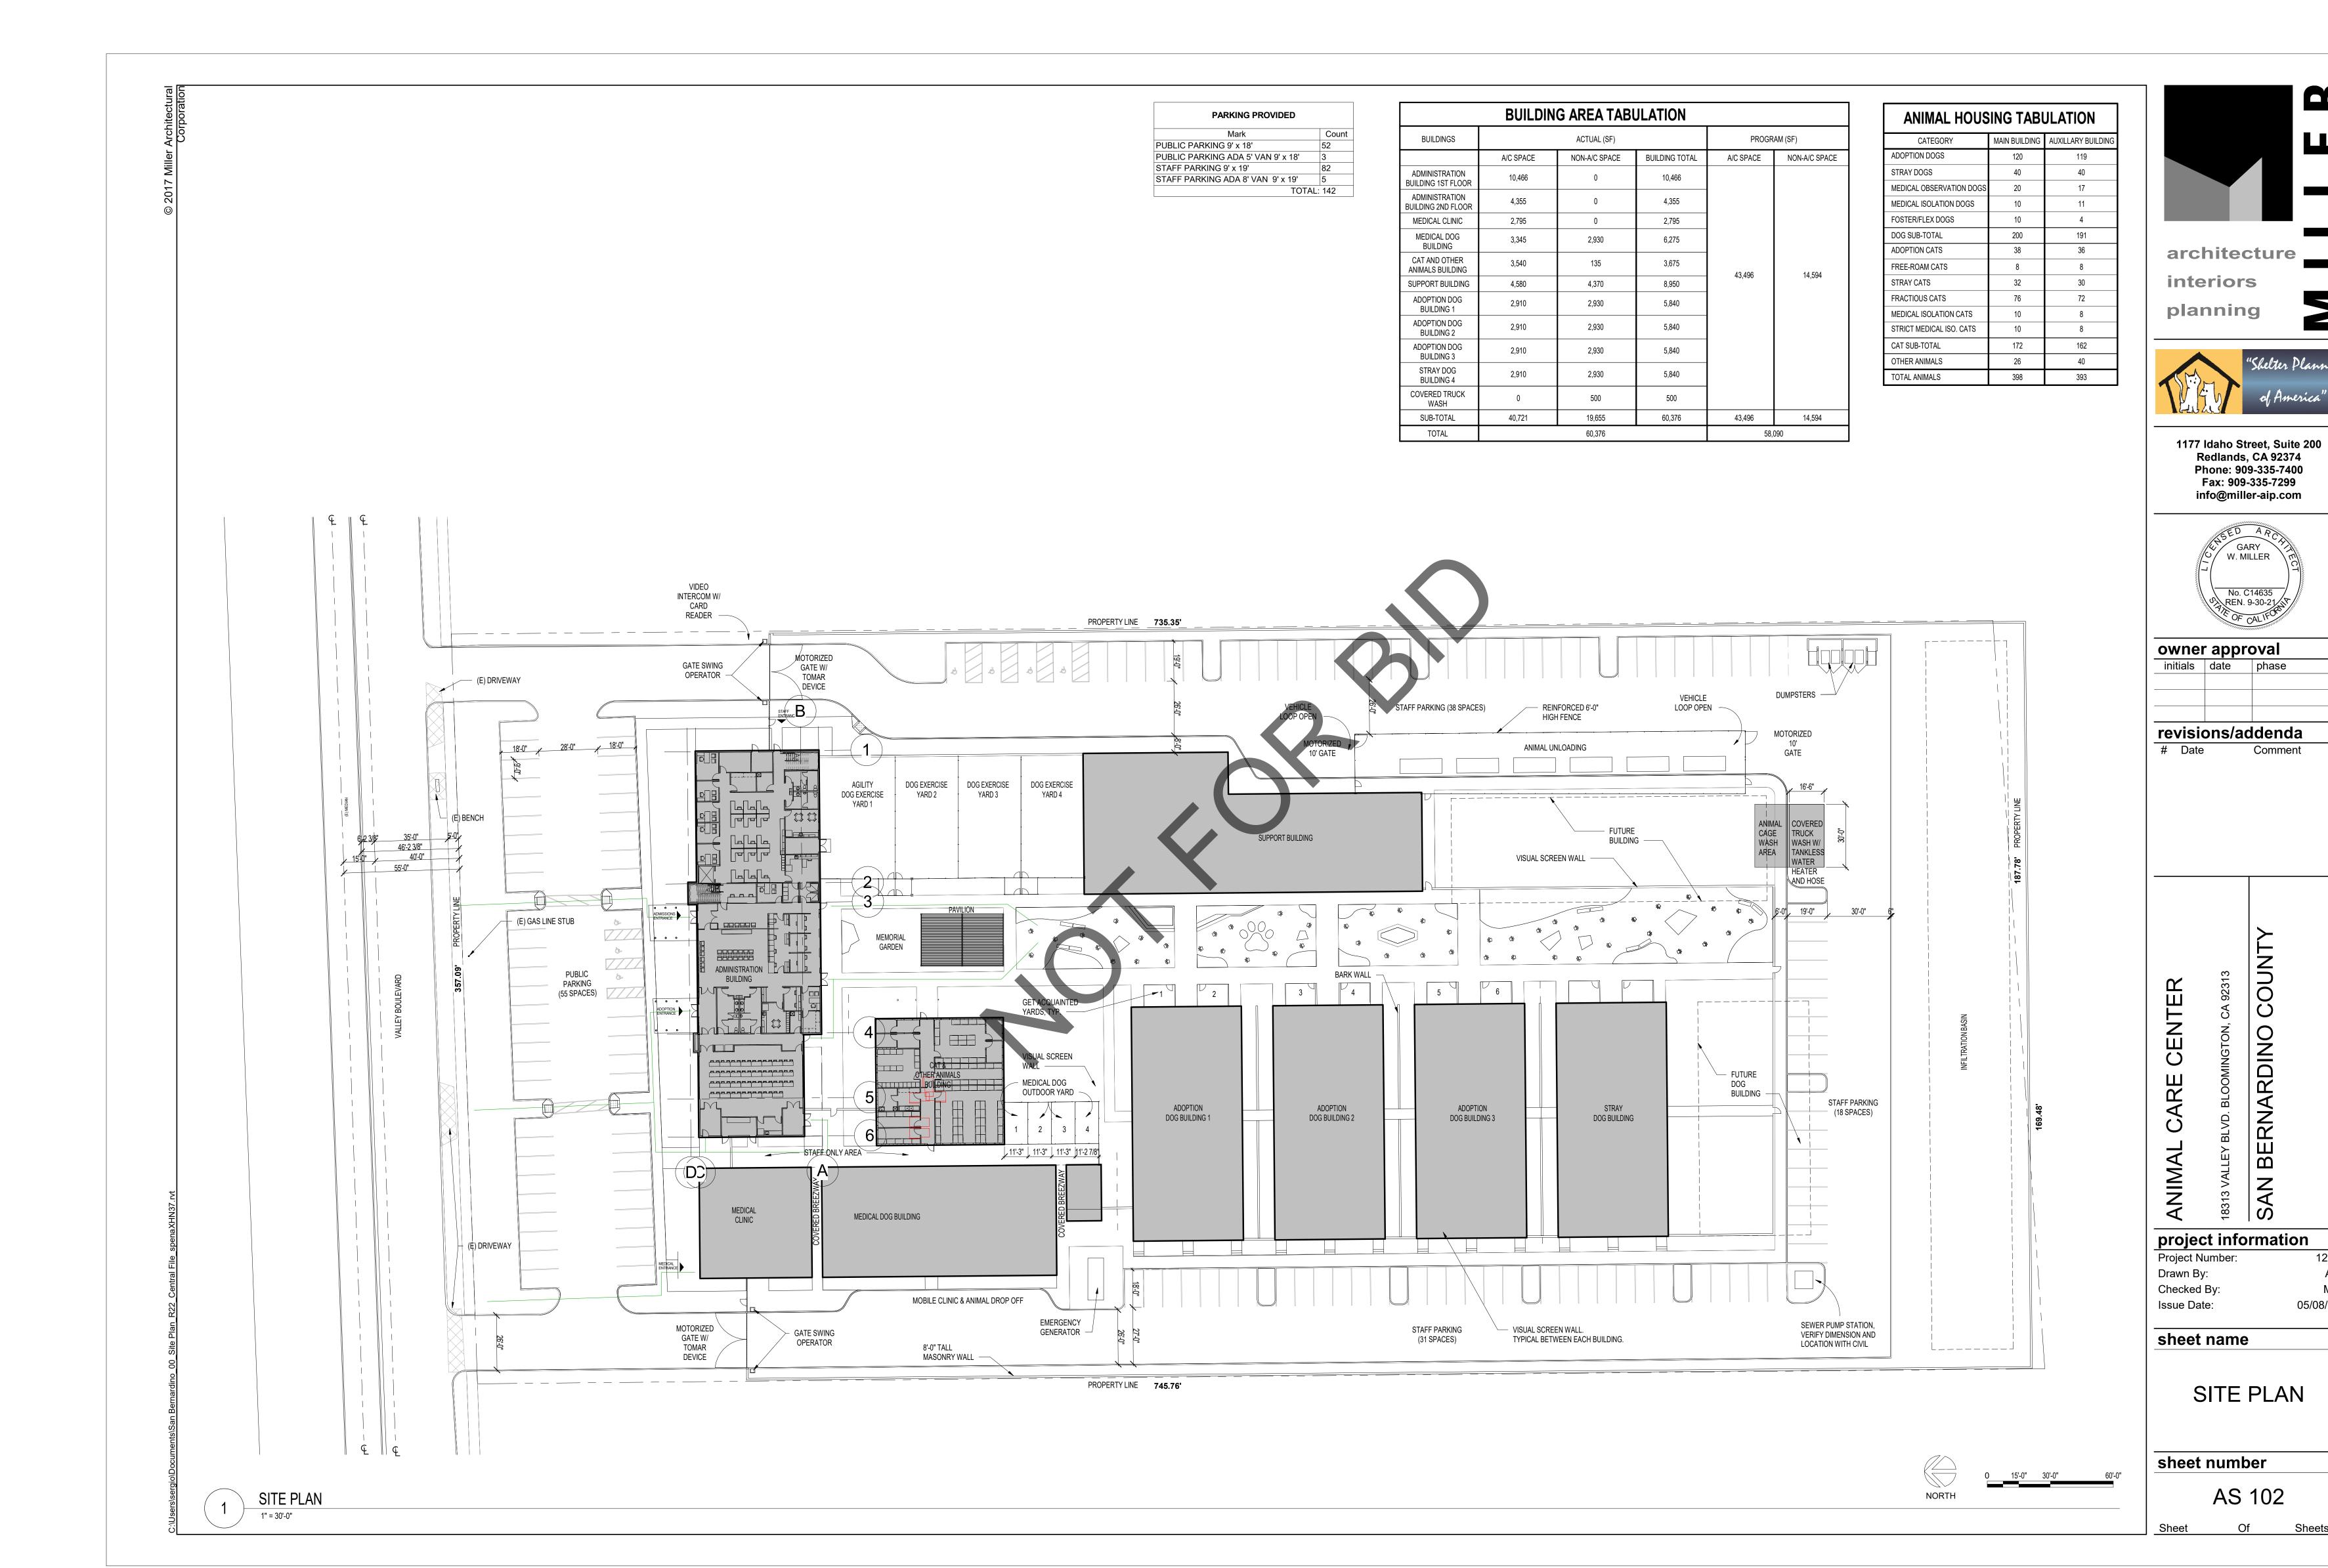
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sheet name

CODE ANALYSIS

sheet number G002

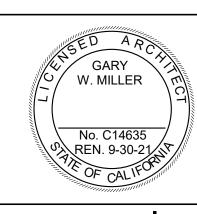




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project information

Project Number: Drawn By: Checked By: Issue Date:

sheet name

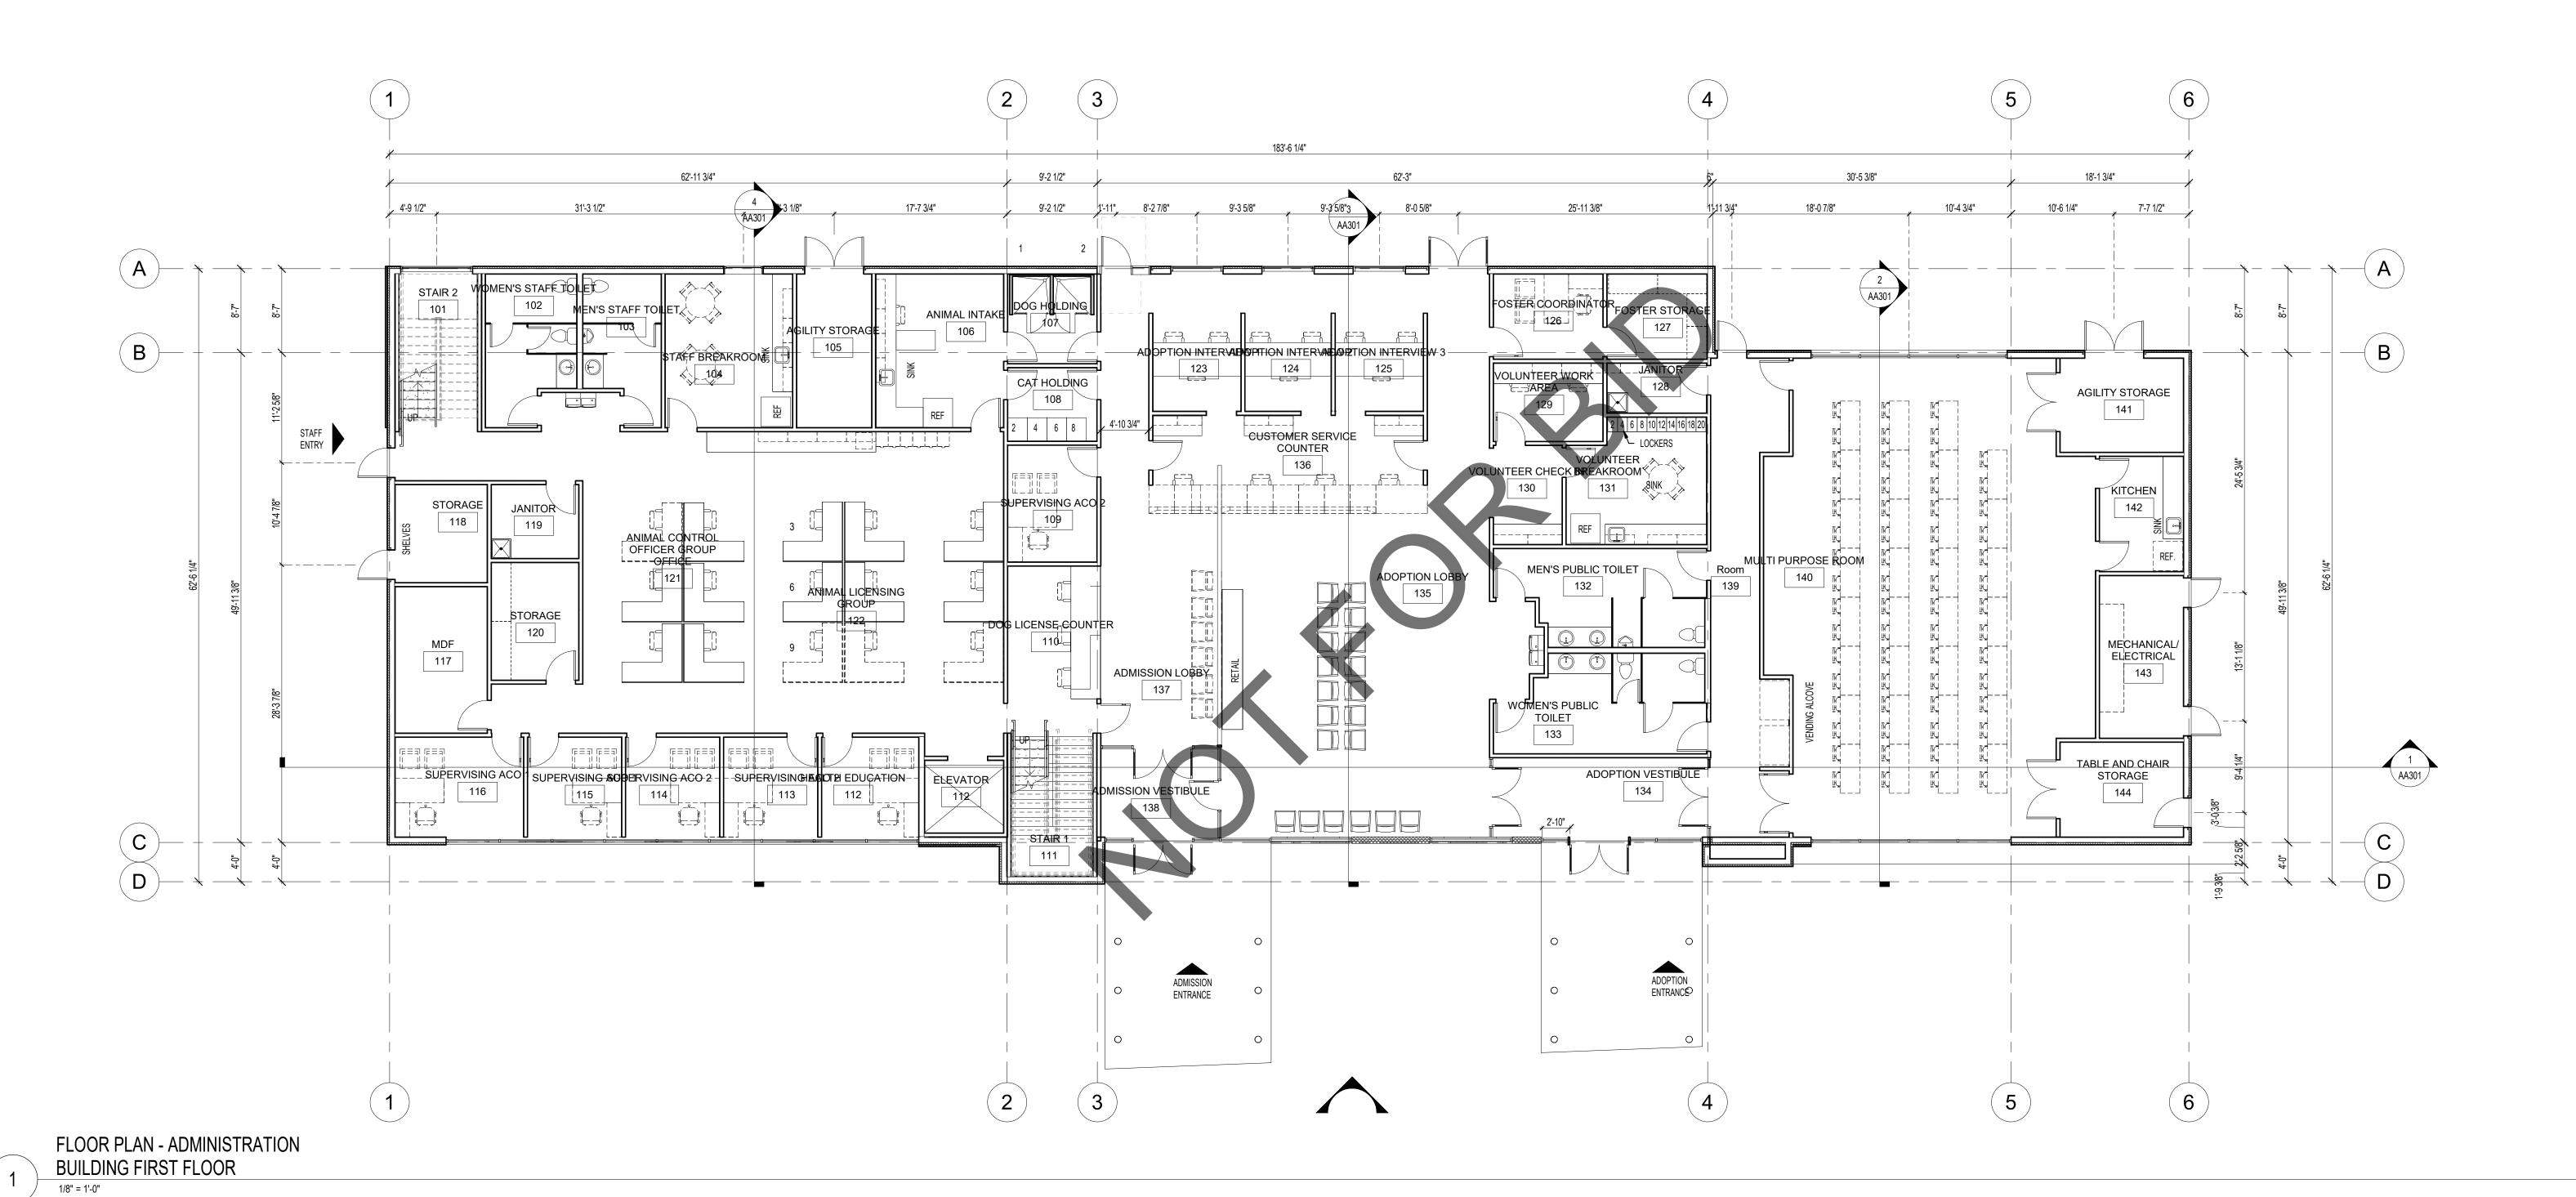ADMIN FIRST FLOOR PLAN

1227


Author

03/22/23

sheet number

AA101

Of Sheets

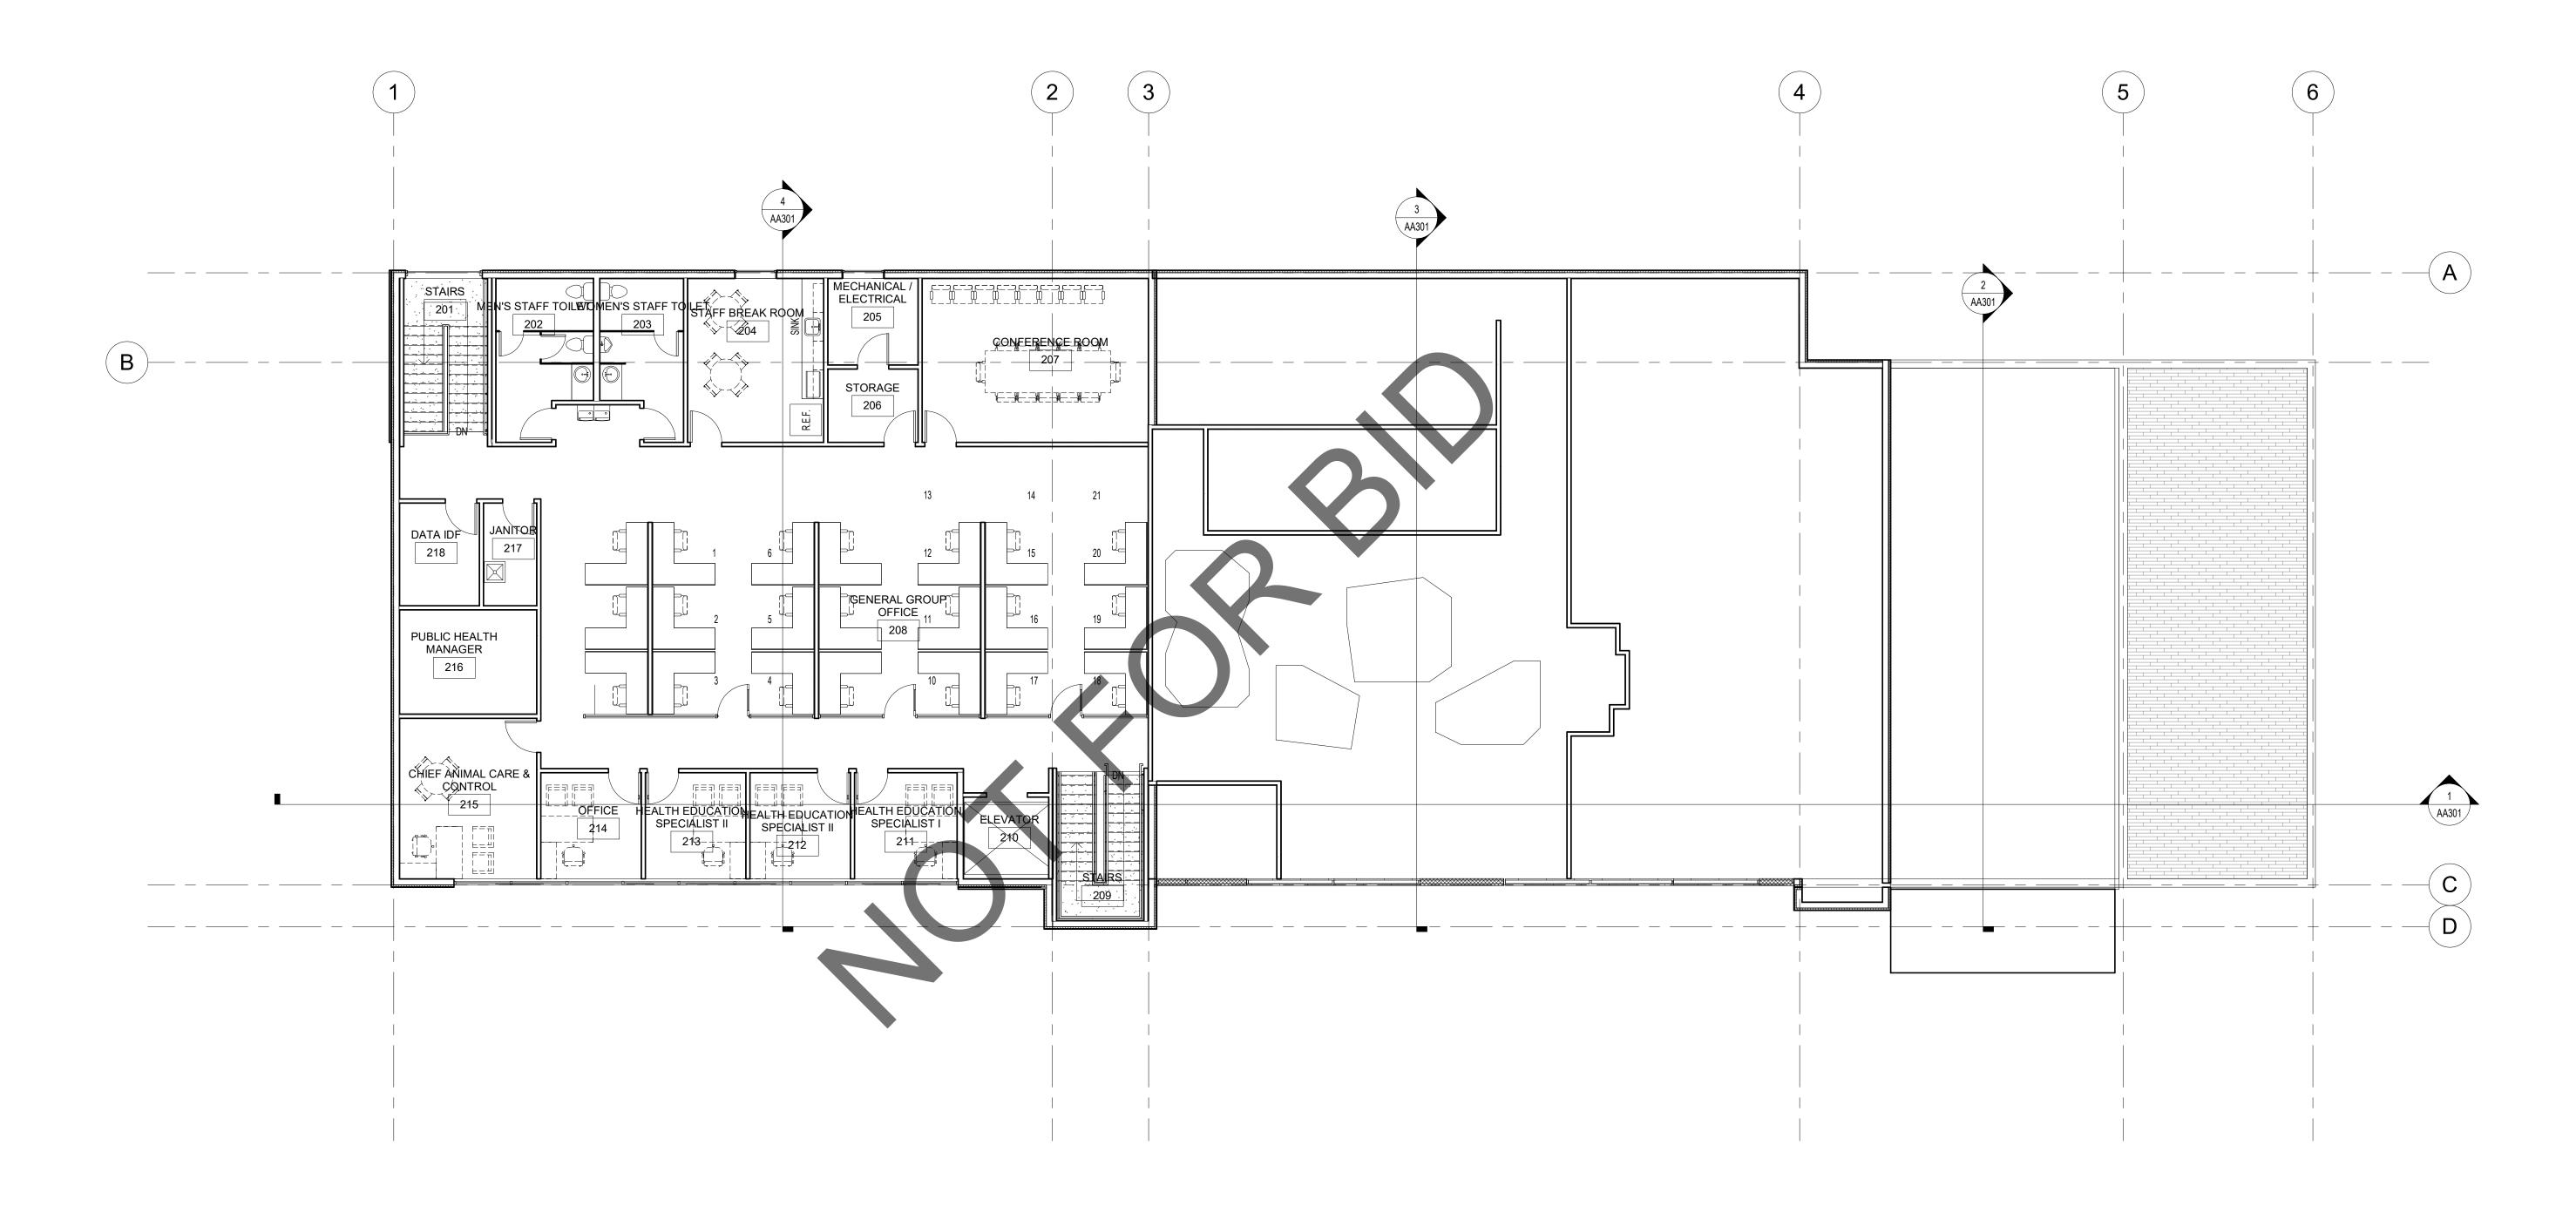


FLOOR PLAN - ADMINISTRATION BUILDING SECOND FLOOR

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planning

interiors

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revisions/addenda # Date

ANIMAL

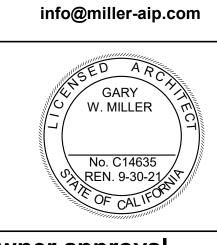project information

Project Number:
Drawn By:
Checked By: Issue Date:

sheet name

ADMIN SECOND FLOOR PLAN

Author

03/22/23

sheet number


AA102



interiors planning



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sheet name

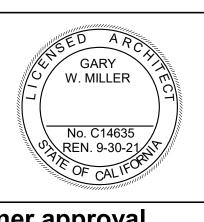ADMIN FIRST FLOOR RCP

1227

Author

03/22/23

sheet number

AA103


LEVEL 1 RCP



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project information

Project Number: Drawn By: Checked By:


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ADMIN SECOND FLOOR RCP

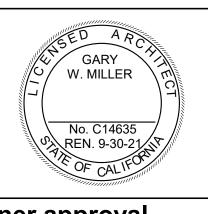sheet number

AA104



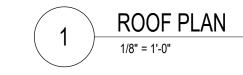


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nitials date phase

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Date Comment

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▼ ≅ ທ່ project information

Project Number:
Drawn By:
Checked By:

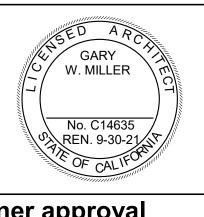Checked By: MB
Issue Date: 03/22/23

Author


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ADMIN BUILDING ROOF PLAN

sheet number

AA105

Sheet Of Sheet

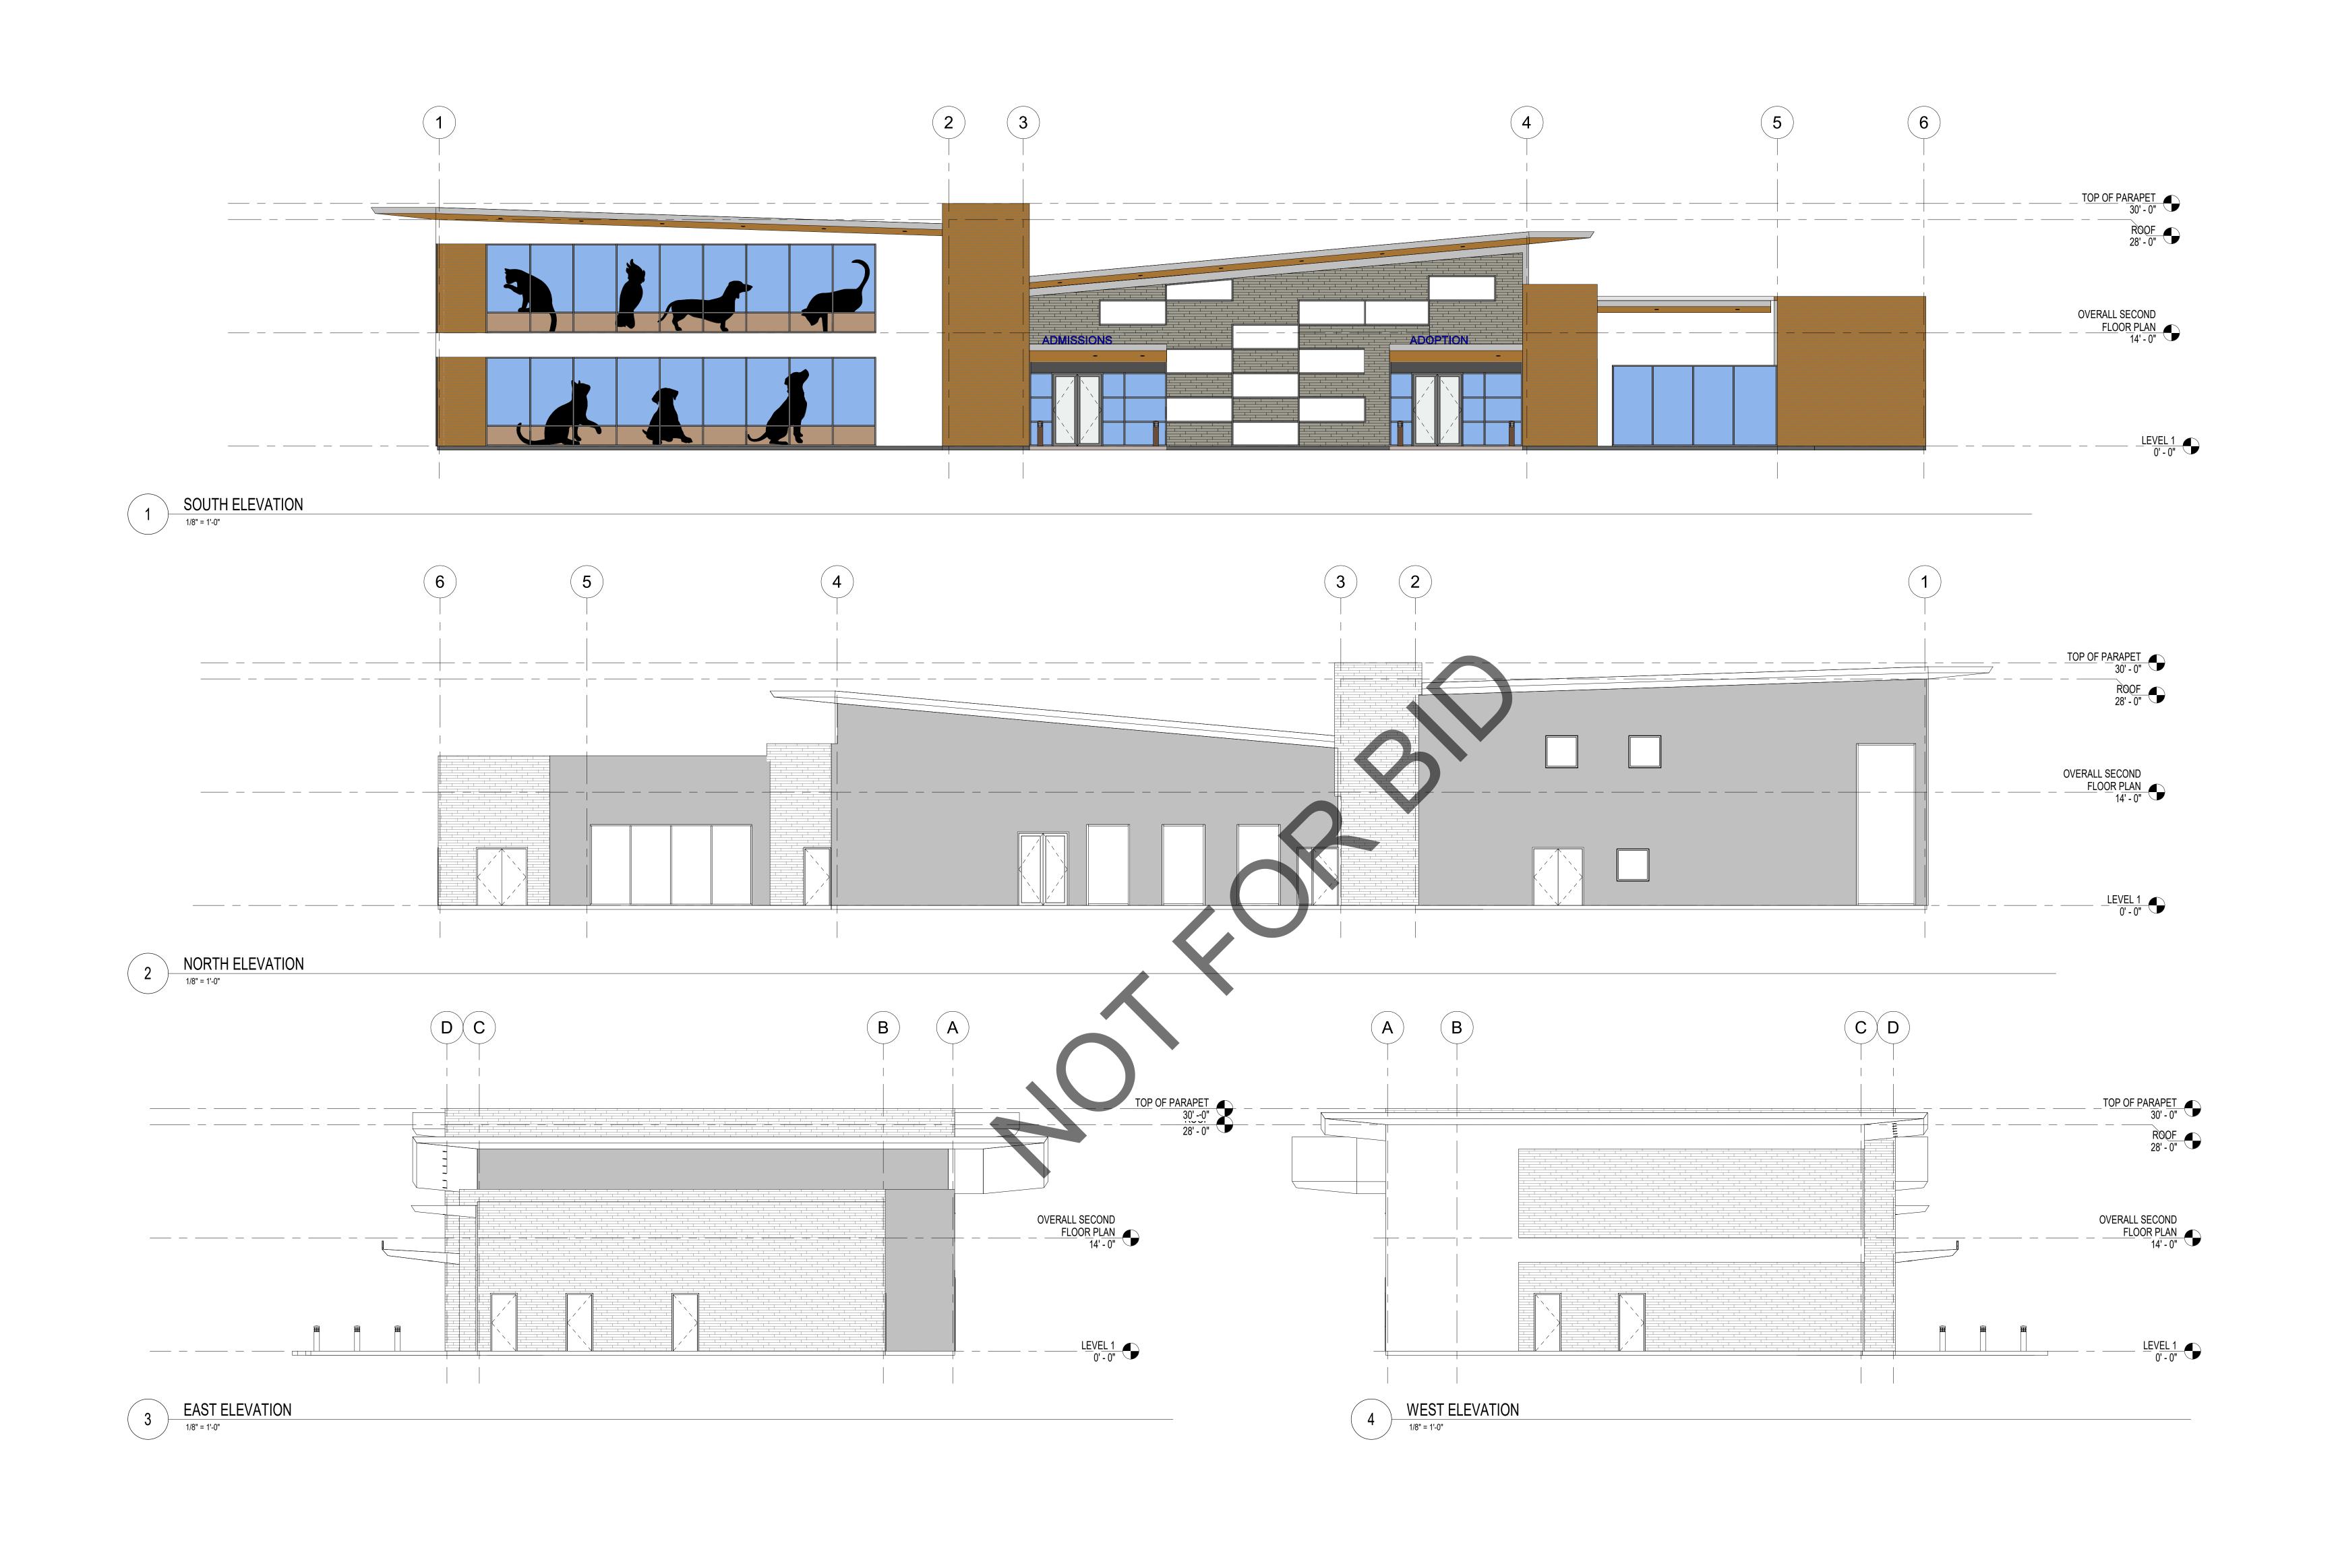


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Date

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project information Project Number: Drawn By: Author

Checked By: Issue Date:

sheet name

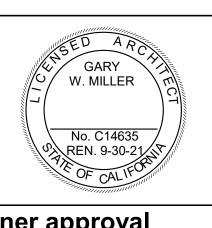
ADMIN BUILDING EXT. **ELEVATIONS**

03/22/23

sheet number


AA201

Of Sheets

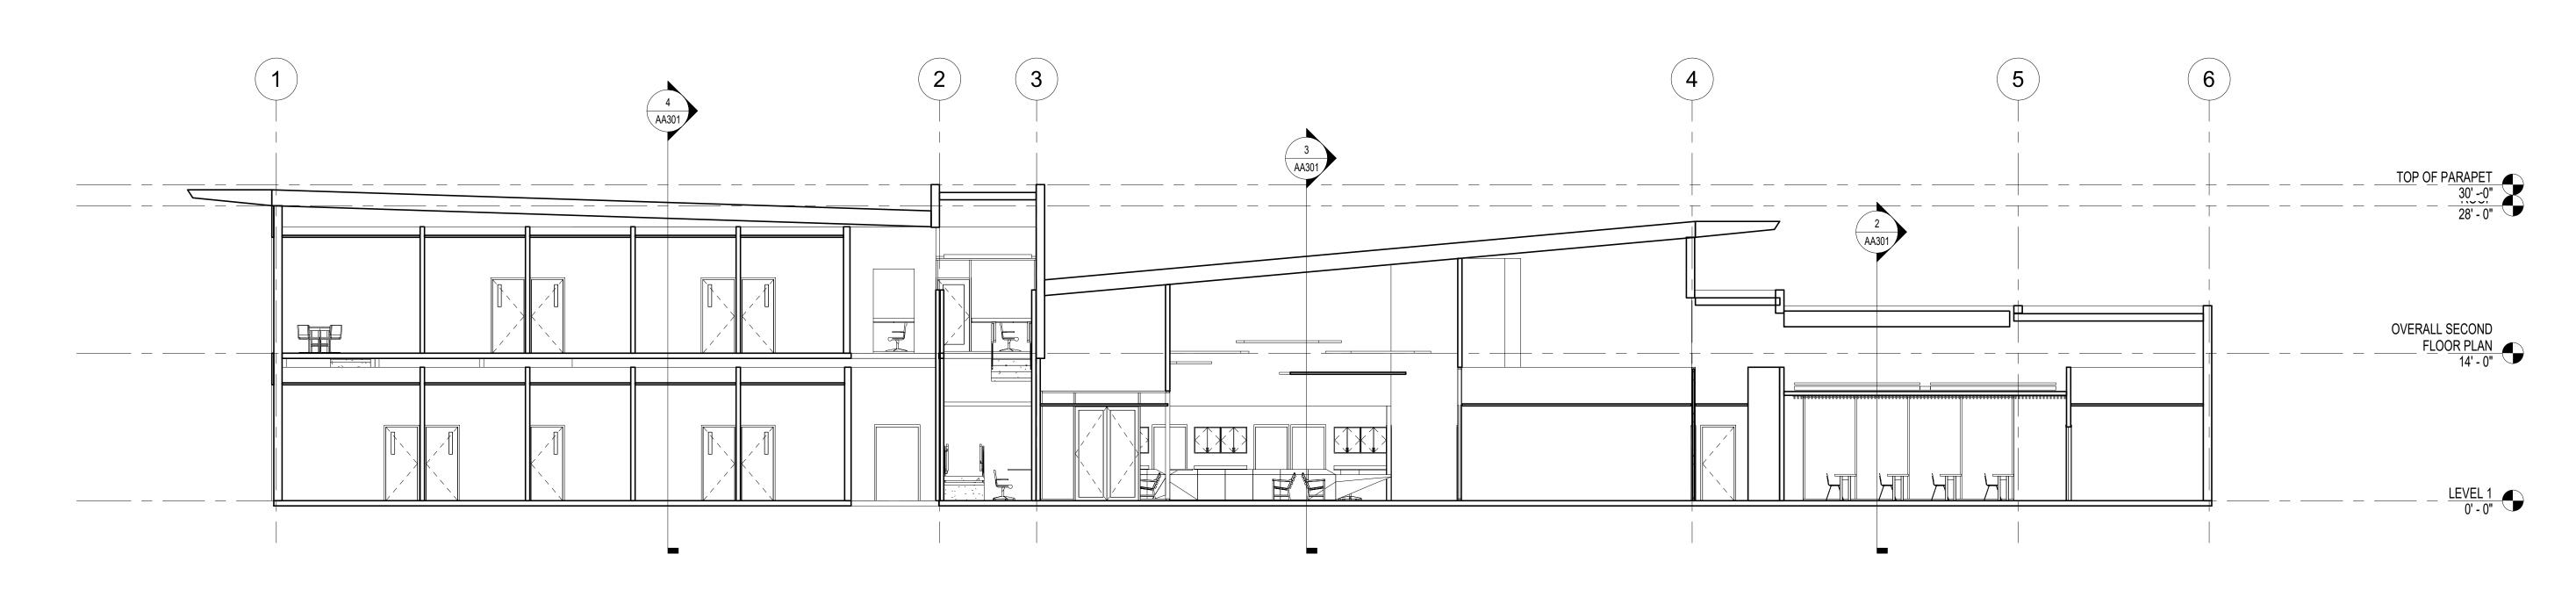


Section 1

1/8" = 1'-0"

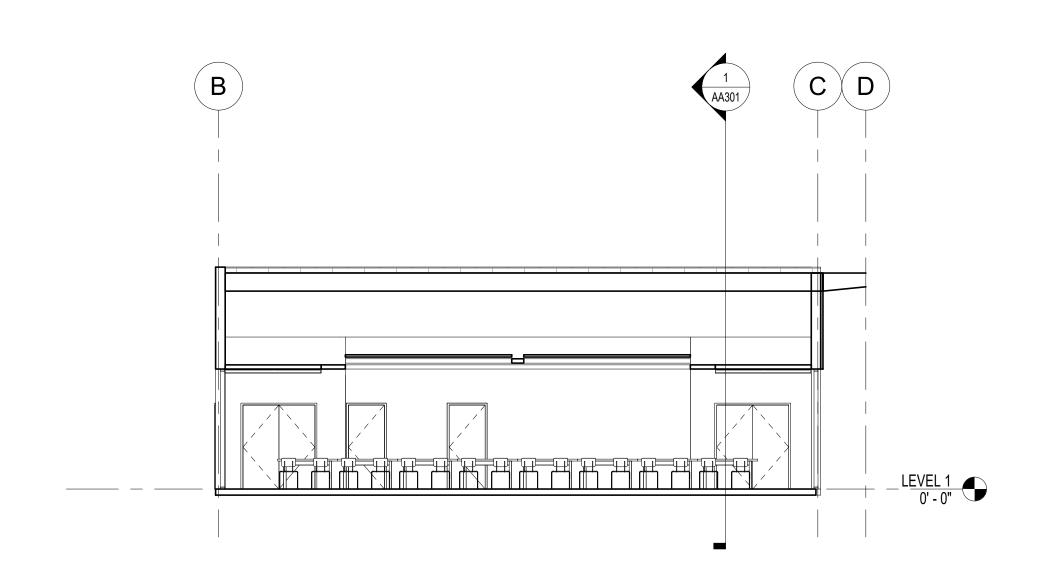


2 Section 2

1/8" = 1'-0"

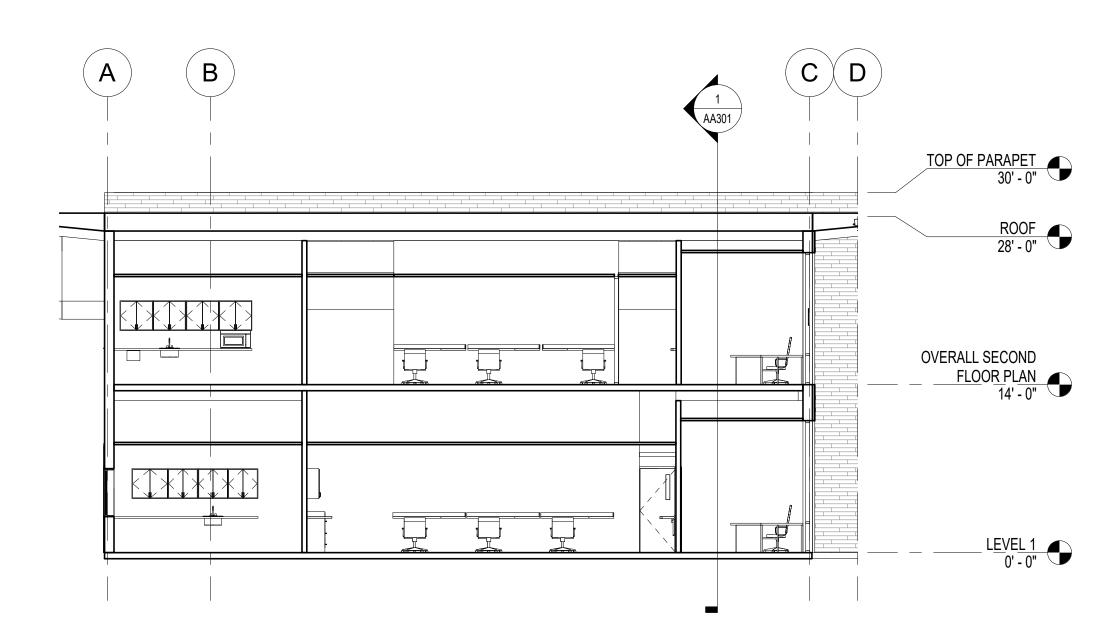

Section 4

1/8" = 1'-0"

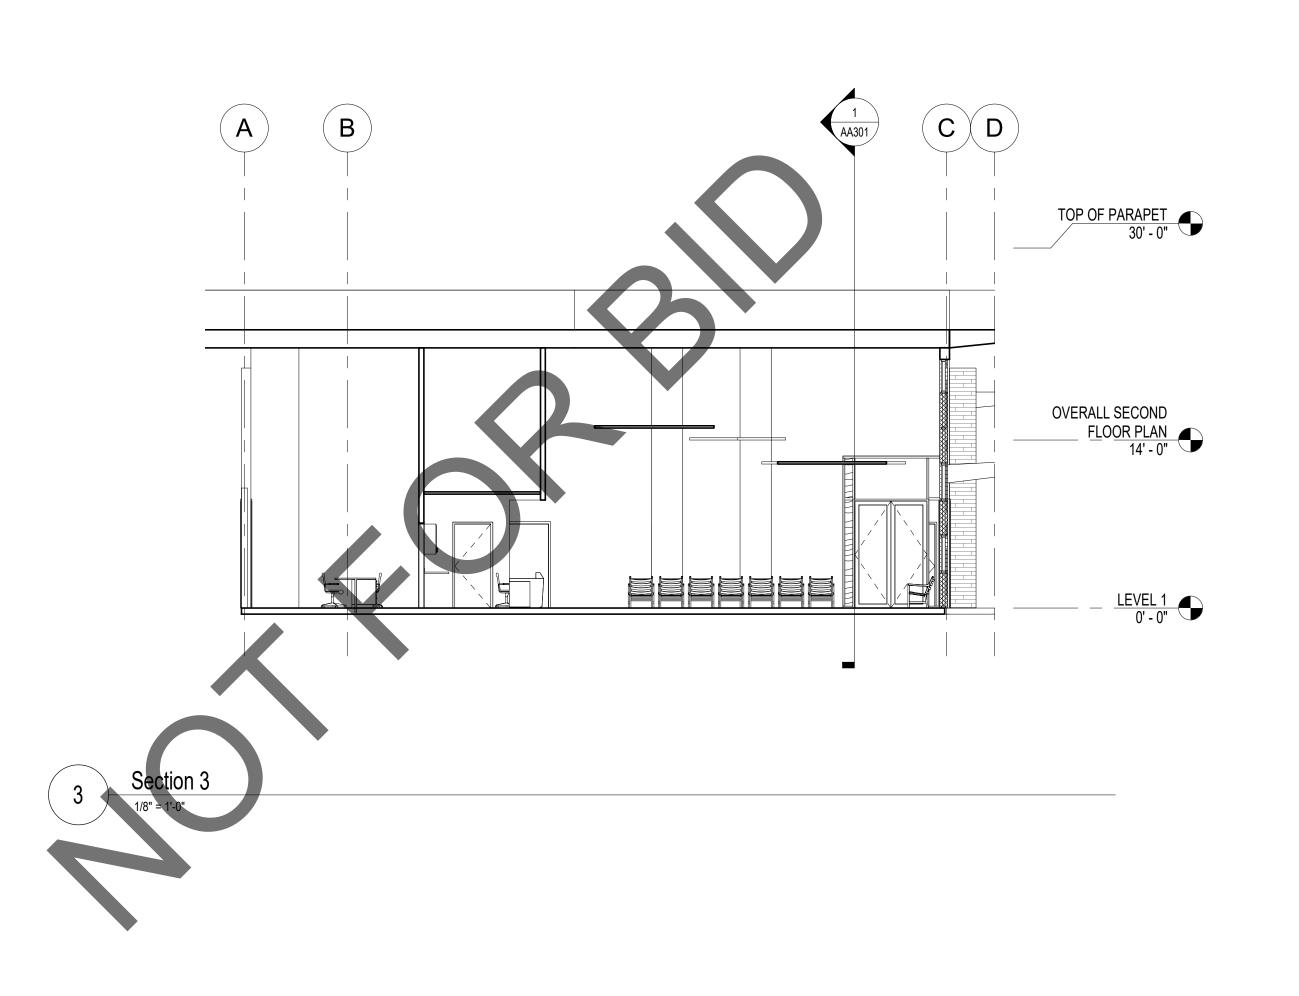






planning

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revisions/addenda

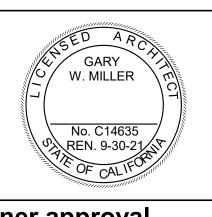Date

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project information

Project Number:
Drawn By:
Checked By:

Author Issue Date: 03/22/23

1227

sheet name

ADMIN BUILDING SECTIONS

sheet number

AA301