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#### **GENERAL NOTES:**

1. THE FIRE ALARM CONTRACT WORK IS A DESIGN/BUILD CONTRACT. THE CONTRACTOR IS RESPONSIBLE TO DESIGN THE FIRE ALARM SYSTEM, SUBMIT PLANS TO THE FIRE DEPARTMENT, PROJECT CONSTRUCTION MANAGER (CM). AND TO THE ARCHITECT FOR APPROVAL. IT SHALL BE THE CONTRACTOR'S RESPONSIBILITY TO INSTALL CONDUITS, WIRING & ALL DEVICES, FIRE ALARM PANEL & POWER SUPPLY TO INCLUDE ITS SUPPORT SYSTEM. THE FIRE ALARM DRAWINGS INDICATE NEW SUGGESTED LOCATIONS OF DEVICES AN HORN/STROBES AND IS FOR INFORMATIONAL PURPOSES ONLY. IT IS T RESPONSIBILITY OF THE CONTRACTOR TO SUBMIT STAMPED SHOP DRAWINGS TO THE CITY OF SAN BERNARDINO COUNTY FIRE DEPARTMENT FOR I MARSHALL APPROVAL AND TO THE PROJECT, CM & THE ARCHITECT

ANY INSPECTIONS AND ASSOCIATED FEE. DEVICES SHOWN IN THE FIRE ALARM

PLAN ARE FOR REFERENCE ONLY AND SHALL NOT USED FOR BID ESTIMATION FIRE ALARM SYSTEM REQUIRES A SEPARATE PERMIT AND SUBMITTAL.

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ISOLATION

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#### KEY NOTES: #

TO DEDICATED 120V CIRCUIT. PROVIDE 'LOCK-ON' DEVICE TO BREAKER AND RED LABEL INDICATING 'FA PANEL' TO CIRCUIT ID. REFER TO POWER PLAN FOR

CIRCUIT ASSIGNMENT. REFER TO SITE PLAN FAS-101 FOR CONTINUATION.

CONTROL MODULE FOR HVAC UNIT SHUTD TO DEDICATED 120V CIRCUIT. PROVIDE LOCK-ON' DEVICE TO BREAKER AND RED LABEL INDICATING 'FA BELL' TO CIRCUIT ID. REFER TO POWER PLAN FOR JIT ASSIGNMENT.

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owner approval		
initials	date	phase

### revisions/addenda

# Date Comment

# project information

Project Number: Drawn By: Author Checked By 05/17/24 Issue Date:

#### sheet name

MEDICAL CLINIC FIRE ALARM FLOOR PLAN

sheet number

Sheet

PRELIMINARY

FABC-101

Of

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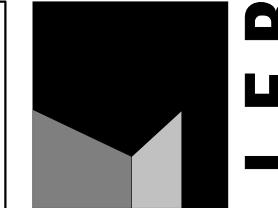
901 VIA PIEMONTE SUITE 400 ONTARIO, CA 91764 P: 909.477.6915 F: 909.477.6916



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### KEY NOTES: #

REFER TO SITE PLAN FAS-101 FOR CONTINUATION. CONTROL MODULE FOR HVAC UNIT SHUTDOWN. TO DEDICATED 120V CIRCUIT. PROVIDE 'LOCK-ON' DEVICE TO BREAKER AND RED LABEL INDICATING 'FA BELL' TO CIRCUIT ID. REFER TO POWER PLAN FOR



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# Date Comment

#### project information

Project Number: 1227 Author Drawn By: PS Checked By 05/17/24 Issue Date:

#### sheet name

CAT & OTHER ANIMALS BUILDING FIRE ALARM FLOOR PLAN

### sheet number

PRELIMINARY

**NOT FOR** 

CONSTRUCTION


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#### KEY NOTES: #

REFER TO SITE PLAN FAS-101 FOR CONTINUATION.
CONTROL MODULE FOR HVAC UNIT SHUTDOWN.
TO DEDICATED 120V CIRCUIT. PROVIDE 'LOCK-ON' DEVICE TO BREAKER AND RED LABEL INDICATED. FA BELL' TO CIRCUIT ID. REFER TO POWER PLAN FOR CIRCUIT ASSIGNMENT.



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# Date Comment

#### project information

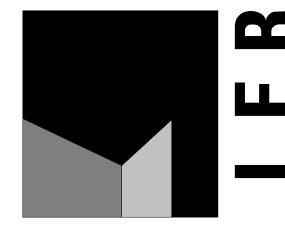Project Number: Drawn By: Author PS Checked By: 05/17/24 Issue Date:

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ADOPTION DOG **BUILDING 1 FIRE** ALARM FLOOR PLAN

sheet number

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PRELIMINARY CONSTRUCTION

1. THE FIRE ALARM CONTRACT WORK IS A DESIGN/BUILD CONTRACT. THE CONTRACTOR IS RESPONSIBLE TO DESIGN THE FIRE ALARM SYSTEM, SUBMIT PLANS TO THE FIRE DEPARTMENT, PROJECT CONSTRUCTION MANAGER (CM), AND TO THE ARCHITECT FOR APPROVAL. IT SHALL BE THE CONTRACTOR'S RESPONSIBILITY TO INSTALL CONDUITS, WIRING & ALL DEVICES, FIRE ALARM PANEL & POWER SUPPLY TO INCLUDE ITS SUPPORT SYSTEM. THE FIRE ALARM DRAWINGS INDICATE NEW SUGGESTED LOCATIONS OF DEVICES AND HORN/STROBES AND IS FOR INFORMATIONAL PURPOSES ONLY. IT IS THE RESPONSIBILITY OF THE CONTRACTOR TO SUBMIT STAMPED SHOP DRAWINGS TO THE CITY OF SAN BERNARDINO COUNTY FIRE DEPARTMENT FOR FIRE MARSHALL APPROVAL AND TO THE PROJECT, CM & THE ARCHITECT FOR APPROVAL. THE CONTRACTOR SHALL BE RESPONSIBLE TO PAY FOR PERMITS & ANY INSPECTIONS AND ASSOCIATED FEE. DEVICES SHOWN IN THE FIRE ALARM PLAN ARE FOR REFERENCE ONLY AND SHALL NOT USED FOR BID ESTIMATE. FIRE ALARM SYSTEM REQUIRES A SEPARATE PERMIT AND SUBMITTAL.

### KEY NOTES: #

REFER TO SITE PLAN FAS-101 FOR CONTINUATION.
CONTROL MODULE FOR HVAC UNIT SHUTDOWN.
TO DEDICATED 120V CIRCUIT. PROVIDE 'LOCK-ON' DEVICE TO BREAKER AND RED LABEL INDICATING 'FA BELL' TO CIRCUIT ID. REFER TO POWER PLAN FOR CIRCUIT ASSIGNMENT.



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# Date Comment

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4.	

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Project Number: 1227
Drawn By: Author
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Issue Date: 05/17/24

#### sheet name

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ADOPTION DOG BUILDING 2 FIRE ALARM FLOOR PLAN

sheet number

FAF-101

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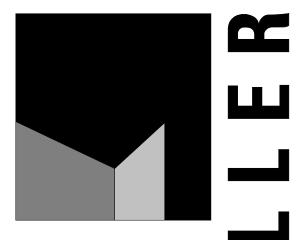
THE FIRE ALARM CONTRACT WORK IS A DESIGN/BUILD CONTRACT. THE CONTRACTOR IS RESPONSIBLE TO DESIGN THE FIRE ALARM SYSTEM, SUBMIT PLANS TO THE FIRE DEPARTMENT, PROJECT CONSTRUCTION MANAGER (CM), AND TO THE ARCHITECT FOR APPROVAL. IT SHALL BE THE CONTRACTOR'S AND TO THE ARCHITECT FOR APPROVAL. IT SHALL BE THE CONTRACTOR'S RESPONSIBILITY TO INSTALL CONDUITS, WIRING & ALL DEVICES, FIRE ALARM PANEL & POWER SUPPLY TO INCLUDE ITS SUPPORT SYSTEM. THE FIRE ALARM DRAWINGS INDICATE NEW SUGGESTED LOCATIONS OF DEVICES AND HORN/STROBES AND IS FOR INFORMATIONAL PURPOSES ONLY. IT IS THE RESPONSIBILITY OF THE CONTRACTOR TO SUBMIT STAMPED SHOP DRAWINGS TO THE CITY OF SAN BERNARDINO COUNTY FIRE DEPARTMENT FOR FIRE MARSHALL APPROVAL AND TO THE PROJECT, CM & THE ARCHITECT FOR APPROVAL. THE CONTRACTOR SHALL BE RESPONSIBLE TO PAY FOR PERMITS & ANY INSPECTIONS AND ASSOCIATED FEE. DEVICES SHOWN IN THE FIRE ALARM PLAN ARE FOR REFERENCE ONLY AND SHALL NOT USED FOR BID ESTIMATE. FIRE ALARM SYSTEM REQUIRES A SEPARATE PERMIT AND SUBMITTAL.

#### KEY NOTES: #

TO DEDICATED 120V CIRCUIT. PROVIDE 'LOCK-ON' DEVICE TO BREAKER AND RED LABEL INDICATING 'FA PANEL' TO CIRCUIT ID. REFER TO POWER PLAN FOR CIRCUIT ASSIGNMENT.

REFER TO SITE PLAN FAS-101 FOR CONTINUATION.


CONTROL MODULE FOR HVAC UNIT SHUTDOWN.
TO DEDICATED 120V CIRCUIT. PROVIDE 'LOCK-ON' DEVICE TO BREAKER AND RED LABEL INDICATING 'FA BELL' TO CIRCUIT ID. REFER TO POWER PLAN FOR CIRCUIT ASSIGNMENT.



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# Date Comment

project information

Project Number: Drawn By: Author Checked By 05/17/24 Issue Date:

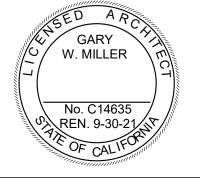sheet name

ADOPTION DOG **BUILDING 3 FIRE** ALARM FLOOR PLAN

sheet number

PRELIMINARY

**NOT FOR** 


CONSTRUCTION

FAG-101

1. THE FIRE ALARM CONTRACT WORK IS A DESIGN/BUILD CONTRACT. THE CONTRACTOR IS RESPONSIBLE TO DESIGN THE FIRE ALARM SYSTEM, SUBMIT PLANS TO THE FIRE DEPARTMENT, PROJECT CONSTRUCTION MANAGER (CM), AND TO THE ARCHITECT FOR APPROVAL. IT SHALL BE THE CONTRACTOR'S RESPONSIBILITY TO INSTALL CONDUITS, WIRING & ALL DEVICES, FIRE ALARM PANEL & POWER SUPPLY TO INCLUDE ITS SUPPORT SYSTEM. THE FIRE ALARM DRAWINGS INDICATE NEW SUGGESTED LOCATIONS OF DEVICES AND HORN/STROBES AND IS FOR INFORMATIONAL PURPOSES ONLY. IT IS THE RESPONSIBILITY OF THE CONTRACTOR TO SUBMIT STAMPED SHOP DRAWINGS TO THE CITY OF SAN BERNARDINO COUNTY FIRE DEPARTMENT FOR FIRE MARSHALL APPROVAL AND TO THE PROJECT, CM & THE ARCHITECT FOR APPROVAL. THE CONTRACTOR SHALL BE RESPONSIBLE TO PAY FOR PERMITS & ANY INSPECTIONS AND ASSOCIATED FEE. DEVICES SHOWN IN THE FIRE ALARM PLAN ARE FOR REFERENCE ONLY AND SHALL NOT USED FOR BID ESTIMATE. FIRE ALARM SYSTEM REQUIRES A SEPARATE PERMIT AND SUBMITTAL.

### KEY NOTES: #

REFER TO SITE PLAN FAS-101 FOR CONTINUATION.
CONTROL MODULE FOR HVAC UNIT SHUTDOWN.
TO DEDICATED 120V CIRCUIT. PROVIDE 'LOCK-ON' DEVICE TO BREAKER AND RED LABEL INDICATING 'FA BELL' TO CIRCUIT ID. REFER TO POWER PLAN FOR CIRCUIT ASSIGNMENT.

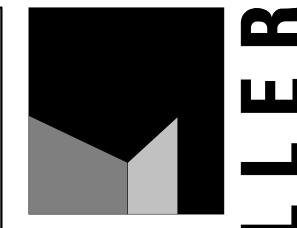

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Comment # Date

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SAN BERNARDINO COUNTY

#### project information

Project Number: 1227 Author Drawn By: PS Checked By 05/17/24 Issue Date:

#### sheet name

PRELIMINARY

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CONSTRUCTION

STRAY DOG **BUILDING FIRE** ALARM FLOOR PLAN


sheet number

FAH-101

1. THE FIRE ALARM CONTRACT WORK IS A DESIGN/BUILD CONTRACT. THE CONTRACTOR IS RESPONSIBLE TO DESIGN THE FIRE ALARM SYSTEM, SUBMIT PLANS TO THE FIRE DEPARTMENT, PROJECT CONSTRUCTION MANAGER (CM), AND TO THE ARCHITECT FOR APPROVAL. IT SHALL BE THE CONTRACTOR'S RESPONSIBILITY TO INSTALL CONDUITS, WIRING & ALL DEVICES, FIRE ALARM PANEL & POWER SUPPLY TO INCLUDE ITS SUPPORT SYSTEM. THE FIRE ALARM DRAWINGS INDICATE NEW SUGGESTED LOCATIONS OF DEVICES AND HORN/STROBES AND IS FOR INFORMATIONAL PURPOSES ONLY. IT IS THE RESPONSIBILITY OF THE CONTRACTOR TO SUBMIT STAMPED SHOP DRAWINGS TO THE CITY OF SAN BERNARDINO COUNTY FIRE DEPARTMENT FOR FIRE MARSHALL APPROVAL AND TO THE PROJECT, CM & THE ARCHITECT FOR APPROVAL. THE CONTRACTOR SHALL BE RESPONSIBLE TO PAY FOR PERMITS & ANY INSPECTIONS AND ASSOCIATED FEE. DEVICES SHOWN IN THE FIRE ALARM PLAN ARE FOR REFERENCE ONLY AND SHALL NOT USED FOR BID ESTIMATE. FIRE ALARM SYSTEM REQUIRES A SEPARATE PERMIT AND SUBMITTAL.

### KEY NOTES: #

REFER TO SITE PLAN FAS-101 FOR CONTINUATION.
CONTROL MODULE FOR HVAC UNIT SHUTDOWN.
TO DEDICATED 120V CIRCUIT. PROVIDE 'LOCK-ON' DEVICE TO BREAKER AND RED LABEL INDICATING 'FA BELL' TO CIRCUIT ID. REFER TO POWER PLAN FOR CIRCUIT ASSIGNMENT.

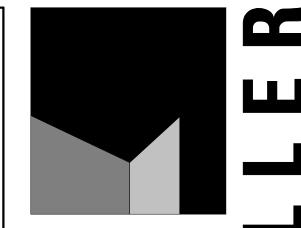

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# Date Comment

# project information Project Number:

Project Number: 1227
Drawn By: Author
Checked By: PS
Issue Date: 05/17/24

#### sheet name

ADOPTION DOG BUILDING 4 FIRE ALARM FLOOR PLAN

sheet number

PRELIMINARY

**NOT FOR** 


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REF. SCALE IN INCHES PROJECT #22007569.00

FAH.1-101

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THE FIRE ALARM CONTRACT WORK IS A DESIGN/BUILD CONTRACT. THE CONTRACTOR IS RESPONSIBLE TO DESIGN THE FIRE ALARM SYSTEM, SUBMIT PLANS TO THE FIRE DEPARTMENT, PROJECT CONSTRUCTION MANAGER (CM), AND TO THE ARCHITECT FOR APPROVAL. IT SHALL BE THE CONTRACTOR'S RESPONSIBILITY TO INSTALL CONDUITS, WIRING & ALL DEVICES, FIRE ALARM PANEL & POWER SUPPLY TO INCLUDE ITS SUPPORT SYSTEM. THE FIRE ALARM DRAWINGS INDICATE NEW SUGGESTED LOCATIONS OF DEVICES AND ORT SYSTEM. THE FIRE ALARM DRAWINGS INDICATE NEW SUGGESTED LOCATIONS OF DEVICES AND HORN/STROBES AND IS FOR INFORMATIONAL PURPOSES ONLY. IT IS THE RESPONSIBILITY OF THE CONTRACTOR TO SUBMIT STAMPED SHOP DRAWINGS TO THE CITY OF SAN BERNARDINO COUNTY FIRE DEPARTMENT FOR FIRE MARSHALL APPROVAL AND TO THE PROJECT, CM & THE ARCHITECT FOR APPROVAL. THE CONTRACTOR SHALL BE RESPONSIBLE TO PAY FOR PERMITS & ANY INSPECTIONS AND ASSOCIATED FEE. DEVICES SHOWN IN THE FIRE ALARM PLAN ARE FOR REFERENCE ONLY AND SHALL NOT USED FOR BID ESTIMATE. FIRE ALARM SYSTEM REQUIRES A SEPARATE PERMIT AND SUBMITTAL.

#### KEY NOTES: #

TO DEDICATED 120V CIRCUIT. PROVIDE 'LOCK-ON' DEVICE TO BREAKER AND RED LABEL INDICATING 'FA PANEL' TO CIRCUIT ID. REFER TO POWER PLAN FOR

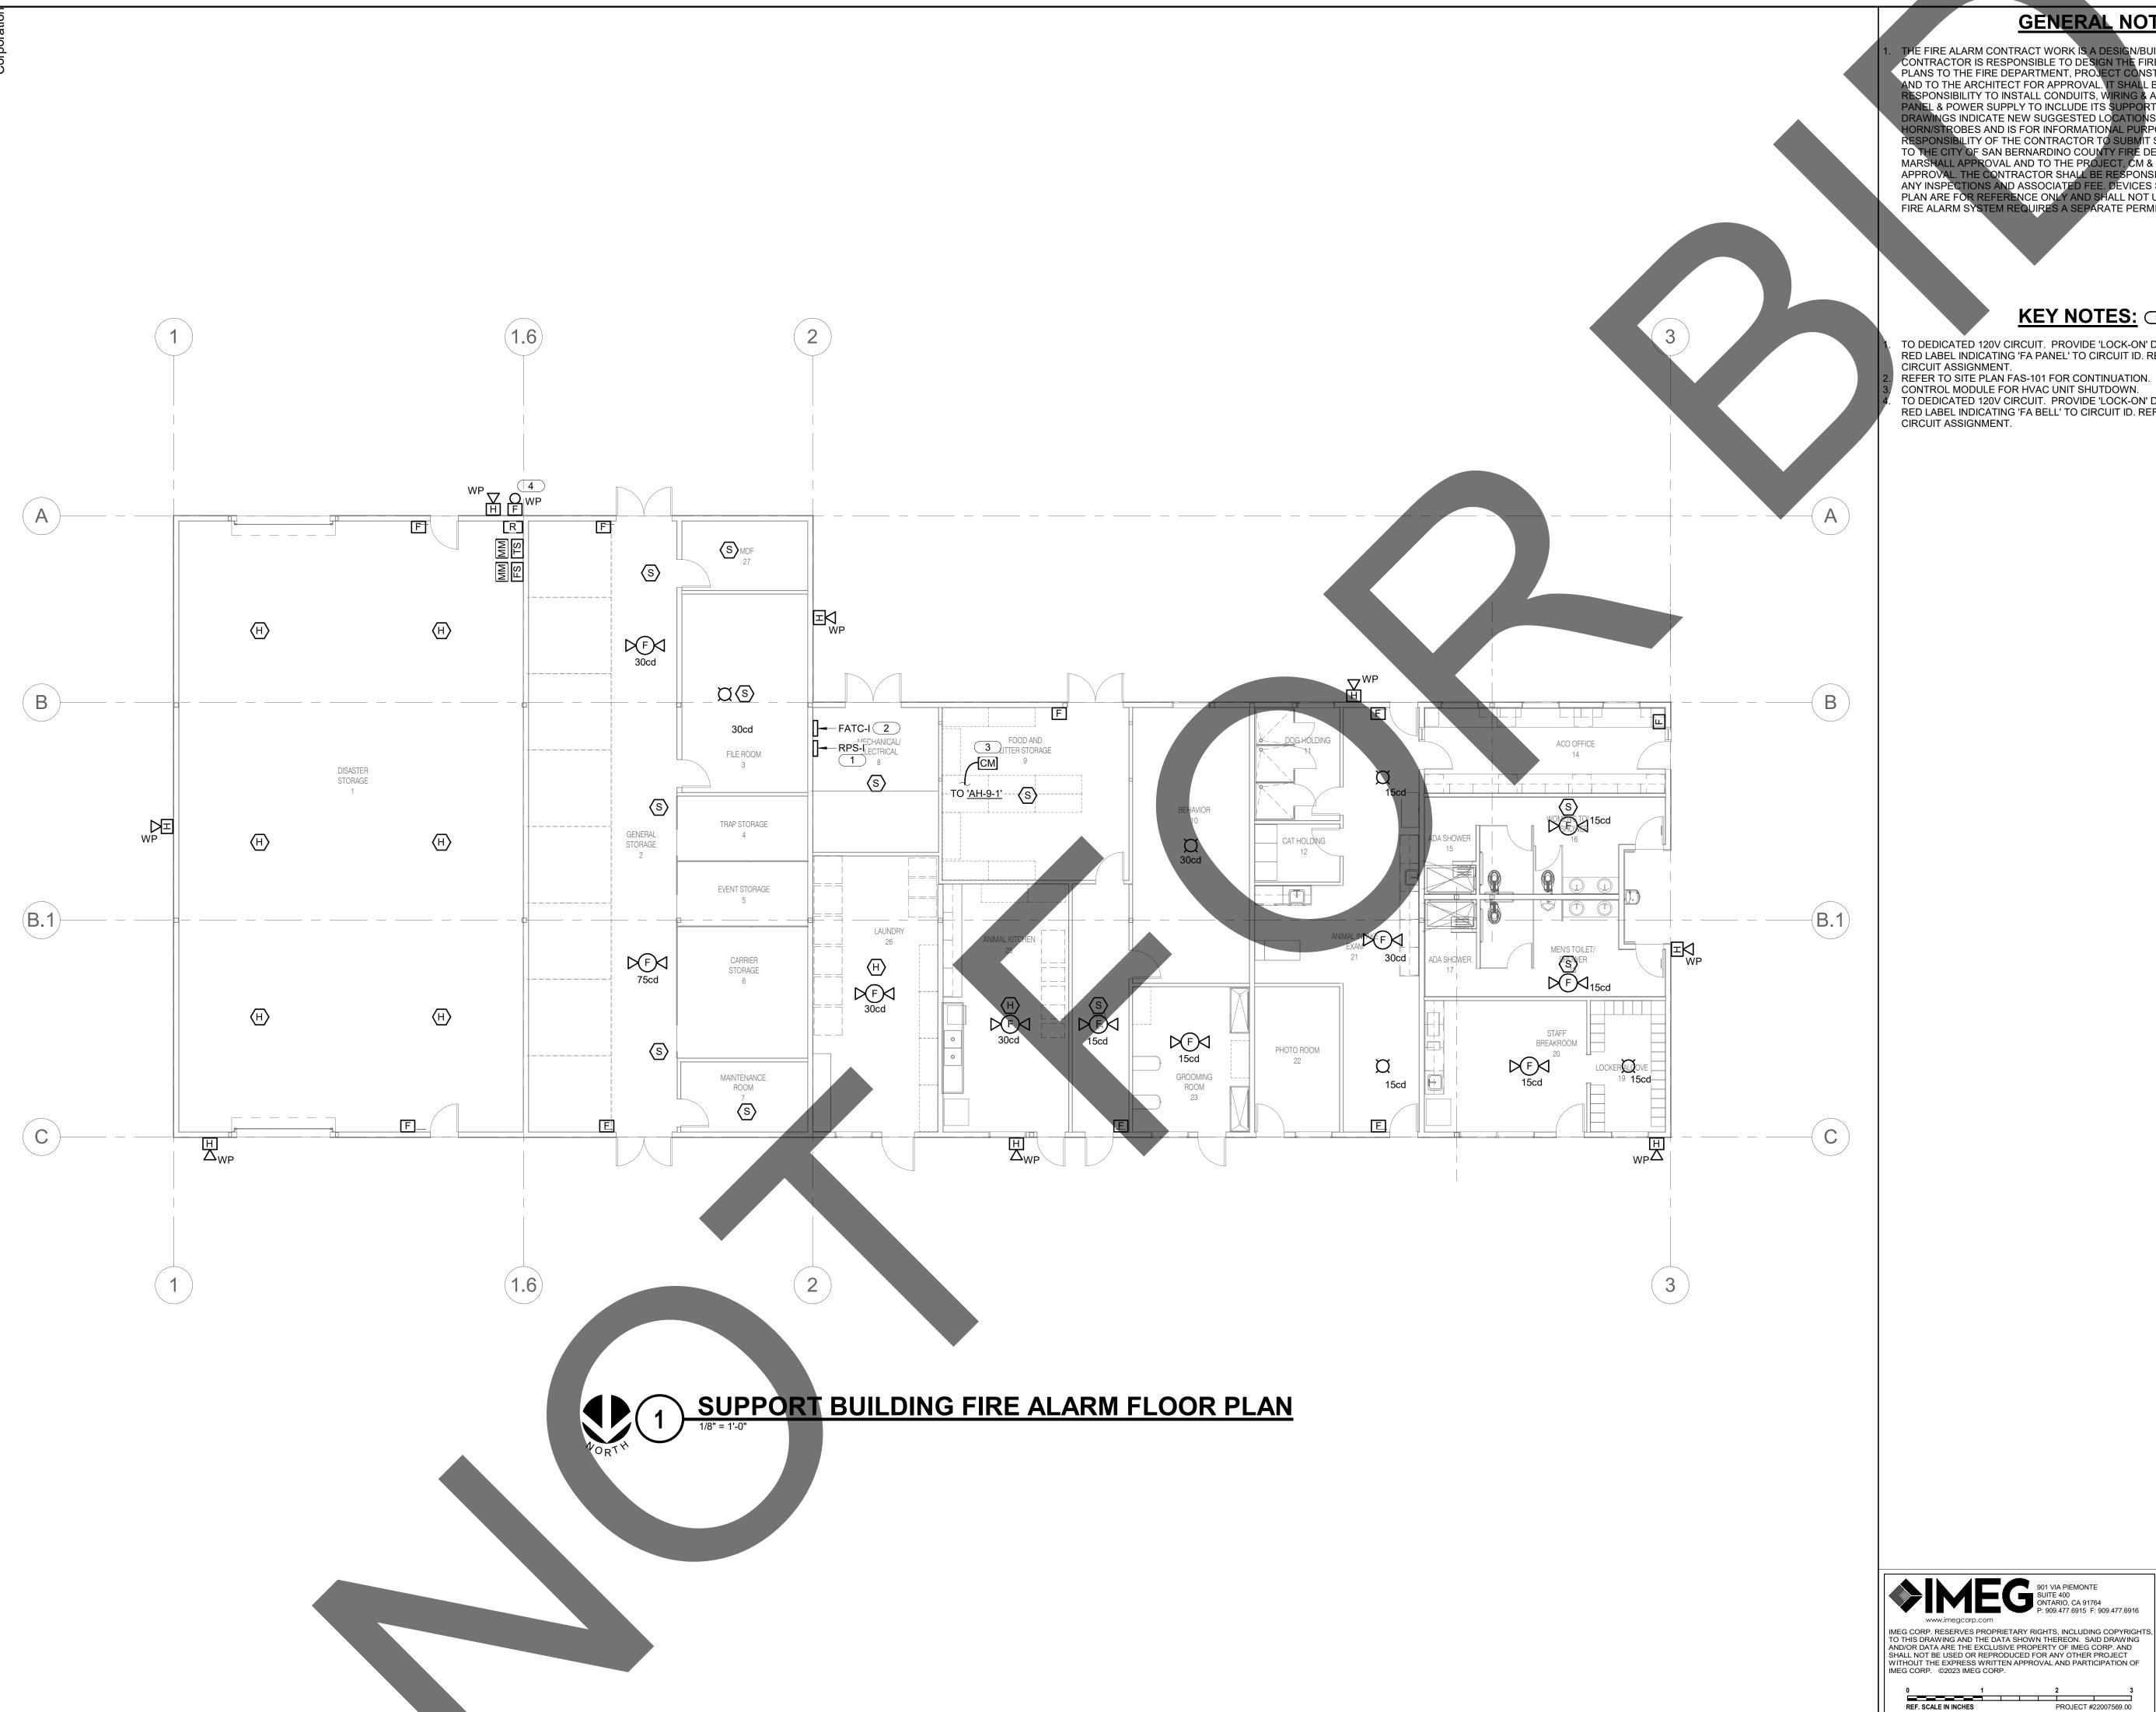REFER TO SITE PLAN FAS-101 FOR CONTINUATION.

CONTROL MODULE FOR HVAC UNIT SHUTDOWN.
TO DEDICATED 120V CIRCUIT. PROVIDE 'LOCK-ON' DEVICE TO BREAKER AND RED LABEL INDICATING 'FA BELL' TO CIRCUIT ID. REFER TO POWER PLAN FOR





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# Date Comment

#### project information

Project Number: Drawn By: Author Checked By 05/17/24 Issue Date:

#### sheet name

SUPPORT BUILDING FIRE ALARM FLOOR PLAN

sheet number

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FAI-101

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### **GENERAL NOTES:**

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REFER TO SITE PLAN FAS-101 FOR CONTINUATION.
CONTROL MODULE FOR HVAC UNIT SHUTDOWN.
TO DEDICATED 120V CIRCUIT. PROVIDE 'LOCK-ON' DEVICE TO BREAKER AND RED LABEL INDICATING 'FA BELL' TO CIRCUIT ID. REFER TO POWER PLAN FOR CIRCUIT ASSIGNMENT.



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# Date Comment

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#### project information

Project Number: 1227
Drawn By: Author
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Issue Date: 05/17/24

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ADOPTION DOG BUILDING 5 FIRE ALARM FLOOR PLAN

### sheet number

FAJ-101

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ADOPTION DOG BUILDING 5 FIRE ALARM FLOOR PLAN
NO SCALE

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TO 'AC-11-1'

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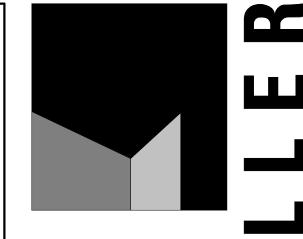
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GET ACQUAINTED YARD 2

1. THE FIRE ALARM CONTRACT WORK IS A DESIGN/BUILD CONTRACT. THE CONTRACTOR IS RESPONSIBLE TO DESIGN THE FIRE ALARM SYSTEM, SUBMIT PLANS TO THE FIRE DEPARTMENT, PROJECT CONSTRUCTION MANAGER (CM), AND TO THE ARCHITECT FOR APPROVAL. IT SHALL BE THE CONTRACTOR'S RESPONSIBILITY TO INSTALL CONDUITS, WIRING & ALL DEVICES, FIRE ALARM PANEL & POWER SUPPLY TO INCLUDE ITS SUPPORT SYSTEM. THE FIRE ALARM DRAWINGS INDICATE NEW SUGGESTED LOCATIONS OF DEVICES AND HORN/STROBES AND IS FOR INFORMATIONAL PURPOSES ONLY. IT IS THE RESPONSIBILITY OF THE CONTRACTOR TO SUBMIT STAMPED SHOP DRAWINGS TO THE CITY OF SAN BERNARDINO COUNTY FIRE DEPARTMENT FOR FIRE MARSHALL APPROVAL AND TO THE PROJECT, CM & THE ARCHITECT FOR APPROVAL. THE CONTRACTOR SHALL BE RESPONSIBLE TO PAY FOR PERMITS & ANY INSPECTIONS AND ASSOCIATED FEE. DEVICES SHOWN IN THE FIRE ALARM PLAN ARE FOR REFERENCE ONLY AND SHALL NOT USED FOR BID ESTIMATE. FIRE ALARM SYSTEM REQUIRES A SEPARATE PERMIT AND SUBMITTAL.

#### KEY NOTES: #

REFER TO SITE PLAN FAS-101 FOR CONTINUATION.
CONTROL MODULE FOR HVAC UNIT SHUTDOWN.
TO DEDICATED 120V CIRCUIT. PROVIDE 'LOCK-ON' DEVICE TO BREAKER AND RED LABEL INDICATING 'FA BELL' TO CIRCUIT ID. REFER TO POWER PLAN FOR CIRCUIT ASSIGNMENT.



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#### revisions/addenda

# Date Comment

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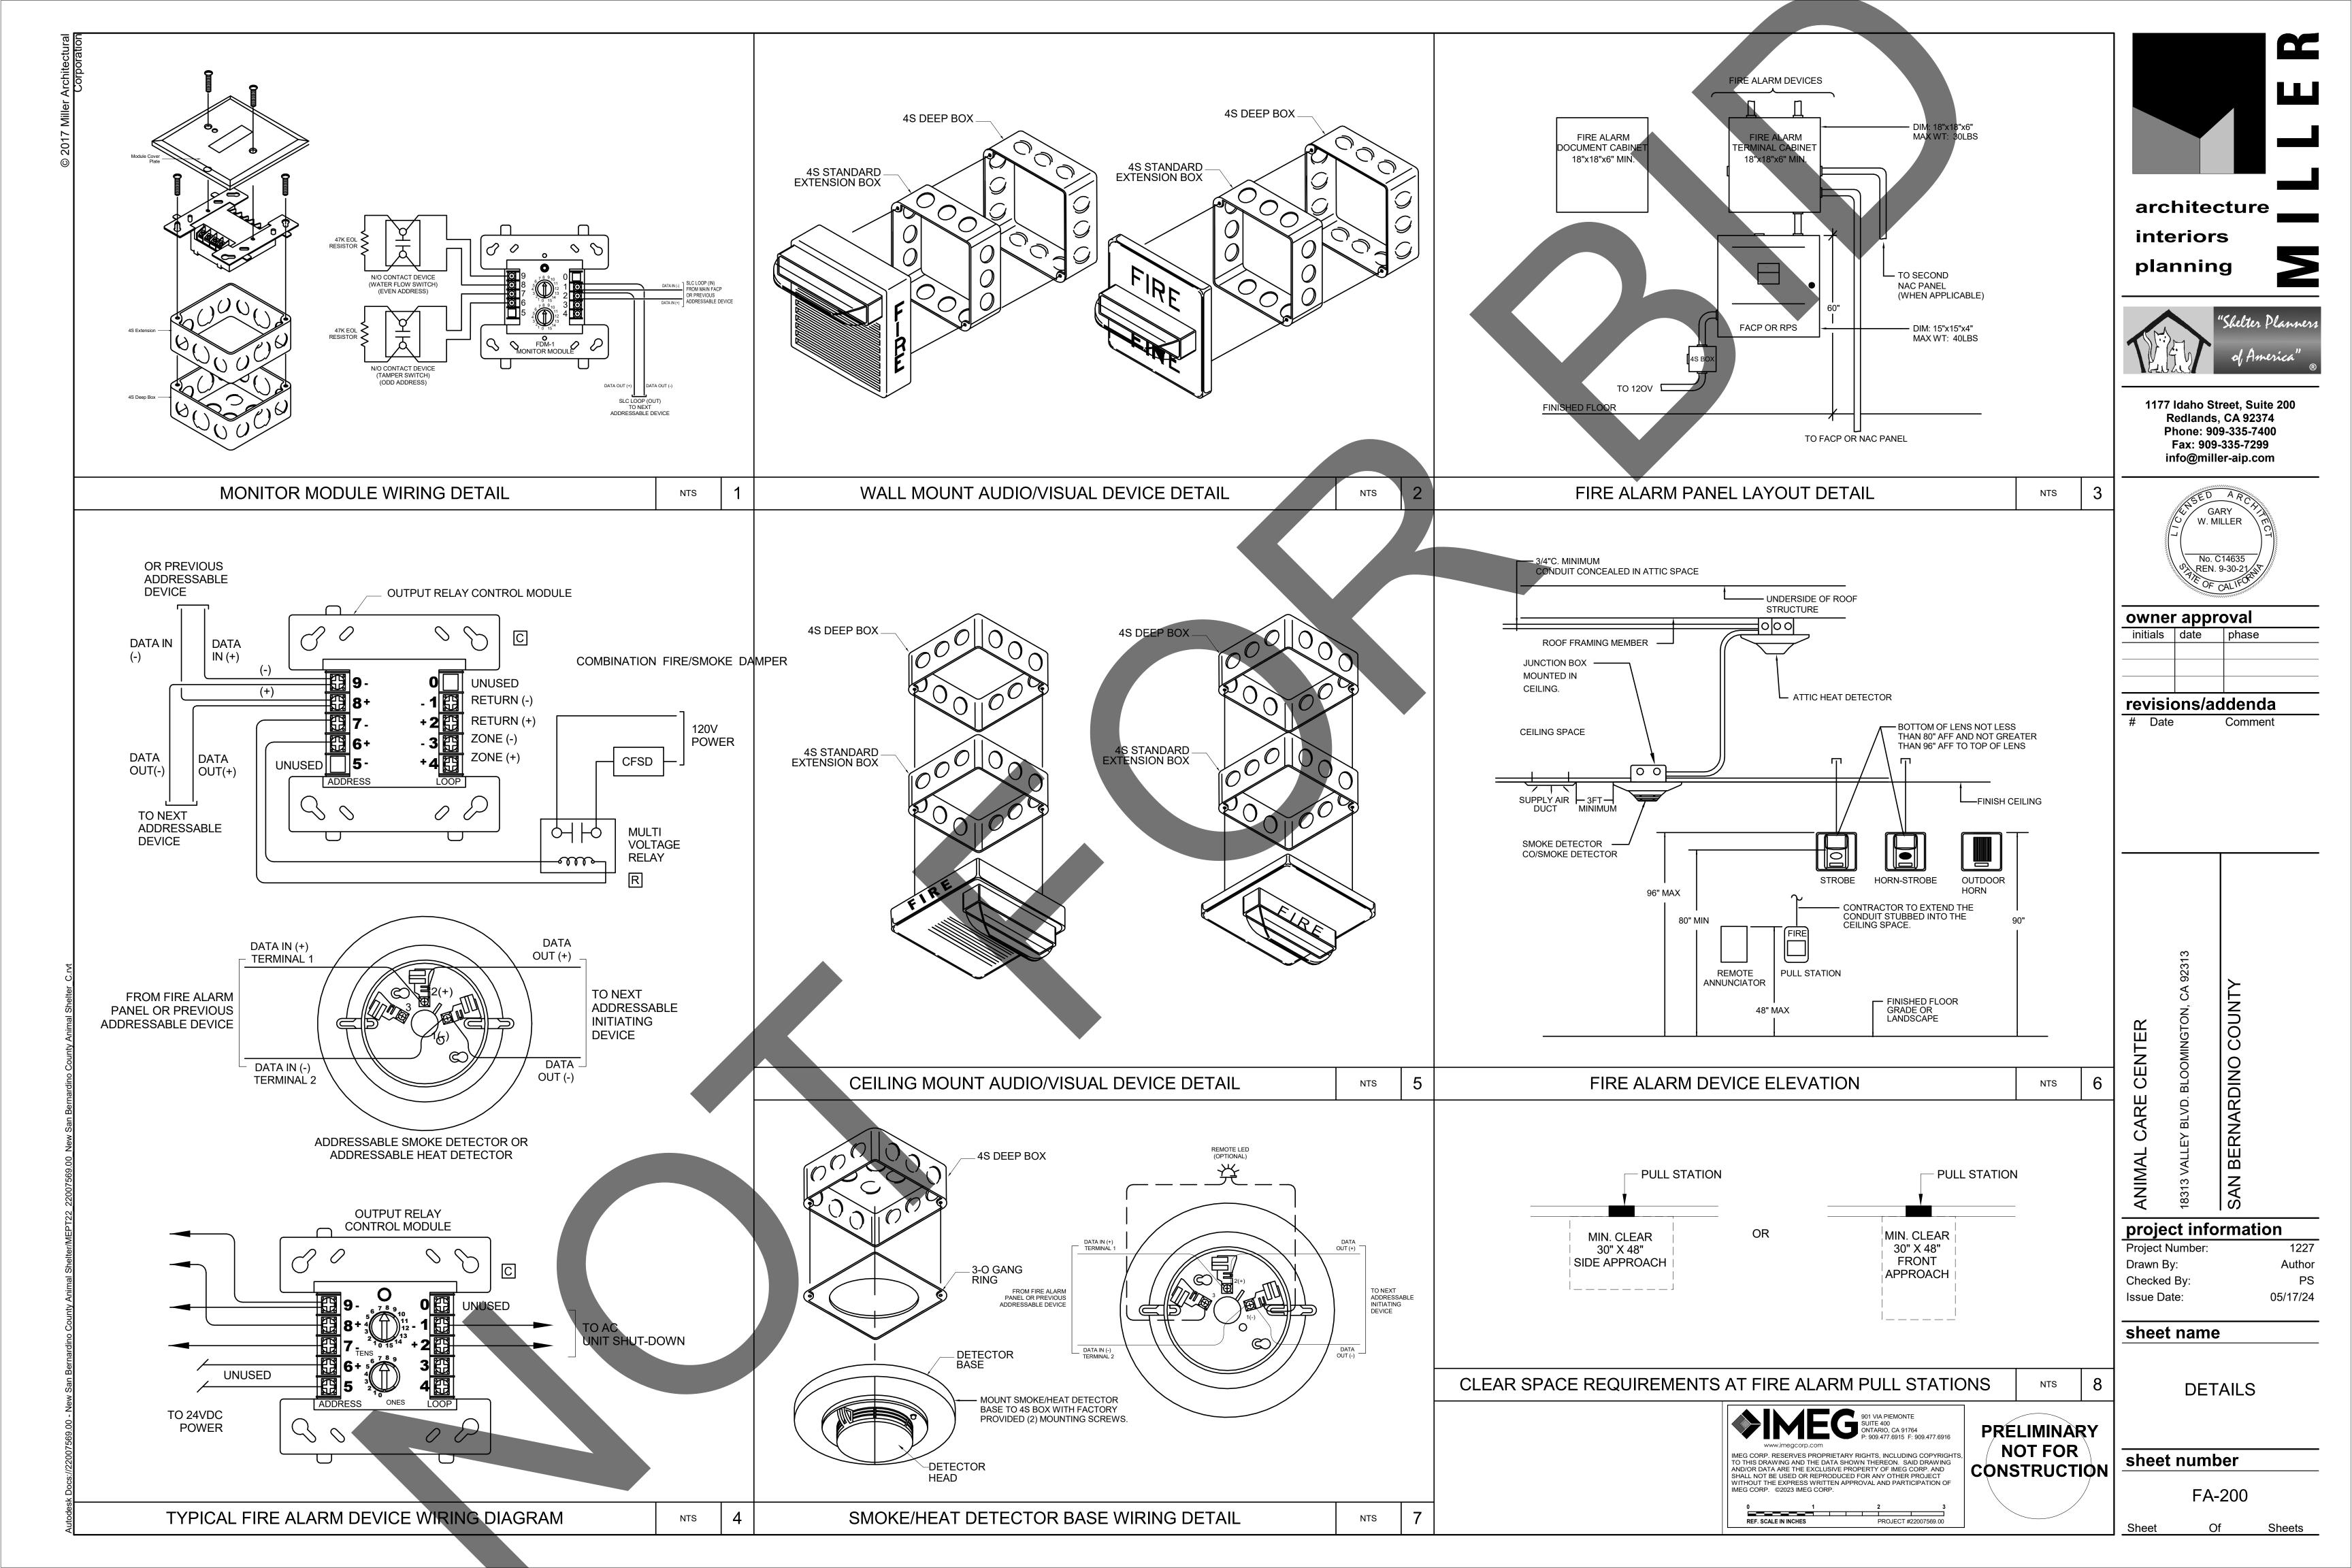
ADOPTION DOG BUILDING 6 FIRE ALARM FLOOR PLAN

### sheet number

FAK-101

Sheet Of Shee

ADOPTION DOG BUILDING 6 FIRE ALARM FLOOR PLAN
NO SCALE



# NEW WORK BY THIS CONTRACTOR (WIDE LINE) \_\_\_\_\_ NFW


SIGNAL CONNECTION ON

DIFFERENT SHEET - INPUT

TR-# TELECOMMUNICATIONS ROOM

---- NEW UNDERFLOOR OR UNDERGROUND (LONG DASHED PATTERN)

UNDERLINED TAG INDICATES OBJECT IS IN-SCOPE. IF NEW, ADDITIONAL INFORMATION IS AVAILABLE IN A SCHEDULE. MATERIAL LIST. OR SYMBOL LIST INDICATES AN EXISTING SYSTEM'S POINT OF CONNECTION/REMOVAL

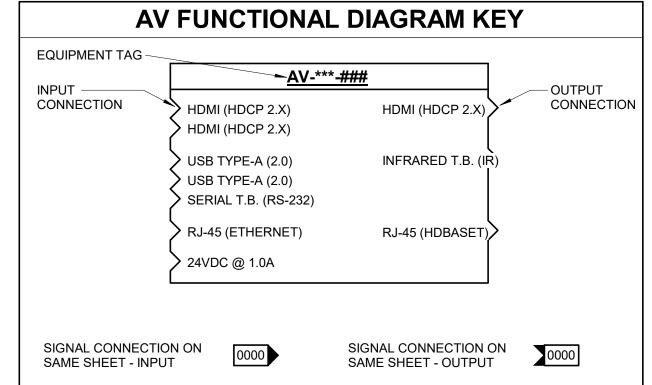

1/T000 0000

SIGNAL CONNECTION ON DIFFERENT SHEET - OUTPUT 1/T000 0000

ABBR:	DESCRIPTION:	
AFF	ABOVE FINISHED FLOOR	
AFG	ABOVE FINISHED GRADE	
BFC	BELOW FINISHED CEILING	
С	CONDUIT	
DE	DELAYED EGRESS	
DPDT	DOUBLE POLE DOUBLE THROW	
FOV	FIELD OF VIEW	
J-BOX	JUNCTION BOX	
POE	POWER OVER ETHERNET	
PTZ	PAN TILT ZOOM	
SIM	SIMILAR	
TYP	TYPICAL	
UON	UNLESS OTHERWISE NOTED	
+#	MOUNTING HEIGHT ABOVE FINISHED FLOOR	
EF-#	ENTRANCE FACILITY	
MC-#	MAIN CROSS-CONNECT	•

SYMBOL:	EQUIPMENT LIST ABBREV.:	DESCRIPTION:	NOTE
CSS	N/A	CONTROLLED SECURITY SCHEME SCHEDULE IDENTIFIER	2.
R#	AC-R#-W	SECURITY CREDENTIAL READER (WALL)	
X	AC-SS-1	ACCESS CONTROL - REQUEST TO EXIT (WALL)	
AMS	AR-AMS-W	AREA OF RESCUE - ASSISTANCE MASTER STATION	
AA1	AR-AA1-W	AREA OF RESCUE - ASSISTANCE CALL STATION - TYPE 1	
<b>™</b> <sub>MP#</sub>	AV-MP#-C/S	AV MICROPHONE (CEILING/SURFACE)	7.
S <sub>SP#</sub>	AV-SP#-C	AV PERFORMANCE SPEAKER (CEILING)	7.
©CAM-#	AV-CAM-#	AV CAMERA (WALL)	7.
$\left\langle T\right\rangle _{\underline{TP\#}}$	AV-TP#-S	AV TOUCH PANEL (SURFACE)	7.
<b>T</b>	AV-TP#-W	AV TOUCH PANEL (WALL)	7.
<b>●</b> ###	AV-###-C/S	AV PLATE (CEILING/SURFACE)	7.
◆ <u>###</u>	<u>AV-###-W</u>	AV WALLPLATE/BACKBOX (WALL)	7.
D	ID-DC1	INTRUSION DETECTION DOOR CONTACT	
<b>©</b>	ID-GB1-C	INTRUSION DETECTION GLASS BREAK (CEILING)	
⑤ <u>s#</u>	PA-S#-C	FACILITY PAGING SPEAKER (CEILING)	6,7.
S <u>s#</u>	PA-S#-W	FACILITY PAGING SPEAKER (WALL)	6,7.
C# ○▼◆AV#	SC-IO-F AV-FB-AV#	INFORMATION OUTLET AND AV DEVICE IN FLOOR BOX/POKE THROUGH	1,4,5.
C# ▼	SC-IO-W	INFORMATION OUTLET (WALL)	1.
W	SC-IO-W	INFORMATION OUTLET WALL PHONE (WALL)	
©C#	SC-IO-C	INFORMATION OUTLET (CEILING)	1.
<b>C</b> M-#	VS-CM-#	VIDEO SURVEILLANCE CAMERA 180° FOV (WALL/VERTICAL SURFACE)	3.
(C) CM-#	VS-CM-#	VIDEO SURVEILLANCE CAMERA 360° FOV (CEILING/HORIZONTAL SURFACE)	3.
<b>○</b> CM-#	VS-CM-#	VIDEO SURVEILLANCE CAMERA SINGLE LENS FOV (CEILING/HORIZONTAL SURFACE)	3.
<b>○</b> CM-#	VS-CM-#	VIDEO SURVEILLANCE CAMERA SINGLE LENS FOV (WALL/VERTICAL SURFACE)	3.
WIDTH >	(HËIGHT	LADDER RACK	
DIAME	TERø C <del></del>	CONDUIT	
	——∋	CONDUIT DOWN	
	<u>_</u> U	CONDUIT UP OR UP/DOWN	
<u> </u>	<del></del> -	CONDUIT SLEEVE	

TECHNOLOGY SYMBOL LIST

#### **GENERAL NOTES:**

LL SYMBOLS AND ABBREVIATIONS LISTED MAY NOT BE APPLICABLE TO THIS PROJECT. REFER TO THE TECHNOLOGY EQUIPMENT SCHEDULE FOR MORE COMPLETE DESCRIPTION

SYMBOLS AND ABBREVIATIONS REFER TO TECHNOLOGY SHEETS ONLY AS DEFINED ON SHEET INDEX. REFER TO THE GENERAL TECHNOLOGY NOTES FOR ADDITIONAL

CONTINUATION

OLS LISTED ABOVE ARE FOR REFERENCE ONLY. REFER TO PLANS AND LINE TYPE BY FOR NEW, EXISTING TO REMAIN AND TO BE REMOVED ITEMS FOR ADDITIONAL

#### REFER TO RISERS ON SHEET(S): T-300, T-301, T-302.

#### **TECHNOLOGY SYMBOL NOTES:**

"C#" INDICATES INFORMATION OUTLET FACEPLATE CONFIGURATION. REFER TO INFORMATION OUTLET SCHEDULE ON T-102 FOR ADDITIONAL INFORMATION. REFER TO CONTROLLED SECURITY SCHEME (CSS) TYPE SCHEDULE ON T-102 FOR

ADDITIONAL INFORMATION. "CM-#" ON FLOOR PLANS INDICATES CAMERA TYPE AND IS ASSOCIATED WITH THE CORRESPONDING "VS-CM-#" EQUIPMENT SCHEDULE ABBREVIATION. "xx-###" SUBSCRIPT INDICATES BLDG INDENTIFIER-CAMERA NUMBER. REFER TO INDIVIDUAL CAMERA REQUIREMENT SCHEDULE FOR ADDITIONAL INFORMATION.

INFORMATION OUTLET INSTALLED IN E.C. PROVIDED FLOOR BOX. "C#" INDICATES NFORMATION OUTLET FACEPLATE CONFIGURATION. REFER TO INFORMATION OUTLET SCHEDULE ON T-102 FOR ADDITIONAL INFORMATION. REFER TO THE ELECTRICAL FLOOR PLANS AND ELECTRICAL EQUIPMENT SCHEDULE FOR ADDITIONAL INFORMATION. AV INSTALLED IN E.C. PROVIDED FLOOR BOX. "AV#" INDICATES AV TYPE CONFIGURATION. REFER TO TECHNOLOGY EQUIPMENT SCHEDULE ON T-101 FOR ADDITIONAL INFORMATION. REFER TO THE ELECTRICAL FLOOR PLANS FOR ADDITIONAL INFORMATION ON FLOOR BOX. SYMBOL SUBSCRIPT INDICATES PAGING ZONE.

SYMBOL SUBSCRIPT INDICATES DEVICE TYPE. REFER TO TECHNOLOGY EQUIPMENT SCHEDULE T-101 FOR ADDITIONAL INFORMATION.

#### SUGGESTED MATRIX OF RESPONSIBILITY FURNISHED INSTALLED NOTES: SHOWN ON: BY: BY: TECHNOLOGY ROUGH-IN, REFER TO T-SERIES 3. 4. E.C. E.C. TECHNOLOGY EQUIPMENT SCHEDULE AND SPECIFICATIONS FOR DEFINITION INFORMATION OUTLET FACEPLATES, T-SERIES T.C. T.C. JACKS, AND TERMINATIONS CONDUIT SLEEVES (WHEN SHOWN ON T-SERIES E.C. E.C. IDRAWINGS) CONDUIT SLEEVES (NOT SHOWN BUT 2. 4. T.C. T.C. REQUIRED FOR PROPER INSTALLATION OF SYSTEM) TELECOMMUNICATION SYSTEMS E.C. T-SERIES ROUGH-IN TELECOMMUNICATION EQUIPMENT, T.C. T-SERIES CABLING, AND TERMINATIONS LADDER RACK T-SERIES GROUNDING LUGS ON TECHNOLOGY T-SERIES EQUIPMENT BONDING SYSTEM FOR TECHNOLOGY T-SERIES SYSTEM, REFER TO SPECIFICATION SECTION 27 05 26 FOR DEFINITION CONNECTION OF TECHNOLOGY T-SERIES E.C. BONDING SYSTEM TO THE ELECTRICAL GROUND SYSTEM LINE VOLTAGE POWER (+120V OR E-SERIES E.C. IGREATER) LINE VOLTAGE POWER (NOT SHOWN N/A T.C. 2. 4. BUT REQUIRED FOR PROPER INSTALLATION OF SYSTEM) LINE VOLTAGE POWER FOR DOOR E.C. ARCH SPEC HARDWARE POWER SUPPLIES LOW VOLTAGE CABLING FOR T-SERIES T.C. TECHNOLOGY SYSTEMS CABLE HANGERS AND SUPPORTS OR OTHER CABLE ROUTING (OTHER THAN CONDUIT AND CABLE TECHNOLOGY SERVICE ENTRANCE E.C. E.C.

#### SUGGESTED MATRIX OF RESPONSIBILITY NOTES

SERIES

E.C.

E.C.

LOCATIONS OF TELECOMMUNICATIONS ROUGH-INS SHALL BE INDICATED BY THE INFORMATION OUTLET SYMBOLS ON THE DRAWINGS. REFER TO THE TECHNOLOGY SYMBOL LIST FOR ADDITIONAL INFORMATION.

CONDUITS, HANDHOLES, AND

FLOOR BOX (ROUGH-IN)

DIAGRAM.

**IMANHOLE** 

BASED ON THE INHERENT DIFFERENCES IN PRODUCTS FROM VARIOUS MANUFACTURERS, ALL REQUIRED EQUIPMENT MAY NOT BE SHOWN ON THE DRAWINGS FOR ALL ACCEPTABLE MANUFACTURERS.

INCLUDES BACKBOXES AND CONDUIT REQUIRED FOR THE TECHNOLOGY SYSTEMS TALLATION. THE E.C. SHALL BASE THE BID ON THE BASIS OF DESIGN SHOWN ON THE CONTRACT DOCUMENTS.

ALL CHANGES TO THE SLEEVES, BACKBOXES, CONDUITS, AND POWER REQUIRED BECAUSE OF THE T.C.'S SELECTION OF AN ALTERNATE ACCEPTABLE MANUFACTURER OR FROM SYSTEM CONFIGURATIONS THAT ARE LEFT TO THE CHOICE OF THE CONTRACTOR SHALL BE INCLUDED IN THE T.C.'S BID. THIS BID SHALL INCLUDE INSTALLATION BY A LICENSED ELECTRICIAN. UNLESS TRADE RULES DICTATE OTHERWISE.

FURNISHED AS PART OF THE EQUIPMENT WHEN POSSIBLE, OR FURNISHED TO THE E.C. FOR INSTALLATION IN THE FIELD.

INCLUDES ALL CONDUCTORS, GROUND BARS, AND TERMINATIONS FOR THE COMPLETE BONDING SYSTEM REQUIRED BY THE SPECIFICATIONS. REFER TO ELECTRICAL DRAWINGS FOR LOCATIONS OF PANELS AND SWITCHBOARDS SHOWN

IN THE TECHNOLOGY BONDING RISER DIAGRAM AND TYPICAL TELECOM ROOM BONDING FLOW

#### TELECOM ROOM REFERENCES

	DETAIL / SHEET	FLOOR PLAN	
TELECOM ROOM	REFERENCE	REFERENCE	ARCH ROOM NUMBER
MC-1	1/T-400, 2/T-400	TA-101	117
TR-2	3/T-400, 4/T-400	TA-102	218
TR-3	5/T-400, 6/T-400	TBC-101	33
TR-4	1/T-401, 2/T-401	TD-101	40
TR-5	3/T-401, 4/T-401	TI-101	27
TR-6	5/T-401, 6/T-401	TE-101	5
TR-7	5/T-401, 6/T-401	TF-101	5
TR-8	5/T-401, 6/T-401	TG-101	5
TR-9	5/T-401, 6/T-401	TH-101	5
TR-10	5/T-401, 6/T-401	TH.1-101	5
TR-11	1/T-402, 2/T-402	TJ-101	6
TR-12	1/T-402, 2/T-402	TK-101	6

### TECHNOLOGY SHEET INDEX

	TECHNOLOGI SHEET INDEX
T-100	TECHNOLOGY COVERSHEET
T-101	SCHEDULES
T-102	SCHEDULES
T-103	SCHEDULES
TA-101	AA - ADMINISTRATION BUILDING TECHNOLOGY FIRST FLOOR PLAN
TA-102	AA - ADMINISTRATION BUILDING TECHNOLOGY SECOND FLOOR PLAN
TBC-101	AB - MEDICAL CLINIC & AC - MEDICAL DOG BLDG TECHNOLOGY FLOOR PLAN
TD-101	AD - CAT & OTHER ANIMALS BUILDING TECHNOLOGY FLOOR PLAN
TE-101	AE - ADOPTION DOG BUILDING 1 TECHNOLOGY FLOOR PLAN
TF-101	AF - ADOPTION DOG BUILDING 2 TECHNOLOGY FLOOR PLAN
TG-101	AG - ADOPTION DOG BUILDING 3 TECHNOLOGY FLOOR PLAN
TH-101	AH - STRAY DOG BUILDING TECHNOLOGY FLOOR PLAN
TH.1-101	AH.1 - ADOPTION DOG BUILDING 4 TECHNOLOGY FLOOR PLAN
TI-101	AI - SUPPORT BUILDING TECHNOLOGY FLOOR PLAN
TJ-101	AJ - DOG BUILDING TECHNOLOGY FLOOR PLAN
TK-101	AK - DOG BUILDING TECHNOLOGY FLOOR PLAN
TS-101	TECHNOLOGY SITE PLAN
T-200	DETAILS
T-201	DETAILS
T-202	DETAILS
T-203	DETAILS
T-204	DETAILS
T-300	DIAGRAMS
T-301	DIAGRAMS
T-302	DIAGRAMS
T-400	TECHNOLOGY ENLARGED PLANS
T-401	TECHNOLOGY ENLARGED PLANS
T-402	TECHNOLOGY ENLARGED PLANS
GRAND TOTAL	.: 28

#### **TECHNOLOGY GENERAL NOTES:**

- ##-###-# INDICATES TECHNOLOGY EQUIPMENT SCHEDULE ITEM LABELED AS "EQUIPMENT
- REFER TO TECHNOLOGY EQUIPMENT SCHEDULE AND SPECIFICATIONS FOR FULL

DESCRIPTIONS AND MANUFACTURERS OF ALL DEVICES.

TECHNOLOGY MOUNTING SUBSCRIPT KEY: MOUNT AT +6" TO CENTERLINE ABOVE COUNTER OR BACKSPLASH

MOUNT ORIENTED HORIZONTALLY MOUNT IN CASEWOR

A SLASH IS USED BETWEEN TWO SUBSCRIPTS,

MOUNT IN SURFACE RACEWAY

MOUNT IN MODULAR FURNITURE

#### TECHNOLOGY INSTALLATION NOTES:

- 1. THE COMPLETE INSTALLATION SHALL BE IN ACCORDANCE WITH THE ADA STANDARDS FOR ACCESSIBLE DESIGN. REFER TO THE ADA GUIDELINES FOR ALL CONFIGURATION DETAILS ON THIS PAGE FOR ADDITIONAL INFORMATION.

  2. CONCEAL ALL CONDUIT IN WALLS, PARTITIONS, ABOVE CEILING, IN FLOOR SLAB, ETC.
- OTHERWISE INDICATED ON THE PLANS OR IN THE SPECIFICATIONS. CONDUIT IN CAL ROOMS AND STORAGE ROOMS WITHOUT CEILINGS MAY BE EXPOSED ON ILDING STRUCTURE.
- 3. BOXES LOCATED ON OPPOSITE SIDES OF NON-RATED WALLS SHALL BE OFFSET A MINIMUM ZONTALLY. BOXES ON OPPOSITE SIDES OF FIRE RATED WALLS SHALL BE MINIMUM OF 24" HORIZONTALLY. "THRU-THE-WALL" BOXES SHALL NOT BE WITHOUT PRIOR WRITTEN APPROVAL OF THE ARCHITECT/ENGINEER. ALL FURNITURE. MODULAR FURNITURE. AND EQUIPMENT LOCATIONS WITH
- CTURAL PLANS, ELEVATIONS, AND REVIEWED SHOP DRAWINGS. PRIOR TO MAKING TUAL TELECOMMUNICATIONS INSTALLATION. ADJUST OUTLETS OR CONNECTION TIONS TO ACCOMMODATE FURNITURE AND/OR EQUIPMENT. ECOMMUNICATIONS EQUIPMENT SHALL BE MOUNTED TO ALLOW ACCESS TO LECTRICAL AND MECHANICAL EQUIPMENT. ALL MOUNTING OF TELECOMMUNICATION
- DEVICES ON EQUIPMENT SUPPLIED BY ANOTHER CONTRACTOR SHALL BE APPROVED IN ADVANCE BY THE OTHER CONTRACTOR. CONTRACTOR SHALL BE RESPONSIBLE FOR ALL OPENINGS REQUIRED IN WALLS. ALL OPENINGS SHALL BE REPAIRED TO MATCH EXISTING BY A QUALIFIED CONTRACTOR AT THE
- EXPENSE OF THIS CONTRACTOR. ALL CONDUITS THROUGH WALLS SHALL BE GROUTED OR SEALED INTO OPENINGS. ALL MATERIALS USED TO SEAL PENETRATIONS OF FIRE RATED WALLS AND FLOORS SHALL BE TESTED AND CERTIFIED AS A SYSTEM PER ASTM E814 STANDARDS FOR FIRE TESTS OF
- THROUGH-PENETRATION FIRESTOPS. REFER TO DIVISION 7 FOR ADDITIONAL INFORMATION AND REQUIREMENTS SPECIFIC TO FIRESTOPPING. 8. THE TECHNOLOGY CONTRACTOR IS RESPONSIBLE FOR REMOVAL AND REPLACEMENT OF

SPECIFICATION SECTIONS 27 05 28 AND 27 11 00 FOR APPROVED MANUFACTURERS AND

- THE CEILINGS, CEILING TILES, AND CEILING GRID ASSOCIATED WITH THE AREAS OF WORK BY ALL CONTRACTORS ALL LADDER RACK AND CABLE TRAY SIZES ARE AS DEFINED ON THE DRAWINGS. REFER TO
- INSTALLATION REQUIREMENTS. 10. EACH CONTRACTOR IS RESPONSIBLE FOR DAMAGE CAUSED BY THEIR ACTIONS TO THE WALLS, FLOORS, CEILINGS, AND ROOFS. THE CONTRACTOR WHOSE WORK CAUSES DAMAGE IS RESPONSIBLE FOR PATCHING TO MATCH ORIGINAL CONSTRUCTION, FIRE

#### **TECHNOLOGY OUTSIDE PLANT NOTES**

- THE LOCATION OF THE CONDUIT, HAND HOLES AND/OR MAINTENANCE HOLES SHOWN ARE APPROXIMATE LOCATIONS. FIELD VERIFY THE LOCATION OF ALL UTILITIES PRIVATE AND/OR PUBLIC PRIOR TO THE INSTALLATION OF THE COMPONENT. FIELD COORDINATE THE FINAL LOCATION WITH THE OWNER AND ENGINEER PRIOR TO INSTALLATION.
- POTHOLING TO LOCATE EXISTING UNDERGROUND UTILITIES, IF APPLICABLE, SHALL BE INCLUDED IN THE CONTRACTOR'S BID. CONTRACTOR IS RESPONSIBLE FOR FINAL PLACEMENT OF HAND HOLES AND/OR MAINTENANCE HOLES AND SHALL NOTIFY THE
- ENGINEER OF FINAL LOCATIONS PRIOR TO INSTALLATION. HAND HOLES AND/OR MAINTENANCE HOLES SHALL BE CONSTRUCTED SO THAT THE TOP OF
- THE FRAME WILL BE FLUSH WITH THE GROUND LINE. REMOVAL AND REPLACEMENT OF THE EXISTING UNDERGROUND UTILITIES THAT ARE REQUIRED TO COMPLETE THE INSTALLATION SHALL BE INCLUDED IN THE CONTRACTOR'S
- CONTRACTOR SHALL INCLUDE IN THEIR BID ANY REMOVAL AND REPLACEMENT OF EXISTING SIDEWALK, PAVEMENT, GRASS, SHRUBS, TREES, ETC. THAT WILL BE IMPACTED BY THE INSTALLATION OF THE NEW CONDUITS SHOWN ON THE DRAWINGS. IF TREES ARE REQUIRED TO BE REMOVED THE CONTRACTOR SHALL CONTACT THE OWNER AND DISCUSS OPTIONS PRIOR TO CUTTING DOWN ANY TREE OR SHRUB OVER 5' IN HEIGHT.
- 6. NO ADDITIONAL COST SHALL BE APPROVED FOR PLACING CONDUITS DEEPER THAN
- REQUIRED MINIMUM DEPTH. PROVIDE A MINIMUM OF 25'-0" SLACK LOOP WITHIN EACH HAND HOLES AND/OR MAINTENANCE HOLES. SLACK LOOP SHALL BE SECURE SO COPPER OR FIBER IS NOT RESTING ON EARTH AFTER FINAL INSTALLATION.

#### **APPLICABLE CODES AND STANDARDS:**

2022 CALIFORNIA BUILDING STANDARDS ADMINISTRATIVE CODE

CALIFORNIA CODE OF REGULATIONS (CCR) TITLE 24, PART 1

2022 CALIFORNIA BUILDING CODE (CBC) CALIFORNIA CODE OF REGULATIONS TITLE 24, PART 2 (2021 INTERNATIONAL BUILDING CODE (IBC) W/ 2022 CALIFORNIA AMENDMENTS)

2022 CALIFORNIA ELECTRICAL CODE (CEC) CALIFORNIA CODE OF REGULATIONS (CCR) TITLE 24, PART 3 (2020 NATIONAL ELECTRICAL CODE (NEC) W/ 2022 CALIFORNIA AMENDMENTS)

2022 CALIFORNIA ENERGY CODE

2022 CALIFORNIA EXISTING BUILDING CODE

RATING, AND FINISH.

CALIFORNIA CODE OF REGULATIONS (CCR) TITLE 24, PART 6

2022 CALIFORNIA FIRE CODE (CFC) CALIFORNIA CODES OF REGULATIONS (CRR) TITLE 24, PART 9 (2021 INTERNATIONAL FIRE CODE (IFC) W/ 2022 CALIFORNIA AMENDMENTS)


CALIFORNIA CODE OF REGULATIONS (CCR) TITLE 24, PART 10 (2021 INTERNATIONAL EXISTING BUILDING CODE (IEBC))

2022 CALIFORNIA REFERENCES STANDARDS CODE CALIFORNIA DOE OF REGULATIONS (CCR) TITLE 24, PART 12

AMERICANS WITH DISABILITIES ACT (ADA) TITLE II - ACCESSIBILITY GUIDELINES FOR BUILDINGS AND FACILITIES (ADAG) 1990 STATE FIRE MARSHAL REGULATIONS AND AMENDMENTS TO-DATE

CALIFORNIA CODE OF REGULATIONS (CCR) TITLE 24, CALIFORNIA STATE ACCESSIBILITY STANDARDS CALIFORNIA CODE OF REGULATIONS (CCR) TITLE 19

2022 CALIFORNIA GREEN BUILDING STANDARDS CODE (CAL GREEN) CALIFORNIA CODE OF REGULATIONS (CCR) TITLE 24 PART 11

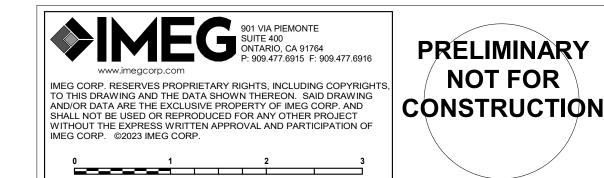




architecture interiors planning



1177 Idaho Street, Suite 200 Redlands, CA 92374 Phone: 909-335-7400 Fax: 909-335-7299 info@miller-aip.com

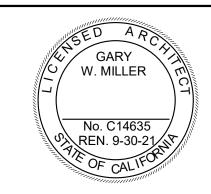

owner approval				
initials date phase				

#### revisions/addenda

# Date Comment

project information

Project Number: Author Drawn By: PS Checked By 05/17/24 Issue Date:

sheet name

**TECHNOLOGY** COVERSHEET

sheet number

T-100

Sheet Of

#### TECHNOLOGY EQUIPMENT SCHEDULE

THE EQUIPMENT LIST ABBREVIATIONS AND THE GENERAL TECHNOLOGY EQUIPMENT SCHEDULE ARE FOR THE CONVENIENCE OF THE CONTRACTOR. EACH CONTRACTOR SHALL BE RESPONSIBLE FOR VERIFICATION OF QUANTITIES AND SHALL FURNISH ALL MATERIAL REQUIRED, WHETHER SPECIFIED OR NOT, TO PRODUCE A SATISFACTORY WORKING SYSTEM.

CATALOG NUMBERS ARE NOT TO BE CONSIDERED COMPLETE BUT ARE GIVEN ONLY TO AID THE CONTRACTOR IN THE SEARCH FOR MATERIAL. NO MATERIAL SHALL BE ORDERED BY MANUFACTURER AND CATALOG NUMBER ONLY. EACH CONTRACTOR SHALL FIRST READ THE COMPLETE DESCRIPTION OF THE MATERIAL ON.

EQUIPMENT LIST ABBREVIATION	EQUIPMENT LIST DESCRIPTION	MANUFACTURER AND MODEL
AC-R1-W	CARD READER. WALL MOUNT, PROVIDED AS INTEGRAL PART OF SECURITY MANAGEMENT SYSTEM. REFER TO	HID SE RP40
	CONTROLLED SECURITY SCHEME (CSS) TYPE SCHEDULE ON T-103 FOR ADDITIONAL INFORMATION. CARD READERS SHOWN ON PLANS TO IDENTIFY INTENDED MOUNTING LOCATION. REFER TO SPECIFICATION SECTION 28 13 00 FOR COMPLETE INFORMATION.	
AC-R2-W	CARD READER. MULLION MOUNT, PROVIDED AS INTEGRAL PART OF SECURITY MANAGEMENT SYSTEM. REFER TO CONTROLLED SECURITY SCHEME (CSS) TYPE SCHEDULE ON T-103 FOR ADDITIONAL INFORMATION. CARD READERS SHOWN ON PLANS TO IDENTIFY	HID SE RP10
AC-R3-W	INTENDED MOUNTING LOCATION. REFER TO SPECIFICATION SECTION 28 13 00 FOR COMPLETE INFORMATION.  CARD READER. WALL MOUNT, PROVIDED AS INTEGRAL	HID
	PART OF SECURITY MANAGEMENT SYSTEM. REFER TO CONTROLLED SECURITY SCHEME (CSS) TYPE SCHEDULE ON T-103 FOR ADDITIONAL INFORMATION. CARD READERS SHOWN ON PLANS TO IDENTIFY INTENDED MOUNTING LOCATION. REFER TO SPECIFICATION SECTION 28 13 00 FOR COMPLETE INFORMATION.	PROXIMITY MAXIPROX 537
AC-SCP-1	ACCESS CONTROL DOOR CONTROL PANEL; DIMENSIONS: 36.12"H x 30.12"W x 7.06"D; WEIGHT (UNLOADED): 60LBS.	ALTRONIX TROVE3M3
AC-SCP-2	CONFIGURE WITH FOLLOWING EQUIPMENT: (2) ALTRONIX AL1024ULXB2 (2) ALTRONIX VR6 (2) ALTRONIX ACMS8 (1) ALTRONIX PDS8 (1) GENETEC SYNERGIS CLOUD LINK (1) MERCURY LP1502 (5) MERCURY MR52 (1) MERCURY MR16IN  ACCESS CONTROL DOOR CONTROL PANEL; PREWIRED	ALTRONIX
7.6 55. 2	MERCURY PANELS FOR 16 DOORS WITH 20A POWER; DIMENSIONS: 36.12"H x 30.12"W x 7.06"D; WEIGHT (UNLOADED): 60LBS.  PROVIDE AND INSTALL GENETEC SYNERGIS CLOUD LINK.	T3M77LCK1
AC-SCP-3	PROVIDE (2) DATA IN CABINET FOR CONNECTION TO OWNER NETWORK.  ACCESS CONTROL DOOR CONTROL PANEL; DIMENSIONS:	ALTRONIX
	36.12"H x 30.12"W x 7.06"D; WEIGHT (UNLOADED): 60LBS.  CONFIGURE WITH FOLLOWING EQUIPMENT: (2) ALTRONIX AL1024ULXB2 (2) ALTRONIX VR6 (2) ALTRONIX ACMS8 (1) ALTRONIX PDS8	TROVE3M3
AC-SCP-4	(5) MERCURY MR52  ACCESS CONTROL DOOR CONTROL PANEL; DIMENSIONS: 27.25"H x 21.75"W x 6.5"D; WEIGHT (UNLOADED): 37.1LBS.	ALTRONIX TROVE2M2
	CONFIGURE WITH FOLLOWING EQUIPMENT: (1) ALTRONIX AL400ULXB2 (1) ALTRONIX PDS16 (1) MERCURY MR16IN	THOVEZINZ
AC-SCP-5	(1) MERCURY MR16OUT  ACCESS CONTROL DOOR CONTROL PANEL; DIMENSIONS: 36.12"H x 30.12"W x 7.06"D; WEIGHT (UNLOADED): 60LBS.  CONFIGURE WITH FOLLOWING EQUIPMENT:	ALTRONIX TROVE3M3
	(1) ALTRONIX AL1024ULXB2 (1) ALTRONIX VR6 (1) ALTRONIX ACMS8 (1) ALTRONIX PDS8 (3) MERCURY MR52 (1) MERCURY MR16IN (1) MERCURY MR16OUT	
AC-SCP-6	ACCESS CONTROL DOOR CONTROL PANEL; DIMENSIONS: 36.12"H x 30.12"W x 7.06"D; WEIGHT (UNLOADED): 60LBS.	ALTRONIX TROVE3M3
AC-SCP-7	CONFIGURE WITH FOLLOWING EQUIPMENT: (2) ALTRONIX AL1024ULXB2 (2) ALTRONIX VR6 (2) ALTRONIX ACMS8 (1) ALTRONIX PDS8 (1) GENETEC SYNERGIS CLOUD LINK (1) MERCURY LP1502 (6) MERCURY MR52  ACCESS CONTROL DOOR CONTROL PANEL; DIMENSIONS:	ALTRONIX
	27.25"H x 21.75"W x 6.5"D; WEIGHT (UNLOADED): 37.1LBS.  CONFIGURE WITH FOLLOWING EQUIPMENT: (1) ALTRONIX AL600ULXB (1) ALTRONIX ACM4 (1) ALTRONIX PDS8 (2) MERCURY MR52 (1) MERCURY MR16IN (1) MERCURY MR16OUT	TROVE2M2
AC-SCP-8	ACCESS CONTROL DOOR CONTROL PANEL; DIMENSIONS: 36.12"H x 30.12"W x 7.06"D; WEIGHT (UNLOADED): 60LBS.	ALTRONIX TROVE3M3
	CONFIGURE WITH FOLLOWING EQUIPMENT: (1) ALTRONIX AL1024ULXB2 (1) ALTRONIX VR6 (1) ALTRONIX ACMS8 (1) ALTRONIX PDS8 (1) GENETEC SYNERGIS CLOUD LINK (1) MERCURY LP1502 (4) MERCURY MR52 (1) MERCURY MR16IN (1) MERCURY MR16OUT	
AC-SS-1	ACCESS CONTROL STROBESWITCH; 200' RANGE; 60° CONICAL; 1.5 SEC. SIGNAL ACQUISITION; 12VDC 4mA, 24VDC 2mA, 24VAC 5mA IDLE CURRENT; SPST RELAY OUTPUT 100mA @ 120VAC; 1/2" FEMALE PIPE MOUNTING BASE.	TOMAR SSLC-1014
AR-AA1-W	AREA OF RESCUE ASSISTANCE CALL STATION. BRUSHED STAINLESS STEEL, FLUSH MOUNT. PROGRAMMABLE WITH UP TO 2 EMERGENCY NUMBERS. RECORDABLE LOCATION MESSAGE, AUTOMATIC DIALER, AUTOMATIC ANSWER FEATURE WITH AUDIBLE RING.	RATH 2100-958NSIP
	PROVIDE WITH 1" CONDUIT TO AREA SERVING TELECOM ROOM. OPWN CABLING IS NOT PERMITTED. INSTALL AT 48" AFF TO PUSH BUTTON.	
AR-AMS-W	AREA OF RESCUE COMMAND CENTER. 10-ZONE, POWDER COATED STEEL ENCLOSURE, FLUSH MOUNT. INCLUDES HANDSET AND SPEAKER PHONE. AUDIBLE ALERTS, LED INDICATORS IDENTITY INDIVIDUAL CALLING STATION. DISTRIBUTION MODULE SHALL BE LOCATED IN TELECOM ROOM. COORDINATE LOCATION WITH OWNER.	RATH 2500-10RCFV
	PROVIDE WITH 1" CONDUIT TO AREA SERVING TELECOM ROOM. OPWN CABLING IS NOT PERMITTED. INSTALL AT 60" AFF TO PUSH BUTTON.	
AV-AMP-1	AUDIO AMPLIFIER; 2x200 WATTS @ 8 OHMS OR 1x350W @ 70V/100V; 1RU, AUDIO INPUT: 2 BALANCED/UNBALANCED,	QSC SPA2-200

#### TECHNOLOGY EQUIPMENT SCHEDULE

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QUIPMENT LIST ABBREVIATION	EQUIPMENT LIST DESCRIPTION  NETWORK AUDIO EXPANDER: (A) LINE OUTPLITS: POF	MANUFACTURER AND MODEL
AV-AO-1	NETWORK AUDIO EXPANDER; (4) LINE OUTPUTS; PoE 802.3AF TYPE 1; QLAN; DIMENSIONS: 8.5" x 4.25" x 1.59"; WEIGHT: 1.72LBS	QSC QIO-L4O
AV-CAM-1	NETWORKED PTZ CONFERENCE CAMERA; PoE CLASS 3; POWER CONSUMPTION: 12.95W; 12x OPTICAL ZOOM; 80° FIELD-OF-VIEW; DIMENSIONS: 6.7" x 7.95" x 5.6"; WEIGHT: 3.5LBS	QSC NC-12x80 ALTERNATES
	4" SQUARE BACKBOX WITH SINGLE GANG PLASTER RING. INSTALL A 3/4" EMT CONDUIT TO ACCESSIBLE CEILING, UNLESS OTHERWISE NOTED, TERMINATE WITH NYLON BUSHING. PROVIDE SINGLE GANG PASS THROUGH COVER PLATE.	AVER VADDIO
AV-EN-1	ABOVE SUSPENDED CEILING ENCLOSURE; 15A POWER OUTLET; MAX EQUIPMENT SIZE: 7.61" x 19.25" x 20"; WEIGHT CAPACITY: 100LBS; DIMENSIONS: 24.97"H x 23.67"W x 8"D; WEIGHT: 4.1LBS	CHIEF CMS492P2 ACCESSORIES
	PROVIDE ALL NECESSARY COMPONENTS TO SUSPEND ENCLOSURE FROM CEILING.	CMSUNV2 CMS1RU ALTERNATES FSR PREMIER MOUNTS
AV-MNT	DISPLAY MOUNT: LARGE SWING ARM WALL DISPLAY MOUNT WITH 25" EXTENSION FOR DISPLAY 42" TO 86" DIA. AND 200 LBS. COORDINATE BLOCKING, AV BOXES AND AC POWER LOCATION REQUIREMENTS ON SITE DURING ROUGH-IN.	CHIEF PNRUB-G
AV-MON-85	85" VIDEO DISPLAY: PROFESSIONAL COMMERCIAL GRADE 85" EDGE LED DISPLAY WITH UHD 3840 x 2160 RESOLUTION, 4000:1 CONTRAST RATIO, 178° VIEWING ANGLE, 350 NITS TYPICAL BRIGHTNESS. INPUTS SHALL INCLUDE HDMI, AUDIO MINI JACK, RS-232 AND IR EXTERNAL CONTROL. STANDARD VESA MOUNTING. TYPICAL DIMENSIONS 74.72" W X 42.55" H x 2.23" D, 86" DIAG. WEIGHT 106.7 LBS	SAMSUNG QB85-B
AV-MP1-C	COORDINATE AC POWER AND BLOCKING AT ROUGH-IN FOR STANDARD WALL MOUNT, UON.  BEAMFORMING CEILING MICROPHONE; POE CLASS 0; POWER CONSUMPTION: 10.11W MAX; AES67/DANTE;	SHURE MXA920S
AV-NVE-1	DIMENSIONS: 23.77"H x 23.77"W x 2.15"D; WEIGHT: 11.8LBS  PROVIDE ALL NECESSARY COMPONENTS TO SUSPEND MICROPHONE FROM CEILING.  NETWORK VIDEO ENDPOINT; ENCODER/DECODER; PoE 802.3BT TYPE 4; (3) HDMI IN, (2) HDMI OUT; 4K60 4:4:4	ALTERNATES SENNHEISER AUDIO-TECHNICA QSC NV-32-H
AV-PM-1	SCALER; RS-232, GPIO, LAN A, LAN B, AUDIO IN, AUDIO OUT; DIMENSIONS: 8.66" x 11.28" x 1.72"; WEIGHT: 4LBS  PROJECTOR MOUNT, WEIGHT 5 LBS, WEIGHT CAPACITY 50LBS.	ALTERNATES CRESTRON EXTRON CHIEF PROJECTOR MOUNT
AV-PRO-1	TO BE USED WITH SUSPENDED CEILING KIT, DIMENSIONS 1.2"H X 24.4"W X 8.0"D, WEIGHT 8LBS, WEIGHT CAPACITY 50LBS.  3LCD VIDEO PROJECTOR, LARGE VENUE, 1920 X 1200	RPAUW CEILING KIT CMA440 EPSON
	WITH 4K ENHANCEMENT, BRIGHTNESS 7000 LUMENS, PROJECTION DISTANCE 12-4" TO 19'-9", DIMENSIONS 21.5"W X 17.2"D X 6.5"H, WEIGHT 39.9LBS	EB-PU1007B  LENS ELPLM08  ALTERNATES PANASONIC
AV-SP1-C	CEILING SPEAKER, 8" TWO-WAY LOUDSPEAKER, 120DB PEAK OUTPUT, MULTIPLE TAP VALUES OF 70V-100, 50, 25, 12.5WATTS, DIMENSIONS 14.9"DIA X 8.3"D, NET WEIGHT 17.5LBS.  REFER TO SPECIFICATION SECTION 27 51 13 FOR	QSC AD-C820R
AV-TP1-S	ADDITIONAL INFORMATION.  TOUCHPANEL - TABLE MOUNT: 10.07" PROJECTIVE CAPACITIVE TOUCHSCREEN WITH 1280X800 RESOLUTION; 400NIT; PoE+ CLASS 4; DIMENSIONS: 6.2"H x 9.97"W x 1.54"D	QSC TSC-101-G3 ACCESSORIES TSC-710T-G3
		ALTERNATES CRESTRON EXTRON
AV-TP1-W	TOUCHPANEL - WALL MOUNT: 7" PROJECTIVE CAPACITIVE TOUCHSCREEN WITH 1280X800 RESOLUTION; 400NIT; PoE CLASS 3; DIMENSIONS: 4.5"H x 7.3"W x 1.54"D  4" SQUARE BACKBOX WITH DOUBLE GANG PLASTER RING.	QSC TSC-70-G3 ALTERNATES CRESTRON
AV-VPS-1	INSTALL A 3/4" EMT CONDUIT TO ACCESSIBLE CEILING, UNLESS OTHERWISE NOTED, TERMINATE WITH NYLON BUSHING.  VIDEO PROJECTION SCREEN, RECESSED CEILING MOUNT.	EXTRON
AV-VP-1	TAB-TENSIONED, TECVISION MS1000X ALR, LOW VOLTAGE CONTROL, QUIET 110V MOTOR, FORMAT 16:10, 65" X 104", 123"DIAG	ULTIMATE ACCESS V ELECTRIC ALTERNATES DALITE
AV-WP1-W	AV WALLPLATE: PASS THROUGH HDMI. 1-PORT. PROVIDE HDMI CABLE BETWEEN SAME TYPE FACEPLATES. PROVIDE 3' HDMI PATCH CABLE AT MONITOR AND 15' HDMI PATCH CORD AT WORKSTATION OUTLET.	CG39710
	4" SQUARE BACKBOX WITH SINGLE GANG PLASTER RING. INSTALL A 3/4" EMT CONDUIT TO ACCESSIBLE CEILING, UNLESS OTHERWISE NOTED, TERMINATE WITH NYLON BUSHING. PROVIDE SINGLE GANG PASS THROUGH COVER PLATE.	
IC-IS-W	INTERCOM STATION; POWER: 12V/2A OR PoE 802.3AF (CLASS 0 - 12.95W); NO/NC CONTACTS, MAX. 20V1A AC/DC; 125kHz/13.56MHz RFID READER; IP69K AND IK10 RATINGS; DIMENSIONS: 9.6"H x 5,4"W x 3.3"D; WEIGHT:5.5LBS	2N IP FORCE 01337-001
ID-DC1	DOOR CONTACT, SURFACE MOUNT CONTACT, 3/16" TO 5/8" GAP, DIMENSIONS .75"H X 4.25"W X .1.5"D, WITH 3' STAINLESS STEEL ARMORED CABLE.  GLASS BREAK DETECTOR, CEILING MOUNT	INTERLOGIX 2706AP-L HONEYWELL
ID-GB-W	GLASS BREAK DETECTOR, WALL MOUNT	FG1625 HONEYWELL
PA-AMP-1	PoE+ IP-TO-ANALOG GATEWAY WITH AMPLIFIER; POWERED VIA 802.3AF, 802.3AT OR LOCAL 24VDC PSU, AMPILIFER POWER RATING: 15W @ 80HM OR 70V (802.3AF), 25W @ 80HM OR 70V (802.3AT); BALANCED AUDIO LINE IN; BALANCED AUDIO LINE OUT; UNBALANCED	FG1625 ATLAS/IED IP-ZCM
PA-S1-C	MICROPHONE INPUT PoE+ INDOOR 1'x2' SUSPENDED CEILING MOUNT IP	ATLAS/IED

IP-12SYSM

SPEAKER WITH TALKBACK MICROPHONE

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EQUIPMENT LIST ABBREVIATION PA-S1-W	EQUIPMENT LIST DESCRIPTION  POE+ INDOOR WALL MOUNT IP HORN SPEAKER WITH LCD DISPLAY	MANUFACTURER AND MODEL  ATLAS/IED IP-SDH
	FLUSH MOUNT: IP-FEST-SD SURFACE MOUNT: IP-SEST-SD	
	INSTALL A 3/4" EMT CONDUIT TO ACCESSIBLE CEILING, UNLESS OTHERWISE NOTED, TERMINATE WITH NYLON BUSHING.	
PA-S2-C	PoE+ INDOOR WALL/CEILING IP SPEAKER WITH TALKBACK MICROPHONE	ATLAS/IED IP-SM
	FLUSH MOUNT: IP-FEST-SD  INSTALL A 3/4" EMT CONDUIT TO ACCESSIBLE CEILING, UNLESS OTHERWISE NOTED, TERMINATE WITH NYLON	
PA-S2-W	BUSHING.	ATLAS/IED IP-HVP
	FLUSH MOUNT: IP-FEST-HVP SURFACE MOUNT: IP-FEST-HVP	
	INSTALL A 3/4" EMT CONDUIT TO ACCESSIBLE CEILING, UNLESS OTHERWISE NOTED, TERMINATE WITH NYLON BUSHING.	
PA-S3-C	PAGING SPEAKER; CEILING MOUNTED; 8" DRIVER; 25V/70V @ 0.25W, 0.5W, 1W, 2W, 5W; POWER RATING: 15W; FREQ. RESPONSE: 54Hz-11.6Hz; 95° CONICAL; SENSITIVITY: 97.9dB @ 1W/1M; MAX SPL: 109.7dB; WEIGHT: 2LBS	LOWELL RPAK-810-72 ATLAS SOUND
SC-CAB-40	INCLUDES ENCLOSURE, TILE-BRIDGE AND GRILLE. EQUIPMENT CABINET, 40 RU MOUNTING SPACES, 72"H X	QUAM VALCOM CHATSWORTH
SC-ER-45		CUBE-IT 13495-772 CHATSWORTH PRODUCTS
	X 15"D X 20.3"W, AVAILABLE WITH 3" DÉEP HOLES. #12-24 TAPPED MOUNTING RAILS. DURABLÉ BLACK POWDER COAT FINISH, MEETS EIA-310-E RÉQUIREMENTS, 1000 LB WEIGHT CAPACITY	55053-703
SC-FDC-2	FIBER OPTIC DISTRIBUTION CABINET, RACK MOUNT 2RU MOUNTING SPACES, ACCOMMODATES A MIN. OF 6 MODULAR ADAPTER PANELS OR MODULES. WELDED	PANDUIT FRME2U
	STEEL CONSTRUCTION, BLACK POWDER-COAT FINISH, INTEGRATED FRONT CABLE MANAGEMENT TROUGH, LOCKABLE.	
SC-FDC-4	FIBER OPTIC DISTRIBUTION CABINET, RACK MOUNT 4RU MOUNTING SPACES, ACCOMMODATES A MIN. OF 12 MODULAR ADAPTER PANELS OR MODULES. WELDED STEEL CONSTRUCTION, BLACK POWDER-COAT FINISH, INTEGRATED FRONT CABLE MANAGEMENT TROUGH, LOCKABLE.	PANDUIT FRME4
SC-GND-1	GROUNDING BUSBAR, WALL MOUNT. 2" H X 12" L X 1/4" D COPPER, ELECTRICALLY ISOLATED BY INSULATORS INTEGRAL TO MOUNTING BRACKETS. COPPER GROUND BAR IS 1/4"	CHATSWORTH 13622-012
	THICK AND STAND OFF 2.75" FROM WALL. THE 12" BUSBAR PROVIDES CONNECTION FOR NINE (9) 2-HOLE COMPRESSION LUGS RESPECTIVELY WITH 5/8" OR 1" CENTERS.	
SC-GND-2	ANSI/TIA-607 AND BICSI COMPLIANT. UL LISTED.  GROUNDING BUSBAR, HORIZONTAL RACK-MOUNT. 1/4" H X 19" L X 3/4" D SOLJD COPPER, ELECTRICALLY ISOLATED	HUBBELL HBBBHR19
	BY INSULATORS INTEGRAL TO STAINLESS STEEL MOUNTING BRACKETS. PROVIDE UNIT CONFIGURED WITH 15 SETS OF 5/16" HOLES SPACED 5/8" ON CENTER TO ACCOMMODATE "A" SPACED TWO-HOLE COMPRESSION LUGS AND 3 SETS OF 7/16" HOLES SPACED 1" ON CENTER TO ACCOMMODATE "C" SPACED TWO-HOLE COMPRESSION LUGS. ANSI/EIA/TIA-607 AND BICSI COMPLIANT. UL LISTED. REFER TO SPECIFICATION 27 11	
SC-HWM-1	00 FOR ADDITIONAL INFORMATION.  HORIZONTAL WIRE MANAGER SINGLE-SIDED, 1 RU MOUNTING SPACES, T-SHAPED CABLE GUIDES WITH	CHATSWORTH 13930-701
SC-HWM-2	SNAP-ON FRONT COVER.  HORIZONTAL WIRE MANAGER SINGLE-SIDED, 2 RU MOUNTING SPACES, T-SHAPED CABLE GUIDES WITH SNAP-ON FRONT COVER.	CHATSWORTH 13930-702
SC-IO-C	INFORMATION OUTLET, CEILING MOUNT, 2-PORT COVERPLATE AS INDICATED ON DRAWINGS.	COMMSCOPE JACK MGS600
	"#" INDICATES INFORMATION OUTLET FACEPLATE CONFIGURATION AS INDICATED ON THE FLOOR PLANS. REFER TO SHEET T-101 FOR INFORMATION OUTLET SCHEDULE FOR PIN CONFIGURATION.	FACEPLATE M12L-246
	INSTALL INFORMATION OUTLET IN A 4" SQUARE BACKBOX WITH A SINGLE GANG PLASTER RING. INSTALL A 1" EMT CONDUIT TO NEAREST ACCESSIBLE CEILING OR UON. PROVIDE REMOVABLE BLANK INSERTS FOR UNUSED PORTS. REFER TO SPECIFICATION SECTION 27 15 00 FOR ADDITIONAL INFORMATION.	
SC-IO-W SC-LRL-12	<pre><varies> HORIZONTAL/VERTICAL LADDER RACK, 18"W TUBULAR</varies></pre>	<varies> CHATSWORTH</varies>
	STEEL CONSTRUCTION, RUST RESISTANT ENAMEL FINISH, REMOVE SHARP BURS FROM LADDER RACK AND REPAINT ALL AREAS THAT HAVE BEEN FIELD MODIFIED, CUT OR EXPOSED. U.L. LISTED.	10250-718
SC-MPP-1	PATCH PANEL, 24-MODULAR RJ-45 TERMINATIONS, CAT 6 MOUNTS DIRECTLY TO EIA/TIA STANDARD 19" RELAY RACK, PORT IDENTIFICATION NUMBERS, PROVIDED WITH COLOR CODING AND LABEL HOLDER KITS, U.L. LISTED. REQUIRES (1) 1.75" MOUNTING SPACES.	COMMSCOPE SYSTIMAX 360-IPR-1100-E-GS3-1U-24
SC-MPP-2	PATCH PANEL, 48-MODULAR RJ-45 TERMINATIONS, CAT 6 MOUNTS DIRECTLY TO EIA/TIA STANDARD 19" RELAY RACK, PORT IDENTIFICATION NUMBERS, PROVIDED WITH COLOR CODING AND LABEL HOLDER KITS, U.L. LISTED. REQUIRES (2) 1.75" MOUNTING SPACES.	COMMSCOPE SYSTIMAX 360-IPR-1100-E-GS3-2U-48
SC-NS-1	NETWORK SWITCH, OWNER PROVIDED, OWNER INSTALLED.	N/A
SC-TTB	TELECOMMUNICATIONS TERMINAL BOARD, 3/4" THICK A-C GRADE FIRE-RATED PLYWOOD. EXPOSED SIDE SHALL BE SMOOTH. MOUNT VERTICALLY WITH TOP OF PLYWOOD AT 8'-6" AFF. IN THE EVENT THE MANUFACTURER'S RATING STAMP IS NOT VISIBLE ON THE SMOOTH SIDE, THE CONTRACTOR SHALL PROVIDE A LAMINATED LETTER FROM THE MANUFACTURER OR SUPPLIER CERTIFYING THAT THE PLYWOOD IS FIRE-RATED AND ATTACH THE LETTER WITH A PICTURE OF THE RATING STAMP, TO THE PLYWOOD. FIRE RATED PLYWOOD SHALL NOT BE PAINTED OR TREATED WITH ANY TYPE OF SEALANT THAT WOULD LESSEN THE INTEGRITY OF THE FIRE RATING.	N/A
SC-VWM-1	DOUBLE SIDED VERTICAL WIRE MANAGER, INCLUDES	CHATSWORTH
	TWO SLACK SPOOLS, 84"H X 6" W X 15.5"D, BLACK POWDER COATED, INCLUDES DUAL HINGED METAL DOOR. INCLUDE CABLE RING KIT #32573-700	32620-703

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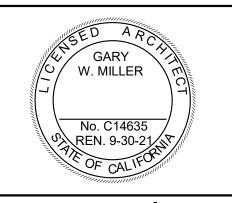
EQUIPMENT LIST ABBREVIATION	EQUIPMENT LIST (		MANUFACTURE MODEL
VS-CM-1	SINGLE VARIFOCAL LENS INTER CAMERA. WALL MOUNTED. 2 ME FORENSIC WIDE DYNAMIC RANG NO CONNECTIVITY. VIDEO COMP MOTION JPEG; CASING: IP66-RA IMPACT-RESISTANT CASING WIT POWER: TYPICAL 4.8W, MAX 10.7 CONDITIONS: -40 TO 50 DEG C.; -40-65 DEG C. INCLUDES VANDA	GAPIXEL. FEATURES GE, TWO-WAY AUDIO, AND PRESSION: H.264, H.265, TED; IK RATING; IK10 TH HARD-COATED DOME; TW; OPERATING STORAGE CONDITIONS:	AXIS P3265-LVE 9MM
	INFORMATION OUTLET FOR CAN TERMINATED ON A RJ-45 JACK. I INFORMATION OUTLET SCHEDU ADDITIONAL INFORMATION PIN (	REFER TO THE LE ON SHEET T-102 FOR	
	THE GENERAL TECHNOLOGY ECONLY DESCRIBES CAMERA SER INFORMATION. REFER TO INDIVION SHEET T-102 FOR ADDITIONAL INDIVIDUAL CAMERA REQUIREM	IES AND PERFORMANCE IDUAL CAMERA SCHEDULE AL INFORMATION ON	
VS-CM-2	SINGLE VARIFOCAL LENS INTER MOUNTED. 2 MEGAPIXEL. FEATU DYNAMIC RANGE, TWO-WAY AU CONNECTIVITY. VIDEO COMPRE MOTION JPEG; CASING: IP52-RA IMPACT-RESISTANT CASING WIT POWER: TYPICAL 3W, MAX 5.1W 0 TO 50 DEG C.; INCLUDES VAND	JRES FORENSIC WIDE DIO, AND I/O SSION: H.264, H.265, TED; IK RATING; IK10 TH HARD-COATED DOME; ; OPERATING CONDITIONS:	AXIS P3265-V
·	INFORMATION OUTLET FOR CAN TERMINATED ON A RJ-45 JACK. I INFORMATION OUTLET SCHEDU ADDITIONAL INFORMATION PIN (	REFER TO THE LE ON SHEET T-102 FOR	
	THE GENERAL TECHNOLOGY ECONLY DESCRIBES CAMERA SER INFORMATION. REFER TO INDIVION SHEET T-102 FOR ADDITIONAL INDIVIDUAL CAMERA REQUIREM	IES AND PERFORMANCE 'IDUAL CAMERA SCHEDULE AL INFORMATION ON	
VS-CM-3	DUAL SENSOR VARIFOCAL INTE CAMERA. 2*2 MEGAPIXEL. ENAB DETAILED SURVEILLANCE WITH FEATURES FORENSIC WIDE DYN CONNECTIVITY. VIDEO COMPRE MOTION JPEG; CASING: IP66 -R/IMPACT-RESISTANT CASING WITPOWER: TYPICAL 8.3W, MAX 17.5 CONDITIONS: -30 TO 50 DEG C.; -40 TO 65 DEG C. INCLUDES VAN	BLING OVERVIEW AND ONE IP ADDRESS. NAMIC RANGE, AND I/O SSION: H.264, H.265, ATED; IK RATING; IK10 TH HARD-COATED DOME; 5W; OPERATING STORAGE CONDITIONS:	AXIS P4705-PVE
	INFORMATION OUTLET FOR CAN ON A RJ-45 JACK. REFER TO THE SCHEDULE ON SHEET T-102 FOR INFORMATION.	E INFORMATION OUTLET	
	THE GENERAL TECHNOLOGY ECONLY DESCRIBES CAMERA SER INFORMATION. REFER TO INDIVION SHEET T-102 FOR ADDITIONAL INDIVIDUAL CAMERA REQUIREM	IES AND PERFORMANCE IDUAL CAMERA SCHEDULE AL INFORMATION ON	
VS-CM-4	360° MULTI-LENS (4) INTERIOR/E MEGAPIXEL. ENABLING OVERVIE SURVEILLANCE WITH ONE IP AD DYNAMIC RANGE, OPTIONAL TW CONNECTIVITY. VIDEO COMPRE MOTION JPEG; CASING: IP66-RAIMPACT-RESISTANT CASING WIT POWER: TYPICAL 16.3W, MAX 25 CONDITIONS: -30-50 DEG C.; INC RESISTANT SCREWS.	EW AND DETAILED DRESS. FEATURES WIDE 'O-WAY AUDIO, AND I/O SSION: H.264, H.265, ITED; IK RATING; IK09 TH HARD-COATED DOME; I.5W; OPERATING	AXIS P3719-PLE
	INFORMATION OUTLET FOR CAN TERMINATED ON AN RJ-45 PLUG INFORMATION OUTLET SCHEDU ADDITIONAL INFORMATION.	REFER TO THE	
	THE TECHNOLOGY EQUIPMENT DESCRIBES CAMERA SERIES AN INFORMATION. REFER TO INDIV ON SHEET T-102 FOR ADDITIONA INDIVIDUAL CAMERA REQUIREM	ID PERFORMANCE IDUAL CAMERA SCHEDULE AL INFORMATION ON	
VS-CM-5	SINGLE VARIFOCAL LENS EXTERMOUNTED. 2 MEGAPIXEL. FEATUDYNAMIC RANGE, TWO-WAY AUCONNECTIVITY. VIDEO COMPREMOTION JPEG; CASING: IP66 -RIMPACT-RESISTANT CASING WITPOWER: TYPICAL 4.8W, MAX 10.7 CONDITIONS: -40 TO 50 DEG C.; 3-40 TO 65 DEG C. INCLUDES VAN AXIS LICENSE PLATE VERIFIER F	JRES FORENSIC WIDE DIO, AND I/O SSION: H.264, H.265, ATED; IK RATING; IK10 TH HARD-COATED DOME; TW; OPERATING STORAGE CONDITIONS: IDAL RESISTANT SCREWS.	AXIS P3265-LVE-3
	INFORMATION OUTLET FOR CAN TERMINATED ON A RJ-45 JACK. I INFORMATION OUTLET SCHEDU ADDITIONAL INFORMATION PIN (	REFER TO THE LE ON SHEET T-102 FOR	
	THE GENERAL TECHNOLOGY ECONLY DESCRIBES CAMERA SER INFORMATION. REFER TO INDIVION SHEET T-102 FOR ADDITIONAL INDIVIDUAL CAMERA REQUIREM	IES AND PERFORMANCE IDUAL CAMERA SCHEDULE AL INFORMATION ON	
VS-CON-1	RACK MOUNT CONSOLE; 1U RAC PS/2, USB 2.0, VGA/SVGA; RESO @ 60Hz; ELECTRICAL CONSUMP	LUTION: UP TO 1920x1080 TION: 30W/5W STANDBY	TRIPP LITE B021-000-19-HD2
VS-NVS-1	NETWORK VIDEO SERVER; 2RU 120VAC @ 9.17A; DIMENSIONS: 3 WEIGHT: 88.2LBS		MILESTONE HUSKY IVO 1800
	REFER TO SPECIFICATION SECT ADDITIONAL INFORMATION.	TION 28 23 00 FOR	



architecture interiors planning



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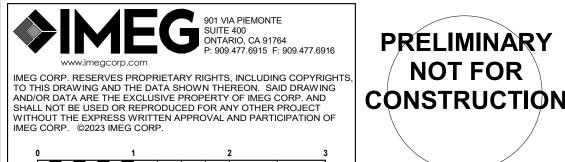
### project information

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Author

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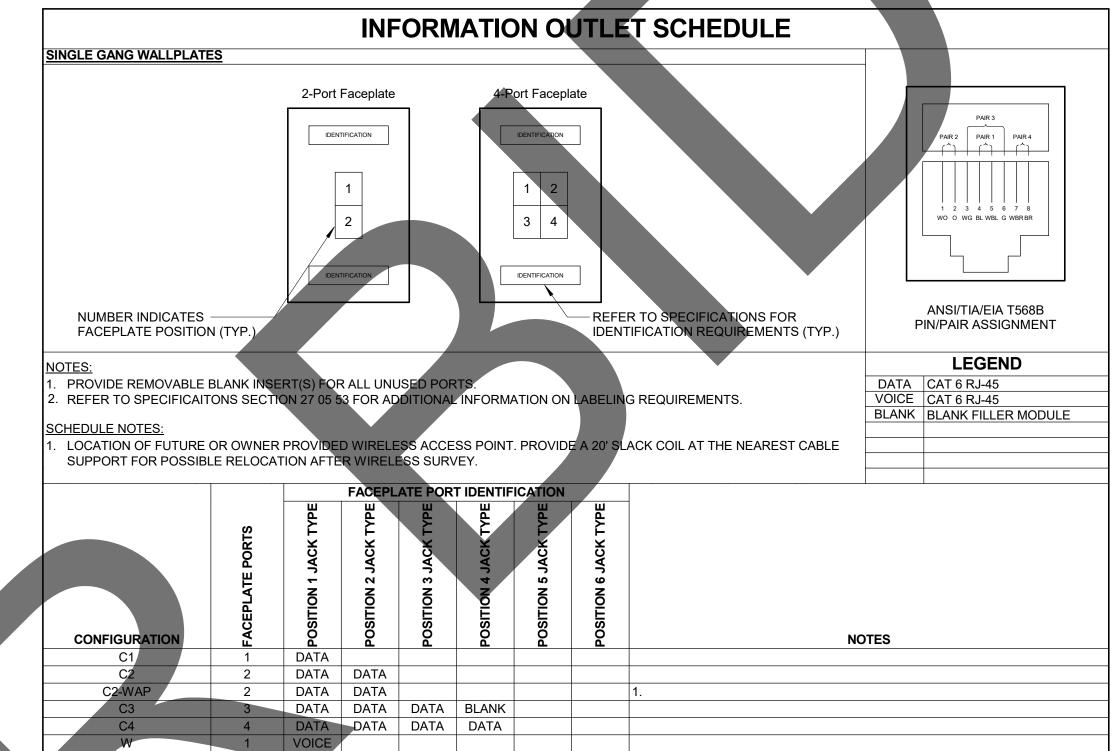
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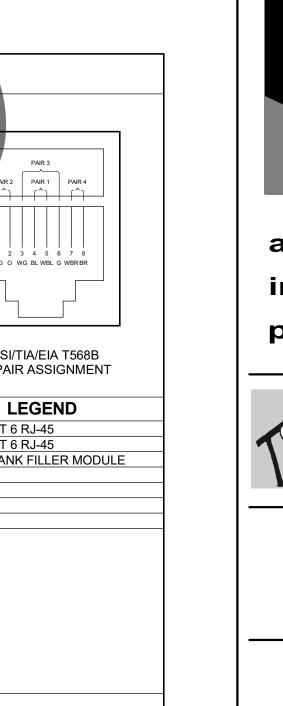


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T-101

				INDIVIDUA	L CAMERA REQU	JIREMEN	NTS SCH	ΙΕD	ULE	
			TELECOM			MOUNTING	DETAIL	FRAME RATE	PERCENT MOTION	
	CAMERA TYPE	CAMERA ENVIRONMENT	ROOM #	LOCATION	FIELD OF VIEW DESCRIPTION	TYPE	REFERENCE			ADDITIONAL INFORMATION NOTES
AA-134	CM-2	INDOOR	MC-1	ADOPTION VESTIBULE 134	ADOPTION ENTRANCE	CEILING	1/T-201	25	100	
AA-138	CM-2	INDOOR	MC-1	ADMISSION VESTIBULE 138	ADMISSION ENTRANCE	CEILING	1/T-201	25	100	
AB-12	CM-2	INDOOR	TR-3	MEDICAL LOBBY 12	CLINIC ENTRANCE	CEILING	1/T-201	25	100	
AC-21	CM-1	INDOOR/OUTDOOR	TR-3	HALL 21	CORRIDOR, DOG KENNELS	WALL	2/T-201	25	100	MINIMUM IP66 RATING
AC-23 AC-24	CM-1	INDOOR/OUTDOOR INDOOR/OUTDOOR	TR-3	CORRIDOR 23  MEDICAL ISOLATION 24	CORRIDOR, ELECTRICAL ROOM, DOG KENNELS CORRIDOR, DOG KENNELS	WALL	2/T-201 2/T-201	25 25	100	MINIMUM IP66 RATING  MINIMUM IP66 RATING
AC-24 AC-25	CM-3	INDOOR/OUTDOOR	TR-3	FOSTER/FLEX 25	CORRIDOR, DOG KENNELS	WALL	2/T-201	25	100	MINIMUM IP66 RATING
AC-26	CM-1	INDOOR/OUTDOOR	TR-3	CORRIDOR 26	CORRIDOR, DOG KENNELS	WALL	2/T-201	25	100	MINIMUM IP66 RATING
AC-29	CM-1	INDOOR/OUTDOOR	TR-3	HALL 29	CORRIDOR 32	WALL	2/T-201	25	100	MINIMUM IP66 RATING
AC-30	CM-3	INDOOR/OUTDOOR	TR-3	MEDICAL OBSERVATION 30	CORRIDOR, DOG KENNELS	WALL	2/T-201	25	100	MINIMUM IP66 RATING
AC-31	CM-3	INDOOR/OUTDOOR	TR-3	MEDICAL OBSERVATION 31	CORRIDOR, DOG KENNELS	WALL	2/T-201	25	100	MINIMUM IP66 RATING
AE-7	CM-1	INDOOR/OUTDOOR	TR-6	OUTDOOR RUN 7	CORRIDOR, DOG KENNELS	WALL	2/T-201	25	100	MINIMUM IP66 RATING
AE-8 AE-9	CM-1 CM-1	INDOOR/OUTDOOR INDOOR/OUTDOOR	TR-6	OUTDOOR RUN 8 OUTDOOR RUN 9	CORRIDOR, DOG KENNELS CORRIDOR, DOG KENNELS	WALL WALL	2/T-201 2/T-201	25 25	100 100	MINIMUM IP66 RATING MINIMUM IP66 RATING
AE-10	CM-1	INDOOR/OUTDOOR	TR-6	OUTDOOR RUN 10	CORRIDOR, DOG KENNELS	WALL	2/T-201	25	100	MINIMUM IP66 RATING
AE-11	CM-4	INDOOR/OUTDOOR	TR-6	DOG POD 11	DOG KENNELS	CEILING	3/T-201	25	100	MINIMUM IP66 RATING
AE-12	CM-4	INDOOR/OUTDOOR	TR-6	DOG POD 12	DOG KENNELS	CEILING	3/T-201	25	100	MINIMUM IP66 RATING
AF-7	CM-1	INDOOR/OUTDOOR	TR-7	OUTDOOR RUN 7	CORRIDOR, DOG KENNELS	WALL	2/T-201	25	100	MINIMUM IP66 RATING
AF-8	CM-1	INDOOR/OUTDOOR	TR-7	OUTDOOR RUN 8	CORRIDOR, DOG KENNELS	WALL	2/T-201	25	100	MINIMUM IP66 RATING
AF-9 AF-10	CM-1 CM-1	INDOOR/OUTDOOR INDOOR/OUTDOOR	TR-7	OUTDOOR RUN 9 OUTDOOR RUN 10	CORRIDOR, DOG KENNELS CORRIDOR, DOG KENNELS	WALL	2/T-201 2/T-201	25 25	100 100	MINIMUM IP66 RATING MINIMUM IP66 RATING
AF-10 AF-11	CM-4	INDOOR/OUTDOOR	TR-7	DOG POD 11	DOG KENNELS	CEILING	3/T-201	25	100	MINIMUM IP66 RATING
AF-12	CM-4	INDOOR/OUTDOOR	TR-7	DOG POD 12	DOG KENNELS	CEILING	3/T-201	25	100	MINIMUM IP66 RATING
AG-7	CM-1	INDOOR/OUTDOOR	TR-8	OUTDOOR RUN 7	CORRIDOR, DOG KENNELS	WALL	2/T-201	25	100	MINIMUM IP66 RATING
AG-8	CM-1	INDOOR/OUTDOOR	TR-8	OUTDOOR RUN 8	CORRIDOR, DOG KENNELS	WALL	2/T-201	25	100	MINIMUM IP66 RATING
AG-9	CM-1	INDOOR/OUTDOOR	TR-8	OUTDOOR RUN 9	CORRIDOR, DOG KENNELS	WALL	2/T-201	25	100	MINIMUM IP66 RATING
AG-10	CM-1	INDOOR/OUTDOOR	TR-8	OUTDOOR RUN 10	CORRIDOR, DOG KENNELS  DOG KENNELS	WALL	2/T-201	25	100 100	MINIMUM IP66 RATING
AG-11 AG-12	CM-4 CM-4	INDOOR/OUTDOOR INDOOR/OUTDOOR	TR-8	DOG POD 11 DOG POD 12	DOG KENNELS  DOG KENNELS	CEILING CEILING	3/T-201 3/T-201	25 25	100	MINIMUM IP66 RATING MINIMUM IP66 RATING
AH-7	CM-4	INDOOR/OUTDOOR	TR-9	OUTDOOR RUN 7	CORRIDOR, DOG KENNELS	WALL	2/T-201	25	100	MINIMUM IP66 RATING
AH-8	CM-1	INDOOR/OUTDOOR	TR-9	OUTDOOR RUN 8	CORRIDOR, DOG KENNELS	WALL	2/T-201	25	100	MINIMUM IP66 RATING
AH-9	CM-1	INDOOR/OUTDOOR	TR-9	OUTDOOR RUN 9	CORRIDOR, DOG KENNELS	WALL	2/T-201	25	100	MINIMUM IP66 RATING
AH-10	CM-1	INDOOR/OUTDOOR	TR-9	OUTDOOR RUN 10	CORRIDOR, DOG KENNELS	WALL	2/T-201	25	100	MINIMUM IP66 RATING
AH-11	CM-4	INDOOR/OUTDOOR	TR-9	DOG POD 11	DOG KENNELS	CEILING	3/T-201	25	100	MINIMUM IP66 RATING
AH-12 AH.1-7	CM-4 CM-1	INDOOR/OUTDOOR INDOOR/OUTDOOR	TR-9 TR-10	DOG POD 12 OUTDOOR RUN 7	DOG KENNELS CORRIDOR, DOG KENNELS	CEILING WALL	3/T-201 2/T-201	25 25	100 100	MINIMUM IP66 RATING MINIMUM IP66 RATING
AH.1-8	CM-1	INDOOR/OUTDOOR	TR-10	OUTDOOR RUN 8	CORRIDOR, DOG KENNELS	WALL	2/T-201	25	100	MINIMUM IP66 RATING
AH.1-9	CM-1	INDOOR/OUTDOOR	TR-10	OUTDOOR RUN 9	CORRIDOR, DOG KENNELS	WALL	2/T-201	25	100	MINIMUM IP66 RATING
AH.1-10	CM-1	INDOOR/OUTDOOR	TR-10	OUTDOOR RUN 10	CORRIDOR, DOG KENNELS	WALL	2/T-201	25	100	MINIMUM IP66 RATING
AH.1-11	CM-4	INDOOR/OUTDOOR	TR-10	DOG POD 11	DOG KENNELS	CEILING	3/T-201	25	100	MINIMUM IP66 RATING
AH.1-12	CM-4	INDOOR/OUTDOOR	TR-10	DOG POD 12	DOG KENNELS	CEILING	3/T-201	25	100	MINIMUM IP66 RATING
AJ-1	CM-1	INDOOR/OUTDOOR	TR-11	OUTDOOR RUN 1	CORRIDOR, DOG KENNELS	WALL	2/T-201	25	100	MINIMUM IP66 RATING
AJ-2 AJ-3	CM-4 CM-1	INDOOR/OUTDOOR INDOOR/OUTDOOR	TR-11 TR-11	DOG POD 2 OUTDOOR RUN 2	DOG KENNELS CORRIDOR, DOG KENNELS	CEILING WALL	3/T-201 2/T-201	25 25	100 100	MINIMUM IP66 RATING MINIMUM IP66 RATING
AK-1	CM-1	INDOOR/OUTDOOR	TR-12	OUTDOOR RUN 1	CORRIDOR, DOG KENNELS	WALL	2/T-201	25	100	MINIMUM IP66 RATING
AK-2	CM-4	INDOOR/OUTDOOR	TR-12	DOG POD 2	DOG KENNELS	CEILING	3/T-201	25	100	MINIMUM IP66 RATING
AK-3	CM-1	INDOOR/OUTDOOR	TR-12	OUTDOOR RUN 2	CORRIDOR, DOG KENNELS	WALL	2/T-201	25	100	MINIMUM IP66 RATING
AS-01	CM-5	OUTDOOR	MC-1	ENTRY GATE	EXTERIOR, VEHICLE ENTRANCE	POLE		25	100	LICENSE PLATE READER
AS-02 AS-03	CM-4 CM-4	OUTDOOR OUTDOOR	TR-5 TR-11	BLDG. AI EXTERIOR BLDG. AJ EXTERIOR	EXTERIOR, PARKING EXTERIOR. PAVILION	CORNER CORNER		25 25	100 100	
AS-03 AS-04	CM-4	OUTDOOR	TR-11	BLDG. AK EXTERIOR  BLDG. AK EXTERIOR	EXTERIOR, PAVILION  EXTERIOR, WASH AREA, DUMPSTERS, PARKING	CORNER		25	100	
AS-05	CM-4	OUTDOOR	TR-10	BLDG. AH.1 EXTERIOR	EXTERIOR, PARKING	CORNER		25	100	
AS-06	CM-4	OUTDOOR	TR-6	BLDG. AE EXTERIOR	EXTERIOR, EMERGENCY	CORNER		25	100	
AS-07	CM-4	OUTDOOR	TR-3	BLDG. AB EXTERIOR	GENERATOR, PARKING EXTERIOR, VEHICLE EXIT,	CORNER		25	100	
40.00	ON4 4	OUTDOOD	TD 4	DIDO AD EVIEDIOD	PARKING	CODNED		25	100	
AS-08 AS-09	CM-4 CM-4	OUTDOOR OUTDOOR	TR-4 MC-1	BLDG. AD EXTERIOR BLDG. AA EXTERIOR	EXTERIOR, PAVILION EXTERIOR, VEHICLE ENTRANCE, PARKING	CORNER CORNER		25 25	100	







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owner approval													
initials	date	phase											

#### revisions/addenda

Comment # Date

### project information

Project Number: Drawn By: Author PS Checked By: 05/17/24 Issue Date:


sheet name

Sheet

SCHEDULES

T-102

Of

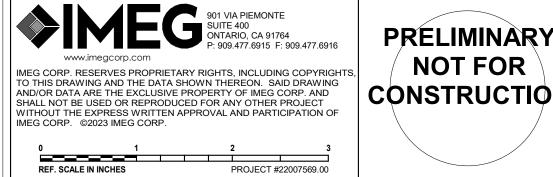

PRELIMINARY sheet number CONSTRUCTION

AF-12B AF-25

AG-5

R1

R1


AG-6 R1

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	0	R TO ES)	EFEI NOTE	(R 	1			R HAF ONIT		D	IT	QUE O EX			N	TION	GRA	NTE	II.			DEN <sup>*</sup>	CRE RE	
	VISUAL STROBE/AUDIBLE ALARM	LE BASED LOCKIN	LOCAL 120VAC POWER SUPPLY	DELAYED EGRESS (BY OTHERS)		MONITOR DOOR POSITION SWITCH SPDT	MONITOR LATCH BOLT (BY OTHERS)	LATCH STATUS DETECTION (BY OTHERS)	MAG LOCK	ELECTRONIC LOCKING HARDWARE (BY OTHERS)	INTERNAL ELECTRIFIED HARDWARE CONNECTION (BY OTHERS)	LOCAL PUSHBUTTON DOOR HARDWARE OVERRIDE	MOTION DETECTOR	VIDEO SURVEILLANCE	REMOTE UNLOCK VIA FIRE COMMAND CENTER	INTRUSION DETECTION	REMOTE UNLOCK VIA PUSHBUTTON	REMOTE UNLOCK VIA INTERCOM MASTER	LOCKED BY EMERGENCY DURESS SEQUENCE	AUTOMATIC DOOR OPERATOR	OPERATES MULTIPLE DOORS	MULTIPLE CREDENTIAL READERS OPERATES SINGLE DOOR	CREDENTIAL READER TYPE	
NOTES	<b>S</b>	SC	2	<u> </u>	<u>S</u>	•	¥	4	M	•	Ξ	2	<b>E</b>		R	Z	A H	<b>8</b>	2	AU	Q	M	R1 R1	<b>R #</b> 01 05
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#### CONTROLLED SECURITY SCHEME (CSS) TYPE SCHEDULE

1. ELECTRONIC DOOR HARDWARE SUCH AS ELECTRIC STRIKES, ELECTRIC LATCH RETRACTION, ETC. SHALL BE PROVIDED AND INSTALLED BY OTHERS.
2. REFER TO THE TECHNOLOGY EQUIPMENT SCHEDULE FOR CREDENTIAL READER TYPE INFORMATION.

			DEN EADI	ITIAL ER		I	NTE	GRA	TION	١			QUE O EX		C	000F M	R HAI ONIT	RDW ORIN	ARE	I	(F	OTI- REFE NOT	IER ER T ES)	0	
	DOOR #	CREDENTIAL READER TYPE	MULTIPLE CREDENTIAL READERS OPERATES SINGLE DOOR	OPERATES MULTIPLE DOORS	AUTOMATIC DOOR OPERATOR	LOCKED BY EMERGENCY DURESS SEQUENCE	REMOTE UNLOCK VIA INTERCOM MASTER	REMOTE UNLOCK VIA PUSHBUTTON	INTRUSION DETECTION	REMOTE UNLOCK VIA FIRE COMMAND CENTER	VIDEO SURVEILLANCE	MOTION DETECTOR	LOCAL PUSHBUTTON DOOR HARDWARE OVERRIDE	INTERNAL ELECTRIFIED HARDWARE CONNECTION (BY OTHERS)	ELECTRONIC LOCKING HARDWARE (BY OTHERS)	MAG LOCK	LATCH STATUS DETECTION (BY OTHERS)	MONITOR (LATCH BOLT (BY OTHERS)	MONITOR DOOR POSITION SWITCH SPDT	MONITOR DOOR POSITION SWITCH DPDT	DELAYED EGRESS (BY OTHERS)	LOCAL 120VAC POWER SUPPLY	SCHEDULE BASED LOCKING	VISUAL STROBE/AUDIBLE ALARM	NOTES
	DOOR #	R1	Σ	O	4	ĭ	<u>~</u>	~	Z	<u>~</u>	5	Ž	Ľ	Z	•	Ž	ב	Ž	Š	Ž	۵	<u>۲</u>	S(	5	NOTES
-	AG-7A AG-8E	R1 R1													•				•						
-	AG-9 AG-9E	R1													•				•						
-	AG-10A AG-11A	R1 R1													•				•						
	AG-12B AG-25	R1													•				•						
	AH-5 AH-6	R1 R1 R1													•				•						
	AH-6A AH-7A	R1 R1													•				•						
-	AH-8E AH-9	R1													•				•						
-	AH-9E AH-10A	R1 R1													•				•						
	AH-11A AH-12B	R1 R1													•				•						
	AH-25 AH.1-2	R1 R1													•				•						
	AH.1-6A	R1													•				•						
	AH.1-7A AH.1-8E AH.1-9	R1 R1													•				•						
	AH.1-9E AH.1-10A	R1 R1													•				•						
-	AH.1-11A AH.1-12B	R1 R1													•				•						
-	AH.1-25 AI-1B	R1 R1													•				•						
-	Al-1D Al-2	R1 R1													•				•						
	AI-2B AI-8	R1 R1													•				•						
-	AI-9A AI-14A	R1 R1													•				•						
-	Al-16 Al-18	R1 R1													•				•						
-	Al-20 Al-21	R1 R1													•				•						
	AI-21A AI-22	R1 R1													•				•						
	AI-23 AI-24	R1 R1													•				•						
	AI-25 AI-26	R1 R1													•				•						
	AJ-1 AJ-2	R1 R1													•				•						
F	AJ-3 AJ-5	R1 R1													•				•						
Ĺ	AJ-9	R1													•				•						



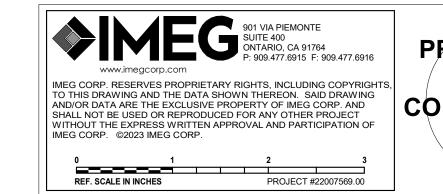





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owner	owner approval												
initials	date	phase											

### revisions/addenda

Comment

project information

Author

PS


Project Number: Drawn By: Checked By: 05/17/24 Issue Date:

sheet name

SCHEDULES


sheet number

T-103

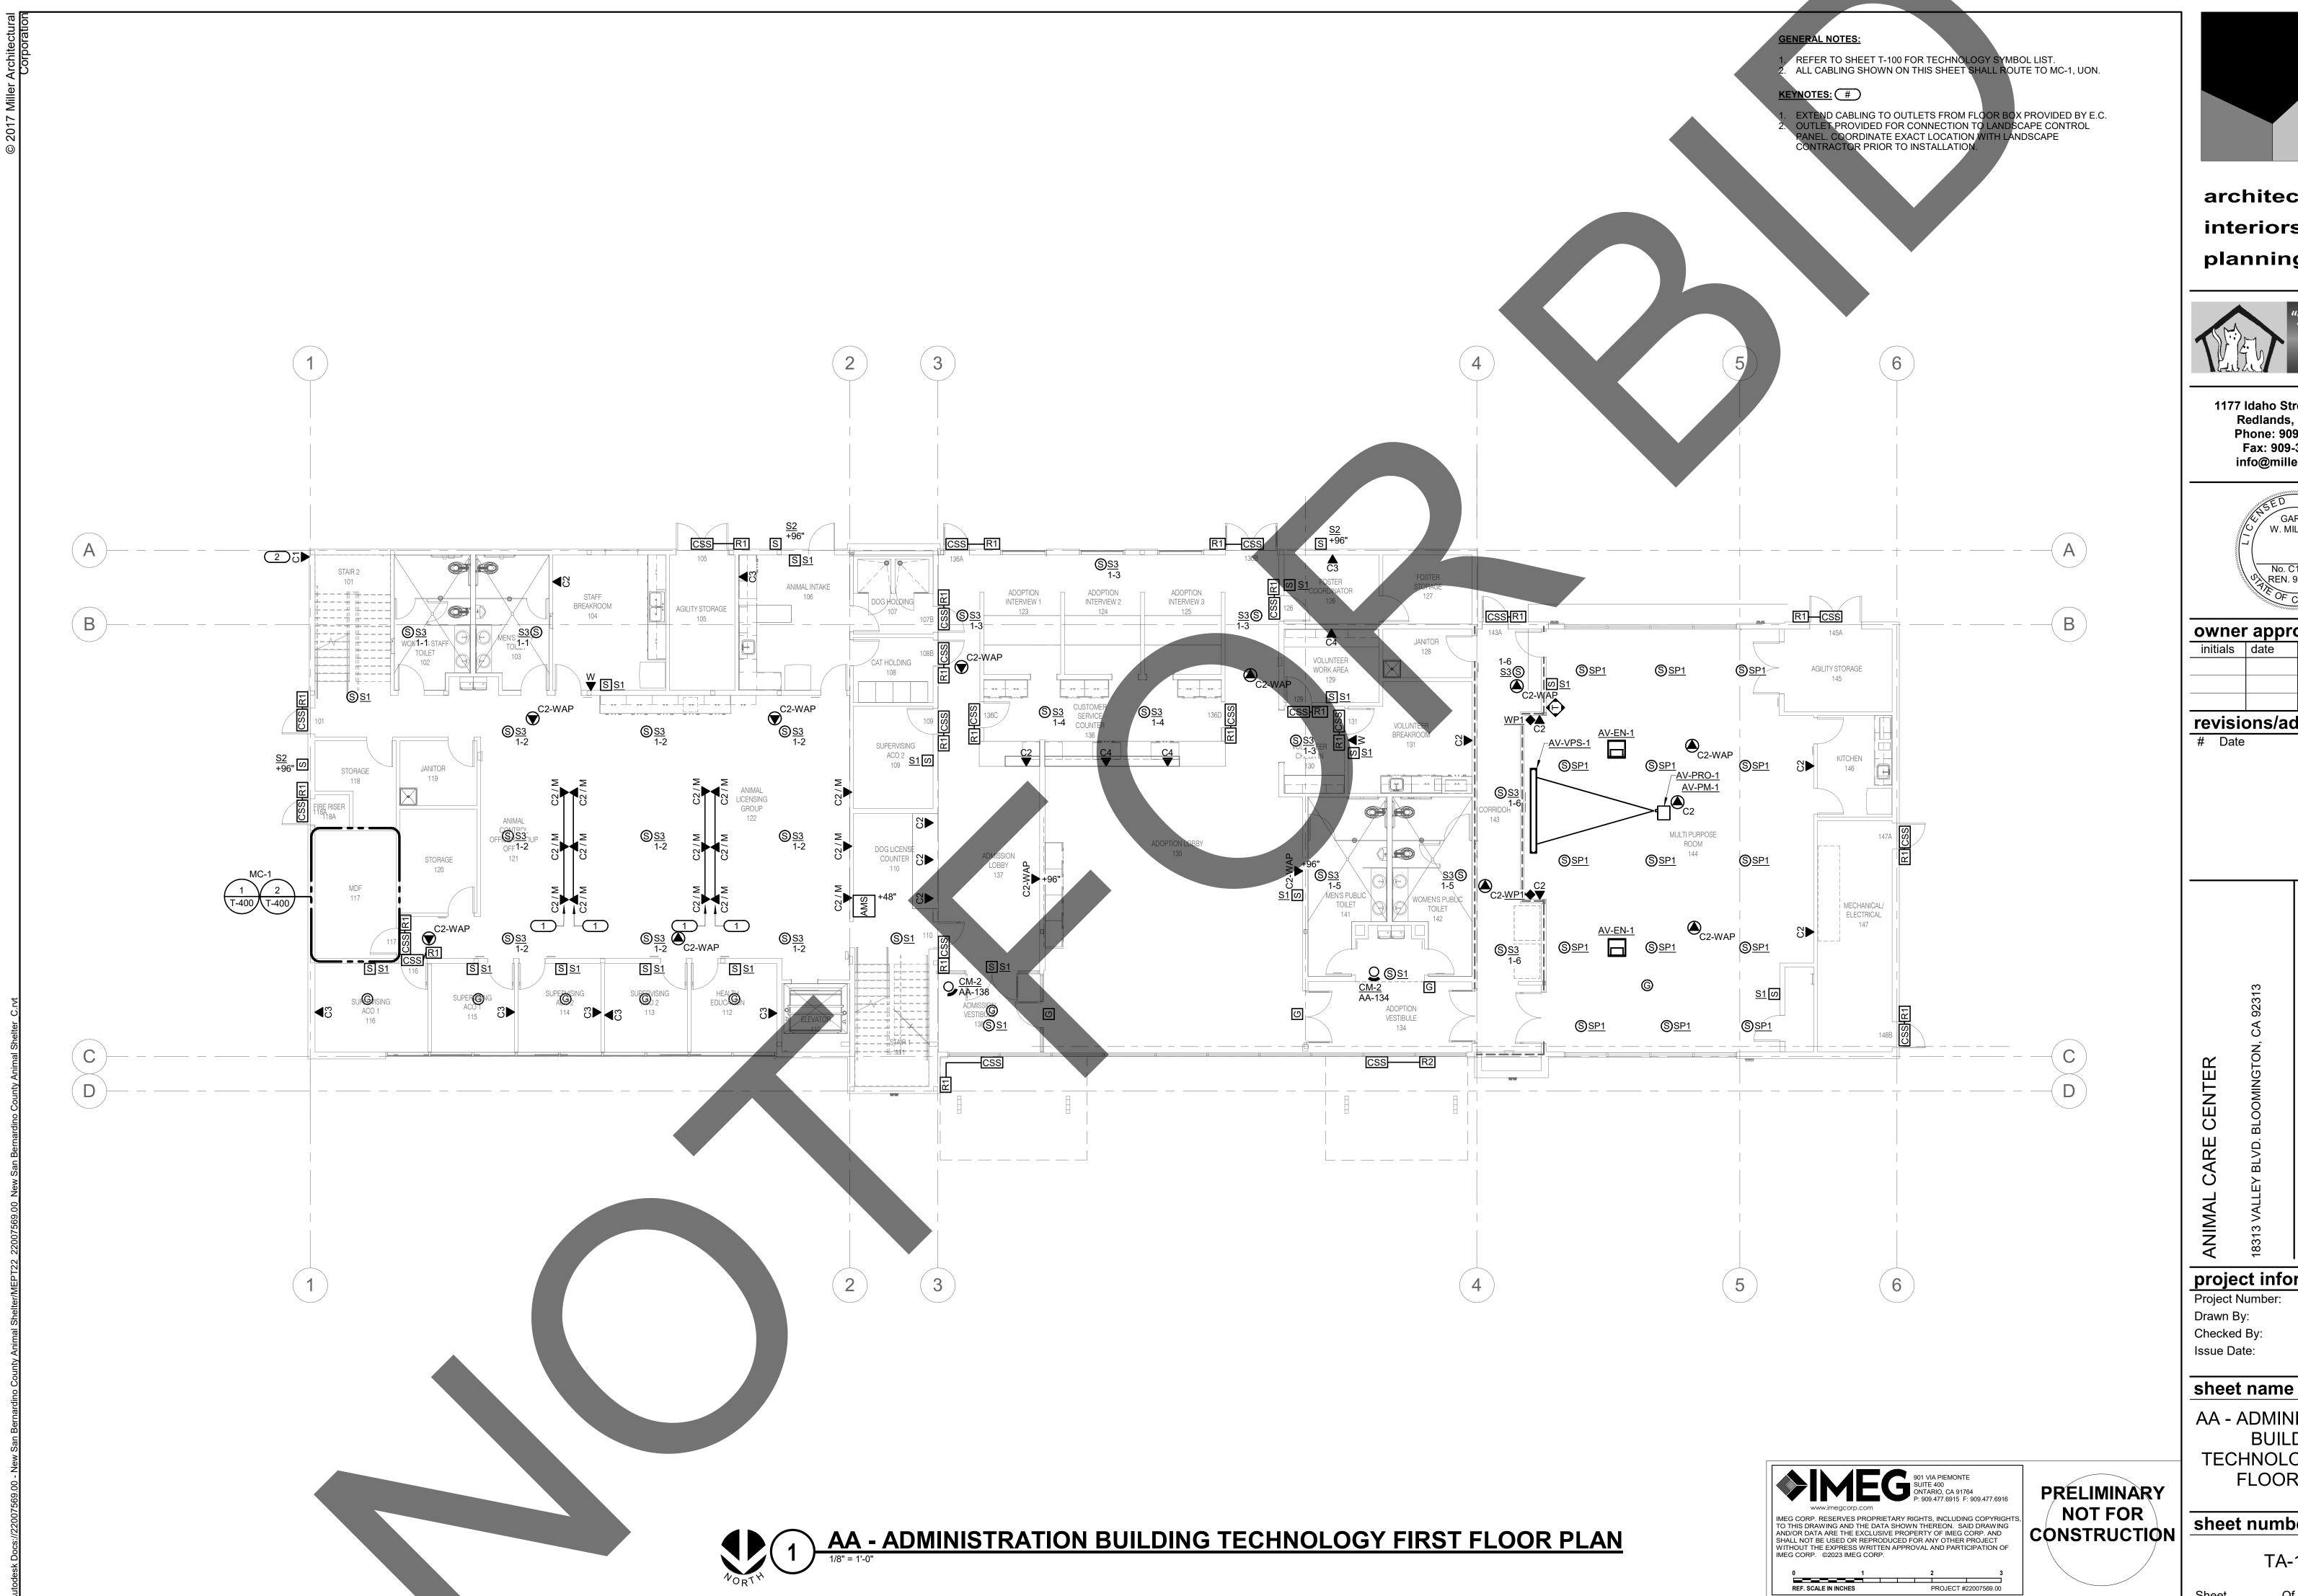



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revisions/addenda

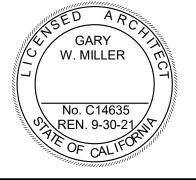Comment


# project information

Project Number: Author 05/17/24

AA - ADMINISTRATION BUILDING **TECHNOLOGY FIRST** FLOOR PLAN


sheet number

TA-101

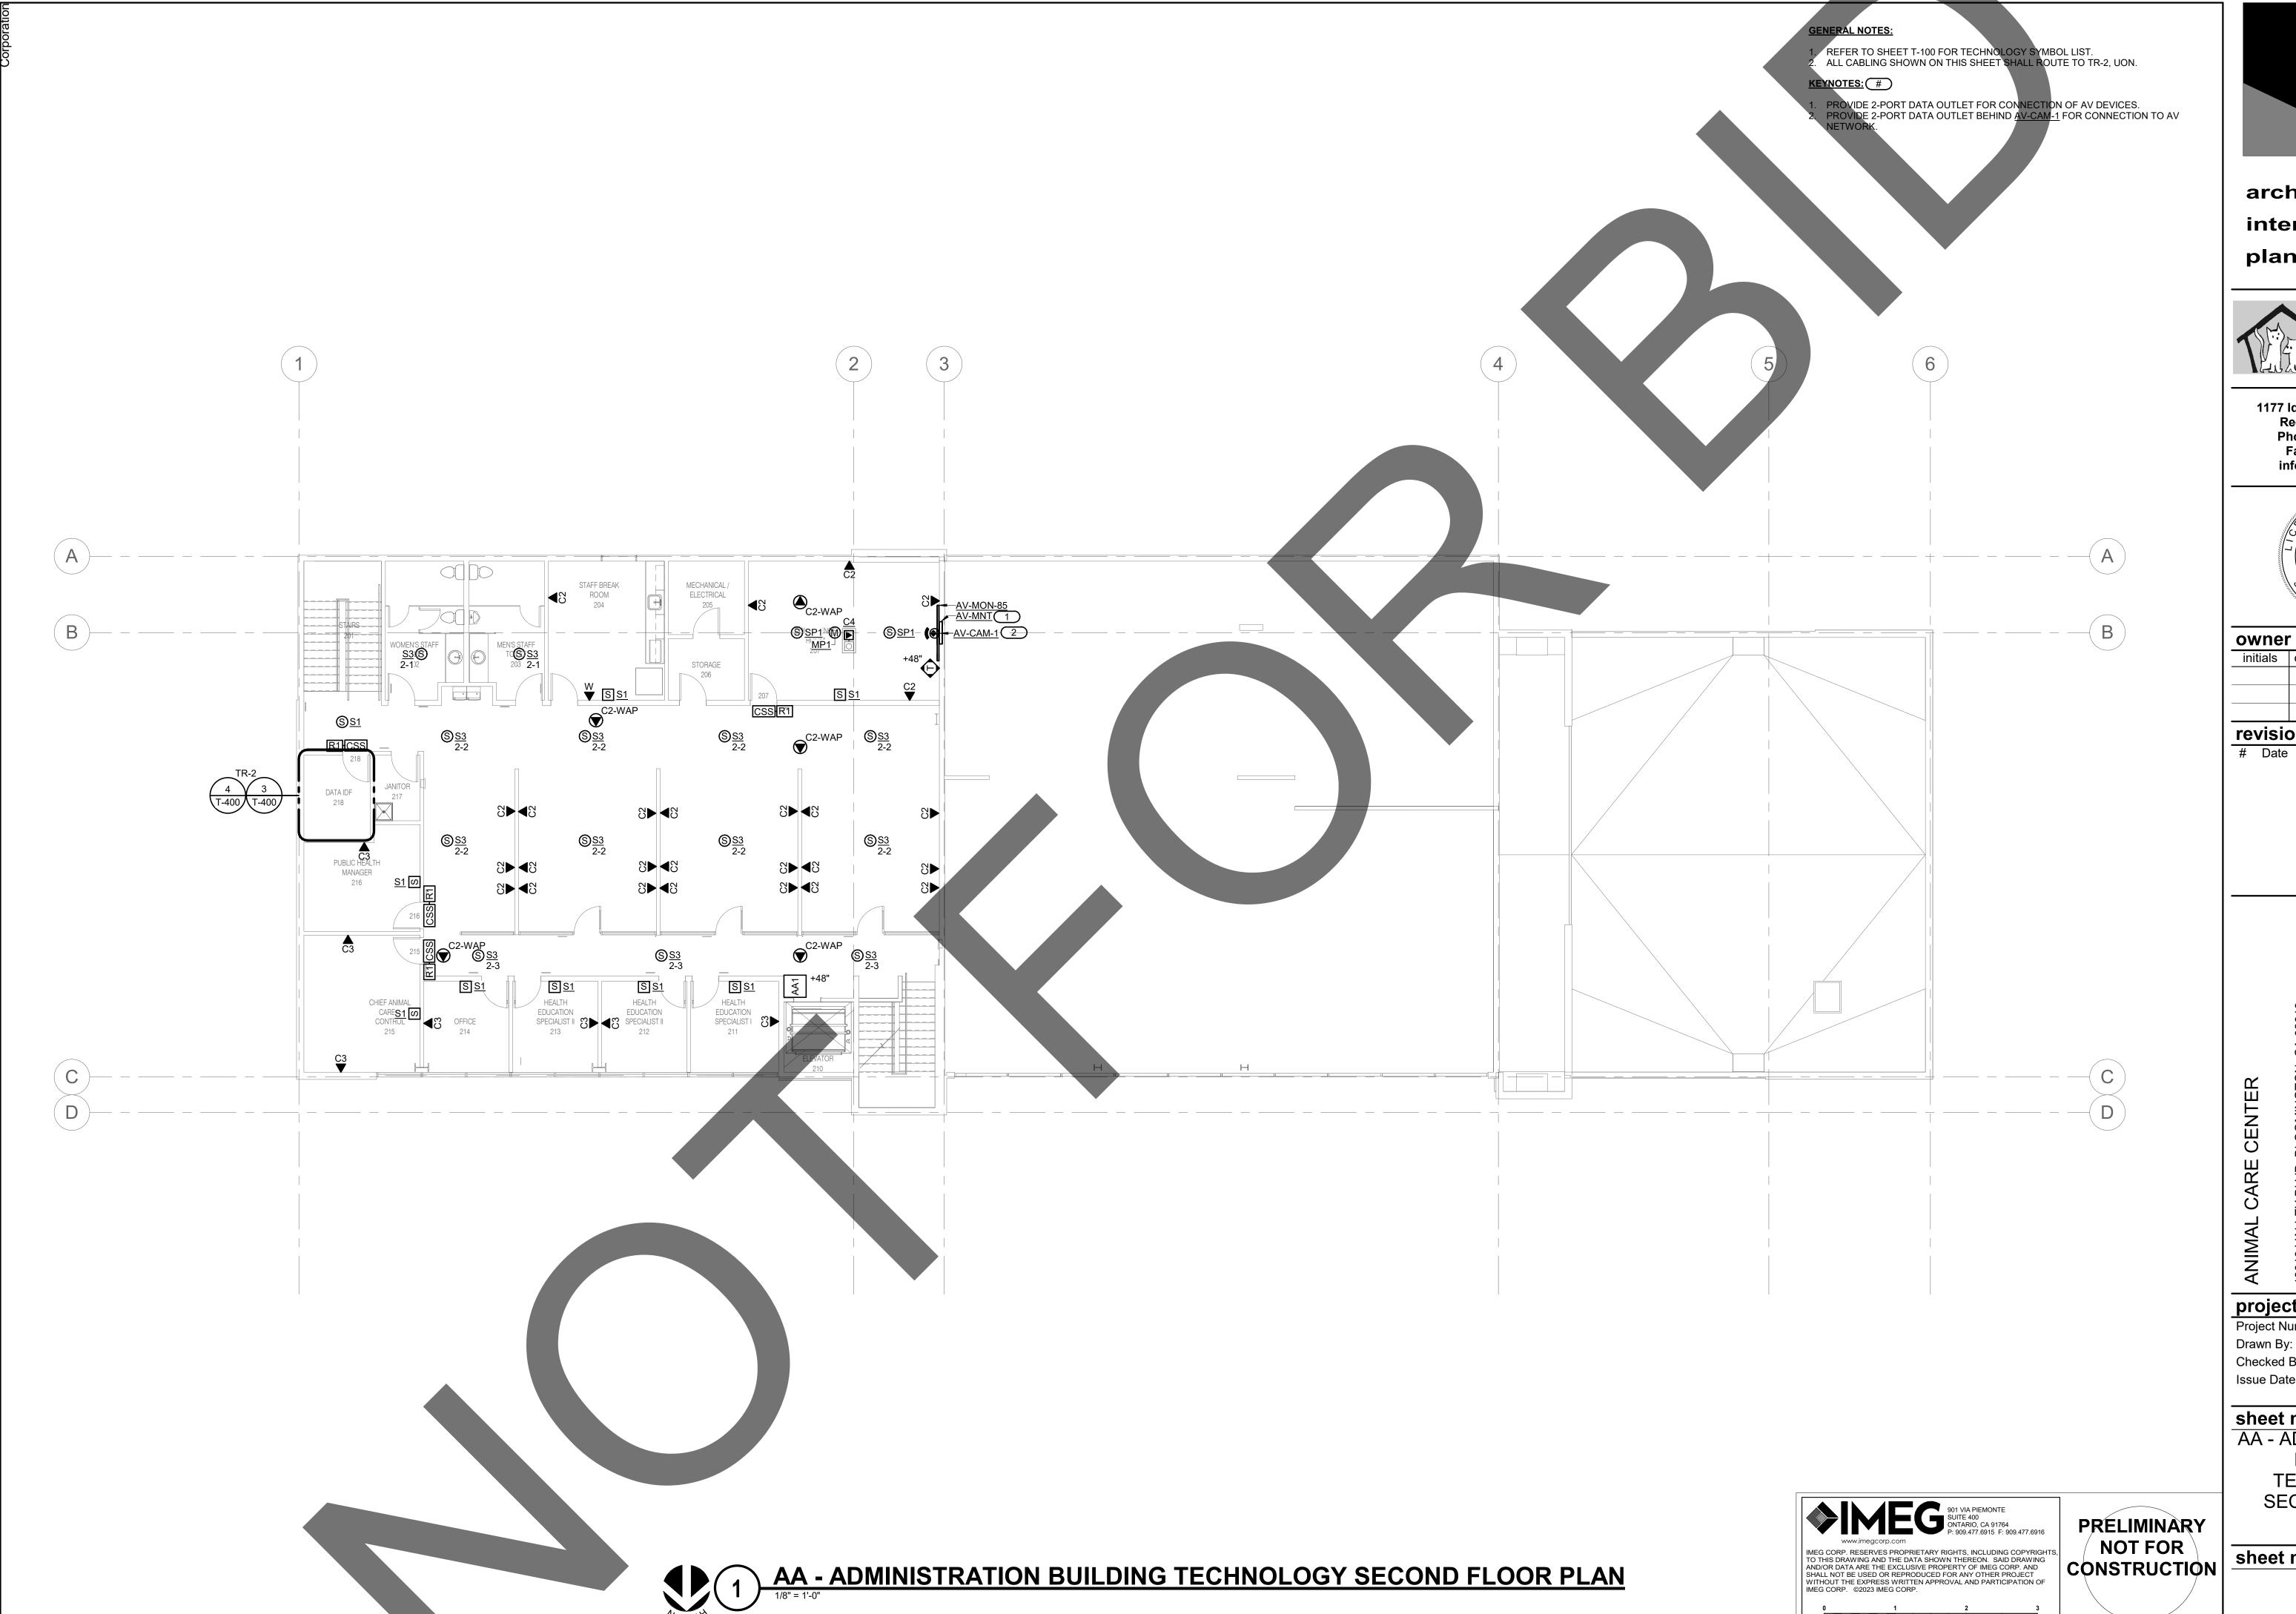



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initials	date	phase												

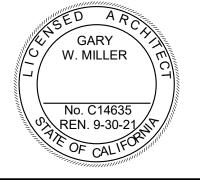revisions/addenda Comment

project information

Project Number: Author Drawn By: Checked By: 05/17/24 Issue Date:

sheet name


AA - ADMINISTRATION BUILDING TECHNOLOGY SECOND FLOOR PLAN

sheet number

0 1 2 3

REF. SCALE IN INCHES PROJECT #22007569.00

TA-102

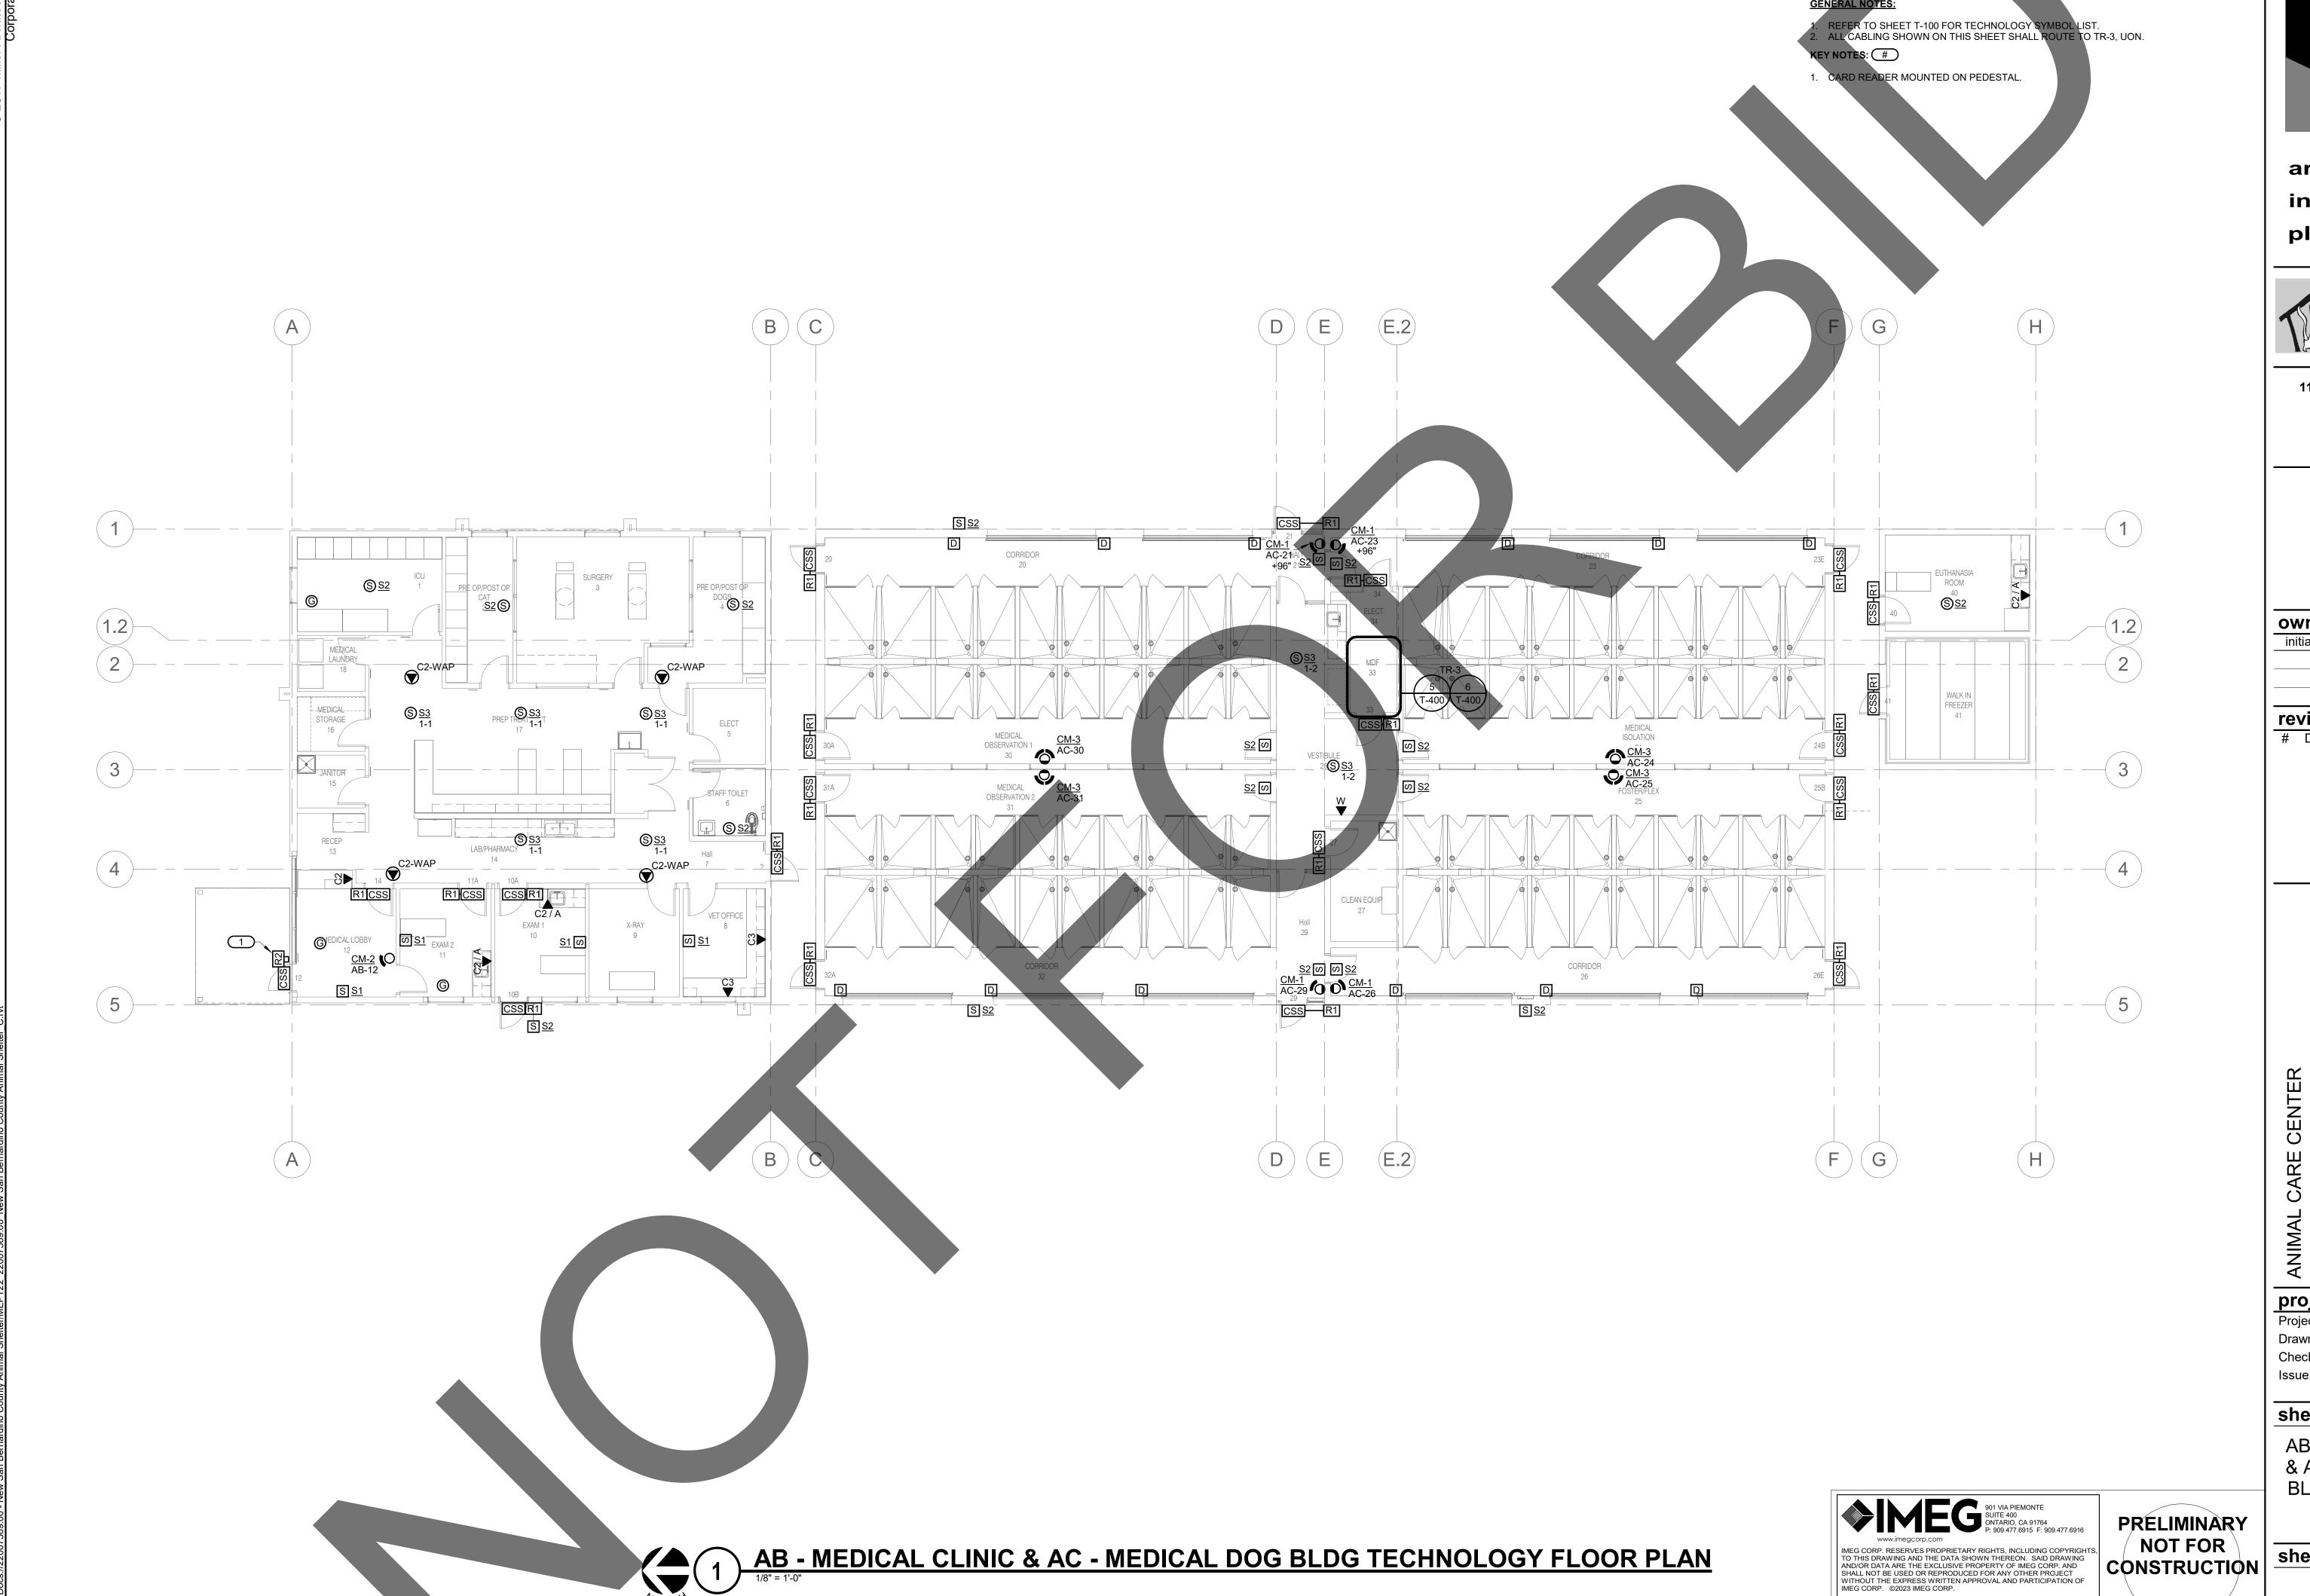



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initials	date	phase												

revisions/addenda

# Date Comment

project information

Project Number: Author Drawn By: Checked By: 05/17/24 Issue Date:

sheet name

AB - MEDICAL CLINIC & AC - MEDICAL DOG **BLDG TECHNOLOGY** FLOOR PLAN


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TBC-101


Sheet

0 1 2 3

REF. SCALE IN INCHES PROJECT #22007569.00

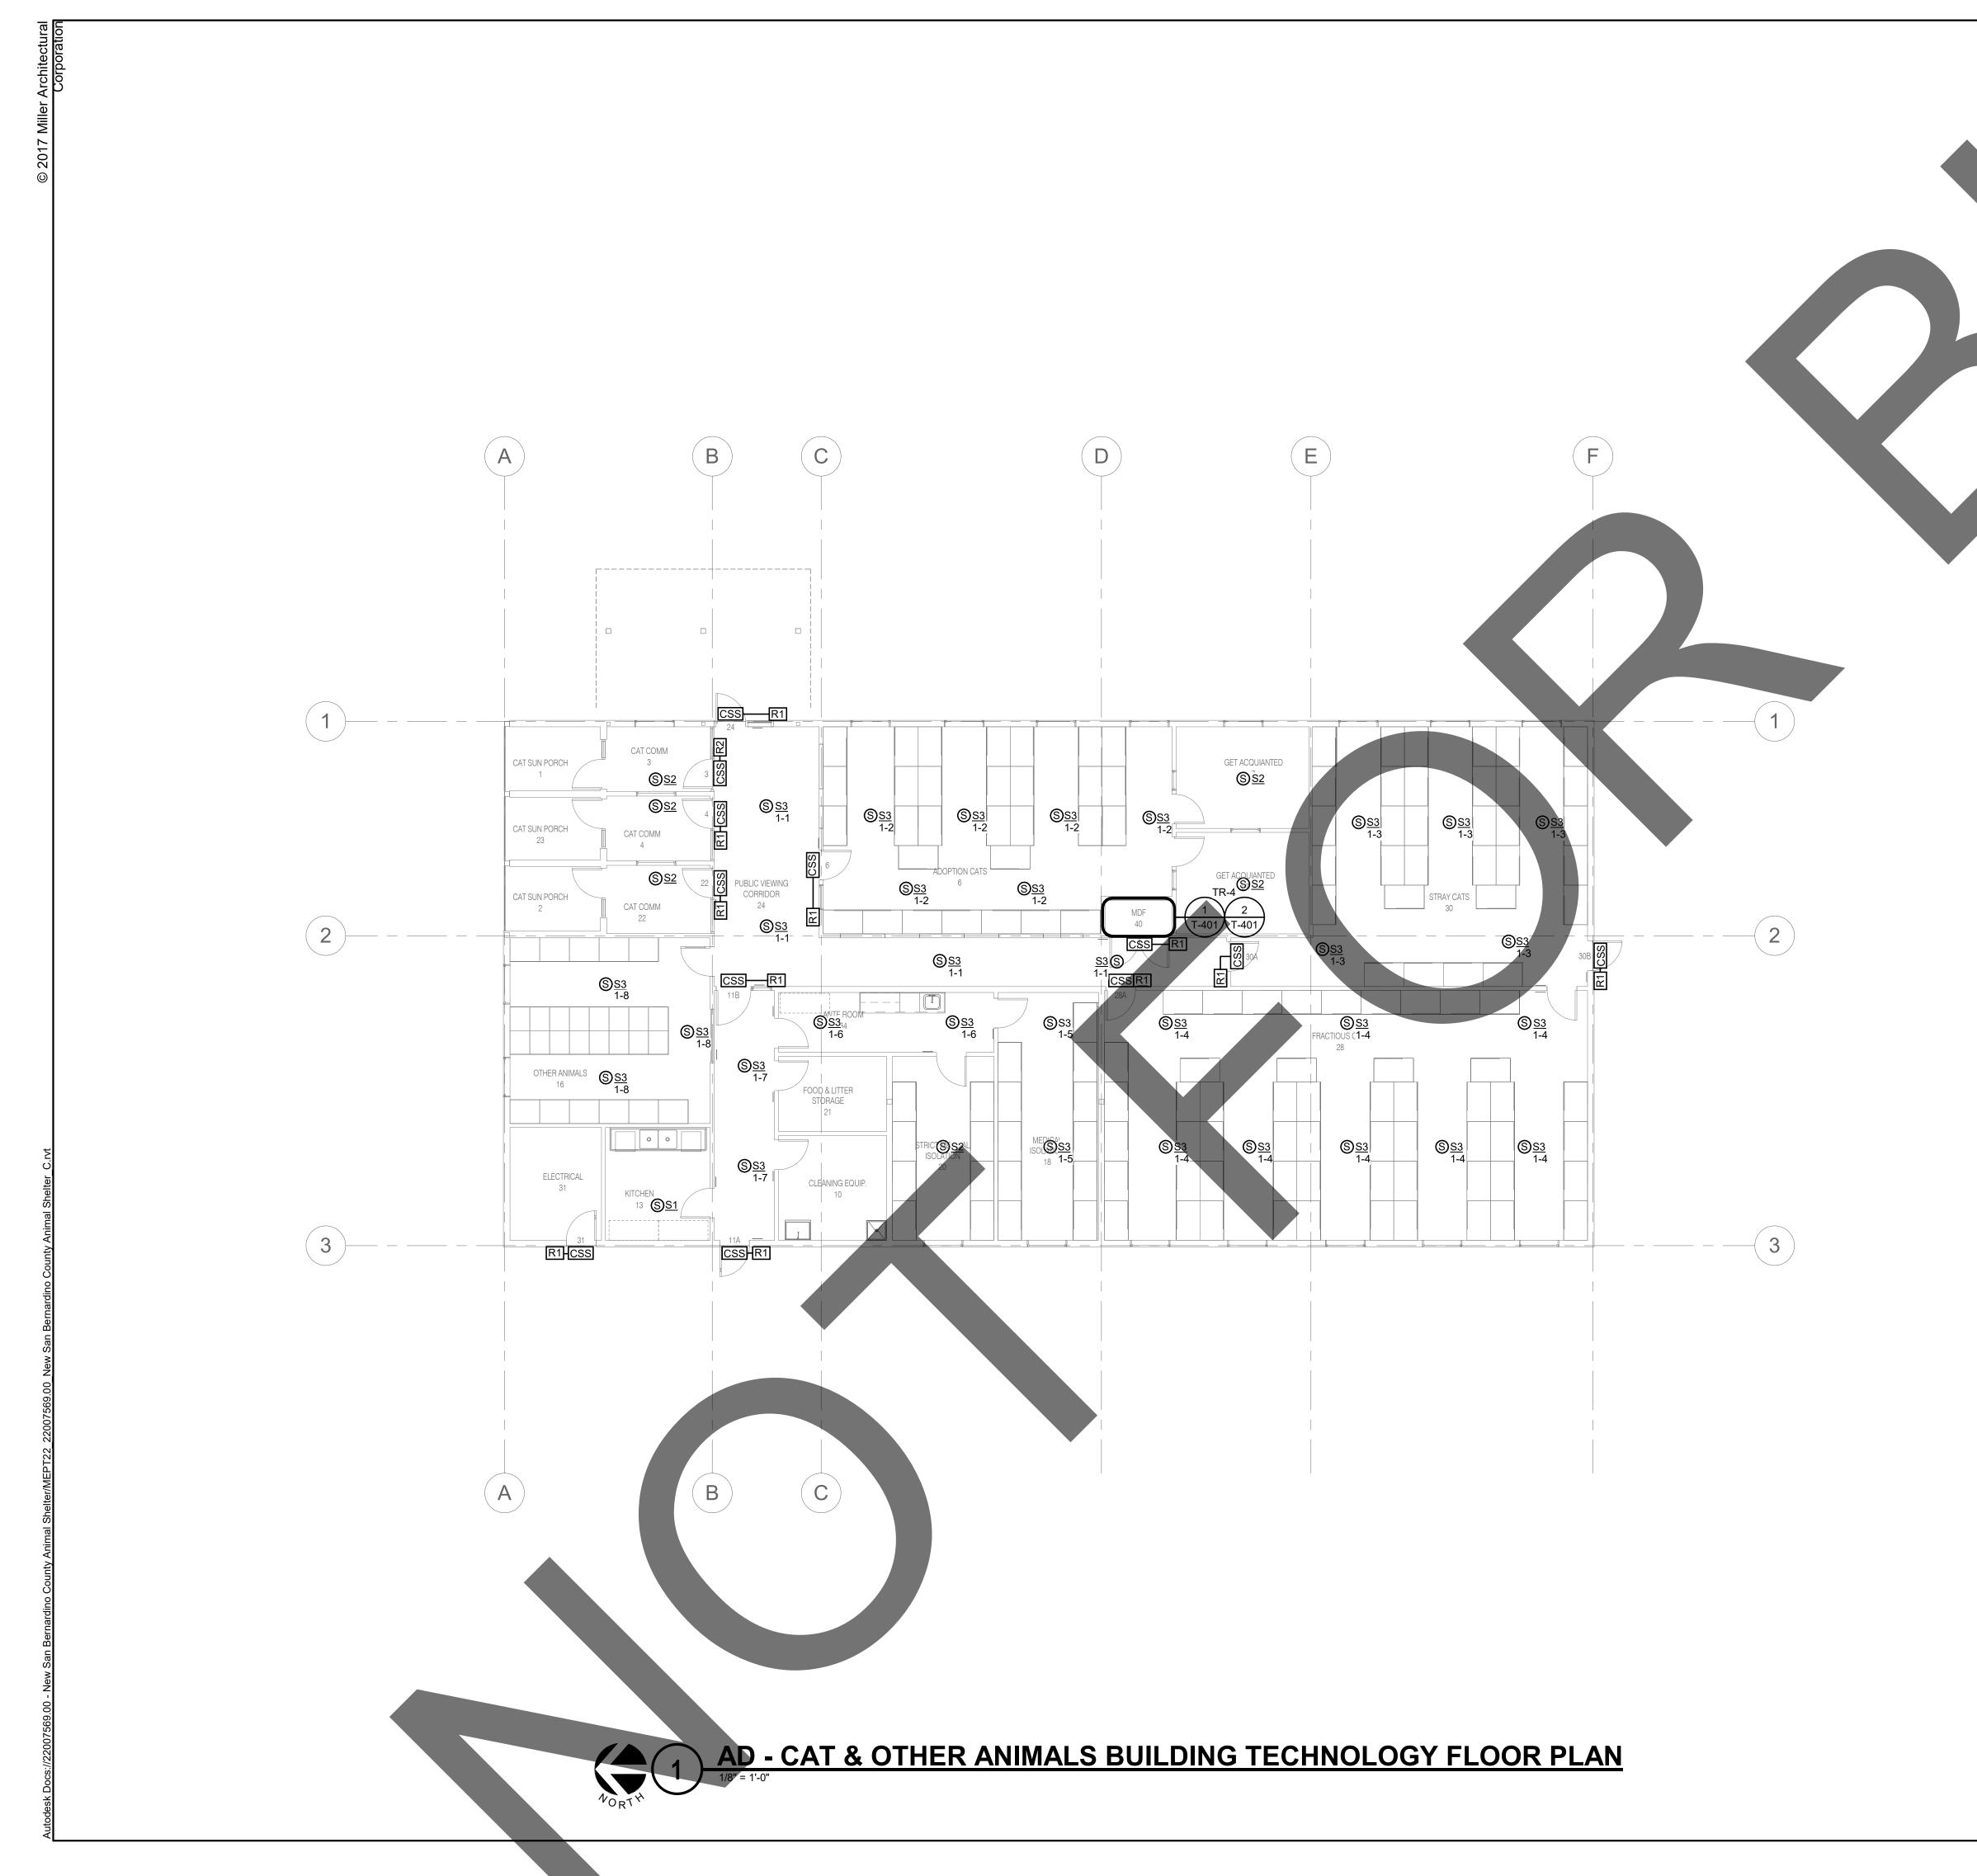

1. ALL CABLING SHOWN ON THIS SHEET SHALL ROUTE TO TR-4, UON.

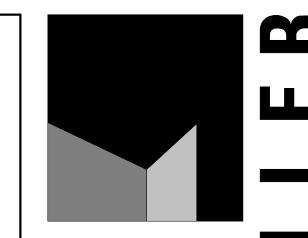

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# Date Comment

### **GENERAL NOTES:**

CONTROLLED SECURITY SCHEME SCHEDULE

SECURITY CREDENTIAL READER (WALL)

FACILITY PAGING SPEAKER (CEILING)

**TECHNOLOGY SYMBOL LIST** 

DESCRIPTION:

IDENTIFIER

- ALL SYMBOLS AND ABBREVIATIONS LISTED MAY NOT BE APPLICABLE TO THIS PROJECT. REFER TO THE TECHNOLOGY EQUIPMENT SCHEDULE FOR MORE COMPLETE DESCRIPTION
- ALL SYMBOLS AND ABBREVIATIONS REFER TO TECHNOLOGY SHEETS ONLY AS DEFINED ON
- THE SHEET INDEX. REFER TO THE GENERAL TECHNOLOGY NOTES FOR ADDITIONAL INFORMATION. 8. ALL SYMBOLS LISTED ABOVE ARE FOR REFERENCE ONLY. REFER TO PLANS AND LINE TYPE KEY FOR NEW, EXISTING TO REMAIN AND TO BE REMOVED ITEMS FOR ADDITIONAL
- INFORMATION.


#### REFER TO RISERS ON SHEET(S): T-300, T-301, T-302. TECHNOLOGY SYMBOL NOTES:

- REFER TO CONTROLLED SECURITY SCHEME (CSS) TYPE SCHEDULE ON T-102 FOR
- ADDITIONAL INFORMATION. SYMBOL SUBSCRIPT INDICATES PAGING ZONE.

SYMBOL: EQUIPMENT LIST ABBREV.:

R#

8. SYMBOL SUBSCRIPT INDICATES DEVICE TYPE. REFER TO TECHNOLOGY EQUIPMENT SCHEDULE T-101 FOR ADDITIONAL INFORMATION.

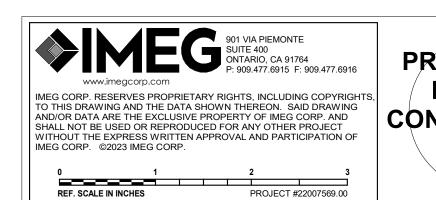

PRELIMINARY **NOT FOR** CONSTRUCTION

project information

Project Number: Drawn By: Author Checked By: PS 05/17/24 Issue Date:


#### sheet name

AD - CAT & OTHER ANIMALS BUILDING **TECHNOLOGY FLOOR** PLAN

sheet number

TD-101


1. ALL CABLING SHOWN ON THIS SHEET SHALL ROUTE TO TR-6, UON.

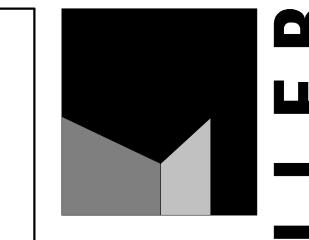

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initials	date	phase		

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# Date Comment

	TECHNOLOGY SYMBOL LIST			
SYMBOL:	EQUIPMENT LIST ABBREV.:	DESCRIPTION:	NOTE	
CSS	N/A	CONTROLLED SECURITY SCHEME SCHEDULE IDENTIFIER	1.	
R#	AC-R#-W	SECURITY CREDENTIAL READER (WALL)		
D	ID-DC1	INTRUSION DETECTION DOOR CONTACT		
S <u>s#</u>	PA-S#-C	FACILITY PAGING SPEAKER (CEILING)	3,4.	
S <u>s#</u>	PA-S#-W	FACILITY PAGING SPEAKER (WALL)	3,4.	
W	SC-IO-W	INFORMATION OUTLET WALL PHONE (WALL)		
(C) CM-#	VS-CM-#	VIDEO SURVEILLANCE CAMERA 360° FOV (CEILING/HORIZONTAL SURFACE)	2.	
<b>○</b> CM-#	VS-CM-#	VIDEO SURVEILLANCE CAMERA SINGLE LENS FOV (WALL/VERTICAL SURFACE)	2.	
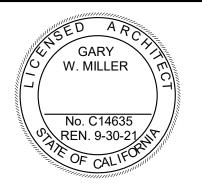
#### GENERAL NOTES:


- ALL SYMBOLS AND ABBREVIATIONS LISTED MAY NOT BE APPLICABLE TO THIS PROJECT. REFER TO THE TECHNOLOGY EQUIPMENT SCHEDULE FOR MORE COMPLETE DESCRIPTION AND ITEMS.
- . ALL SYMBOLS AND ABBREVIATIONS REFER TO TECHNOLOGY SHEETS ONLY AS DEFINED ON THE SHEET INDEX. REFER TO THE GENERAL TECHNOLOGY NOTES FOR ADDITIONAL INFORMATION.
- 3. ALL SYMBOLS LISTED ABOVE ARE FOR REFERENCE ONLY. REFER TO PLANS AND LINE TYPE KEY FOR NEW, EXISTING TO REMAIN AND TO BE REMOVED ITEMS FOR ADDITIONAL INFORMATION.

#### REFER TO RISERS ON SHEET(S): T-300, T-301, T-302.

- TECHNOLOGY SYMBOL NOTES:

  REFER TO CONTROLLED SECURITY SCHEME (CSS) TYPE SCHEDULE ON T-102 FOR
- ADDITIONAL INFORMATION.

  "CM-#" ON FLOOR PLANS INDICATES CAMERA TYPE AND IS ASSOCIATED WITH THE CORRESPONDING "VS-CM-#" EQUIPMENT SCHEDULE ABBREVIATION. "xx-###" SUBSCRIPT INDICATES BLDG INDENTIFIER-CAMERA NUMBER. REFER TO INDIVIDUAL CAMERA REQUIREMENT SCHEDULE FOR ADDITIONAL INFORMATION.
- SYMBOL SUBSCRIPT INDICATES PAGING ZONE.
   SYMBOL SUBSCRIPT INDICATES DEVICE TYPE. REFER TO TECHNOLOGY EQUIPMENT SCHEDULE T-101 FOR ADDITIONAL INFORMATION.

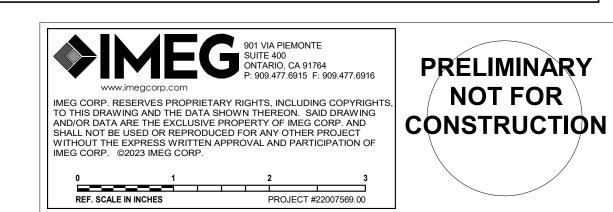

project information
Project Number:

Project Number: 1227
Drawn By: Author
Checked By: PS
Issue Date: 05/17/24

#### sheet name


AE - ADOPTION DOG BUILDING 1 TECHNOLOGY FLOOR PLAN

sheet number

TE-101

Sheet Of She

1. ALL CABLING SHOWN ON THIS SHEET SHALL ROUTE TO TR-7, UON.

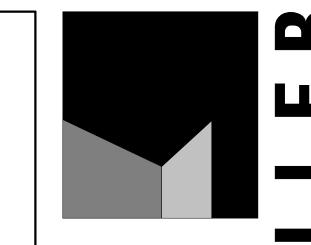

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### revisions/addenda

# Date Comment


	TECHNOLOGY SYMBOL LIST			
SYMBOL:	EQUIPMENT LIST ABBREV.:	DESCRIPTION:	NOTE	
CSS	N/A	CONTROLLED SECURITY SCHEME SCHEDULE IDENTIFIER	1.	
R#	AC-R#-W	SECURITY CREDENTIAL READER (WALL)		
D	ID-DC1	INTRUSION DETECTION DOOR CONTACT		
(S) <u>S#</u>	PA-S#-C	FACILITY PAGING SPEAKER (CEILING)	3,4.	
S <u>s#</u>	PA-S#-W	FACILITY PAGING SPEAKER (WALL)	3,4.	
₩	SC-IO-W	INFORMATION OUTLET WALL PHONE (WALL)		
( <u>C</u> ) CM-#	VS-CM-#	VIDEO SURVEILLANCE CAMERA 360° FOV (CEILING/HORIZONTAL SURFACE)	2.	
<b>☆</b> CM-#	<u>VS-CM-#</u>	VIDEO SURVEILLANCE CAMERA SINGLE LENS FOV (WALL/VERTICAL SURFACE)	2.	

#### **GENERAL NOTES:**

- ALL SYMBOLS AND ABBREVIATIONS LISTED MAY NOT BE APPLICABLE TO THIS PROJECT. REFER TO THE TECHNOLOGY EQUIPMENT SCHEDULE FOR MORE COMPLETE DESCRIPTION
- ALL SYMBOLS AND ABBREVIATIONS REFER TO TECHNOLOGY SHEETS ONLY AS DEFINED ON THE SHEET INDEX. REFER TO THE GENERAL TECHNOLOGY NOTES FOR ADDITIONAL
- INFORMATION. ALL SYMBOLS LISTED ABOVE ARE FOR REFERENCE ONLY. REFER TO PLANS AND LINE TYPE KEY FOR NEW, EXISTING TO REMAIN AND TO BE REMOVED ITEMS FOR ADDITIONAL INFORMATION.
- . REFER TO RISERS ON SHEET(S): T-300, T-301, T-302.

#### **TECHNOLOGY SYMBOL NOTES:**

- REFER TO CONTROLLED SECURITY SCHEME (CSS) TYPE SCHEDULE ON T-102 FOR
- ADDITIONAL INFORMATION. "CM-#" ON FLOOR PLANS INDICATES CAMERA TYPE AND IS ASSOCIATED WITH THE CORRESPONDING "VS-CM-#" EQUIPMENT SCHEDULE ABBREVIATION. "xx-###" SUBSCRIPT INDICATES BLDG INDENTIFIER-CAMERA NUMBER. REFER TO INDIVIDUAL CAMERA REQUIREMENT SCHEDULE FOR ADDITIONAL INFORMATION.
- SYMBOL SUBSCRIPT INDICATES PAGING ZONE. . SYMBOL SUBSCRIPT INDICATES DEVICE TYPE. REFER TO TECHNOLOGY EQUIPMENT SCHEDULE T-101 FOR ADDITIONAL INFORMATION.

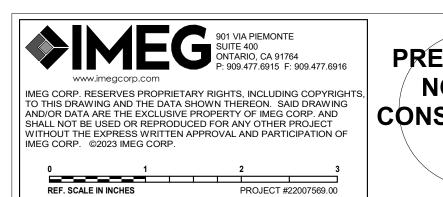

PRELIMINARY **NOT FOR** CONSTRUCTION

project information


Project Number: Drawn By: Author PS Checked By: 05/17/24 Issue Date:

sheet name


AF - ADOPTION DOG **BUILDING 2 TECHNOLOGY FLOOR** PLAN

sheet number

TF-101

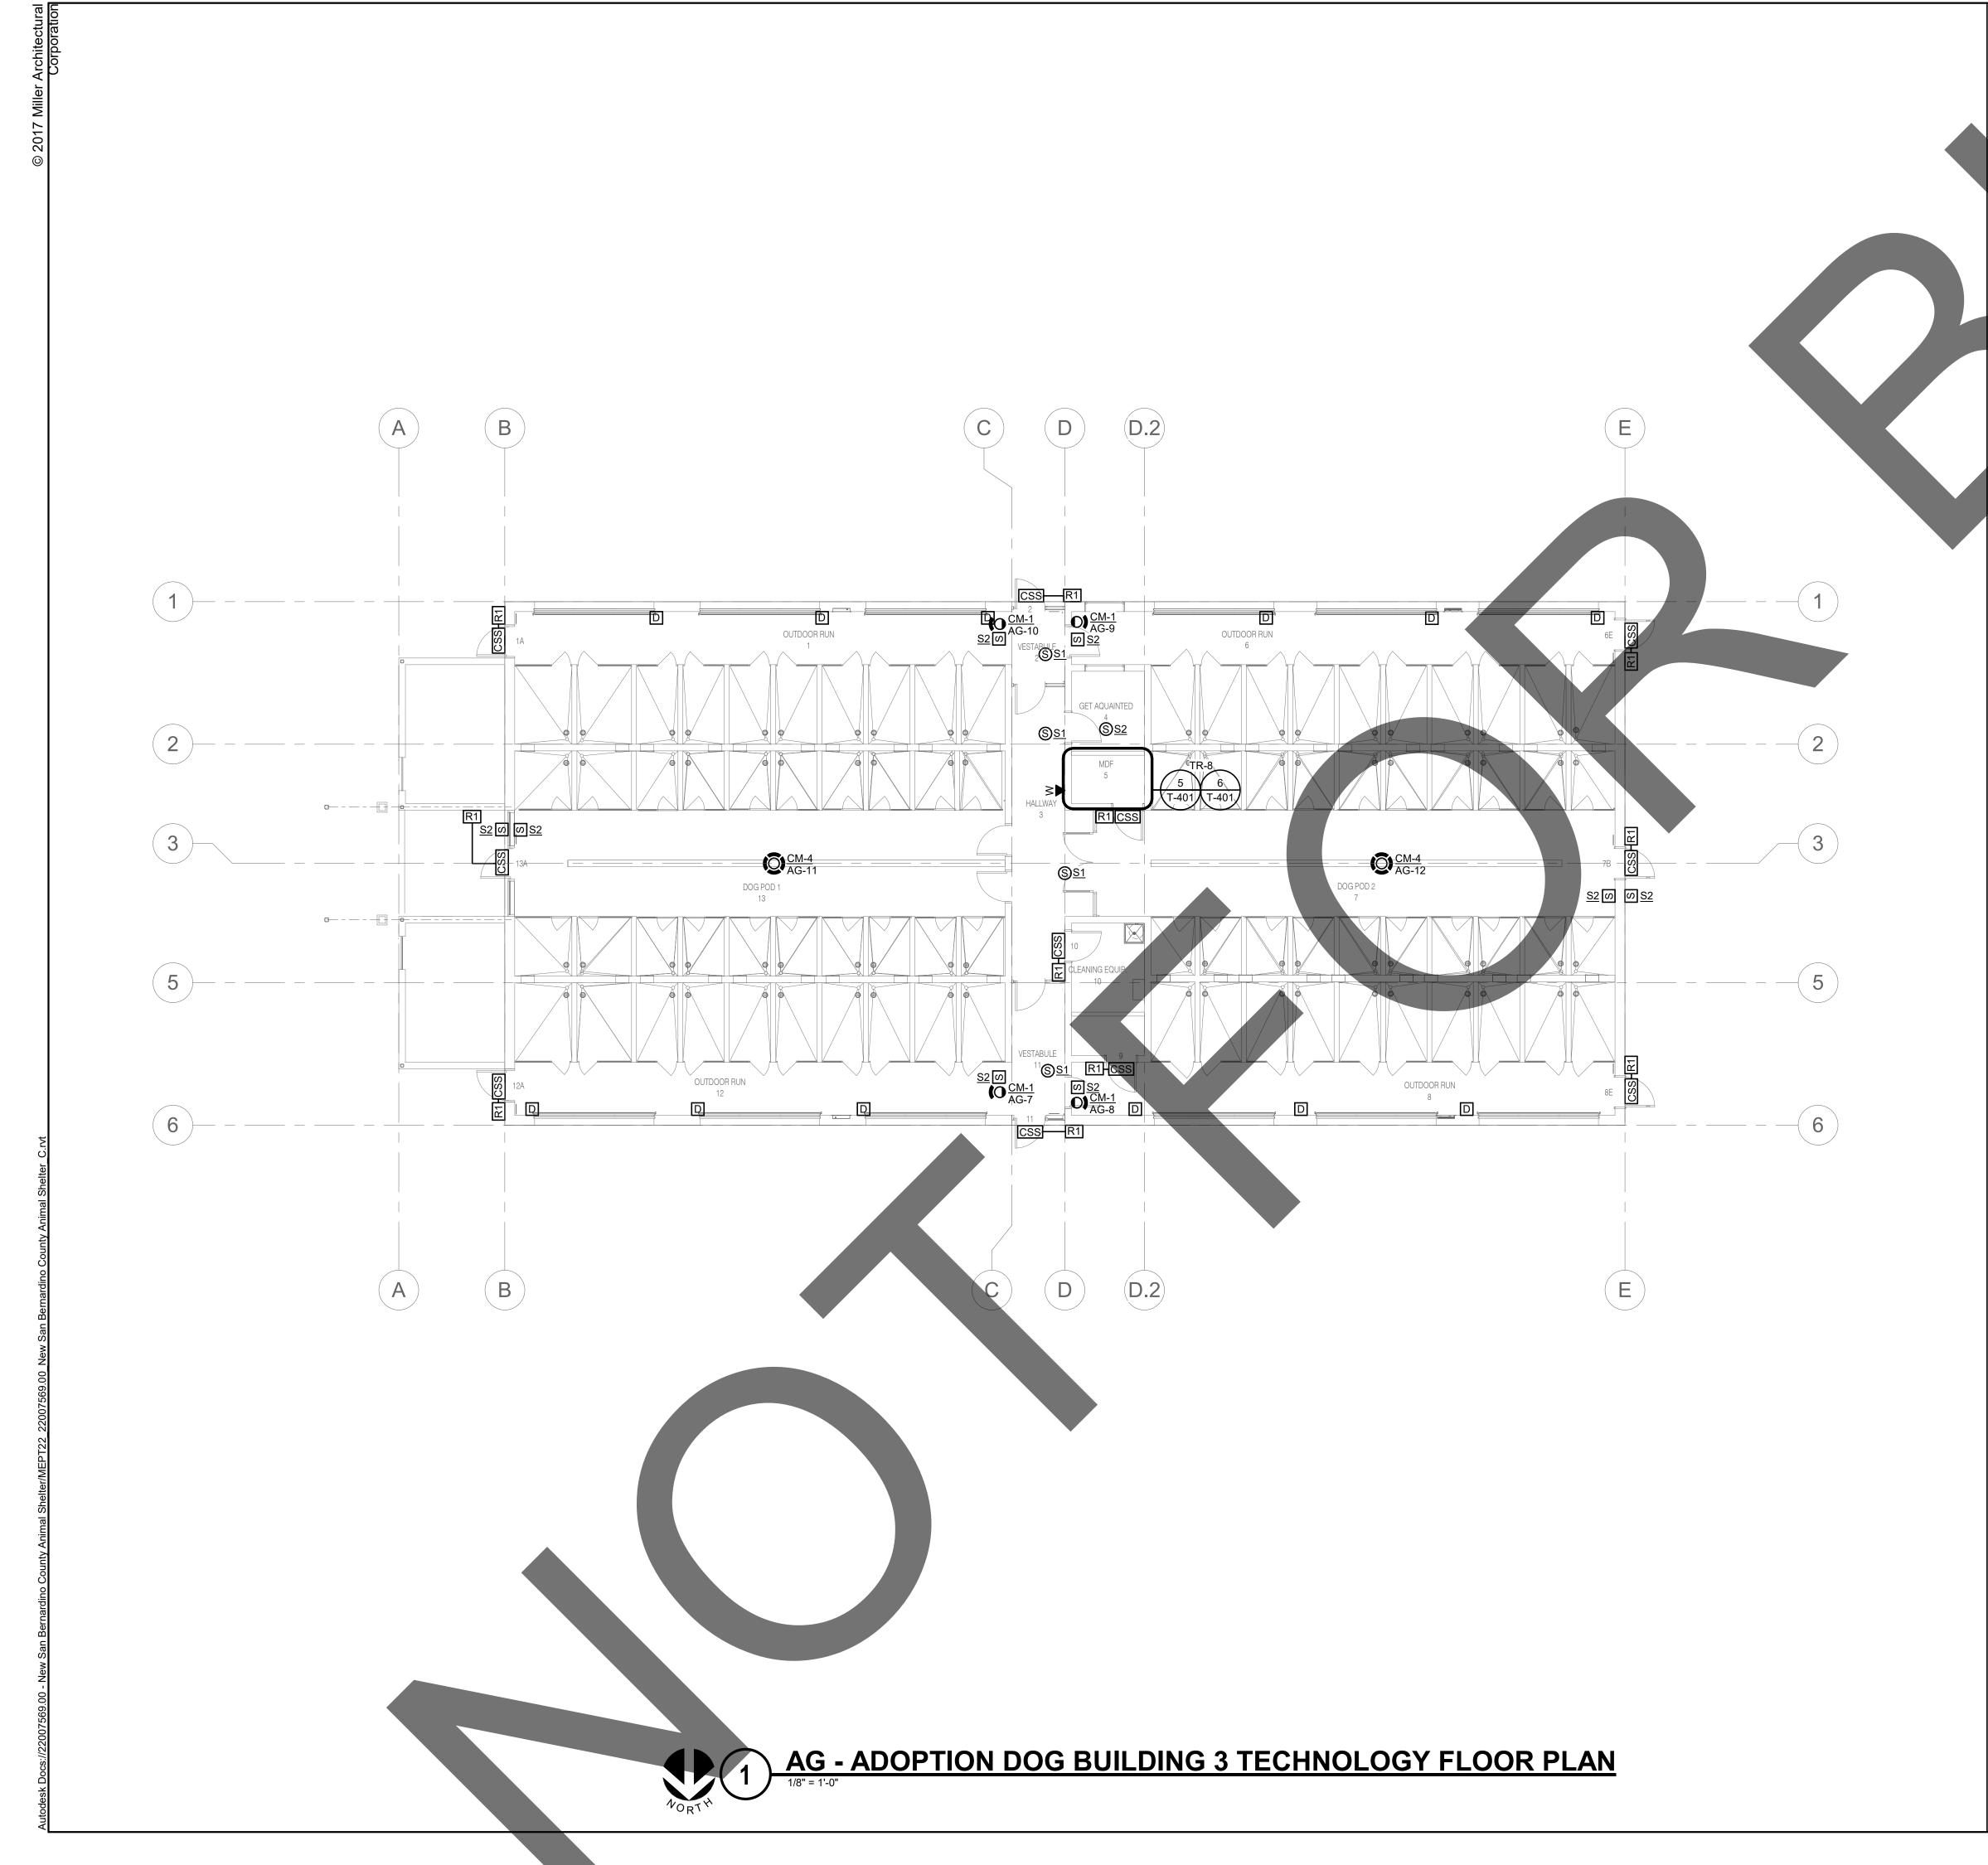


1. ALL CABLING SHOWN ON THIS SHEET SHALL ROUTE TO TR-8, UON.

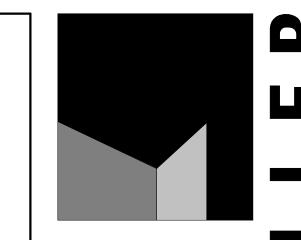

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owner approval			
initials	date	phase	

### revisions/addenda

# Date Comment

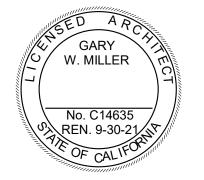	TECHNOLOGY SYMBOL LIST			
SYMBOL:	EQUIPMENT LIST ABBREV.:	DESCRIPTION:	NOTE	
CSS	N/A	CONTROLLED SECURITY SCHEME SCHEDULE IDENTIFIER	1.	
R#	AC-R#-W	SECURITY CREDENTIAL READER (WALL)		
D	ID-DC1	INTRUSION DETECTION DOOR CONTACT		
S <u>s#</u>	PA-S#-C	FACILITY PAGING SPEAKER (CEILING)	3,4.	
S <u>s#</u>	PA-S#-W	FACILITY PAGING SPEAKER (WALL)	3,4.	
W	SC-IO-W	INFORMATION OUTLET WALL PHONE (WALL)		
(C) CM-#	VS-CM-#	VIDEO SURVEILLANCE CAMERA 360° FOV (CEILING/HORIZONTAL SURFACE)	2.	
<b>☆</b> CM-#	VS-CM-#	VIDEO SURVEILLANCE CAMERA SINGLE LENS FOV (WALL/VERTICAL SURFACE)	2.	


#### **GENERAL NOTES:**

- ALL SYMBOLS AND ABBREVIATIONS LISTED MAY NOT BE APPLICABLE TO THIS PROJECT.
  REFER TO THE TECHNOLOGY EQUIPMENT SCHEDULE FOR MORE COMPLETE DESCRIPTION
  AND ITEMS
- 2. ALL SYMBOLS AND ABBREVIATIONS REFER TO TECHNOLOGY SHEETS ONLY AS DEFINED ON THE SHEET INDEX. REFER TO THE GENERAL TECHNOLOGY NOTES FOR ADDITIONAL INFORMATION.
- 3. ALL SYMBOLS LISTED ABOVE ARE FOR REFERENCE ONLY. REFER TO PLANS AND LINE TYPE KEY FOR NEW, EXISTING TO REMAIN AND TO BE REMOVED ITEMS FOR ADDITIONAL INFORMATION.
- REFER TO RISERS ON SHEET(S): T-300, T-301, T-302.

#### TECHNOLOGY SYMBOL NOTES:

- REFER TO CONTROLLED SECURITY SCHEME (CSS) TYPE SCHEDULE ON T-102 FOR
- ADDITIONAL INFORMATION.

  "CM-#" ON FLOOR PLANS INDICATES CAMERA TYPE AND IS ASSOCIATED WITH THE CORRESPONDING "VS-CM-#" EQUIPMENT SCHEDULE ABBREVIATION. "xx-###" SUBSCRIPT INDICATES BLDG INDENTIFIER-CAMERA NUMBER. REFER TO INDIVIDUAL CAMERA REQUIREMENT SCHEDULE FOR ADDITIONAL INFORMATION.
- SYMBOL SUBSCRIPT INDICATES PAGING ZONE.
   SYMBOL SUBSCRIPT INDICATES DEVICE TYPE. REFER TO TECHNOLOGY EQUIPMENT SCHEDULE T-101 FOR ADDITIONAL INFORMATION.

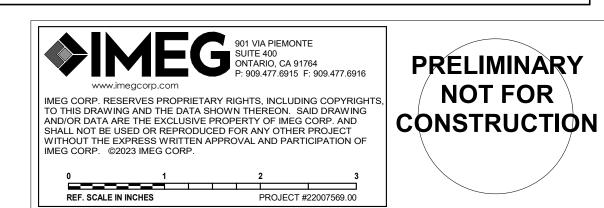

project information
Project Number:


Project Number: 1227
Drawn By: Author
Checked By: PS
Issue Date: 05/17/24

#### sheet name


AG - ADOPTION DOG BUILDING 3 TECHNOLOGY FLOOR PLAN

sheet number

TG-101
Sheet Of Sheet

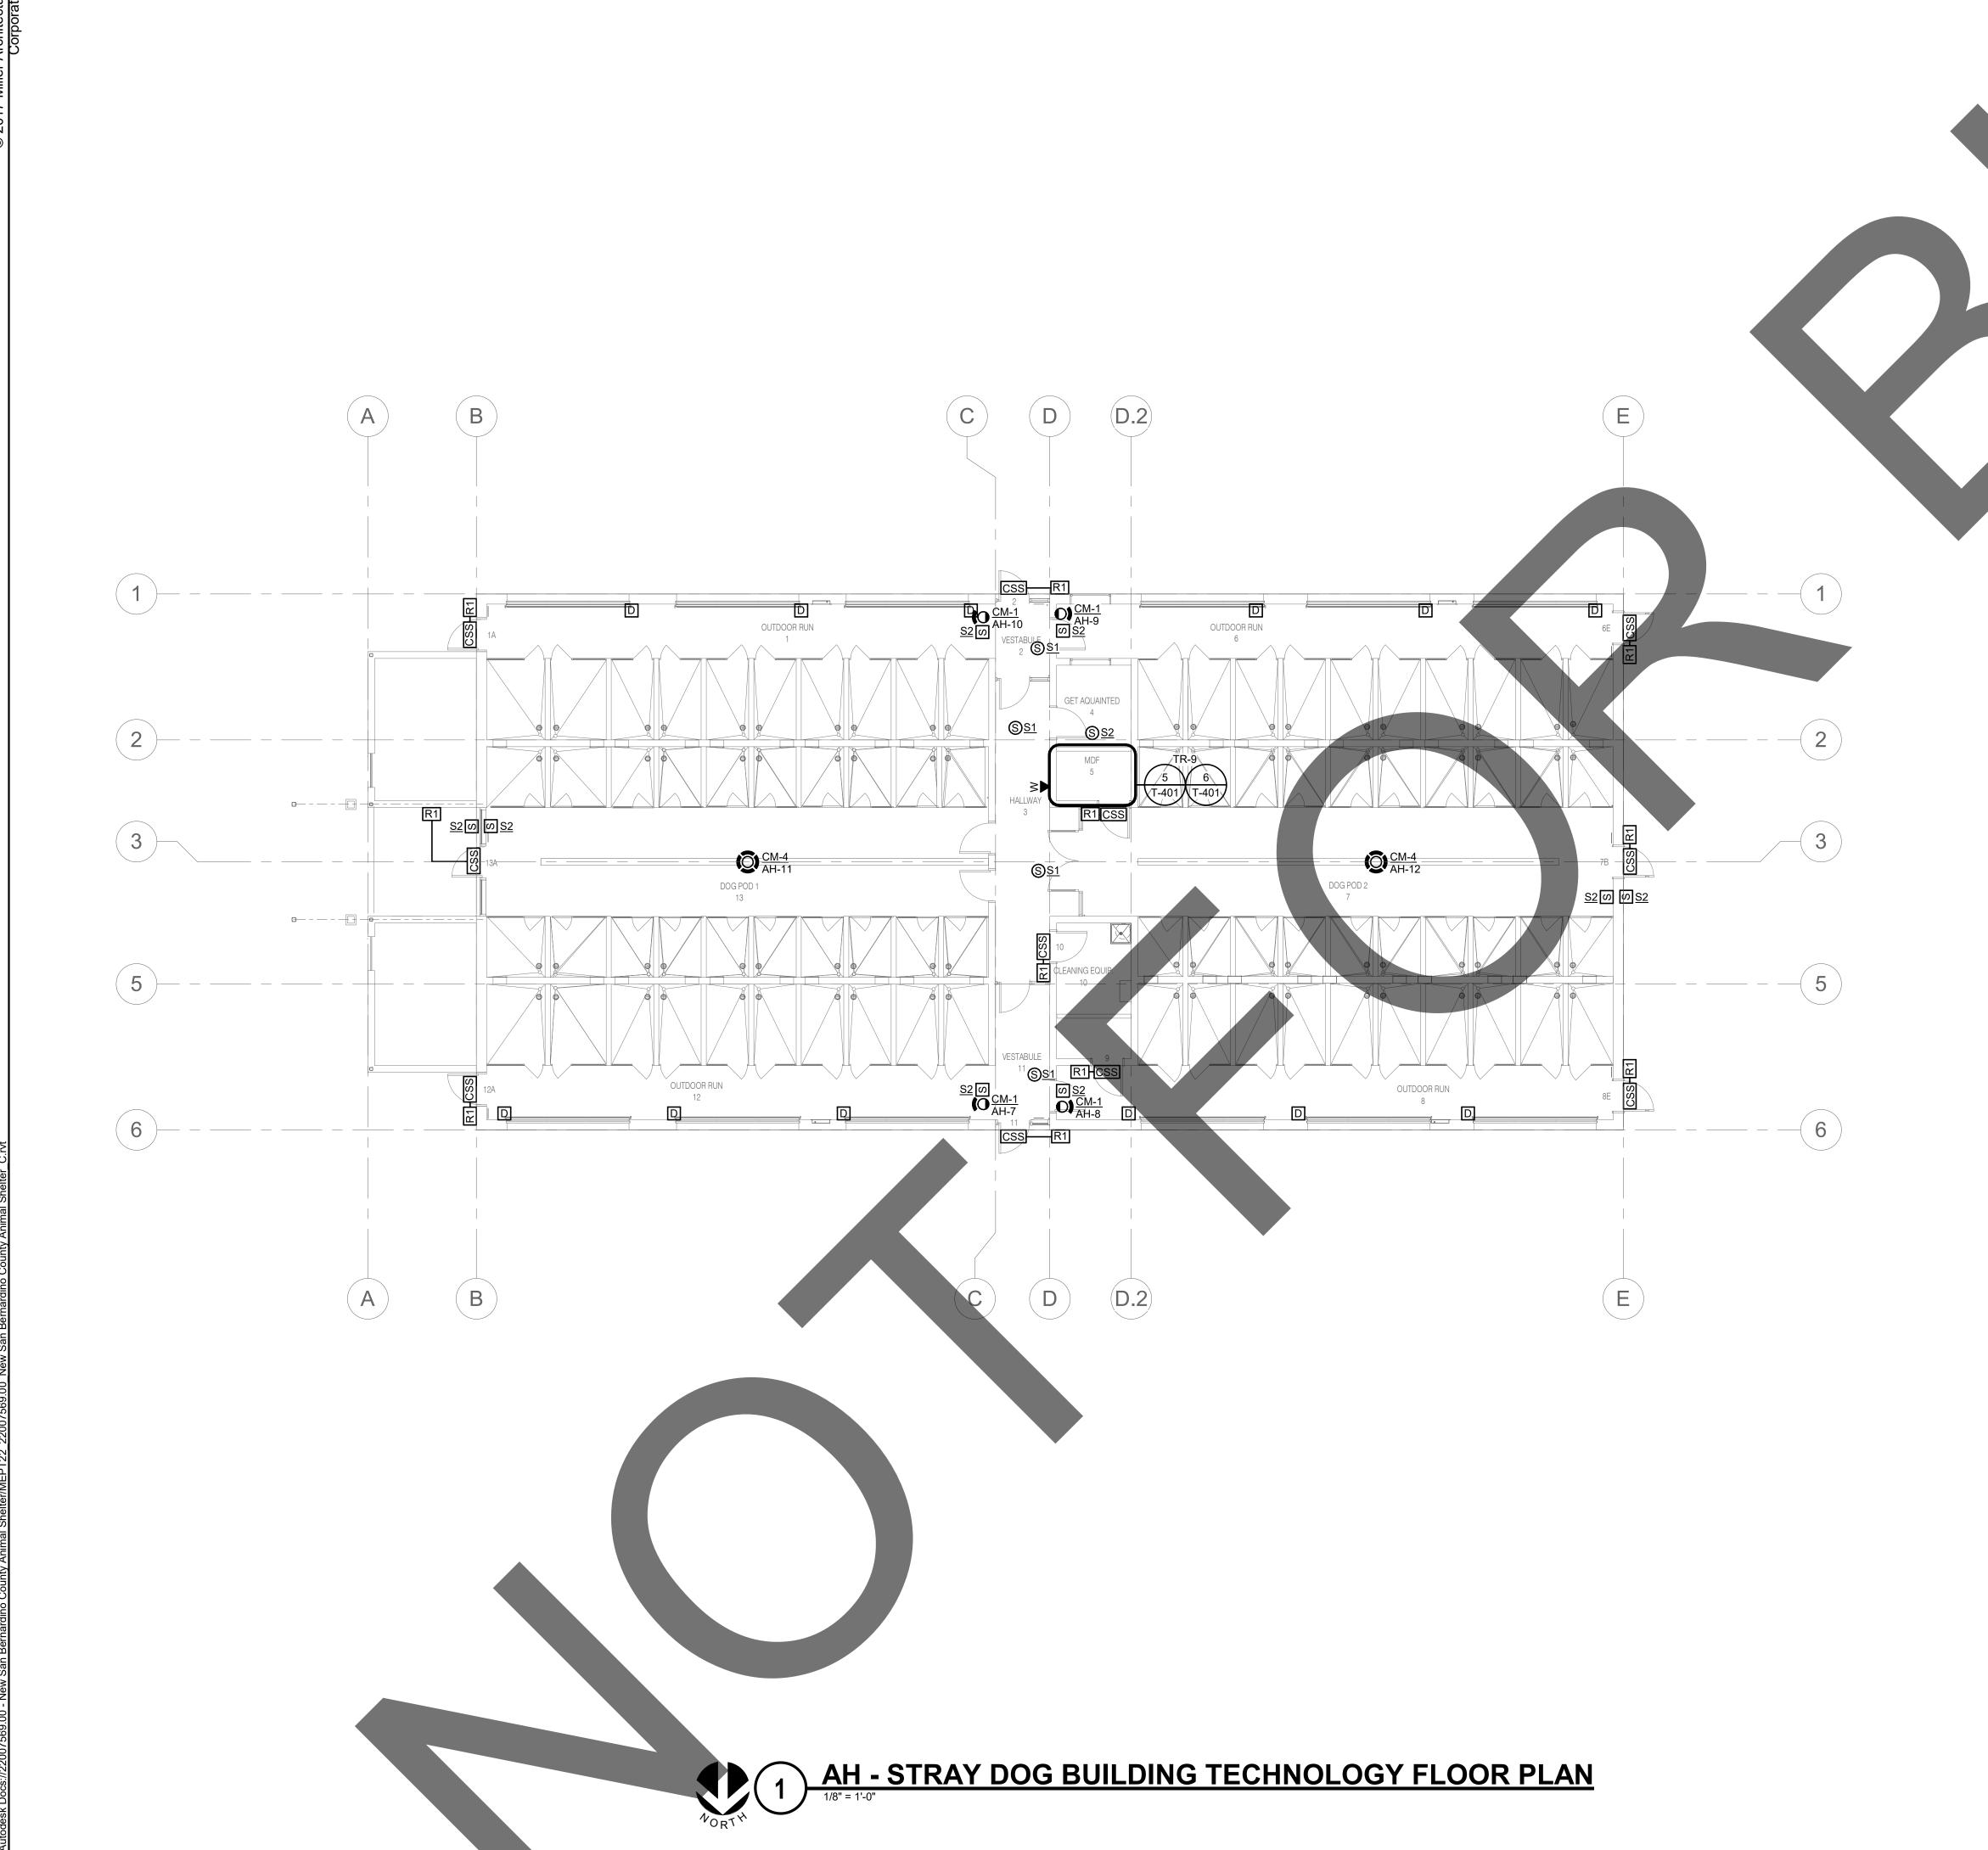

1. ALL CABLING SHOWN ON THIS SHEET SHALL ROUTE TO TR-9, UON.

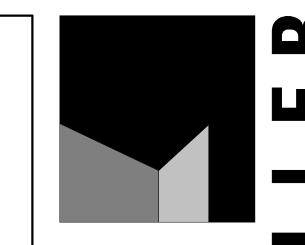

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initials	date	phase	

# revisions/addenda # Date Comment

	TECHNOLOGY SYMBOL LIST			
SYMBOL:	EQUIPMENT LIST ABBREV.:	DESCRIPTION:	NOT	
CSS	N/A	CONTROLLED SECURITY SCHEME SCHEDULE IDENTIFIER	1.	
R#	AC-R#-W	SECURITY CREDENTIAL READER (WALL)		
D	ID-DC1	INTRUSION DETECTION DOOR CONTACT		
⑤ <u>s#</u>	PA-S#-C	FACILITY PAGING SPEAKER (CEILING)	3,4.	
S <u>s#</u>	PA-S#-W	FACILITY PAGING SPEAKER (WALL)	3,4.	
₩ ▼	SC-IO-W	INFORMATION OUTLET WALL PHONE (WALL)		
(CM-#	VS-CM-#	VIDEO SURVEILLANCE CAMERA 360° FOV (CEILING/HORIZONTAL SURFACE)	2.	

#### **GENERAL NOTES:**

ALL SYMBOLS AND ABBREVIATIONS LISTED MAY NOT BE APPLICABLE TO THIS PROJECT.
REFER TO THE TECHNOLOGY EQUIPMENT SCHEDULE FOR MORE COMPLETE DESCRIPTION

VIDEO SURVEILLANCE CAMERA SINGLE LENS FOV (WALL/VERTICAL SURFACE)

- ALL SYMBOLS AND ABBREVIATIONS REFER TO TECHNOLOGY SHEETS ONLY AS DEFINED ON THE SHEET INDEX. REFER TO THE GENERAL TECHNOLOGY NOTES FOR ADDITIONAL INFORMATION.
- ALL SYMBOLS LISTED ABOVE ARE FOR REFERENCE ONLY. REFER TO PLANS AND LINE TYPE KEY FOR NEW, EXISTING TO REMAIN AND TO BE REMOVED ITEMS FOR ADDITIONAL INFORMATION.
- INFORMATION.


  4. REFER TO RISERS ON SHEET(S): T-300, T-301, T-302.

SYMBOL SUBSCRIPT INDICATES PAGING ZONE.

#### **TECHNOLOGY SYMBOL NOTES:**

- I. REFER TO CONTROLLED SECURITY SCHEME (CSS) TYPE SCHEDULE ON T-102 FOR
- ADDITIONAL INFORMATION.

  2. "CM-#" ON FLOOR PLANS INDICATES CAMERA TYPE AND IS ASSOCIATED WITH THE CORRESPONDING "VS-CM-#" EQUIPMENT SCHEDULE ABBREVIATION. "xx-###" SUBSCRIPT INDICATES BLDG INDENTIFIER-CAMERA NUMBER. REFER TO INDIVIDUAL CAMERA REQUIREMENT SCHEDULE FOR ADDITIONAL INFORMATION.
- 4. SYMBOL SUBSCRIPT INDICATES DEVICE TYPE. REFER TO TECHNOLOGY EQUIPMENT SCHEDULE T-101 FOR ADDITIONAL INFORMATION.

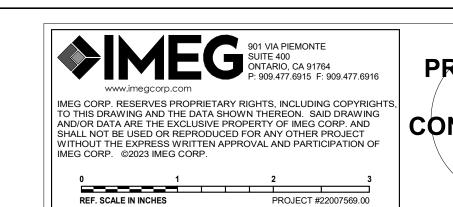

PRELIMINARY
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CONSTRUCTION

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#### project information

project iiiioiiii	ation
Project Number:	122
Drawn By:	Autho
Checked By:	P\$
Issue Date:	05/17/2


#### sheet name

AH - STRAY DOG BUILDING TECHNOLOGY FLOOR PLAN

sheet number

TH-101
Sheet Of Sh

1. ALL CABLING SHOWN ON THIS SHEET SHALL ROUTE TO TR-10, UON.

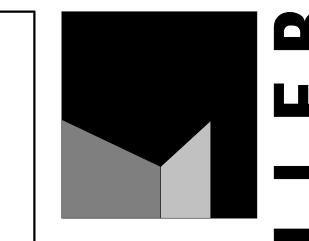

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initials	date	phase	

### revisions/addenda

# Date Comment


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SYMBOL:	EQUIPMENT LIST ABBREV.:	DESCRIPTION:	NOTE:	
CSS	N/A	CONTROLLED SECURITY SCHEME SCHEDULE IDENTIFIER	1.	
R#	AC-R#-W	SECURITY CREDENTIAL READER (WALL)		
D	ID-DC1	INTRUSION DETECTION DOOR CONTACT		
⑤ <u>s#</u>	PA-S#-C	FACILITY PAGING SPEAKER (CEILING)	3,4.	
s <u>s#</u>	PA-S#-W	FACILITY PAGING SPEAKER (WALL)	3,4.	
W	SC-IO-W	INFORMATION OUTLET WALL PHONE (WALL)		
(C) CM-#	VS-CM-#	VIDEO SURVEILLANCE CAMERA 360° FOV (CEILING/HORIZONTAL SURFACE)	2.	
<b>○</b> CM-#	VS-CM-#	VIDEO SURVEILLANCE CAMERA SINGLE LENS FOV (WALL/VERTICAL SURFACE)	2.	

#### **GENERAL NOTES:**

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- ALL SYMBOLS AND ABBREVIATIONS REFER TO TECHNOLOGY SHEETS ONLY AS DEFINED ON THE SHEET INDEX. REFER TO THE GENERAL TECHNOLOGY NOTES FOR ADDITIONAL
- ALL SYMBOLS LISTED ABOVE ARE FOR REFERENCE ONLY. REFER TO PLANS AND LINE TYPE KEY FOR NEW, EXISTING TO REMAIN AND TO BE REMOVED ITEMS FOR ADDITIONAL INFORMATION.
- 4. REFER TO RISERS ON SHEET(S): T-300, T-301, T-302.

#### **TECHNOLOGY SYMBOL NOTES:**

- REFER TO CONTROLLED SECURITY SCHEME (CSS) TYPE SCHEDULE ON T-102 FOR
- ADDITIONAL INFORMATION. "CM-#" ON FLOOR PLANS INDICATES CAMERA TYPE AND IS ASSOCIATED WITH THE CORRESPONDING "VS-CM-#" EQUIPMENT SCHEDULE ABBREVIATION. "xx-###" SUBSCRIPT INDICATES BLDG INDENTIFIER-CAMERA NUMBER. REFER TO INDIVIDUAL CAMERA REQUIREMENT SCHEDULE FOR ADDITIONAL INFORMATION.
- SYMBOL SUBSCRIPT INDICATES PAGING ZONE. SYMBOL SUBSCRIPT INDICATES DEVICE TYPE. REFER TO TECHNOLOGY EQUIPMENT SCHEDULE T-101 FOR ADDITIONAL INFORMATION.

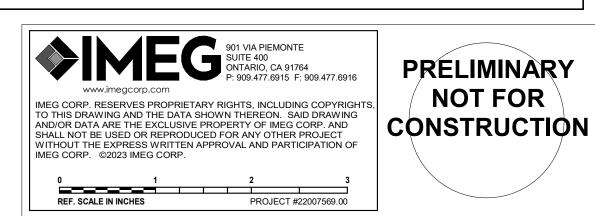

project information


Project Number: Drawn By: Author Checked By: 05/17/24 Issue Date:

#### sheet name

AH.1 - ADOPTION DOG BUILDING 4 **TECHNOLOGY FLOOR** PLAN

sheet number

TH.1-101

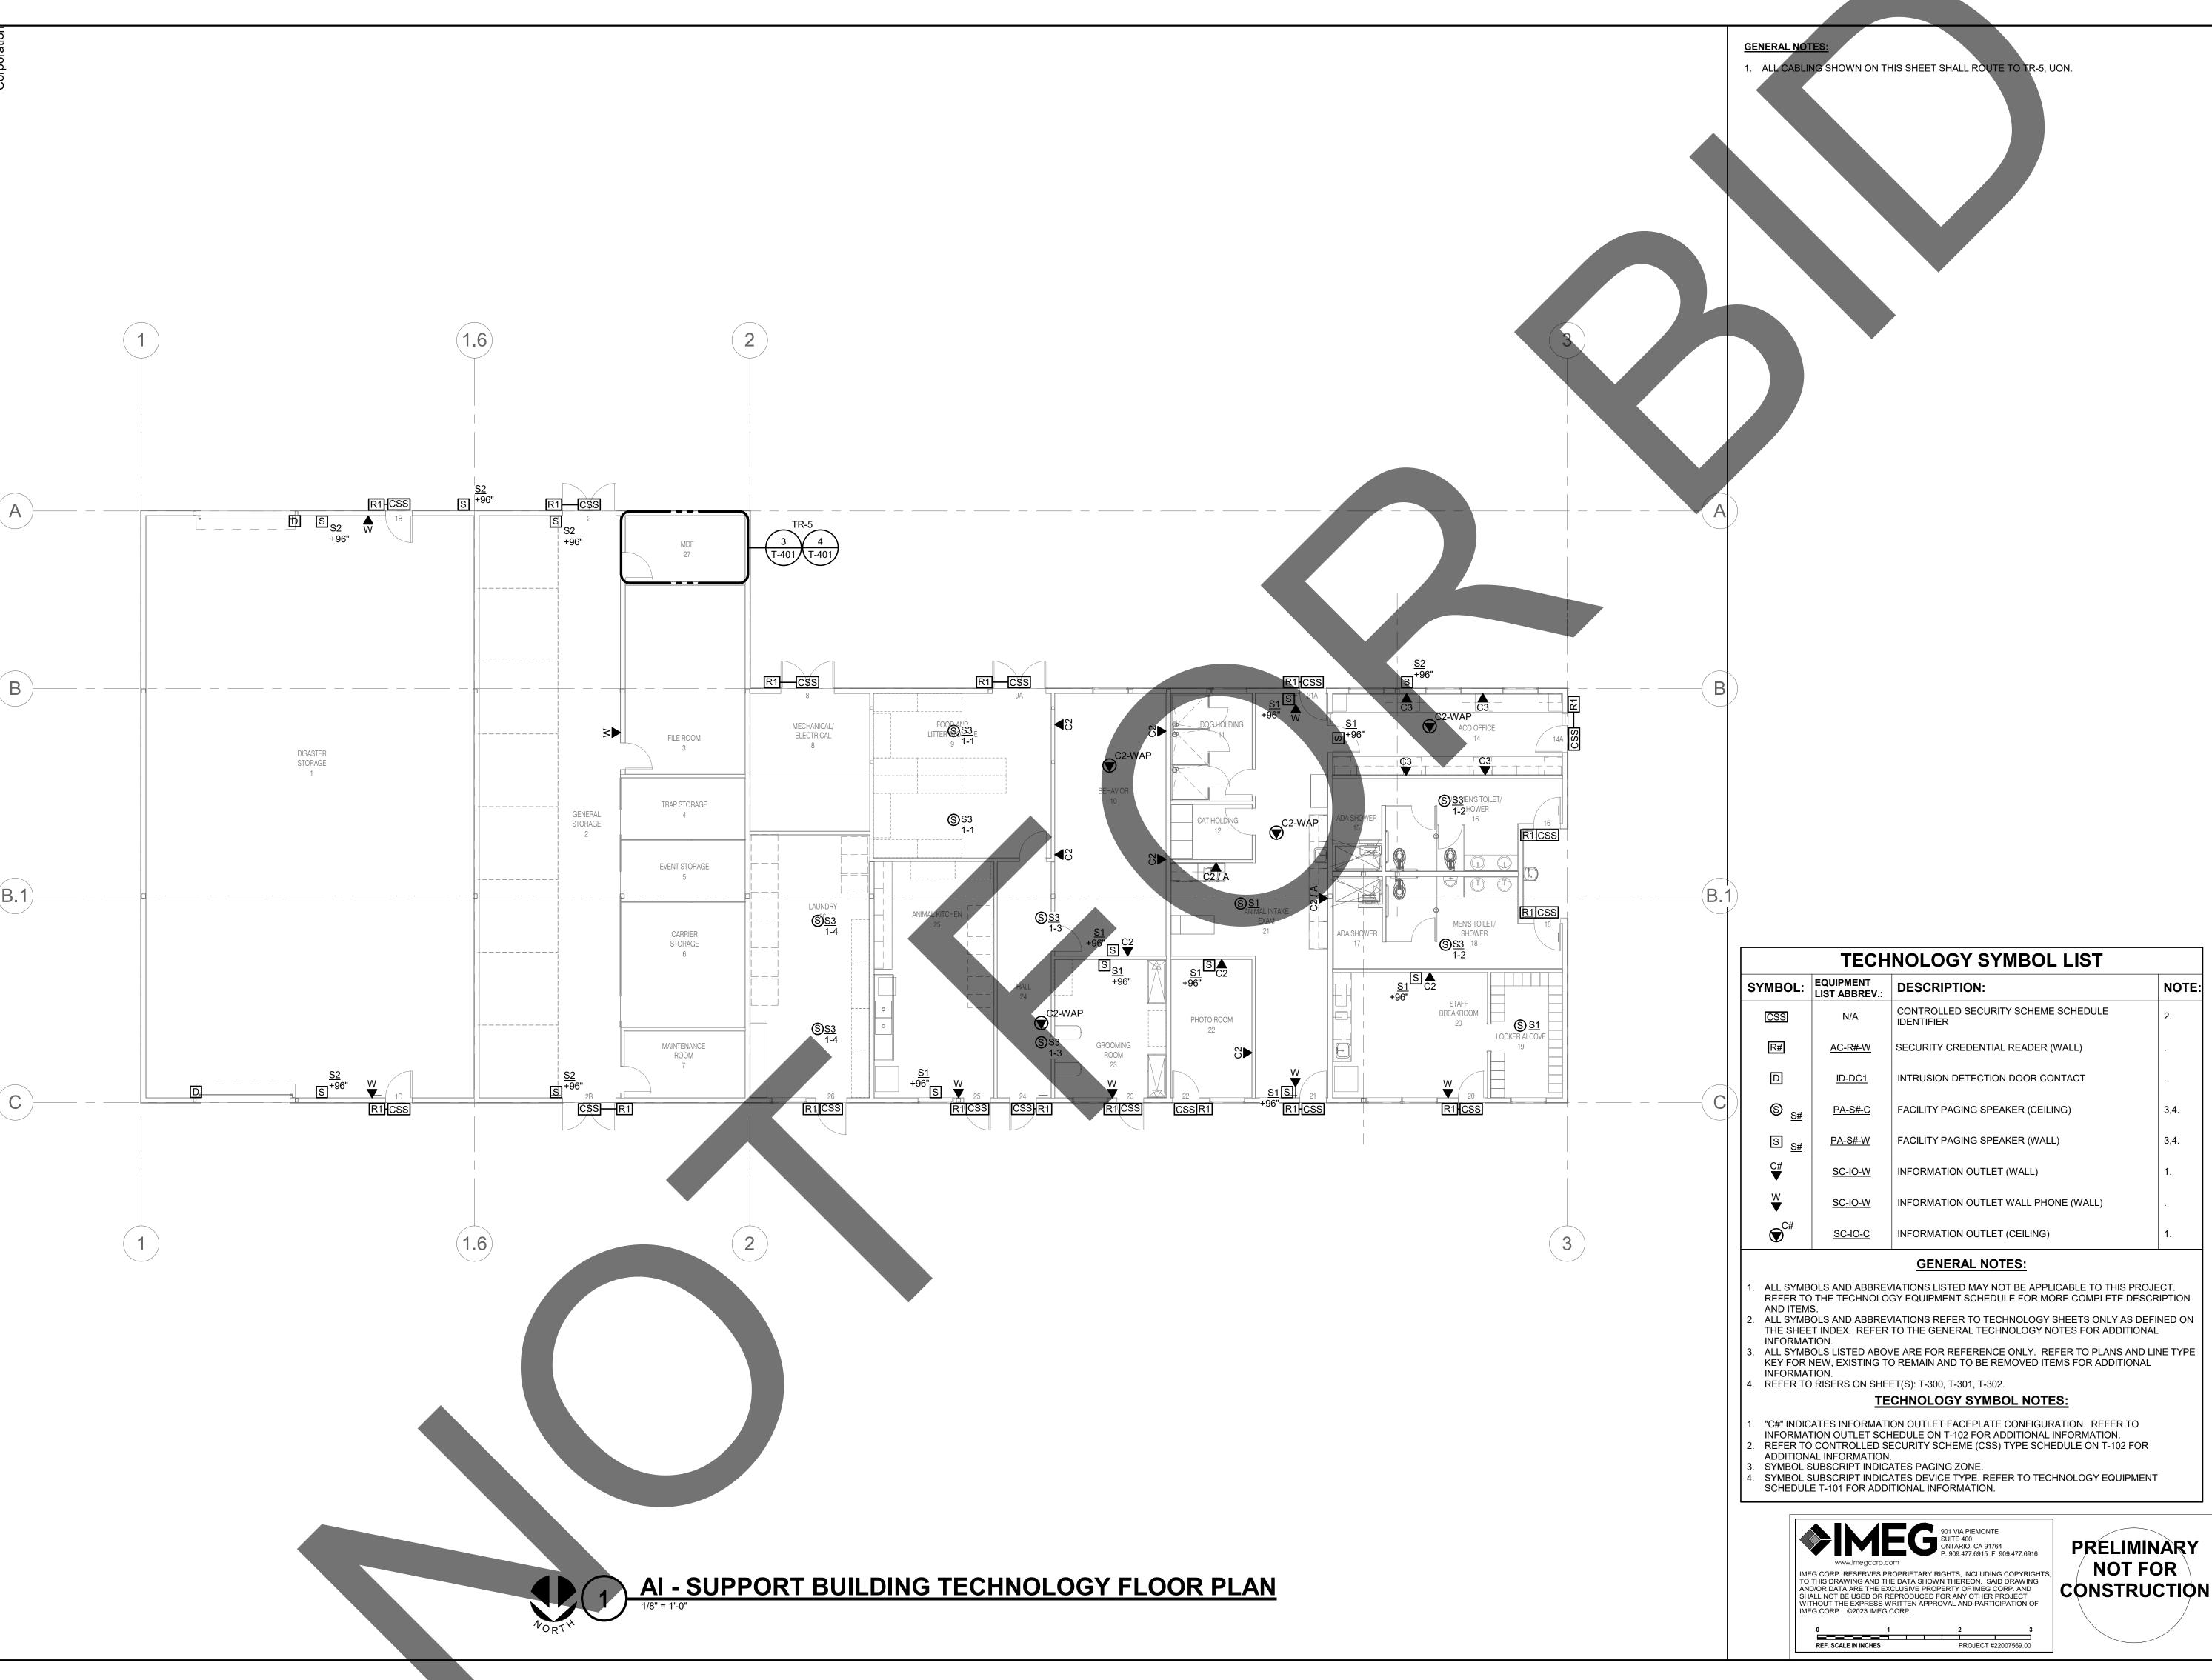





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	owner approval		
	initials	date	phase

revisions/addenda

# Date Comment

NOTE:

# project information

Project Number: Drawn By: Author Checked By: PS 05/17/24 Issue Date:

#### sheet name

AI - SUPPORT BUILDING **TECHNOLOGY FLOOR** PLAN

sheet number


TI-101

1. ALL CABLING SHOWN ON THIS SHEET SHALL ROUTE TO TR-11, UON.





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initials	date	phase
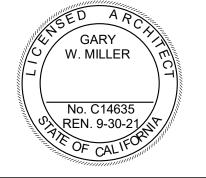
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# Date Comment

	TECHNOLOGY SYMBOL LIST				
SYMBOL:	EQUIPMENT LIST ABBREV.:	DESCRIPTION:	NOTE:		
CSS	N/A	CONTROLLED SECURITY SCHEME SCHEDULE IDENTIFIER	1.		
R#	AC-R#-W	SECURITY CREDENTIAL READER (WALL)			
D	ID-DC1	INTRUSION DETECTION DOOR CONTACT			
S <u>s#</u>	PA-S#-W	FACILITY PAGING SPEAKER (WALL)	3,4.		
₩	SC-IO-W	INFORMATION OUTLET WALL PHONE (WALL)			
(CM-#	VS-CM-#	VIDEO SURVEILLANCE CAMERA 360° FOV (CEILING/HORIZONTAL SURFACE)	2.		
<b>○</b> CM-#	VS-CM-#	VIDEO SURVEILLANCE CAMERA SINGLE LENS FOV (WALL/VERTICAL SURFACE)	2.		

#### **GENERAL NOTES:**

- ALL SYMBOLS AND ABBREVIATIONS LISTED MAY NOT BE APPLICABLE TO THIS PROJECT.

  REFER TO THE TECHNOLOGY EQUIPMENT SCHEDULE FOR MORE COMPLETE DESCRIPTION

  AND ITEMS.
- 2. ALL SYMBOLS AND ABBREVIATIONS REFER TO TECHNOLOGY SHEETS ONLY AS DEFINED ON THE SHEET INDEX. REFER TO THE GENERAL TECHNOLOGY NOTES FOR ADDITIONAL INFORMATION.
- INFORMATION.

  3. ALL SYMBOLS LISTED ABOVE ARE FOR REFERENCE ONLY. REFER TO PLANS AND LINE TYPE KEY FOR NEW, EXISTING TO REMAIN AND TO BE REMOVED ITEMS FOR ADDITIONAL
- INFORMATION.

  REFER TO RISERS ON SHEET(S): T-300, T-301, T-302.

#### TECHNOLOGY SYMBOL NOTES:

- REFER TO CONTROLLED SECURITY SCHEME (CSS) TYPE SCHEDULE ON T-102 FOR
- ADDITIONAL INFORMATION.

  2. "CM-#" ON FLOOR PLANS INDICATES CAMERA TYPE AND IS ASSOCIATED WITH THE CORRESPONDING "VS-CM-#" EQUIPMENT SCHEDULE ABBREVIATION. "xx-###" SUBSCRIPT INDICATES BLDG INDENTIFIER-CAMERA NUMBER. REFER TO INDIVIDUAL CAMERA REQUIREMENT SCHEDULE FOR ADDITIONAL INFORMATION.
- SYMBOL SUBSCRIPT INDICATES PAGING ZONE.
   SYMBOL SUBSCRIPT INDICATES DEVICE TYPE. REFER TO TECHNOLOGY EQUIPMENT SCHEDULE T-101 FOR ADDITIONAL INFORMATION.

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0 1 REF. SCALE IN INCHES	<b>2</b> PROJECT #22007569.	3 00

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#### project information

project information		
Project Number:	1227	
Drawn By:	Autho	
Checked By:	PS	
Issue Date:	05/17/24	

### sheet name

AJ - DOG BUILDING TECHNOLOGY FLOOR PLAN

sheet number

TJ-101

AJ - DOG BUILDING TECHNOLOGY FLOOR PLAN

1/8" = 1'-0"

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CM-1 AJ-1 +96" S

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planning



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initials	date	phase

### revisions/addenda

Comment # Date


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SYMBOL:	EQUIPMENT LIST ABBREV.:	DESCRIPTION:	NOTE:		
CSS	N/A	CONTROLLED SECURITY SCHEME SCHEDULE IDENTIFIER	1.		
R#	AC-R#-W	SECURITY CREDENTIAL READER (WALL)			
D	ID-DC1	INTRUSION DETECTION DOOR CONTACT			
S <u>s#</u>	PA-S#-W	FACILITY PAGING SPEAKER (WALL)	3,4.		
W	SC-IO-W	INFORMATION OUTLET WALL PHONE (WALL)			
(C) CM-#	VS-CM-#	VIDEO SURVEILLANCE CAMERA 360° FOV (CEILING/HORIZONTAL SURFACE)	2.		
<b>○</b> CM-#	VS-CM-#	VIDEO SURVEILLANCE CAMERA SINGLE LENS FOV (WALL/VERTICAL SURFACE)	2.		

#### **GENERAL NOTES:**

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- REFER TO RISERS ON SHEET(S): T-300, T-301, T-302.

#### TECHNOLOGY SYMBOL NOTES:

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- SYMBOL SUBSCRIPT INDICATES PAGING ZONE. . SYMBOL SUBSCRIPT INDICATES DEVICE TYPE. REFER TO TECHNOLOGY EQUIPMENT SCHEDULE T-101 FOR ADDITIONAL INFORMATION.

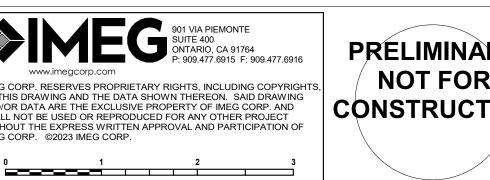

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project information

Project Number: Drawn By: Author Checked By: PS 05/17/24 Issue Date:

sheet name

AK - DOG BUILDING TECHNOLOGY FLOOR PLAN

sheet number

TK-101

AK - DOG BUILDING TECHNOLOGY FLOOR PLAN

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CSS E

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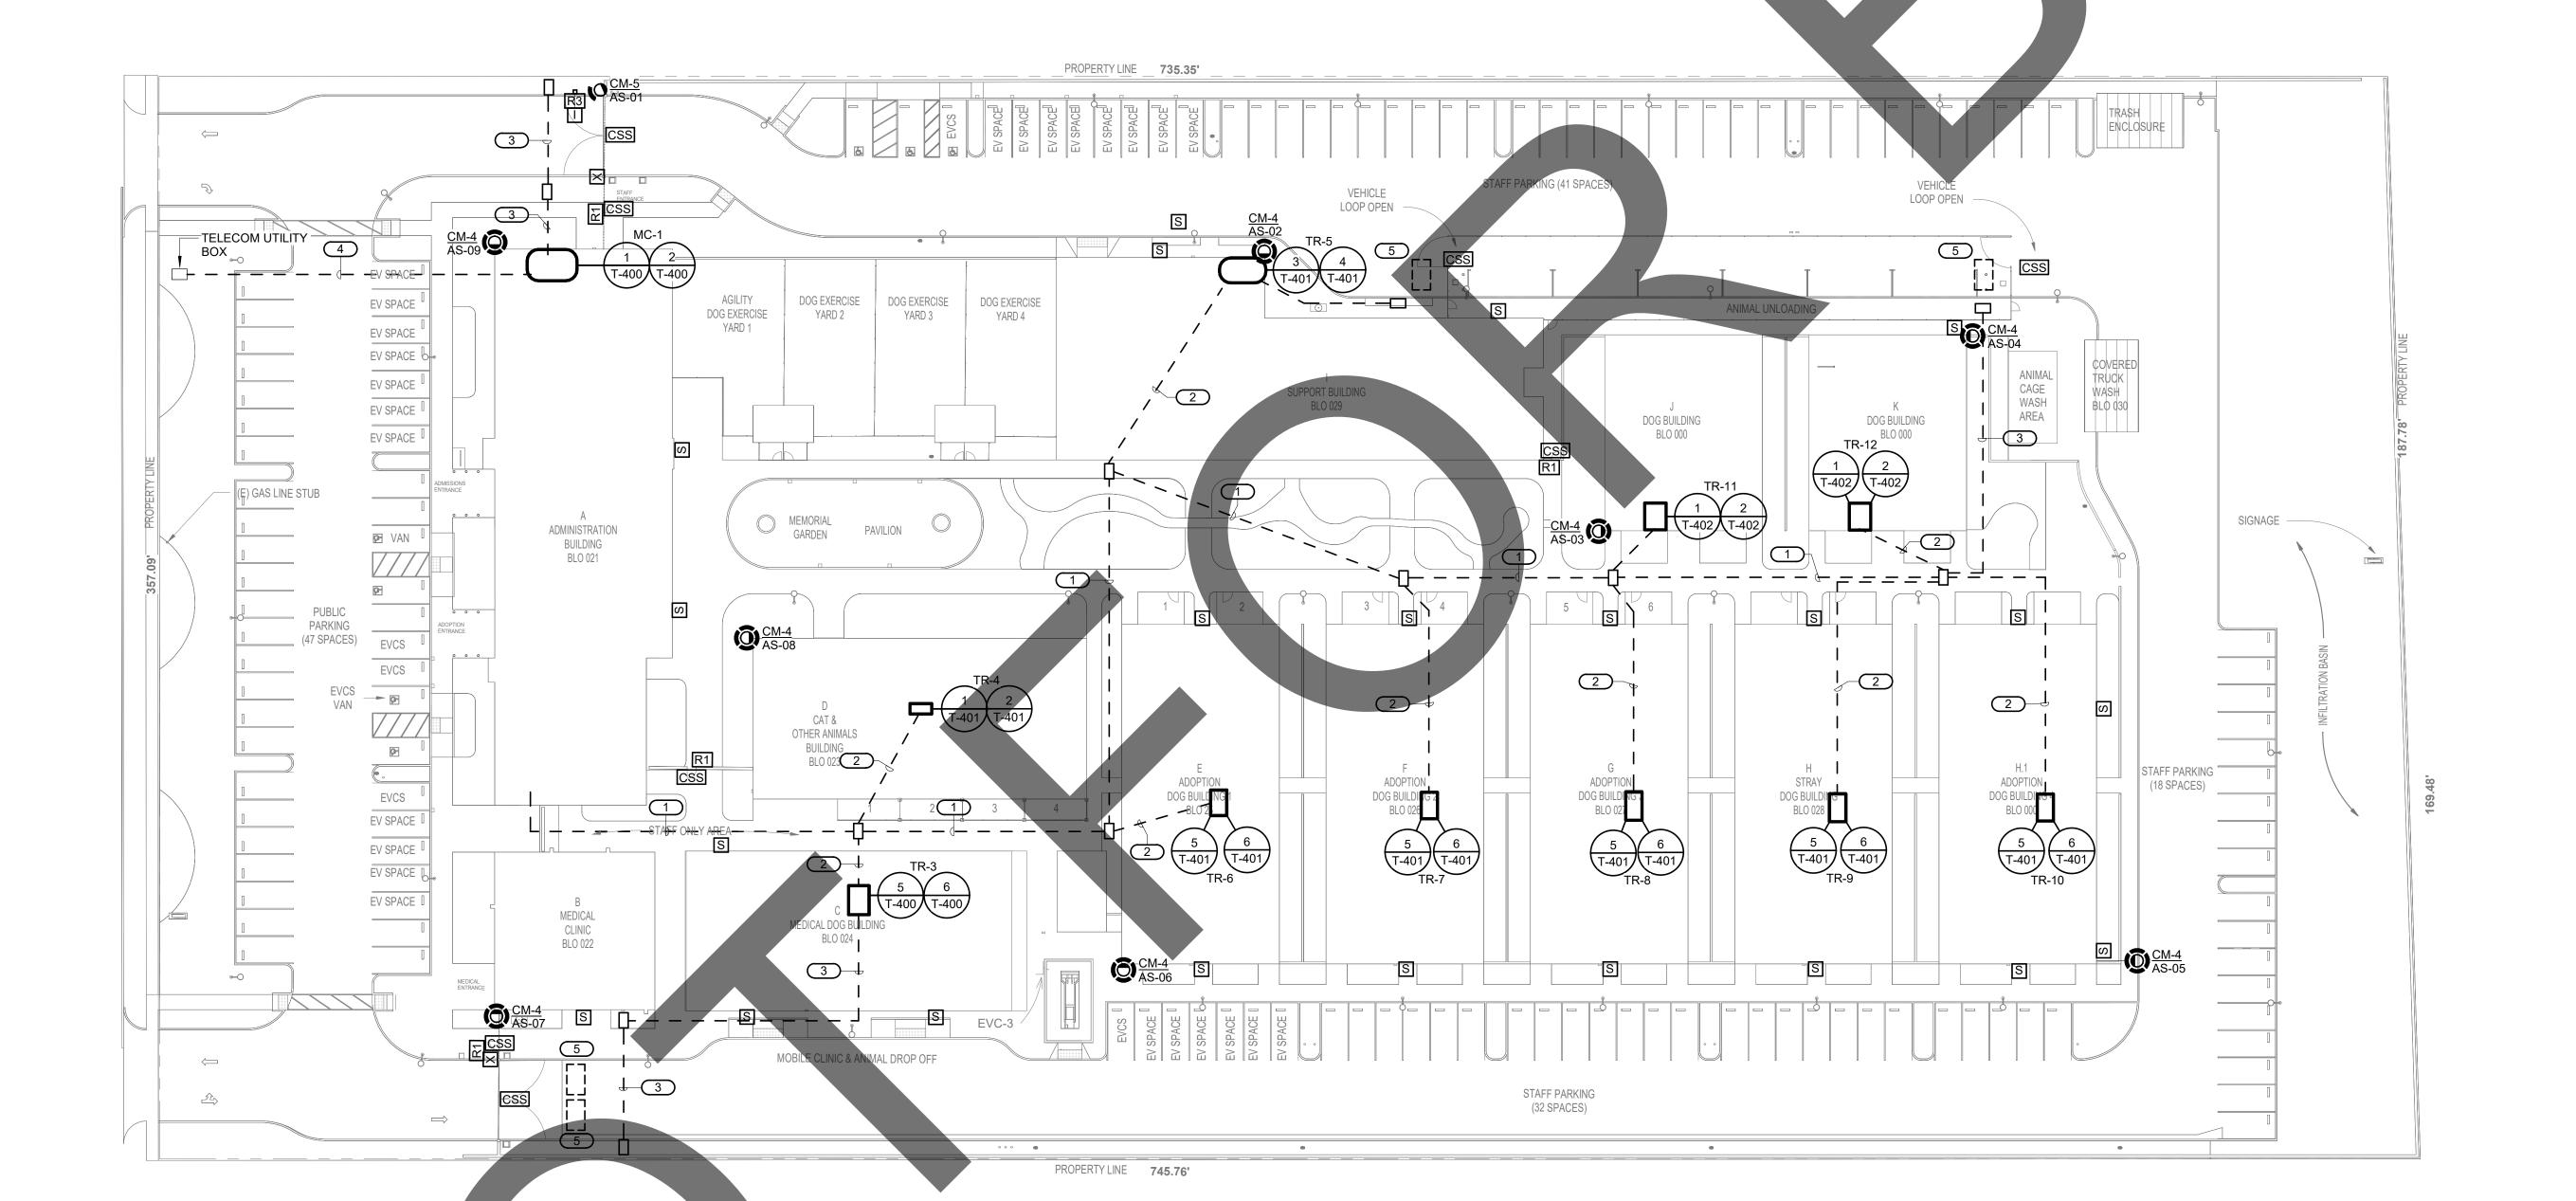
1. REFER TO SHEET TA-102 FOR TR-2 LOCATION.

IOTES: #


PROVIDE UNDERGROUND CONDUIT FOR TECHNOLOGY PATHWAY. QUANTITY AND SIZES (1) 4",

PROVIDE UNDERGROUND CONDUIT FOR TECHNOLOGY PATHWAY. QUANTITY AND SIZE PROVIDE UNDERGROUND CONDUIT FOR TECHNOLOGY PATHWAY. QUANTITY AND SIZE

PROVIDE UNDERGROUND CONDUIT FOR TECHNOLOGY PATHWAY. QUANTITY AND SIZES (2) 4" VEHICLE LOOP DETECTION SYSTEM. REFER TO 1/T-202 FOR INSTALLATION DETAIL.





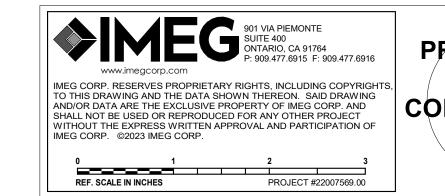


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owner approval				
initials	date	phase		
		owner appro		

revisions/addenda

# Date Comment

project information

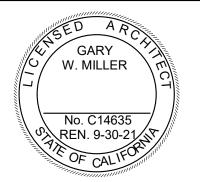Project Number: Drawn By:

Author

PS

Checked By: 05/17/24 Issue Date:

sheet name


TECHNOLOGY SITE PLAN

sheet number

TS-101


# SECTION 270536. **BONDING BUS BAR DETAIL**

- 1. REFER TO TECHNOLOGY EQUIPMENT SCHEDULE <u>SC-GND-1</u> FOR MINIMUM DIMENSION REQUIREMENTS.
- 2. REFER TO 2/T300 FOR TYPICAL TELECOM ROOM BONDING FLOW

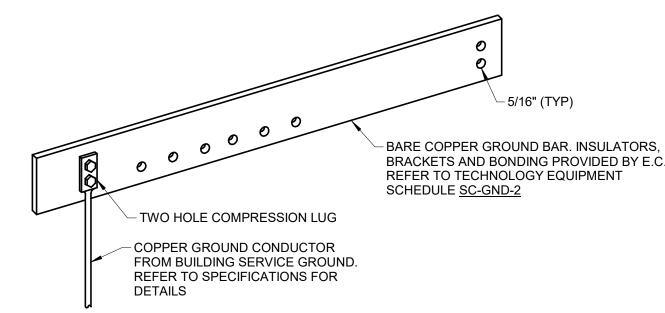

# RACK MOUNT BONDING BUS BAR DETAIL

1. REFER TO TECHNOLOGY EQUIPMENT SCHEDULE <u>SC-GND-2</u> FOR WIDTH REQUIREMENTS.

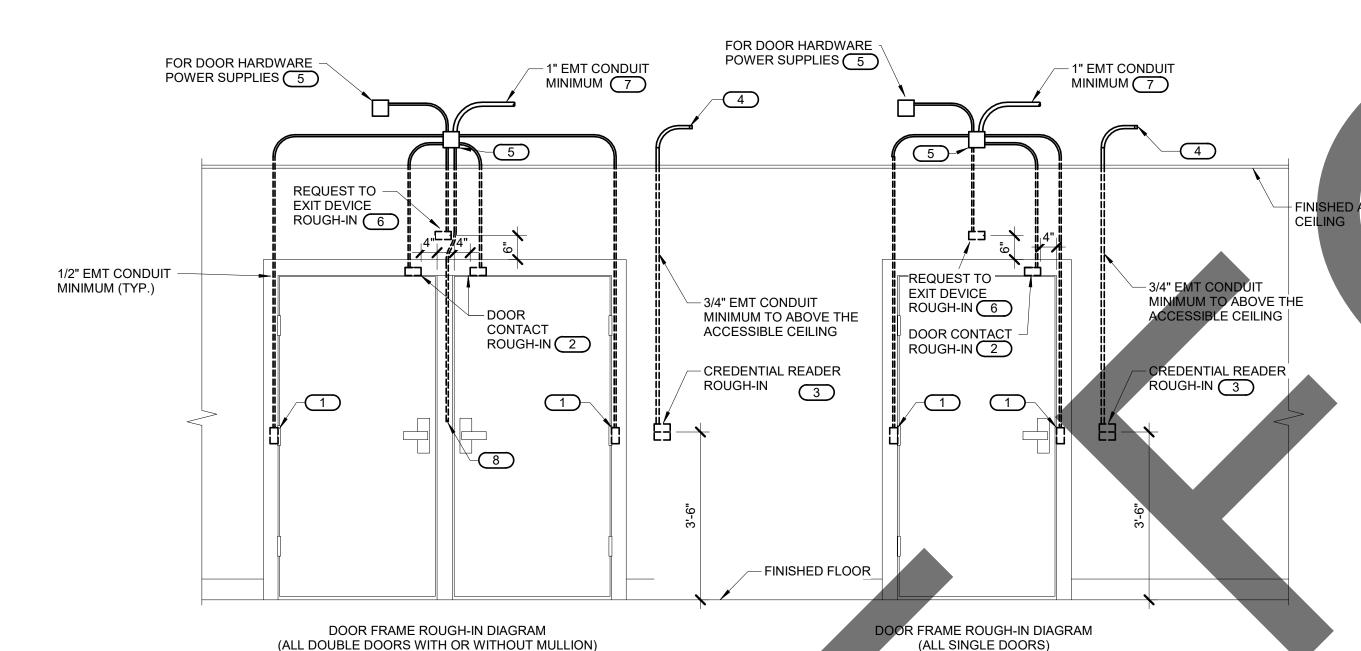

# CONTROLLED SECURITY SCHEME DOOR ROUGH-IN DETAIL

- 1. CONFIGURATIONS SHOWN IN THE DETAIL ABOVE ARE DIAGRAMMATIC, INTENDED TO DESCRIBE THE CONTROLLED SECURITY SCHEME ROUGH-IN REQUIREMENTS OF THE DOORS. DETAILS ABOVE MAY NOT ACCURATELY REPRESENT DOOR SIZE, DOOR SWING, DOOR HARDWARE, OR DOOR FUNCTIONALITY. REFER TO ARCHITECTURAL DOOR HARDWARE SCHEDULE, DOOR HARDWARE GROUPS AND DOOR HARDWARE SPECIFICATIONS FOR COMPLETE INFORMATION. MIRROR THE DETAIL AS REQUIRED.
- 2. ROUGH IN SHOWN IN THE DETAIL ABOVE REPRESENTS THE MINIMUM REQUIREMENTS FOR ALL CONTROLLED SECURITY SYSTEM DEVICES AND CABLING UNLESS OTHERWISE NOTED. COORDINATE EXACT REQUIREMENTS WITH SELECTED DOOR MATERIALS, DOOR HARDWARE, AND CONTROLLED SECURITY DEVICES AND CABLING PRIOR TO INSTALLATION.
- 3. ALL CABLING IN WALLS AND WHERE EXPOSED ON VERTICAL SURFACES SHALL BE INSTALLED IN EMT CONDUIT OR SURFACE MOUNT RACEWAY. CABLING ROUTED HORIZONTALLY ABOVE THE ACCESSIBLE CEILING MAY BE INSTALLED FREE-AIR CABLING PROPERLY RATED FOR THE CEILING ENVIRONMENT.
- 4. THE ELECTRICAL OR SECURITY CONTRACTOR SHALL NOT MODIFY ANY FIRE TED DOOR AND/OR DOOR FRAME. REFER TO THE ARCHITECTURAL DOOR SCHEDULE, DOOR HARDWARE SCHEDULE, AND DOOR HARDWARE SPECIFICATION FOR ADDITIONAL INFO MATION. MODIFICATION TO ANY FIRE RATED DOOR AND/OR FRAME WILL REQUIRE A RE-CERTIFICATION OF THE DOOR AND FRAME WITH THE LOCAL AUTHORITY HAVING JURISDICTION
- 5. INSTALLING CONTRACTOR SHALL FURNISH AND INSTALL FIRESTOP MATERIALS FOR ALL CONTROLLED SECURITY SCHEME ROUGH-INS PER PROJECT REQUIREMENTS. REFER TO SPECIFICATIONS FOR ADDITIONAL INFORMATION AND REQUIREMENTS
- . REFER TO THE CONTROLLED SECURITY SCHEME SCHEDULE ON T-103 FOR ADDITIONAL INFORMATION.
- 7. INSTALLATION SHALL INCLUDE ALL POWER REQUIRED FOR SYSTEM OPERATION INCLUDING +120VAC. REFER TO THE SUGGESTED MATRIX OF SCOPE RESPONSIBILITY FOR ADDITIONAL INFORMATION.


#### KEYNOTES: #

IN. PROVIDE A NYLON BUSHING ON THE CONDUIT END.

- 1. PROVIDE JUNCTION BOXES IN THE DOOR FRAME WHERE SHOWN ON THIS DETAIL. ROUGH-IN SHALL BE PROVIDED WHETHER THE CURRENT SECURITY SCHEME UTILIZES THEM OR NOT.
  ALL CONDUITS SHALL BE EMT CONDUIT UNLESS OTHERWISE NOTED. FLEXIBLE CONDUIT OF ANY TYPE WILL NOT BE ACCEPTED. COORDINATE INSTALLATION WITH ON-SITE DOOR FRAME
- 2. ALL DOOR POSITION SWITCHES ARE REQUIRED TO BE RECESSED UNLESS OTHERWISE NOTED. ELECTRIC HINGE MONITORS ARE NOT AN ACCEPTABLE REPLACEMENT FOR THE RECESSED DOOR POSITION SWITCH.
- 3. 4" SQUARE BACKBOX WITH SINGLE GANG PLASTER RING. PROVIDE 2 1/2" DEEP MASONRY BOX WHERE APPLICABLE. REFER TO FLOOR PLAN(S) FOR ACTUAL CREDENTIAL READER TYPE AND ROUGH-IN LOCATIONS.
- 4. CONDUIT SHALL ROUTE FROM THE CREDENTIAL READER TO THE SECURE SIDE OF THE DOOR. CONDUIT SHALL ROUTE TO THE NEAREST TELECOM ROOM. 5. MOUNT A MINIMUM 4" SQUARE 2-1/8" DEEP JUNCTION BOX WITH BLANK COVER PLATE ON THE SECURE SIDE OF THE DOOR ABOVE ACCESSIBLE CEILING. INSTALLING CONTRACTOR SHALL
- SIZE THE JUNCTION BOXES PER SYSTEM INSTALLATION REQUIREMENTS AND APPLICABLE CODES. MAINTAIN ACCESS TO THE JUNCTION BOX.

  6. PROVIDE A HORIZONTALLY MOUNTED SINGLE GANG BACKBOX FOR THE REQUEST TO EXIT SENSOR. REFER TO THE CONTROLLED SECURITY SCHEME SCHEDULE ON T-103 FOR DOORS
- THAT REQUIRE THIS ROUGH-IN.
- 7. CONDUIT SHALL ROUTE TO THE NEAREST TELECOM ROOM. 8. CONDUIT INSTALLED IN PERMANENT MULLIONS ONLY. REFER TO THE ARCHITECTURAL DOOR SCHEDULE AND DOOR HARDWARE GROUPS FOR LOCATIONS THAT REQUIRE THIS ROUGH-


#### CABLE EXTENDS TO THE NEAREST TELECOMMUNICATIONS ROOM

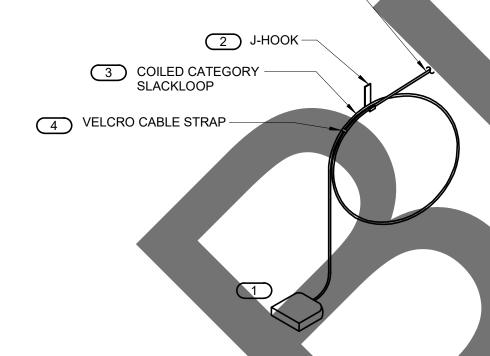

# ABOVE CEILING INFORMATION OUTLET MOUNTING DETAIL

GRAM MAY NOT REPRESENT THE QUANTITY OF CABLES TO EACH INFORMATION OUTLET JUNCTION BOX. REFER TO THE DRAWINGS AND DRMATION OUTLET SCHEDULE FOR ADDITIONAL INFORMATION. 2. ALL DEVICES ARE INSTALLED ABOVE THE CEILING UNLESS OTHERWISE NOTED.

- PLENUM RATED SURFACE MOUNTED BOX, SUPPORT FROM J-HOOK. REFER TO THE INFORMATION OUTLET SCHEDULE AND TECHNOLOGY MENT SCHEDULE FOR ADDITIONAL INFORMATION.
- OUNT A DEDICATED J-HOOK TO THE NEAREST CEILING SUBSTRUCTURE, COLUMN, JOIST, OR WALL ABOVE THE CEILING AS SHOWN ON THE AWINGS. PROVIDE THE PROPER SUPPORT WHEN HANGING FROM THE CEILING SUBSTRUCTURE OR COLUMN WALL OR JOIST. REFER TO
- SPECIFICATION SECTION 27 05 28 FOR ADDITIONAL REQUIREMENTS. 00 FOR SLACKLOOP LENGTH. MAINTAIN THE MANUFACTURERS BEND RADIUS FOR SLACKLOOP SIZE. PROVIDE AND INSTALL A VELCRO CABLE STRAP ON THE SLACKLOOP APPROXIMATELY EVERY 6" ALONG THE SLACKLOOP. FOR SLACKLOOPS GREATER THAN 3' A MINIMUM OF (4) STRAPS WILL BE INSTALLED.

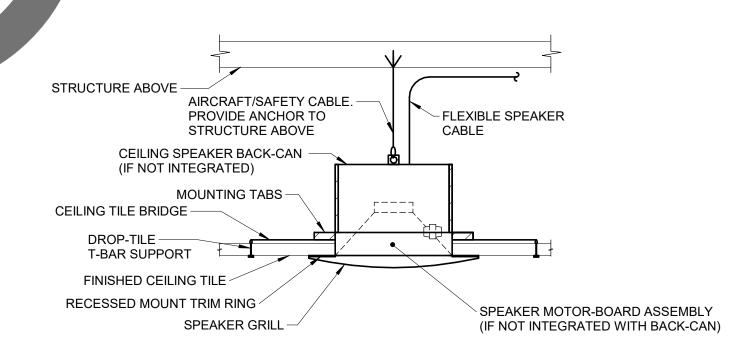

# **CEILING SPEAKER MOUNTING DETAIL**

WHERE SUPPORTS ATTACH TO METAL ROOF DECKING, EXCLUDING CONCRETE ON METAL DECKING, DO NOT EXCEED 25 LBS. PER HANGAR AND A MINIMUM SPACING OF 2'-0" ON CENTER. THIS 25 LB. LOAD AND 2'-0" SPACING INCLUDE ELECTRICAL AND MECHANICAL ITEMS HANGING FROM DECK. IF THE HANGER RESTRICTIONS CANNOT BE ACHIEVED, THE ADDITION OF SUPPLEMENTAL FRAMING OFF STEEL FRAMING WILL BE REQUIRED.

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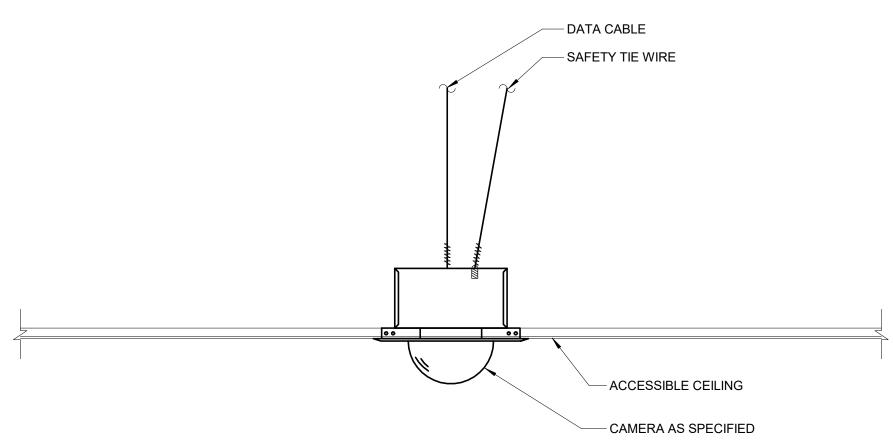
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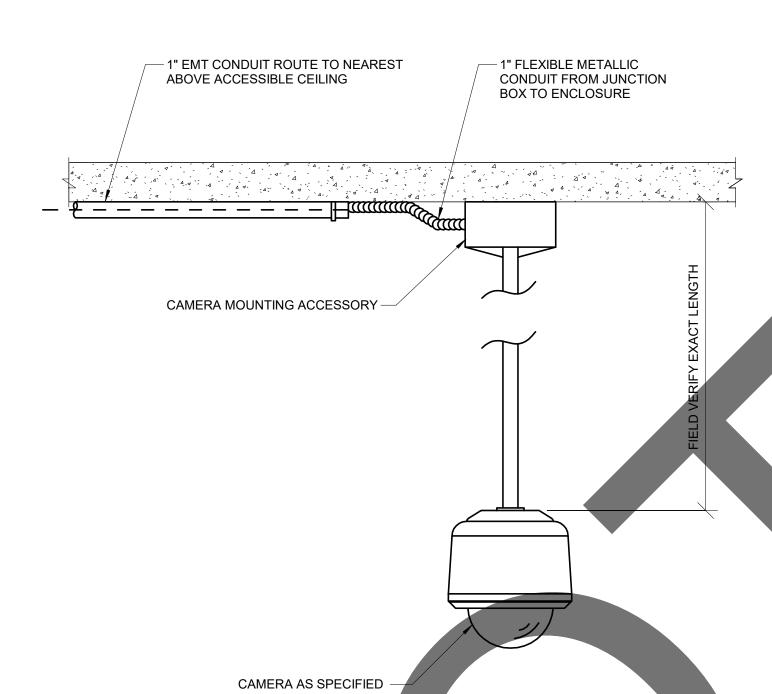
T-200

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# ACCESSIBLE CEILING CAMERA MOUNT AND ROUGH-IN DETAIL NO SCALE


- 1. COORDINATE EXACT LOCATION ON SITE WITH WORK BY OTHER TRADES TO ENSURE DESIRED VIEWING AREA AND SERVICE ACCESS AFTER COMPLETION OF
- PROJECT AND TO MINIMIZE ANY POSSIBLE DAMAGE TO INSTALLED CAMERA OR ASSOCIATED CABLING. 2. PROVIDE CAMERA MOUNTING ACCESSORIES REQUIRED FOR A COMPLETE INSTALLATION FROM THE SAME MANUFACTURER OF THE CAMERA AND APPROVED BY THE MANUFACTURER FOR USE WITH THE SPECIFIC MODEL NUMBER OF CAMERA INSTALLED.



# CEILING PENDANT CAMERA MOUNT AND ROUGH-IN DETAIL NO SCALE

- COORDINATE EXACT LOCATION ON SITE WITH WORK BY OTHER TRADES TO ENSURE DESIRED VIEWING AREA AND SERVICE
  ACCESS AFTER COMPLETION OF PROJECT AND TO MINIMIZE ANY POSSIBLE DAMAGE TO INSTALLED CAMERA OR ASSOCIATED
  CABLING. FIELD COORDINATE PENDANT LENGTH TO ENSURE CAMERA VIEW IS NOT OBSTRUCTED.
- INSTALLING CONTRACTOR SHALL FURNISH AND INSTALL FIRESTOP MATERIALS FOR CAMERA ROUGH-INS PER PROJECT
- REQUIREMENTS. REFER TO SPECIFICATIONS FOR FIRESTOP REQUIREMENTS.

  PROVIDE CAMERA MOUNTING ACCESSORIES REQUIRED FOR A COMPLETE INSTALLATION FROM THE SAME MANUFACTURER OF THE CAMERA AND APPROVED BY THE MANUFACTURER FOR USE WITH THE SPECIFIC MODEL NUMBER OF CAMERA INSTALLED.

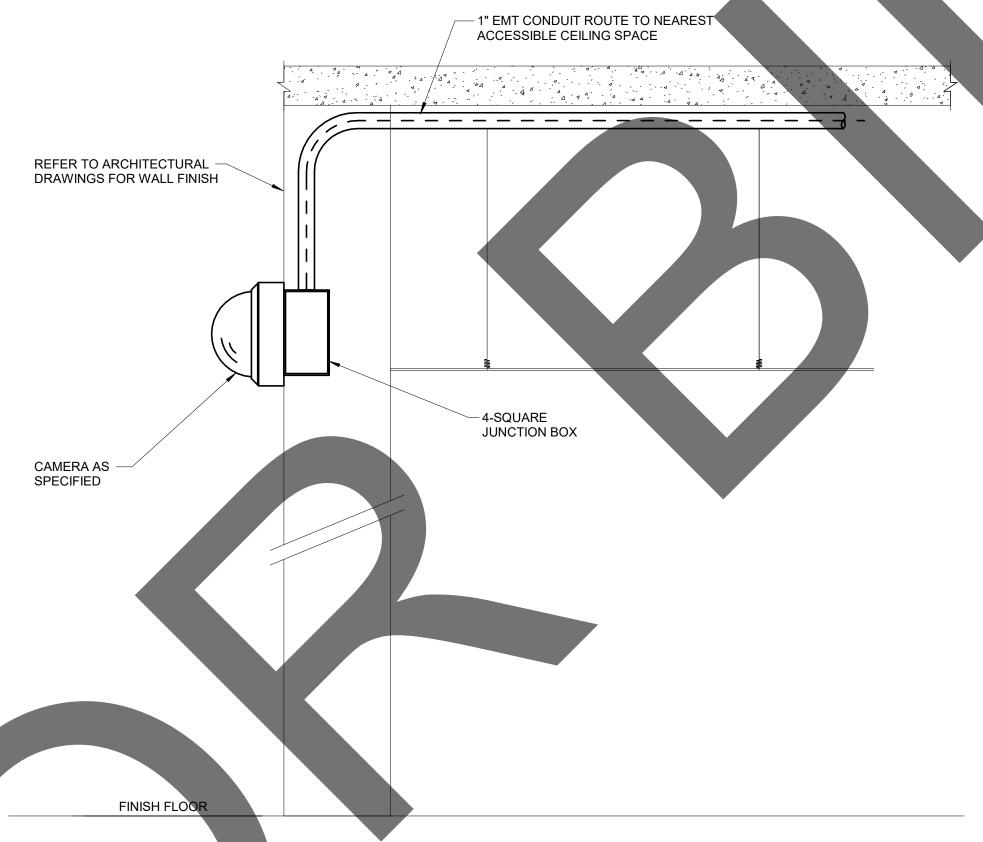


# INTERIOR WALL CAMERA MOUNT AND ROUGH-IN DETAIL

- COORDINATE EXACT LOCATION ON SITE WITH WORK BY OTHER TRADES TO ENSURE DESIRED VIEWING AREA AND SERVICE ACCESS AFTER COMPLETION OF PROJECT AND TO MINIMIZE ANY POSSIBLE DAMAGE TO INSTALLED CAMERA OR ASSOCIATED CABLING.
  INSTALLING CONTRACTOR SHALL FURNISH AND INSTALL FIRESTOP MATERIALS FOR CAMERA ROUGH-INS PER PROJECT REQUIREMENTS. REFER
- TO SPECIFICATIONS FOR FIRESTOP REQUIREMENTS.

  PROVIDE CAMERA MOUNTING ACCESSORIES REQUIRED FOR A COMPLETE INSTALLATION FROM THE SAME MANUFACTURER OF THE CAMERA AND APPROVED BY THE MANUFACTURER FOR USE WITH THE SPECIFIC MODEL NUMBER OF CAMERA INSTALLED.





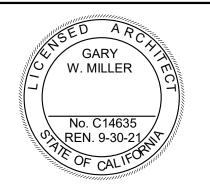

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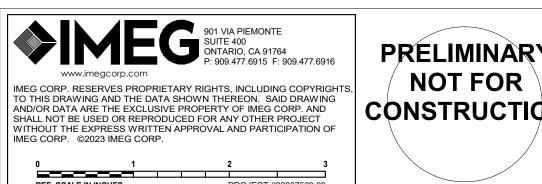
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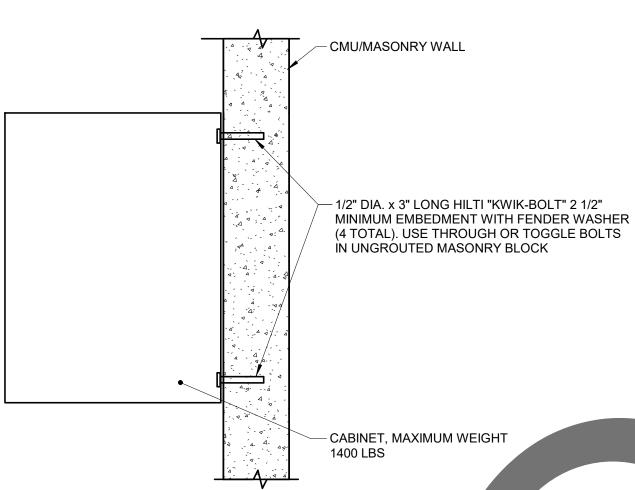
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# 1 LOOP DETECTION DETAIL NO SCALE

#### NOTES:


- CUT A GROOVE IN PATTERN AS SHOWN ABOVE. LOOP WIRING MUST BE MINIMUM 3/8" BELOW GRADE LEVEL TO ALLOW FOR BACK PATCH FILLER MATERIAL.
- 2. LOOP WIRES ARE #14 GAUGE TYPE 'THHN' SINGLE
  CONDUCTOR STRANDED. MAKE 3 TURNS OF WIRE IN LOOP
  GROOVE. THEN TWIST LEAD-IN WIRES TOGETHER WITH A
  MINIMUM OF 2 TWISTS PER FOOT. THEN PULL LEAD-IN WIRE
  THROUGH CONDUIT. CAUTION: LEAD-IN WIRE AND LOOP MUST
- BE A CONTINUOUS PIECE OF WIRE WITH NO SPLICES.


  3. SEAL LEAD-IN WIRE IN CONDUIT TO PREVENT MOISTURE SEEPAGE INTO CONDUIT. COMPLETELY FILL SLOTS AND BLOCK-OUT WITH EPOXY AFTER WIRING IS INSTALLED AND
- 4. WHEN LOOP IS TO BE INSTALLED NEAR STEEL REINFORCEMENTS, IT MUST BE A MINIMUM OF 2" AWAY FROM THE REINFORCEMENT.
- 5. SUGGESTED BACK PATCH MATERIAL: CONCRETE COLORED, FAST DRYING CEMENT. POR-ROCK OR APPROVED EQUIVALENT.



3 SURFACE MOUNTED CABINET CMU/MASONRY WALL DETAIL

NO SCALE
T\_160\_17

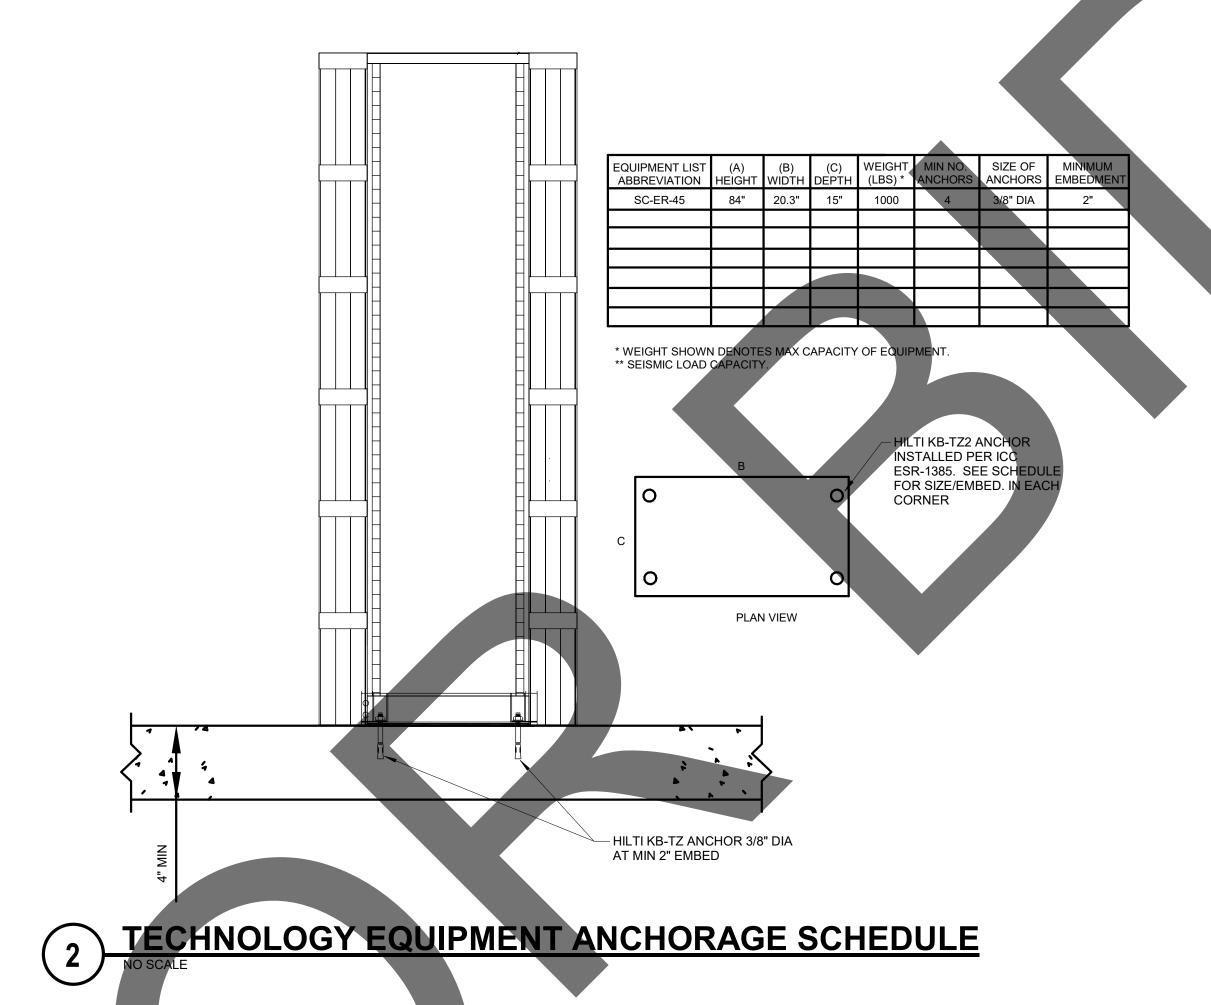

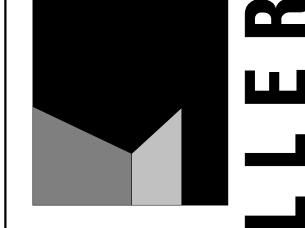

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18313 VALLEY BLVD. BLOOMINGTON, CA 92313

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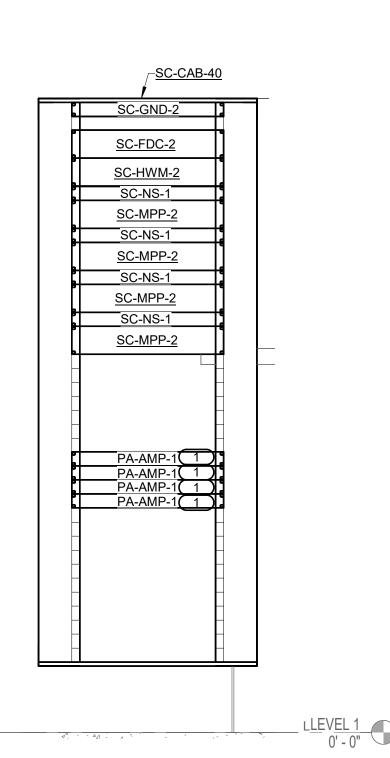
# AA - MC-1 - RACK ELEVATION

**GENERAL NOTES:** 

- 1. REFER TO 1/T-400 FOR MC-1 EQUIPMENT PLAN.
- 2. REFER TO 2/T-400 FOR MC-1 PATHWAY PLAN. 3. LOCATED ON FIRST FLOOR IN BUILDING AA - ADMINISTRATION BUILDING.
- REFER TO TA-101 FOR OVERALL FLOOR PLAN. 4. REFER TO 2/T-202 FOR EQUIPMENT RACK MOUNTING DETAIL.
- 5. COORDINATE FINAL LOCATION OF RACK MOUNTED EQUIPMENT WITH OWNER PRIOR TO INSTALLATION.
- 6. DATA OUTLETS, PAGING, AND VIDEO SURVEILLANCE TO BE PLACED ON SEPARATE PATCH PANELS. CONTRACTOR TO VERIFY QUANTITY.

#### KEY NOTES: #

1. TWO PA-AMP-1 MOUNTED IN EACH RACK UNIT.




# **AD - TR-4 - RACK ELEVATION**

#### **GENERAL NOTES:**

- REFER TO 1/T-401 FOR TR-4 EQUIPMENT PLAN.
- REFER TO 2/T-401 FOR TR-4 PATHWAY PLAN. LOCATED IN BUILDING AD - CAT AND OTHER ANIMALS BUILDING
- REFER TO TD-101 FOR OVERALL FLOOR PLAN. REFER TO 3/T-202 FOR EQUIPMENT CABINET MOUNTING DETAIL.
- 5. COORDINATE FINAL LOCATION OF RACK MOUNTED EQUIPMENT WITH OWNER PRIOR TO INSTALLATION.
- 6. DATA OUTLETS, PAGING, AND VIDEO SURVEILLANCE TO BE PLACED ON SEPARATE PATCH PANELS. CONTRACTOR TO VERIFY QUANTITY.

#### KEY NOTES: #

1. TWO PA-AMP-1 MOUNTED IN EACH RACK UNIT.

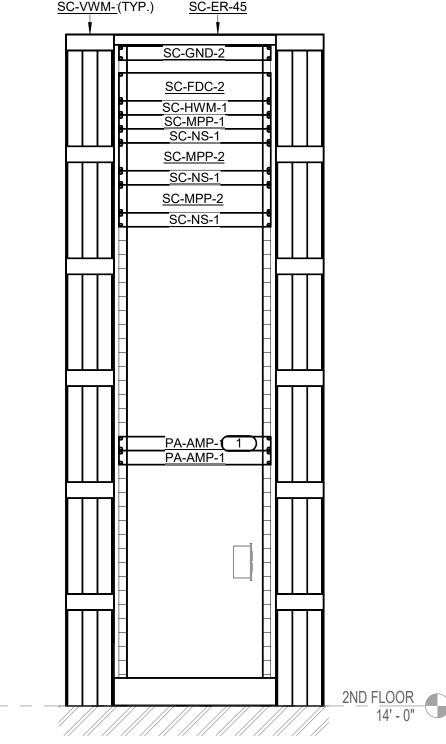


# **AA - TR-2 - RACK ELEVATION**

#### **GENERAL NOTES:**

- REFER TO 3/T-400 FOR TR-2 EQUIPMENT PLAN.
- 2. REFER TO 4/T-400 FOR TR-2 PATHWAY PLAN.
- 3. LOCATED ON SECOND FLOOR IN BUILDING AA ADMINISTRATION BUILDING. REFER TO TA-102 FOR OVERALL FLOOR PLAN.
- 4. REFER TO 2/T-202 FOR EQUIPMENT RACK MOUNTING DETAIL.
- 5. COORDINATE FINAL LOCATION OF RACK MOUNTED EQUIPMENT WI OWNER PRIOR TO INSTALLATION.
- 6. DATA OUTLETS, PAGING, AND VIDEO SURVEILLANCE TO BE PLACED ON SEPARATE PATCH PANELS. CONTRACTOR TO VERIFY QUANTITY

#### KEY NOTES: #

1. TWO PA-AMP-1 MOUNTED IN EACH RACK UNIT.

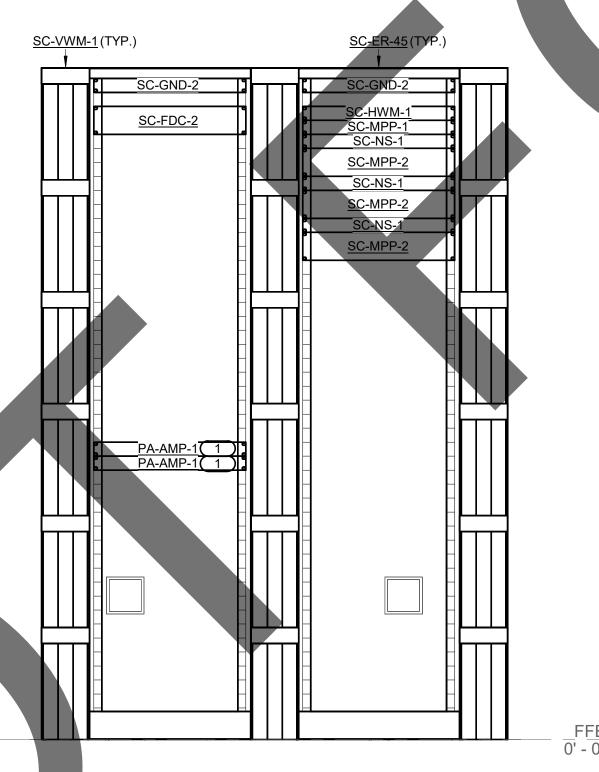


# AI - TR-5 - RACK ELEVATION

#### **GENERAL NOTES:**

- REFER TO 3/T-401 FOR TR-5 EQUIPMENT PLAN.
- . REFER TO 4/T-401 FOR TR-5 PATHWAY PLAN. . LOCATED IN BUILDING AI - SUPPORT BUILDING. REFER TO TI-101 FOR OVERALL FLOOR PLAN.
- . REFER TO 2/T-202 FOR EQUIPMENT RACK MOUNTING DETAIL. 5. COORDINATE FINAL LOCATION OF RACK MOUNTED EQUIPMENT WITH
- OWNER PRIOR TO INSTALLATION. 6. DATA OUTLETS, PAGING, AND VIDEO SURVEILLANCE TO BE PLACED ON SEPARATE PATCH PANELS. CONTRACTOR TO VERIFY QUANTITY.

#### KEY NOTES: #

1. TWO PA-AMP-1 MOUNTED IN EACH RACK UNIT.

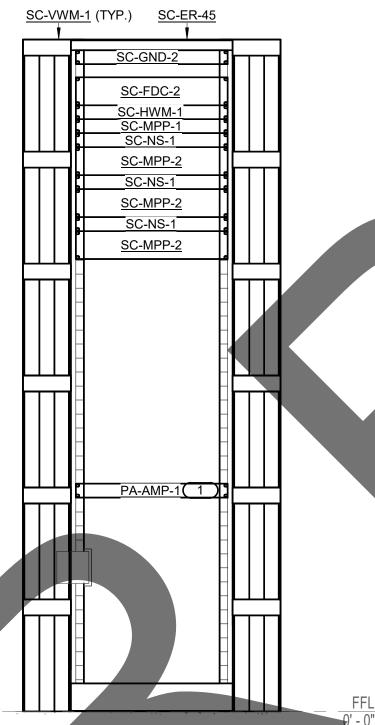


# **AC - TR-3 - RACK ELEVATION**

- EFER TO 5/T-400 FOR TR-3 EQUIPMENT PLAN. EFER TO 6/T-400 FOR TR-3 PATHWAY PLAN. 3. LOCATED IN BUILDING AC - MEDICAL DOG BUILDING. REFER TO
- TBC-101 FOR OVERALL FLOOR PLAN. REFER TO 2/T-202 FOR EQUIPMENT RACK MOUNTING DETAIL.
- COORDINATE FINAL LOCATION OF RACK MOUNTED EQUIPMENT WITH OWNER PRIOR TO INSTALLATION.


  DATA OUTLETS, PAGING, AND VIDEO SURVEILLANCE TO BE PLACED ON SEPARATE PATCH PANELS. CONTRACTOR TO VERIFY QUANTITY.
- EY NOTES: #


TWO PA-AMP-1 MOUNTED IN EACH RACK UNIT.

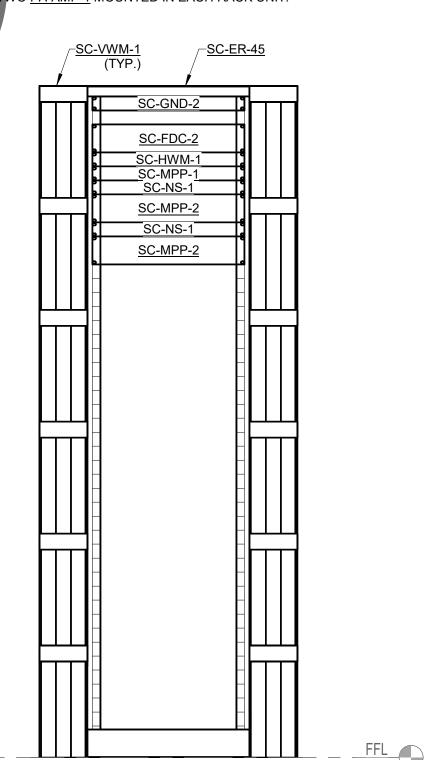

# **AE - TR-6 - RACK ELEVATION GENERAL NOTES:**

- 1. TYPICAL OF BUILDINGS AE (TR-6), AF (TR-7), AG (TR-8), AH (TR-9) AND AH.1 (TR-10).
- 2. REFER TO 5/T-401 FOR TR-6 EQUIPMENT PLAN. 8. REFER TO 6/T-401 FOR TR-6 PATHWAY PLAN.
- 4. LOCATED IN BUILDING AE ADOPTION DOG BUILDING. REFER TO
- TE-101 FOR OVERALL FLOOR PLAN.
- 5. REFER TO 2/T-202 FOR EQUIPMENT RACK MOUNTING DETAIL. 6. COORDINATE FINAL LOCATION OF RACK MOUNTED EQUIPMENT WITH
- OWNER PRIOR TO INSTALLATION. 7. DATA OUTLETS, PAGING, AND VIDEO SURVEILLANCE TO BE PLACED ON SEPARATE PATCH PANELS. CONTRACTOR TO VERIFY QUANTITY.

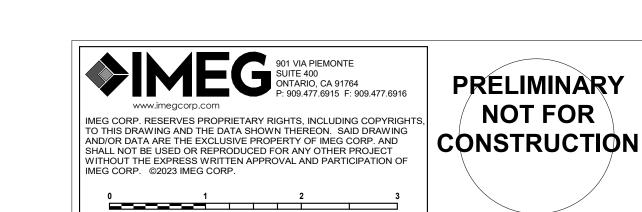


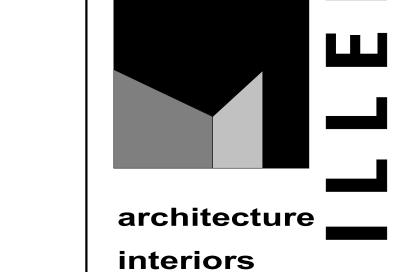

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1177 Idaho Street, Suite 200 Redlands, CA 92374 Phone: 909-335-7400 Fax: 909-335-7299 info@miller-aip.com



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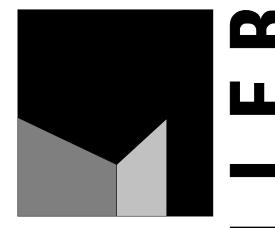
T-203

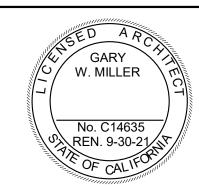Sheet Of **AK - TR-12 - RACK ELEVATION** 

**GENERAL NOTES:** 

- 1. TYPICAL OF BUILDINGS AJ (TR-11) AND AK (TR-12).
- REFER TO 1/T-402 FOR TR-12 EQUIPMENT PLAN.
   REFER TO 2/T-402 FOR TR-12 PATHWAY PLAN.
   LOCATED IN BUILDING AK DOG BUILDING. REFER TO TK-101 FOR
- OVERALL FLOOR PLAN.
- REFER TO 2/T-202 FOR EQUIPMENT RACK MOUNTING DETAIL.
   COORDINATE FINAL LOCATION OF RACK MOUNTED EQUIPMENT WITH
- OWNER PRIOR TO INSTALLATION.

  7. DATA OUTLETS, PAGING, AND VIDEO SURVEILLANCE TO BE PLACED ON SEPARATE PATCH PANELS. CONTRACTOR TO VERIFY QUANTITY.



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T-204 Of Sheet

TELECOM BONDING BACKBONE SHALL BE PROVIDED PER BONDING CONDUCTOR SIZING SCHEDULE.

PAINT-PIERCING WASHERS TO PROVIDE PROPER ELECTRICAL BOND AT ALL CONNECTIONS.

6. REFER TO 2/T-300 FOR TYPICAL TELECOM ROOM BONDING FLOW DIAGRAM.

**TECHNOLOGY BONDING RISER DIAGRAM (ADMIN BLDG)** 

CLARIFICATION OF CONNECTION LOCATIONS AND CONDUCTOR TYPE. ALL CONNECTIONS AND SYSTEM DEVICES SHOWN ARE TYPICAL AND

GREEN COLOR). REFER TO BONDING CONDUCTOR SIZING SCHEDULE FOR SIZING CRITERIA FOR CONDUCTORS. REFER TO SPECIFICATIONS

3. ALL CONDUCTORS IN THE TECHNOLOGY BONDING SYSTEM SHALL BE [PLENUM RATED] COPPER (GREEN OR MARKED WITH A DISTINCTIVE

IRREVERSIBLE COMPRESSION CONNECTORS. SOLDER IS NOT AN ACCEPTABLE MEANS OF CONNECTION. SHEET METAL SCREWS SHALL NOT BE USED TO CONNECT COMMUNICATIONS BONDING CONDUCTORS TO EQUIPMENT. WHERE NECESSARY, REMOVE PAINT AND/OR USE

5. SC-GND-1 IS THE PRIMARY BONDING BUSBAR (PBB) WHICH CONNECTS TO THE (TBC) AND CONNECTS ALL SECONDARY BONDING BUSBAR

NOT REPRESENTATIVE OF ACTUAL PROJECT QUANTITIES. REFER TO FLOOR PLANS AND ENLARGED FLOOR PLANS FOR ACTUAL QUANTITIES AND LOCATIONS OF DEVICES AND MORE SPECIFIC ROUTING INFORMATION. REFER TO SPECIFICATIONS FOR ADDITIONAL REQUIREMENTS.

1. THIS RISER IS DIAGRAMMATIC AND MAY NOT SHOW ACTUAL ROUTING OR QUANTITIES OF MATERIALS. THIS RISER IS SHOWN FOR

4. ALL BONDING CONDUCTORS AND BONDING JUMPERS SHALL BE CONNECTED BY COMPRESSION LUGS, EXOTHERMIC WELDING, OR

1. TELECOMMUNICATIONS BONDING CONDUCTOR (TBC). TBC SHALL BE THE SAME SIZE AS THE TBB OR LARGER. REFER TO BONDING

BONDING CONDUCTOR SIZING SCHEDULE		
CONDUCTOR LENGTH IN FEET	MINIMUM ACCEPTABLE SIZE - AWG	
LESS THAN 13'	6	
14' - 20'	4	
21' - 26'	3	
27' - 33'	2	
34' - 41'	1	
42' - 52'	1/0	
53' - 66'	2/0	
67' - 84'	3/0	
85' 105'	4/0	
106' - 125'	250 kcmil	
126' - 150'	300 kcmil	
151' - 175'	350 kcmil	
176' - 250'	500 kcmil	
251' - 300'	600 kcmil	
GREATER THAN 301'	750 kcmil	

# TYPICAL TELECOM ROOM BONDING FLOW DIAGRAM

ELECTRICAL PANEL SERVING ROOM

SC-GND-1

BUILDING STEEL

TELECOMMUNICATIONS ROOM MC-1, TR-#, (TYP.) 1

TELECOMMUNICATIONS -

**BONDING JUMPER (TBJ)** 

TELECOMMUNICATI

BONDING JUMPER

PRIMARY/SECONDARY

3 2

4 ~

**BONDING BUSBAR** 

(PBB/SBB)

- 1. THIS FLOW DIAGRAM IS DIAGRAMMATIC AND MAY NOT SHOW ACTUAL ROUTING OR QUANTITIES OF MATERIALS. THIS FLOW DIAGRAM IS SHOWN FOR CLARIFICATION OF CONNECTIONS AND CONDUCTOR TYPE. ALL CONNECTIONS AND SYSTEM DEVICES SHOWN ARE TYPICAL AND NOT REPRESENTATIVE OF ACTUAL PROJECT QUANTITIES. REFER TO FLOOR PLANS AND ENLARGED FLOOR PLANS FOR ACTUAL QUANTITIES AND LOCATIONS OF DEVICES AND SPECIFIC ROUTING INFORMATION. REFER TO SPECIFICATIONS FOR ADDITIONAL REQUIREMENTS.
- 2. ALL CONDUCTORS IN THE TECHNOLOGY BONDING SYSTEM SHALL BE [PLENUM RATED] COPPER (GREEN OR MARKED WITH A DISTINCTIVE GREEN COLOR).
  REFER TO BONDING CONDUCTOR SIZING SCHEDULE FOR SIZING CRITERIA FOR CONDUCTORS. REFER TO SPECIFICATIONS FOR ADDITIONAL REQUIREMENTS.
- 3. ALL BONDING CONDUCTORS AND BONDING JUMPERS SHALL BE CONNECTED BY COMPRESSION LUGS, EXOTHERMIC WELDING, OR IRREVERSIBLE COMPRESSION CONNECTORS. SOLDER IS NOT AN ACCEPTABLE MEANS OF CONNECTION. SHEET METAL SCREWS SHALL NOT BE USED TO CONNECT
- COMMUNICATIONS BONDING CONDUCTORS TO EQUIPMENT. WHERE NECESSARY, REMOVE PAINT AND/OR USE PAINT-PIERCING WASHERS TO PROVIDE PROPER ELECTRICAL BOND AT ALL CONNECTIONS.

#### KEYNOTES: (#)

- REFER TO TELECOM ROOM REFERENCES SCHEDULE FOR TELECOMMUNICATIONS ROOM NUMBER AND LOCATION INFORMATION.
- TELECOMMUNICATIONS BONDING BACKBONE (TBB). REFER TO TELECOMMUNICATIONS BONDING RISER DIAGRAM.
   TELECOMMUNICATIONS BONDING CONDUCTOR (TBC), TO ELECTRICAL ENTRANCE INTERSYSTEM BONDING TERMINATION. REFER TO TELECOMMUNICATIONS
- BONDING RISER DIAGRAM FOR CONTINUATION AND ADDITIONAL INFORMATION AND REQUIREMENTS.

- 2. INCLUDES HORIZONTAL AND VERTICAL CONDUIT SLEEVES FOR TECHNOLOGY CABLING.
- 5. REFER TO THE ELECTRICAL DRAWINGS FOR LOCATION. 6. PROVIDE SC-GND-2 RACK MOUNT TELECOMMUNICATIONS BONDING BUSBAR AT EACH EQUIPMENT RACK AND CABINET.


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CONDUCTOR SIZING SCHEDULE FOR SIZING REQUIRÉMENTS.

**ELECTRICAL GROUNDING** 

KEYNOTES: #

FOR ADDITIONAL REQUIREMENTS.

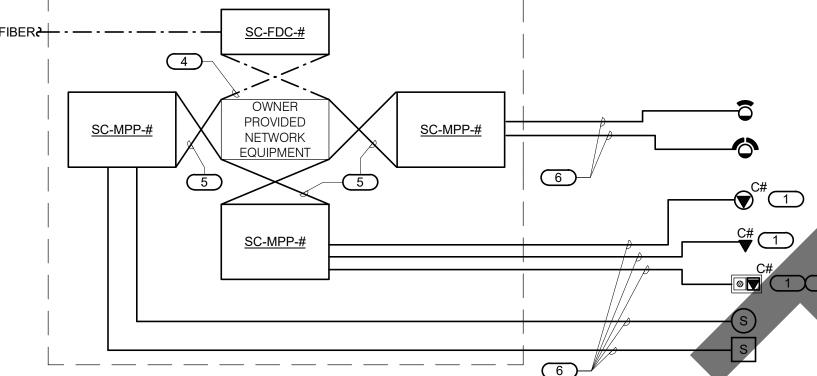


# TYPICAL TELECOM ROOM CONNECTIVITY DIAGRAM

- 1. THIS RISER IS DIAGRAMMATIC AND MAY NOT SHOW ACTUAL ROUTING OR QUANTITIES OF MATERIALS SHOWN. T SHOWN FOR CLARIFICATION OF CONNECTION(S), LOCATIONS AND CABLE TYPE. ALL INFORMATION OUTLETS ARE TYPICAL O THE OUTLETS IN THE AREA SHOWN. REFER TO FLOOR PLANS FOR MORE SPECIFIC ROUTING INFORMATION. REFER SPECIFICATIONS FOR ADDITIONAL REQUIREMENTS.
- 2. REFER TO FLOOR PLANS FOR QUANTITY OF CABLES AND JACKS TO BE INSTALLED AT EACH INFORMATION OUTLET

#### KEYNOTES: #

- 1. C# INDICATES VOICE/DATA FACEPLATE CONFIGURATION. REFER TO THE INFORMATION OUTLET SCHEDULE AND SPECIFICATION SECTION 27 15 00 FOR ADDITIONAL INFORMATION.
- INFORMATION OUTLET INSTALLED IN E.C. PROVIDED AND INSTALLED FLOOR BOX. 3. RACK(S) OR CABINET(S) AS DEFINED ON THE TELECOM ROOM LAYOUT. REFER TO THE TELECOM ROOM REFERENCES MATRIX
- ON THE COVERPAGE FOR LOCATION. REFER TO SPECIFICATIONS FOR FIBER PATCH CORD REQUIREM
- 5. RJ-45 TO RJ-45 CATEGORY 6 UTP PATCH CORDS, REFER TO SPECIFIATIONS. 4-PAIR, CATEGORY 6, UNSHIELDED TWISTED PAIR CABLE, REFER TO SPECIFICATIONS
- REFER TO 1/T-301 FIBER AND COPPER RISER DIAGRAM FOR INCOMING FIBER.

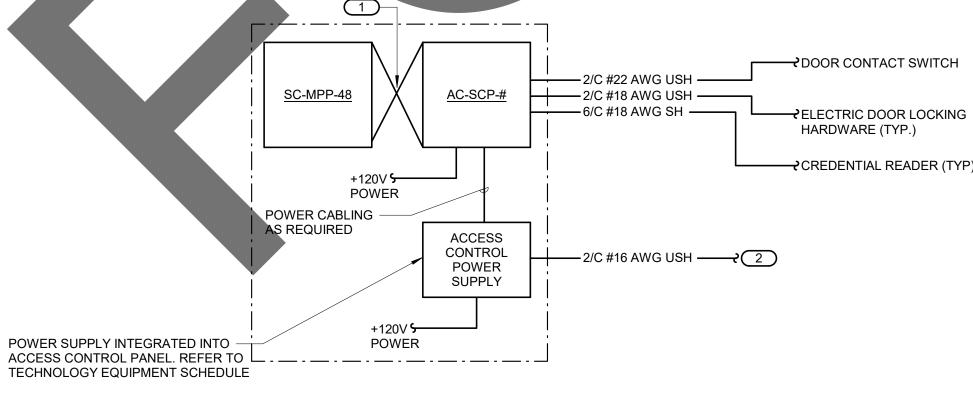


# **ACCESS CONTROL RISER DIAGRAM**

- THIS DIAGRAM IS DIAGRAMMATIC AND MAY NOT SHOW ACTUAL DEVICE QUANTITIES OR LOCATIONS. ALL DEVICES SHOWN ARE TYPICAL AND MAY NOT REFLECT EVERY WIRE OR CONNECTION THAT MUST BE MADE. WIRING SHOWN ON THIS DIAGRAM REFLECTS THE REQUIREMENTS FOR THE BASIS OF DESIGN MANUFACTURER. ANY CHANGES
- REQUIRED DUE TO THE T.C.'S SELECTION OF AN ALTERNATE MANUFACTURER, INCLUDING ANY POWER REQUIRED FOR FIELD LOCATED SECURITY CONTROLLERS,
- SHALL BE INCLUDED IN THE T.C.'S BID.
- 2. ALL CONDUCTOR SIZES ARE LISTED A MINIMUM SIZES.
- 3. ALL WORKSTATIONS AND SERVERS REQUIRE A KEYBOARD AND MOUSE. 4. MULTICONDUCTOR COMPOSITE CABLES ARE ACCEPTABLE.

#### KEYNOTES: #

- 1. CATEGORY 6 RJ-45 TO RJ-45 PATCH CABLE.
- 2. CONNECT TO FIRE ALARM PANEL, REFER TO ELECTRICAL DRAWINGS FOR PANEL LOCATION.

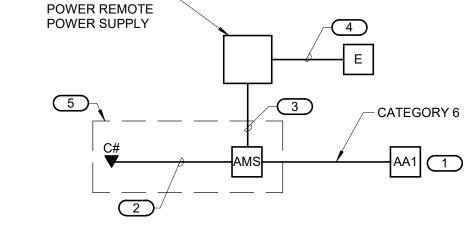

**ECOMMUNICATIONS** 

BONDING JUMPER (1

**EQUIPMEN** 

RACK(S)

EQUIPMENT CABINET(S)

BOND)

RACK BONDING

BUSBAR (RBB


# AREA OF REFUGE RISER DIAGRAM

1. THIS RISER IS DIAGRAMMATIC AND NOT INTENDED TO SHOW ACTUAL ROUTING OR QUANTITIES OF MATERIALS SHOWN. THIS RISER IS SHOWN FOR CLARIFICATION OF CONNECTION LOCATIONS AND CABLE TYPE. ALL INFORMATION OUTLETS ARE TYPICAL OF THE OUTLETS IN THE AREA SHOWN. REFER TO PLANS FOR MORE SPECIFIC ROUTING INFORMATION. REFER TO SPECIFICATIONS FOR ADDITIONAL REQUIREMENTS.

#### KEYNOTES: #

AREA OF RESCUE

- 1. REFER TO FLOOR PLANS FOR QUANTITIES AND LOCATIONS.
- 2. CATEGORY 6 DATA PATCH CORD.
- 3. ONE (1) 2/16 AWG FOR REMOTE MONITORING OF THE AREA OF REFUGE MASTER
- STATION. 4. 110V POWER CONNECTION. COORDINATE LOCATION WITH E.C. PRIOR TO
- INSTALLATION. 5. FINAL LOCATION TO BE DETERMINED BY AHJ. COORDINATE PRIOR TO INSTALLATION.

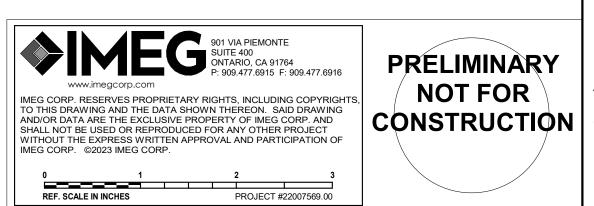






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initials	date	phase

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project information

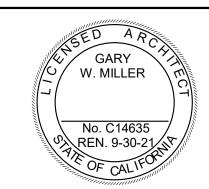Project Number: Drawn By: Author PS Checked By Issue Date: 05/17/24


sheet name

DIAGRAMS

sheet number

T-300

Sheet Of

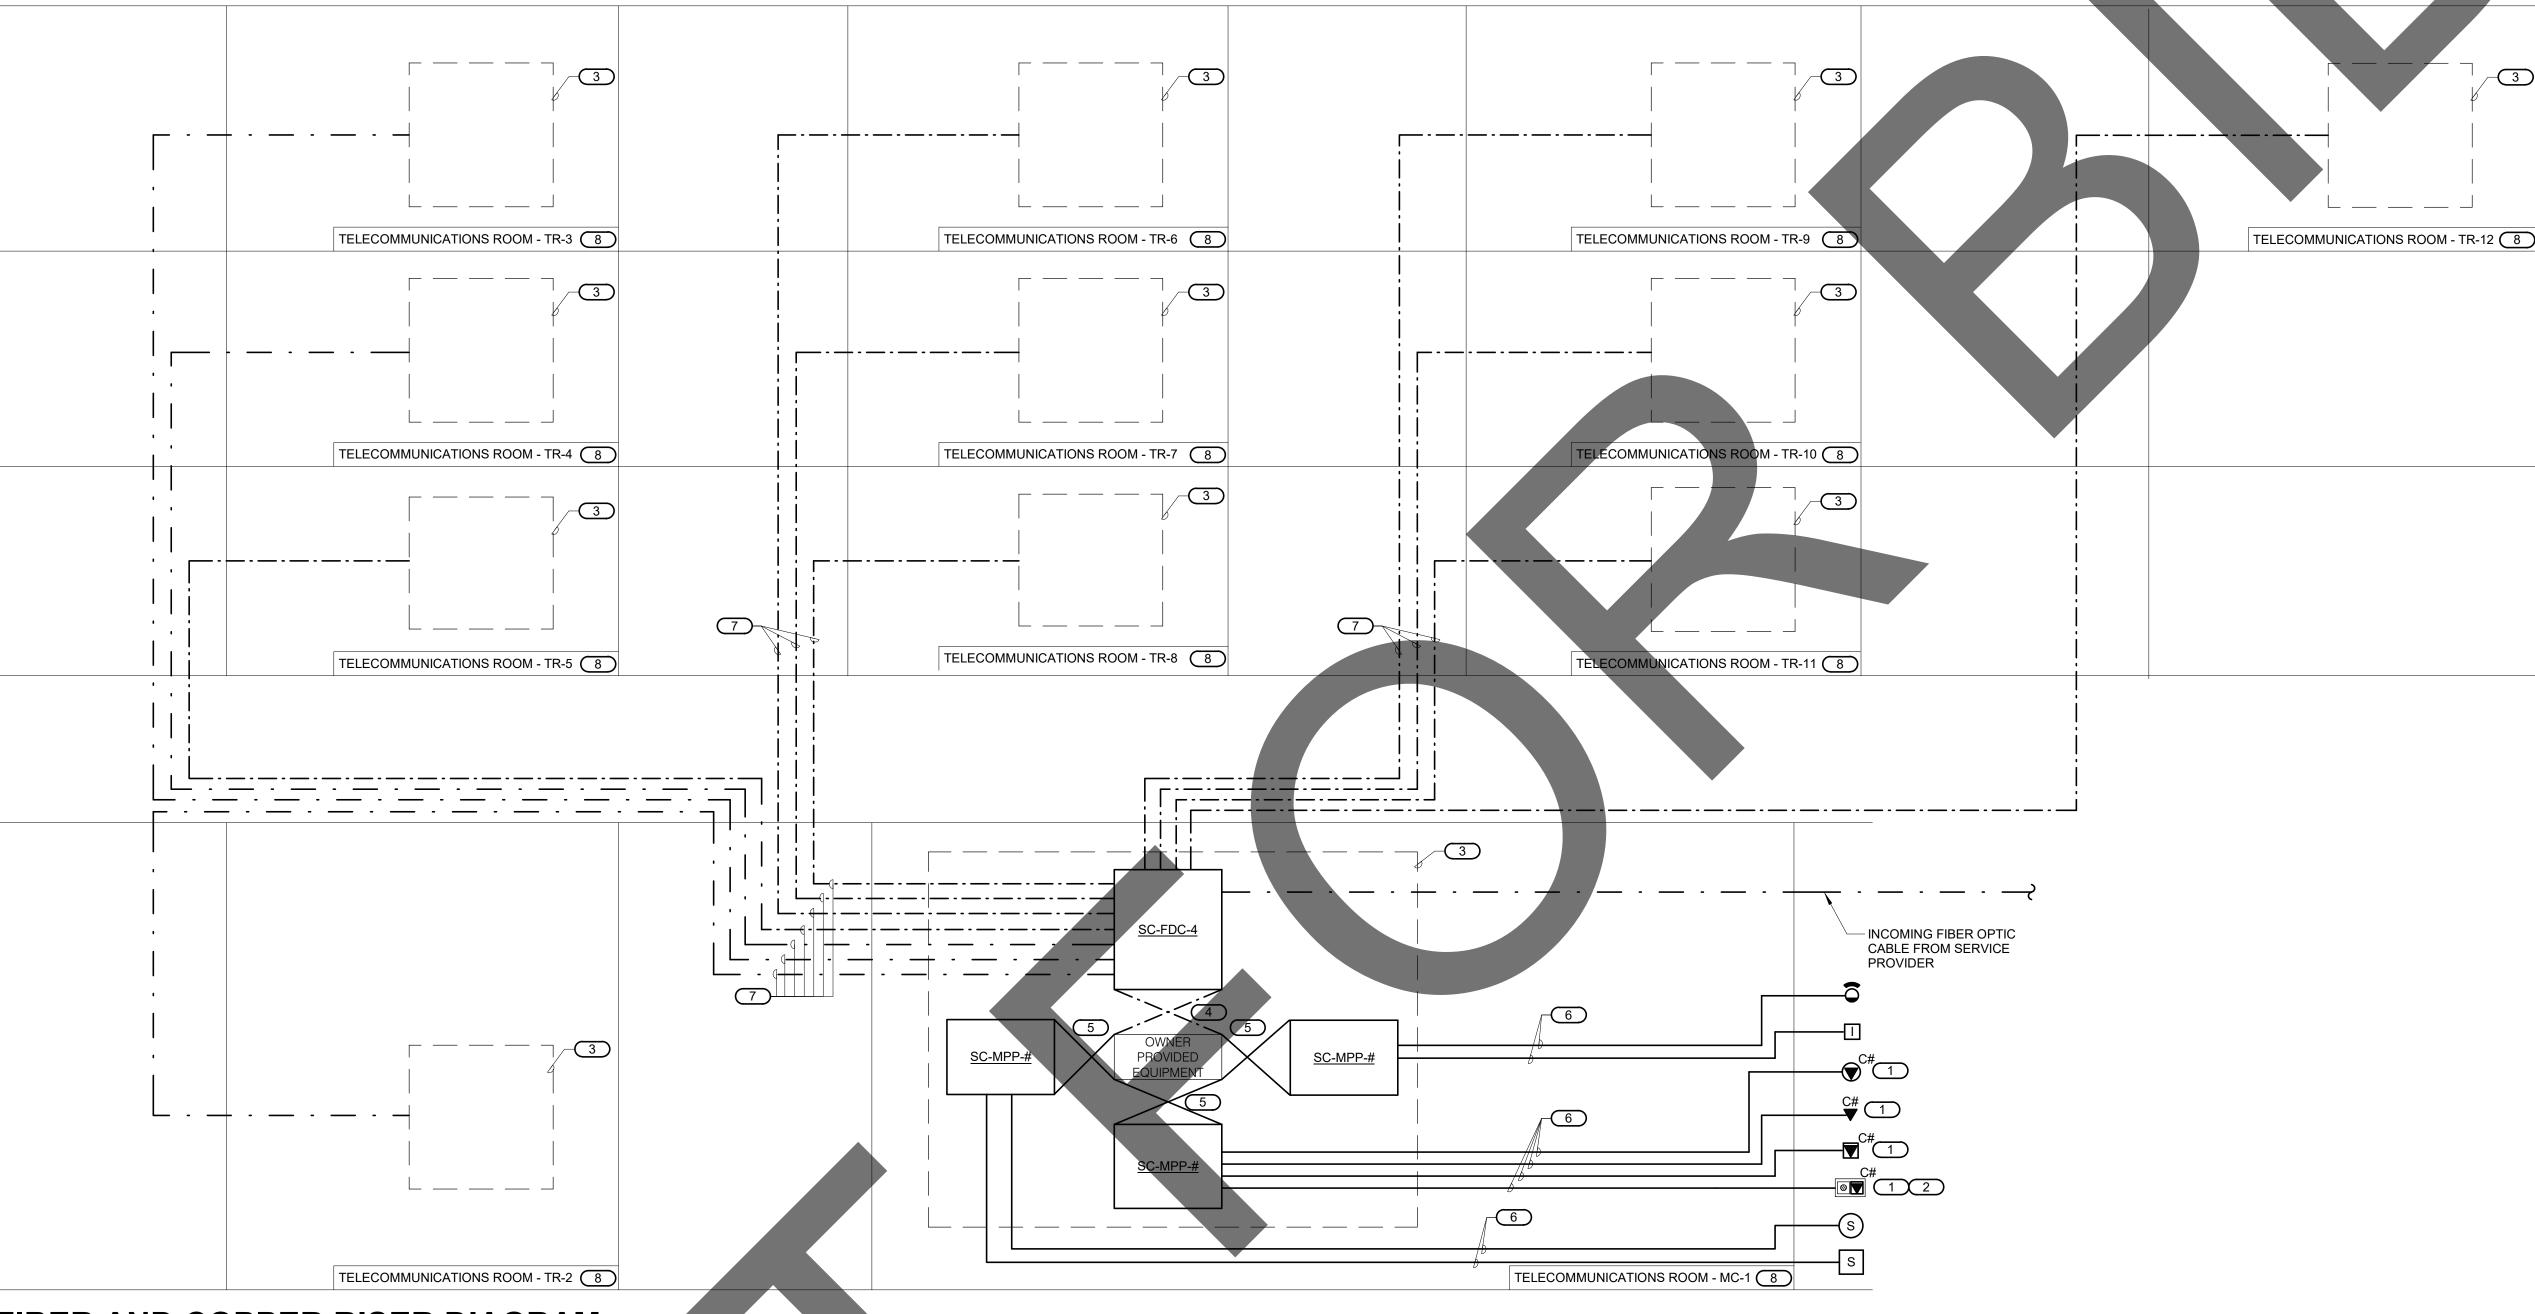

# FIBER AND COPPER RISER DIAGRAM NO SCALE

1. THIS RISER IS DIAGRAMMATIC AND MAY NOT SHOW ACTUAL ROUTING OR QUANTITIES OF MATERIALS SHOWN. THIS RISER IS SHOWN FOR CLARIFICATION OF CONNECTION(S), LOCATIONS AND CABLE TYPE. ALL INFORMATION OUTLETS ARE TYPICAL OF THE OUTLETS IN THE AREA SHOWN. REFER TO FLOOR PLANS FOR MORE SPECIFIC ROUTING INFORMATION. REFER TO SPECIFICATIONS FOR ADDITIONAL REQUIREMENTS.


#### **KEYNOTES**:

- 1. C# INDICATES VOICE/DATA FACEPLATE CONFIGURATION. REFER TO THE INFORMATION OUTLET SCHEDULE ON T-102 FOR ADDITIONAL INFORMATION. REFER TO SPECIFICATIONS SECTION 27 15 00 FOR ADDITIONAL INFORMATION.
- INFORMATION OUTLET INSTALLED IN E.C. PROVIDED AND INSTALLED FLOOR BOX.
   REFER TO 3/T-300 TYPICAL TELECOM ROOM CONNECTIVITY DIAGRAM FOR PATCHING, CROSS-CONNECTS, AND HORIZONTAL CABLING REQUIREMENTS.
   OPTICAL FIBER PATCH CABLES. REFER TO SPECIFICATIONS FOR REQUIREMENTS.
- 5. RJ-45 TO RJ-45 CATEGORY 6 UTP PATCH CORDS, REFER TO SPECIFICATION
- 6. 4-PAIR, CATEGORY 6, UNSHIELDED TWISTED PAIR CABLE, REFER TO SPECIFICATIONS.
- 24-STRAND MM FIBER OPTIC CABLE. REFER TO SPECIFICATIONS FOR ADDITIONAL INFORMATION.
   REFER TO COVERPAGE AND FLOOR PLANS FOR TELECOMMUNICATIONS ROOM LOCATIONS.

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project information

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sheet name


DIAGRAMS

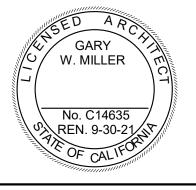PS

sheet number

T-301 Of Sheet

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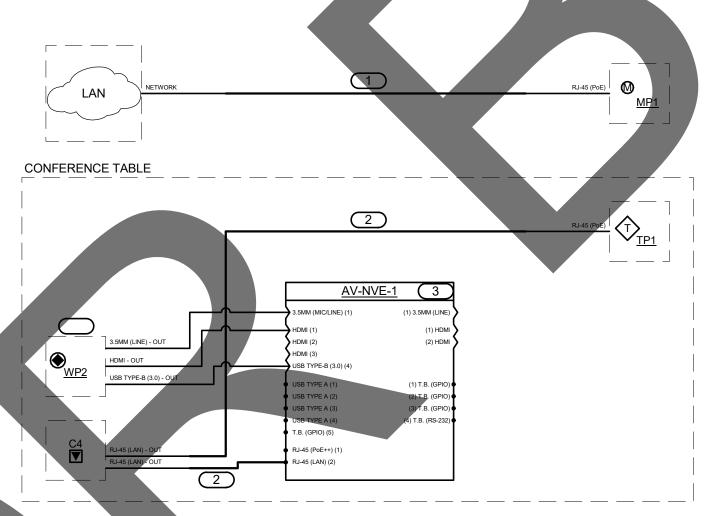


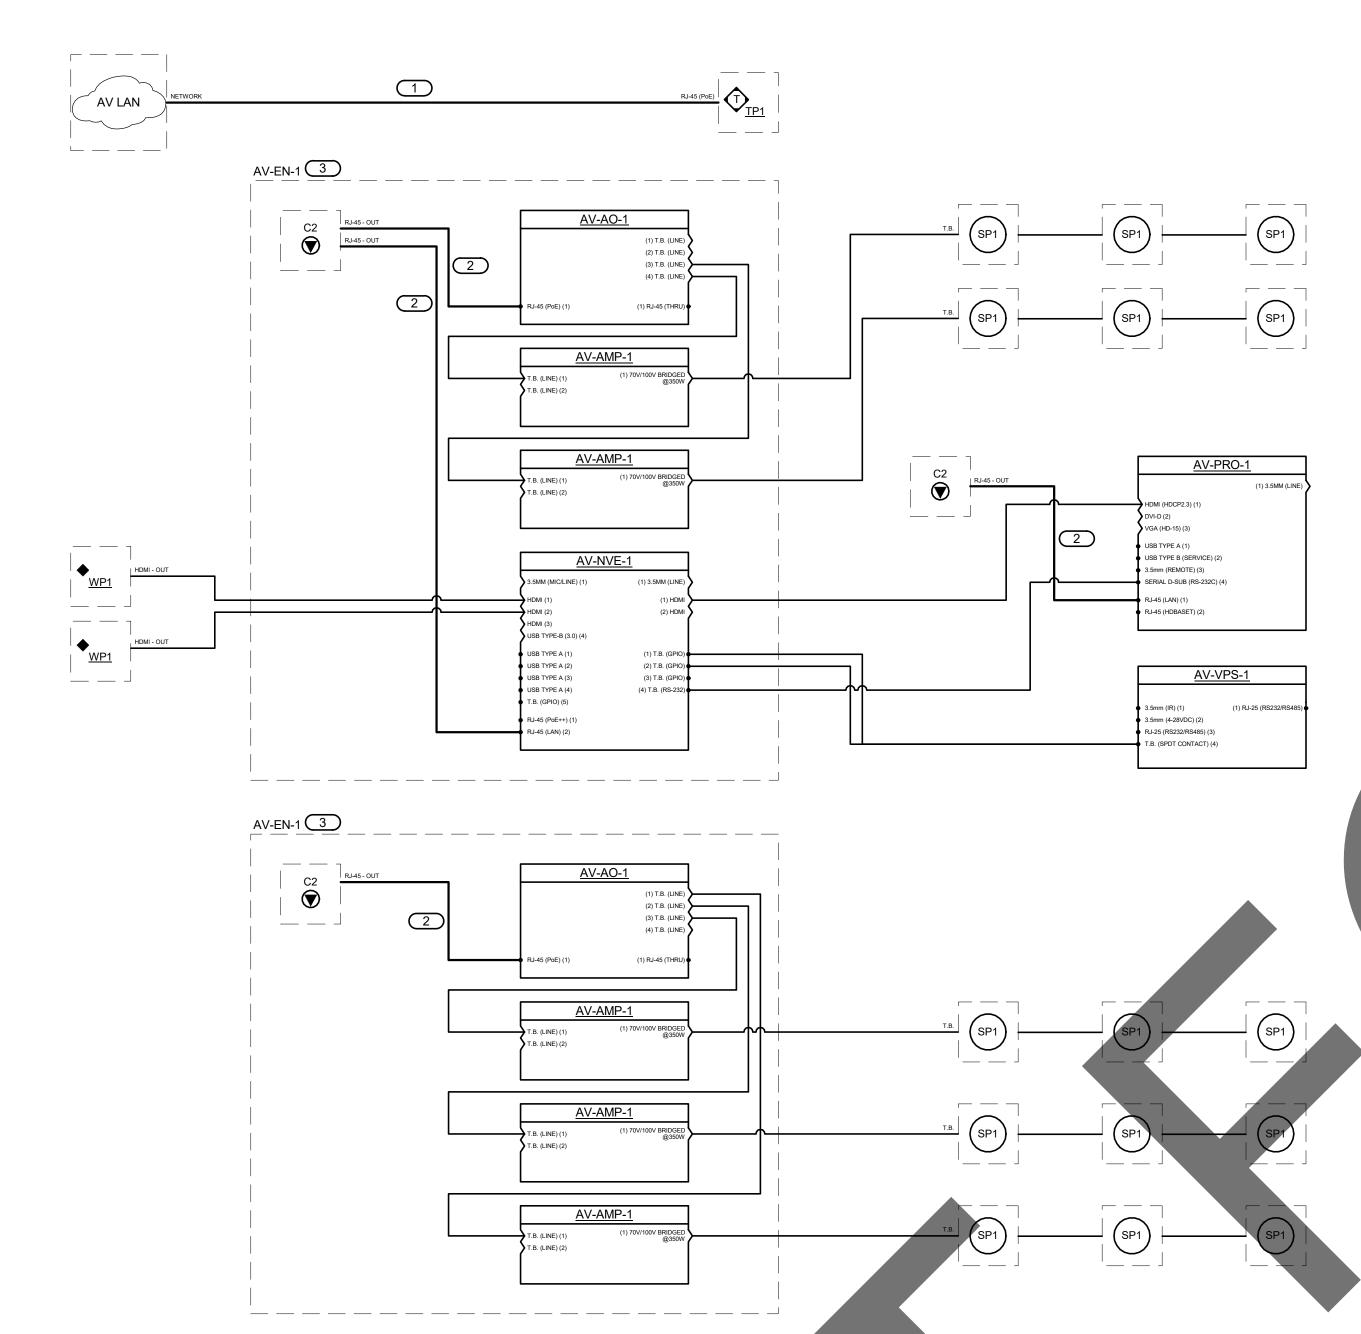
# MULTI PURPOSE ROOM FUNCTIONAL DIAGRAM

- 1. REFER TO THE ROOM DESCRIPTION AND FUNCTIONALITY IN SPECIFICATION SECTION 27 41 00 FOR COMPLETE
- 2. THIS RISER IS DIAGRAMMATIC AND MAY NOT SHOW ACTUAL ROUTING, QUANTITIES, OR ALL CABLING REQUIRED FOR A COMPLETE INSTALLATION. THE RISER IS SHOWN FOR CLARIFICATION OF CONNECTIONS, LOCATIONS AND CABLING TYPE. REFER TO THE SPECIFICATION SECTION 27 41 00 FOR ADDITIONAL INFORMATION AND COMPLE REQUIREMENTS.
- 3. AV CONTRACTOR TO VERIFY POWER REQUIREMENTS, CONNECTIONS, AND LOCATIONS FOR AV DEVICES WITH ELECTRICAL CONTRACTOR.
- 4. THE CONTRACTOR SHALL PROVIDE PROFESSIONAL LEVEL CALIBRATION TO THIS DISPLAY. REFER TO SPECIFICATIO SECTION 27 41 00 FOR DISPLAY CALIBRATION REQUIREMENTS.
- 5. PROVIDE AUDIO SYSTEM TESTING AND CALIBRATION. REFER TO SPECIFICATION 27 41 00 FOR INITIAL AUDIO DS SETTINGS AND TESTING REQUIREMENTS. CALIBRATION BY EAR IS NOT ACCEPTABLE.
- 6. THIS SYSTEM IS DESIGNED TO UTILIZE Q-SYS. REFER TO SPECIFICATION FOR ADDITIONAL REQUIREMENTS.

#### KEYNOTES: #

- CONTRACTOR PROVIDED AND INSTALLED CATEGORY 6 CABLE BACK TO NEAREST TELECOM ROOM. REFER TO THE FLOOR PLANS FOR THE LOCATION OF THE NEAREST SERVING TELECOM ROOM. REFER TO SPECIFICATION SECTION 27 15 00 FOR CABLING REQUIREMENTS.
- 2. CONTRACTOR PROVIDED AND INSTALLED CATEGORY 6 PATCH CORD. REFER TO THE SPECIFICATIONS FOR PATCH
- CORD REQUIREMENTS. 3. MOUNT ALL EQUIPMENT IN THE IN-CEILING ENCLOSURE (<u>AV-EN-1</u>). PROVIDE WITH MOUNTING BRACKETS AS REQUIRED TO SECURE THE EQUIPMENT.



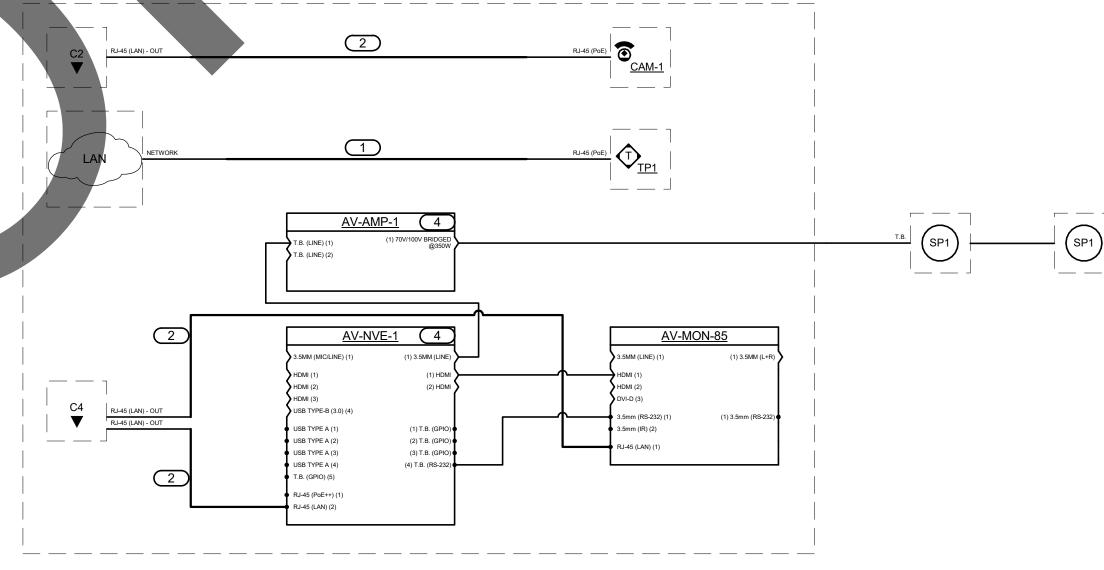



# **CONFERENCE ROOM FUNCTIONAL DIAGRAM**

- 1. REFER TO THE ROOM DESCRIPTION AND FUNCTIONALITY IN SPECIFICATION SECTION 27 41 00 FOR COMPLETE
- 2. THIS RISER IS DIAGRAMMATIC AND MAY NOT SHOW ACTUAL ROUTING, QUANTITIES, OR ALL CABLING REQUIRED FOR A COMPLETE INSTALLATION. THE RISER IS SHOWN FOR CLARIFICATION OF CONNECTIONS, LOCATIONS AND CABLING TYPE. REFER TO THE SPECIFICATION SECTION 27 41 00 FOR ADDITIONAL INFORMATION AND COMPLETE REQUIREMENTS.
- 3. AV CONTRACTOR TO VERIFY POWER REQUIREMENTS, CONNECTIONS, AND LOCATIONS FOR AV DEVICES WITH ELECTRICAL CONTRACTOR.
- 4. PROVIDE AUDIO SYSTEM TESTING AND CALIBRATION. REFER TO SPECIFICATION 27 41 00 FOR INITIAL AUDIO DSP SETTINGS AND TESTING REQUIREMENTS. CALIBRATION BY EAR IS NOT ACCEPTABLE.
- 5. THIS SYSTEM IS DESIGNED TO UTILIZE DANTE AND Q-SYS. REFER TO SPECIFICATION FOR ADDITIONAL REQUIREMENTS.

#### KEYNOTES: #

- 1. CONTRACTOR PROVIDED AND INSTALLED CATEGORY 6 CABLE BACK TO NEAREST TELECOM ROOM. REFER TO THE FLOOR PLANS FOR THE LOCATION OF THE NEAREST SERVING TELECOM ROOM. REFER TO SPECIFICATION SECTION 27 15 00 FOR CABLING REQUIREMENTS.
- 2. CONTRACTOR PROVIDED AND INSTALLED CATEGORY 6 PATCH CORD. REFER TO THE SPECIFICATIONS FOR PATCH CORD REQUIREMENTS.
- 3. MOUNT ALL EQUIPMENT IN THE UNDER TABLE. COORDINATE WITH FURNITURE CONTRACTOR FOR INSTALLATION. PROVIDE WITH MOUNTING BRACKETS AS REQUIRED TO SECURE THE EQUIPMENT.
- 4. MOUNT ALL EQUIPMENT IN THE IN-WALL DISPLAY MOUNT (AV-MNT-1). PROVIDE WITH MOUNTING BRACKETS AS REQUIRED TO SECURE THE EQUIPMENT TO THE DISPLAY MOUNT.
- 5. PLUG IN TABLE TOP BOX WHIP IN THE E.C. PROVIDED FLOOR BOX. COORDINATE CONNECTION REQUIREMENTS WITH THE E.C. PRIOR TO INSTALLATION.

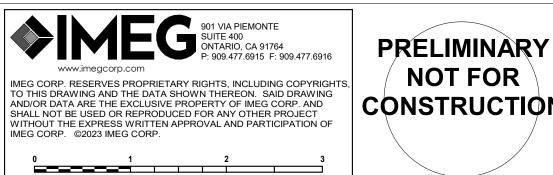

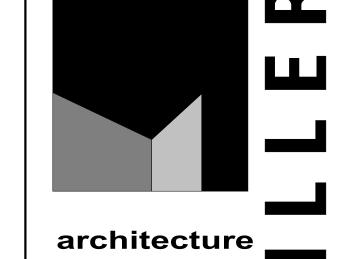


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# Date

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Project Number: Drawn By: Author Checked By: PS Issue Date: 05/17/24

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**DIAGRAMS** 

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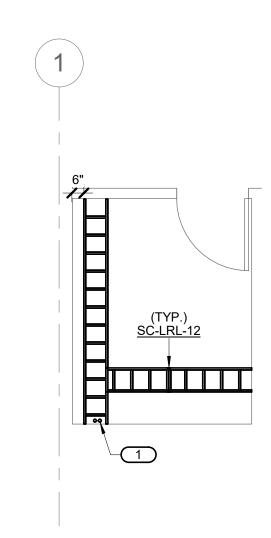
T-302 Sheet

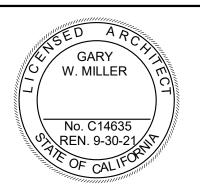Of



### AA - MC-1 - EQUIPMENT PLAN

- 1. REFER TO 2/T-400 FOR MC-1 PATHWAY PLAN. 2. REFER TO 1/T-203 FOR MC-1 RACK ELEVATION.
- 3. LOCATED ON FIRST FLOOR IN BUILDING AA ADMINISTRATION
- BUILDING. REFER TO TA-101 FOR OVERALL FLOOR PLAN. 4. COORDINATE ALL ELECTRICAL REQUIREMENTS WITH E.C. PRIOR TO




# AA - TR-2 - PATHWAY PLAN

1. REFER TO 3/T-400 FOR TR-2 EQUIPMENT PLA 2. LOCATED ON SECOND FLOOR IN BUILDING AA - ADMINISTRATION BUILDING. REFER TO TA-102 FOR OVERALL FLOOR PLAN.

#### KEYNOTES: #

1. TWO 2" CONDUITS FROM MC-1.

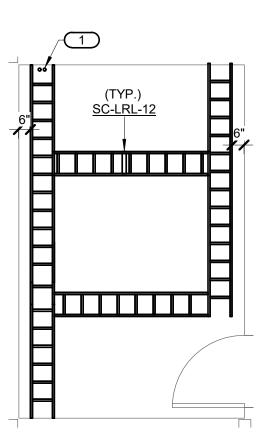




### - MC-1 - PATHWAY PLAN

- 1. REFER TO 1/T-400 FOR MC-1 EQUIPMENT PLAN.
- 2. LOCATED ON FIRST FLOOR IN BUILDING AA ADMINISTRATION BUILDING. REFER TO TA-101 FOR OVERALL FLOOR PLAN.

#### KEYNOTES: #


1. TWO 2" CONDUITS TO TR-2.

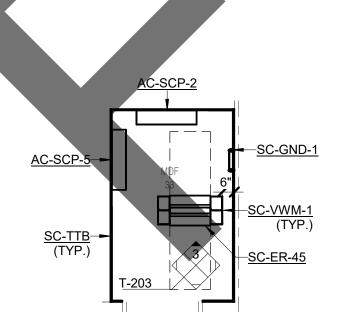



### **AC - TR-3 - EQUIPMENT PLAN**

- 1. REFER TO 6/T-400 FOR TR-3 PATHWAY PLAN.
- 2. REFER TO 3/T-203 FOR TR-3 RACK ELEVATION. 3. LOCATED IN BUILDING AC - MEDICAL DOG BUILDING. REFER TO
- TBC-101 FOR OVERALL FLOOR PLAN.
- 4. COORDINATE ALL ELECTRICAL REQUIREMENTS WITH E.C. PRIOR TO INSTALLATION.

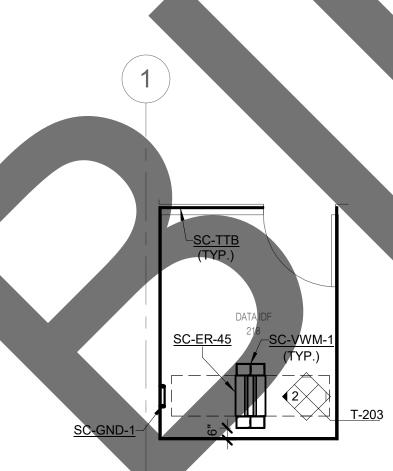




### **AA - TR-2 - EQUIPMENT PLAN**

#### **GENERAL NOTES:**

- 1. REFER TO 4/T-400 FOR TR-2 PATHWAY PLAN.
- 2. REFER TO 2/T-203 FOR TR-2 RACK ELEVATION.
- 3. LOCATED ON SECOND FLOOR IN BUILDING AA ADMINISTRATION BUILDING. REFER TO TA-102 FOR OVERALL FLOOR PLAN.
- 4. COORDINATE ALL ELECTRICAL REQUIREMENTS WITH E.C. PRIOR TO INSTALLATION.




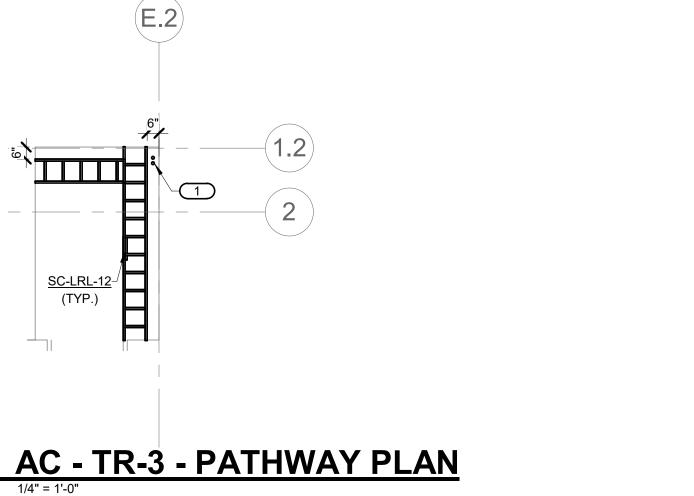

1. REFER TO 5/T-400 FOR TR-3 EQUIPMENT PLAN. 2. LOCATED IN BUILDING AC - MEDICAL DOG BUILDING. REFER TO

#### TBC-101 FOR OVERALL FLOOR PLAN. KEYNOTES: #

1. TWO 2" UNDERGROUND CONDUITS FOR CAMPUS CONNECTIVITY.

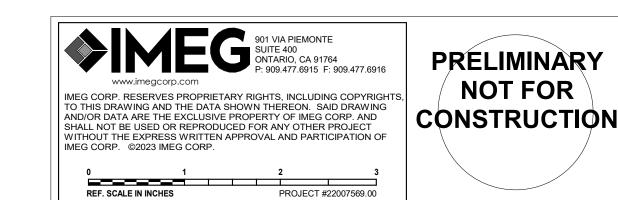

project information

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architecture

1177 Idaho Street, Suite 200 Redlands, CA 92374 Phone: 909-335-7400 Fax: 909-335-7299 info@miller-aip.com

W. MILLER

No. C14635 REN. 9-30-21

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Issue Date:


TECHNOLOGY **ENLARGED PLANS** 

PS

05/17/24

sheet number

T-400

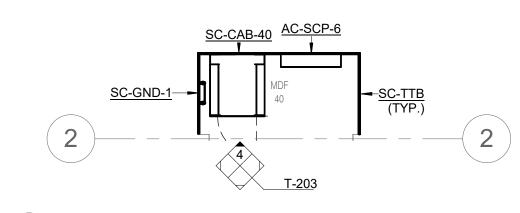

**AD - TR-4 - EQUIPMENT PLAN** 

- 1. REFER TO 2/T-401 FOR TR-4 PATHWAY PLAN.
- 2. REFER TO 4/T-203 FOR TR-4 RACK ELEVATION. 3. LOCATED IN BUILDING AD - CAT AND OTHER ANIMALS BUILDING.
- REFER TO TD-101 FOR OVERALL FLOOR PLAN. 4. COORDINATE ALL ELECTRICAL REQUIREMENTS WITH E.C. PRIOR TO INSTALLATION.

AI - TR-5 - PATHWAY PLAN

LOCATED IN BUILDING AI - SUPPORT BUILDING. REFER TO TI-101 FOR OVERALL FLOOR PLAN.

CONNECTIVITY AND TWO 1-1/2" UNDERGROUND CONDUITS FOR GATE CONNECTIVITY.


1. REFER TO 3/T-401 FOR TR-5 EQUIPMENT PLAN.

1. TWO 2" UNDERGROUND CONDUITS FOR CAMPUS

SC-LRL-12 (TYP.)

**GENERAL NOTES:** 

KEYNOTES: #

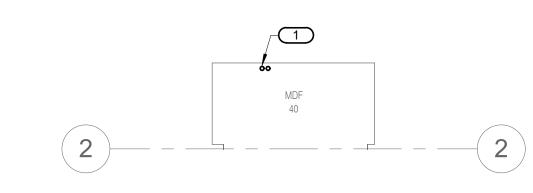




1. REFER TO 1/T-401 FOR TR-4 EQUIPMENT PLAN. 2. LOCATED IN BUILDING AD - CAT AND OTHER ANIMALS BUILDING REFER TO TD-101 FOR OVERALL FLOOR PLAN.


#### KEYNOTES: #


1. TWO 2" UNDERGROUND CONDUITS FOR CAMPUS CONNECT

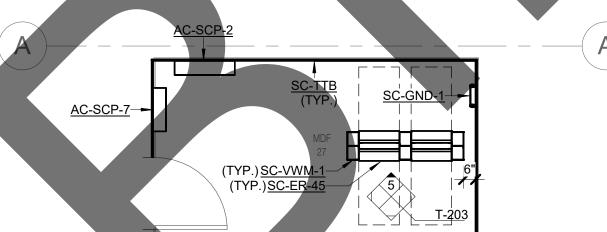



- 1. REFER TO 4/T-401 FOR TR-5 PATHWAY PLAN.
- 2. REFER TO 5/T-203 FOR TR-5 RACK ELEVATION. 3. LOCATED IN BUILDING AI - SUPPORT BUILDING. REFER TO TI-101 FOR OVERALL FLOOR PLAN.
- 4. COORDINATE ALL ELECTRICAL REQUIREMENTS WITH E.C. PRIOR TO INSTALLATION.

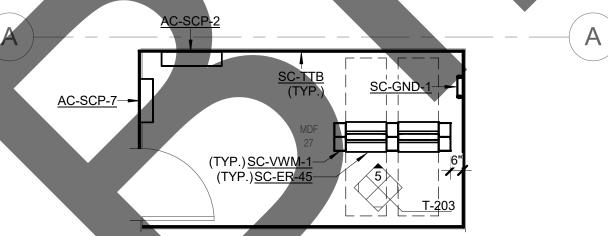

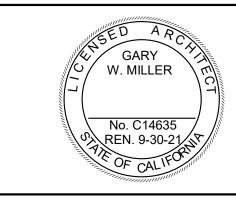

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> Fax: 909-335-7299 info@miller-aip.com

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owner approval			
initials	date	phase	

#### revisions/addenda

# Date Comment

project information

Project Number: Drawn By: Checked By: 05/17/24 Issue Date:

Author PS

sheet name

**TECHNOLOGY ENLARGED PLANS** 

sheet number

Sheet


T-401 Of

-<u>SC-VWM-1</u>

**AE - TR-6 - EQUIPMENT PLAN** 

1. TYPICAL OF BUILDINGS AE (TR-6), AF (TR-7), AG (TR-8), AH (TR-9) AND

- AH.1 (TR-10).
- 2. REFER TO 6/T-401 FOR TR-6 PATHWAY PLAN. 3. REFER TO 6/T-203 FOR TR-6 RACK ELEVATION.
- 4. LOCATED IN BUILDING AE ADOPTION DOG BUILDING. REFER TO
- TE-101 FOR OVERALL FLOOR PLAN. 5. COORDINATE ALL ELECTRICAL REQUIREMENTS WITH E.C. PRIOR TO INSTALLATION.

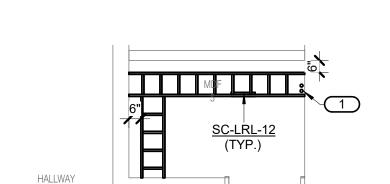

# **AE - TR-6 - PATHWAY PLAN**

- 1. TYPICAL OF BUILDINGS AE (TR-6), AF (TR-7), AG (TR-8), AH (TR-9) AND AH.1 (TR-10). 2. REFER TO 5/T-401 FOR TR-5 EQUIPMENT PLAN.
- 3. LOCATED IN BUILDING AE ADOPTION DOG BUILDING. REFER TO TE-101 FOR OVERALL FLOOR PLAN.


#### KEYNOTES: #

1. TWO 2" UNDERGROUND CONDUITS.

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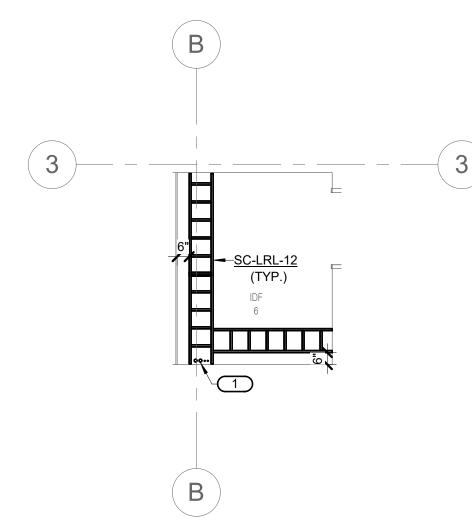




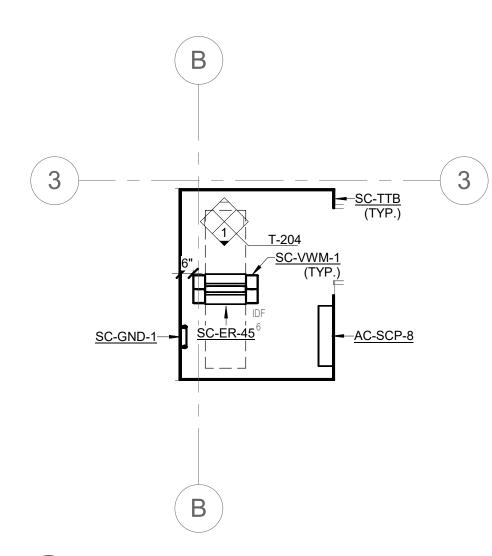

### AK - TR-12 - EQUIPMENT PLAN

- TYPICAL OF BUILDINGS AJ (TR-11) AND AK (TR-12).
   REFER TO 2/T-402 FOR TR-12 PATHWAY PLAN.
- REFER TO 1/T-204 FOR TR-12 RACK ELEVATION.
   LOCATED IN BUILDING AK DOG BUILDING. REFER TO TK-101 FOR
- OVERALL FLOOR PLAN. COORDINATE ALL ELECTRICAL REQUIREMENTS WITH E.C. PRIOR TO INSTALLATION.



# AK - TR-12 - PATHWAY PLAN

- TYPICAL OF BUILDINGS AJ (TR-11) AND AK (TR-12).
   REFER TO 1/T-402 FOR TR-12 EQUIPMENT PLAN.
   LOCATED IN BUILDING AK DOG BUILDING. REFER TO TK-101 FOR OVERALL FLOOR PLAN.

#### KEYNOTES: #


TWO 2" UNDERGROUND CONDUITS FOR CAMPUS CONNECTIVITY AND TWO 1-1/2" UNDERGROUND CONDUITS FOR GATE CONNECTIVITY.



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project information

Author


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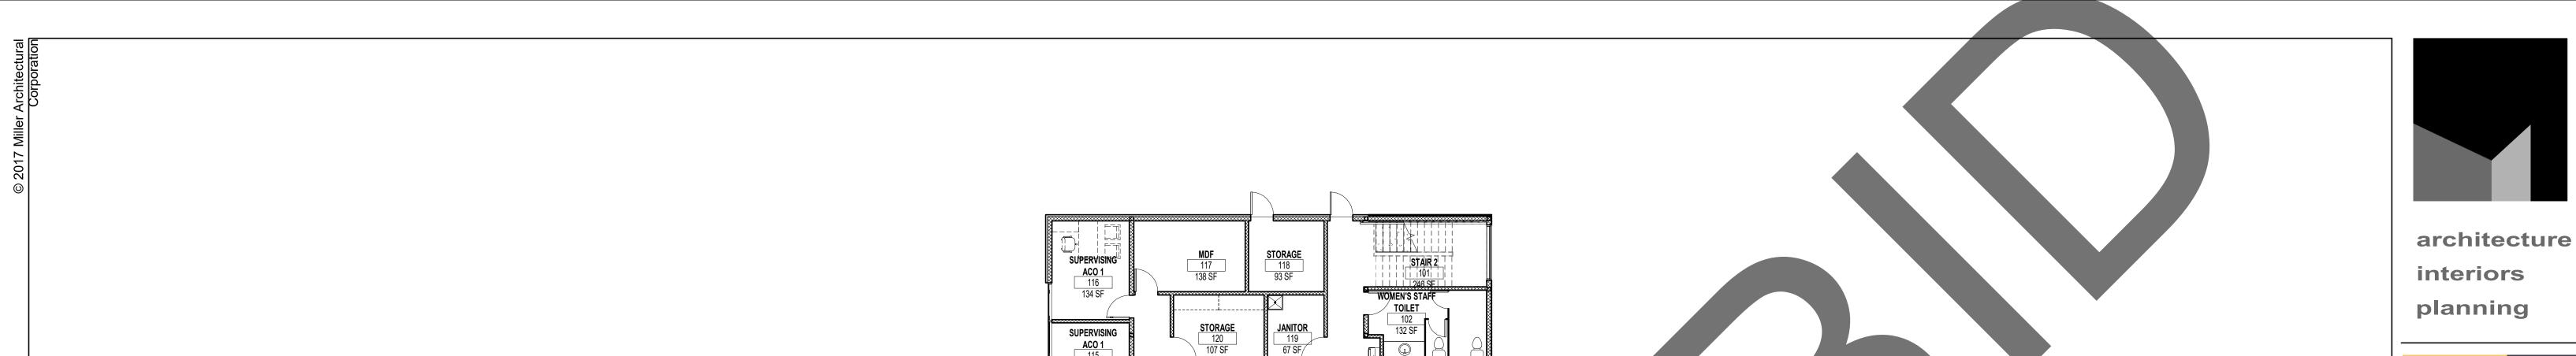
TECHNOLOGY **ENLARGED PLANS** 

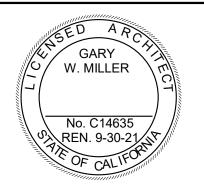

**NOT FOR** CONSTRUCTION

sheet number

T-402 Of Sheet

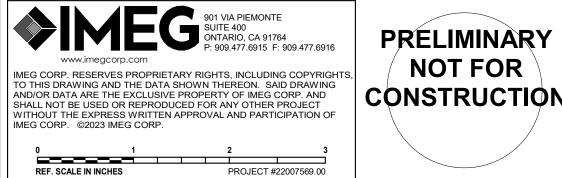

CONTROL

**ØFFICER GROUP** 

**OFFICE**1/21
468 SF

ANIMAL
LIGENSING - GROUP
122

SUPERVISING

SUPERVISING ACO, 2 114 98 SF

SUPERVISING

ACO 2 113

EDUCATION

ADMISSION

VESTIBULE 138

**VESTIBULE**134
203 SF

TOILET

STAFF

**BREAKROOM** 

104 204 SF

**AGILITY** STORAGE

INTERVIEW 1

123 7 89 SF

ADOPTION

INTERVIEW 2

WORK AREA


STORAGE

BREAKROOM

면면된면면면면면면면면면면면

된 되면 된 된 된 된 된 된 된 된 된 된 된 

147 170 SF

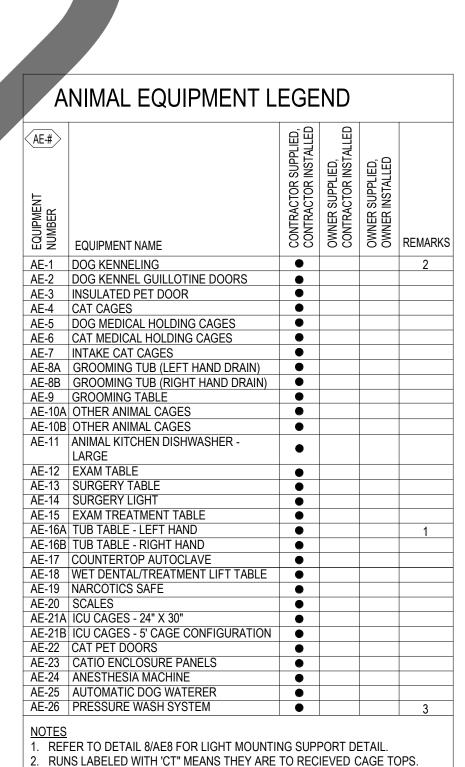

3. REMOTE STATION FOR PRESSURE WASH SYSTEM ARE LABELED AS "RS".

ANIMAL HOUSING TABULATION		
CATEGORY	ACTUAL	
ADOPTION DOGS	200	
STRAY DOGS	40	
MEDICAL ISOLATION DOGS	10	
MEDICAL OBSERVATION DOGS	20	
FOSTER DOGS	10	
DOG SUB-TOTAL	280	
ADOPTION CATS	56	
FREE ROAM CATS	12	
STRAY CATS	50	
FRACTIOUS CATS	108	
MEDICAL ISOLATION CATS	20	
STRICT MEDICAL ISOLATION CATS	20	
CAT SUB-TOTAL	266	
OTHER ANIMALS	56	
TOTAL ANIMALS	602	



owner approval				
initials	date	phase		

### revisions/addenda

Comment # Date

> BERNARDINO SAN

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ANIMAL **EQUIPMENT** PLAN


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sheet number

AE1

Of Sheet

ANIMAL EQUIPMENT PLAN - ADMINISTRATIVE BUILDING FIRST FLOOR



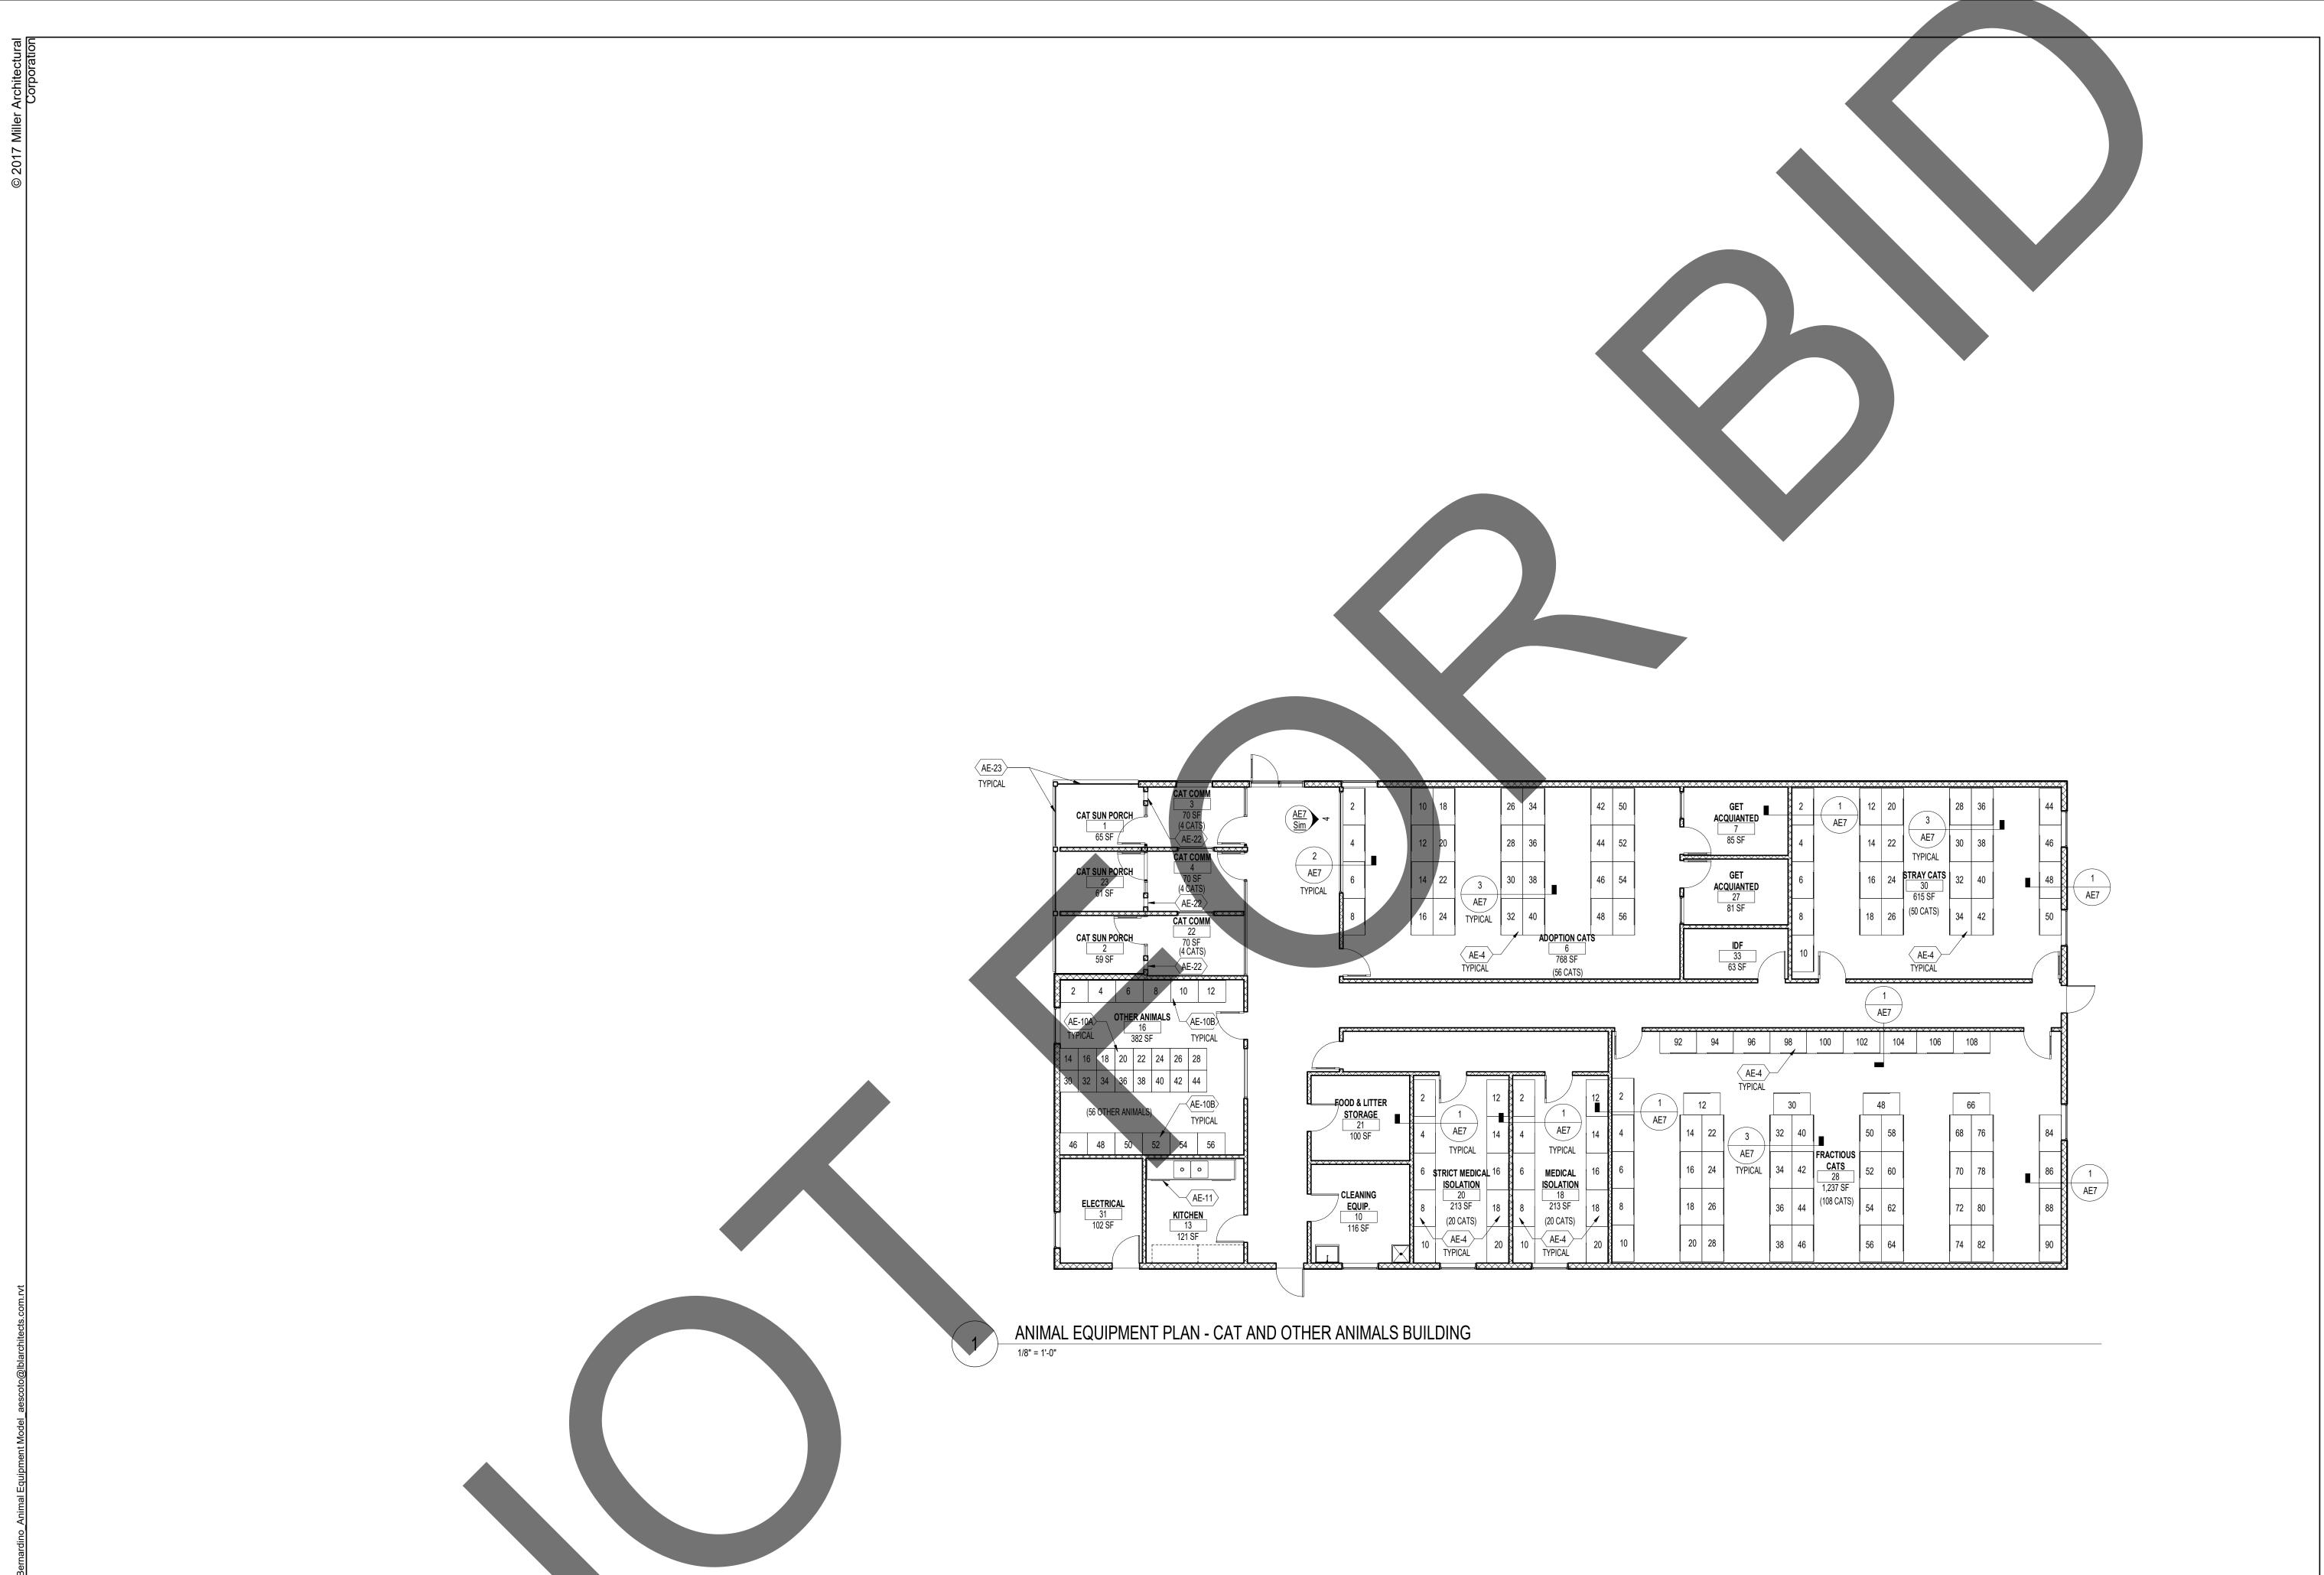

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SAN BERNARDINO

# project information

Project Number: 2200065 Drawn By: Checked By: 11/14/23 Issue Date:

#### sheet name

ANIMAL **EQUIPMENT** PLAN

sheet number

AE2

FOR ANIMAL EQUIPMENT LEGEND AND GENERAL NOTES REFER TO SEET AE1