

# SAN BERNARDINO COUNTY CSA 64 - SPRING VALLEY LAKE

# LAKEVIEW SEWER LIFT STATION REHABILITATION 100% SUBMITTAL PLANS

# PROJECT AREA SPRING VALLEY LAKE ORO GRANDE PALIDALE RD PHELAN PHELAN RD PHELAN PHELAN RD PROJECT VICINITY MAP NOT TO SOLIE

## JULY 2023

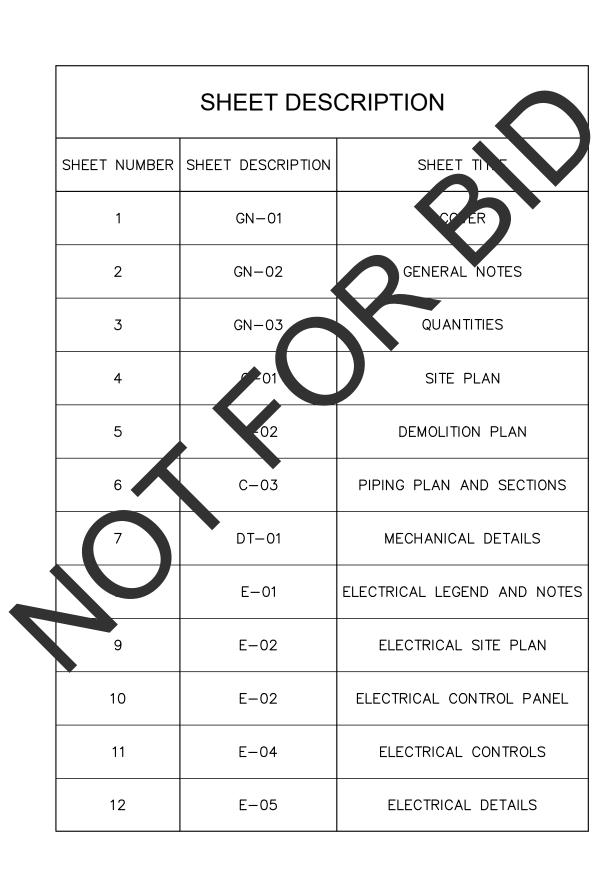

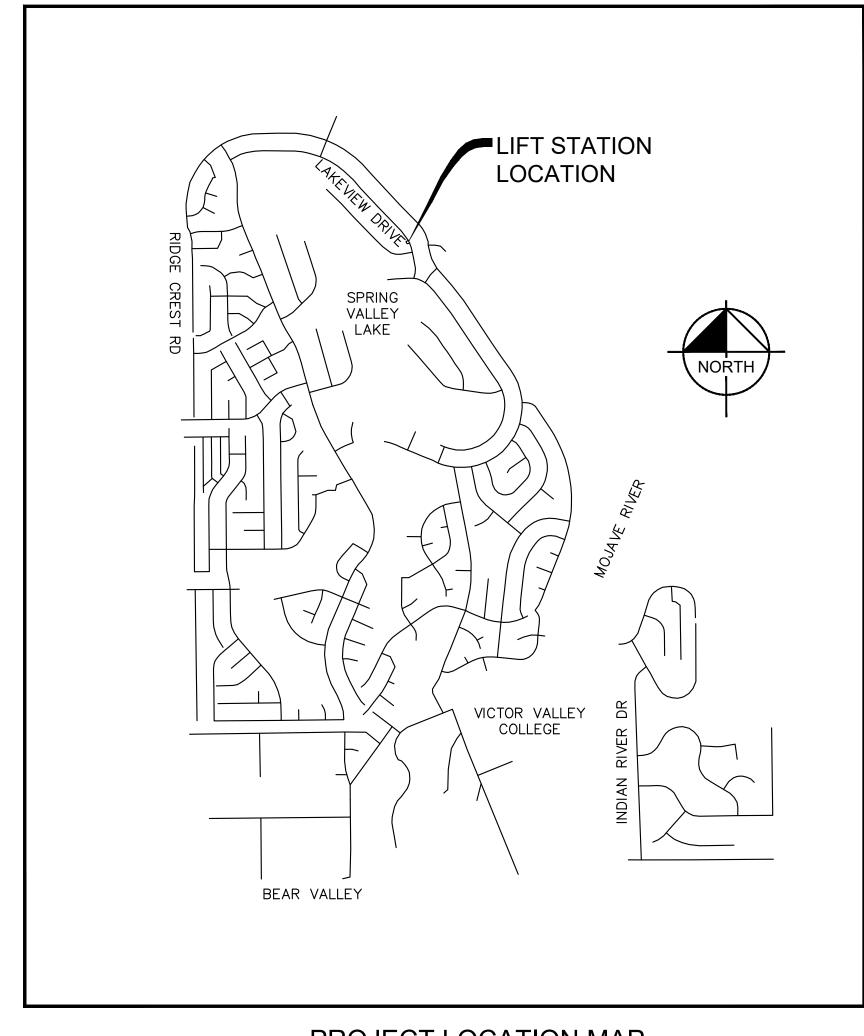

PROJECT LOCATION MAP

### **SAN BERNARDINO COUNTY**

COUNTY SERVICE AREA 64
DEPARTMENT OF PUBLIC WORKS - SPECIAL DISTRICTS
PROJECT MANAGEMENT DIVISION
222 W. HOSPITALITY LANE, 2ND FLOOR
SAN BERNARDINO, CA 92415-0763
(909) 386-8800



REVISIONS DESIGNED BY: RKC SAN		DESIGNED BY: RKC	SAN BERNARDINO COUNTY	B		
	MARK DATE BY APPROVED/RCE NO. DATE: 7/12/2023		DATE: 7/12/2023	RECOMMENDED BY:		
7.				DRAWN BY: <u>SDW</u> DATE: 7/12/2023	NAME, TITLE DATE	
2010				CHECKED BY: SLM DATE: 7/12/2023	ACCEPTED BY:  NAME, TITLE  DATE	
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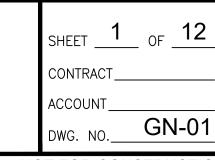
BENCH MARK NO. N/A ELEV. N/A

LOCATION: N/A





### **COVER**



- 2. PRIOR TO THE BEGINNING OF ANY CONSTRUCTION, CONTRACTOR SHALL VERIFY THE LOCATION, MATERIAL, SIZE, AND DEPTH OF ALL CROSSINGS AND CONNECTING UTILITIES REQUIRED TO COMPLETE THE WORK. UTILITY INVESTIGATION SHALL BE COMPLETED BY HAND OR HYDRO-VAC METHODS. CONTRACTOR TO PROVIDE SCALED, DETAILED, UTILITY CONFLICT FIELD NOTES AS CONDITION PRECEDENT TO PAYMENT FOR MOBILIZATION ACTIVITIES. PAY ITEMS FOR PIPELINE ADJUSTMENTS ARE INCLUDED IN THE BID FORMS IF REQUIRED IN THE ENGINEER'S SOLE OPINION.
- 3. CONTRACTOR SHALL LOCATE AND PROTECT ALL SURVEY POINTS AND POTHOLE ALL SUBSURFACE UTILITIES AND POINTS OF CONNECTION NOTED ON THE PLANS BEFORE STARTING WORK, SUBMIT A RECORD OF FIELD VERIFICATION PRIOR TO SUBMITTAL OF MAJOR EQUIPMENT SHOP DRAWINGS AND SHALL IMMEDIATELY NOTIFY THE ENGINEER OF ANY DISCREPANCIES. CONTRACTOR SHALL FIELD VERIFY THE CONDITION AND DIMENSIONS OF EXISTING STRUCTURES AND UTILITIES TO BE MAINTAINED. CONTRACTOR SHALL NOTIFY ENGINEER IF THERE IS A CONFLICT BETWEEN THE CONTRACT DOCUMENTS AND EXISTING CONSTRUCTION BEFORE PROCEEDING WITH WORK.
- 4. ACCESS CONTROL: ALL CONTRACTOR'S PERSONNEL AND SUBCONTRACTORS ARE SUBJECT TO SAN BERNARDINO COUNTY'S SECURITY POLICY REFER TO CONTRACT GENERAL CONDITION 3.13; SEE SUPPLEMENTAL GENERAL PROVISIONS. THE CONTRACTOR SHALL COORDINATE THE LOCATION OF PARKING AND STORAGE AREAS WITH THE OWNER'S REPRESENTATIVE CONTRACTOR PARKING AND STORAGE OF EQUIPMENT AND MATERIALS SHALL BE RESTRICTED TO AGREED UPON AREAS.
- 5. CONTRACTOR SHALL REESTABLISH PRE-CONSTRUCTION GROUND ELEVATIONS IN AREAS WHERE GRADING IS NOT DEFINED.
- 6. UNLESS OTHERWISE INDICATED ON THE DRAWINGS OR SPECIFIED, CIVIL CONSTRUCTION SHALL BE PER COUNTY STANDARD DETAILS AND SPECIFICATIONS. TYPICAL DETAILS SHALL APPLY EVEN THOUGH NOT REFERENCED AT SPECIFIC LOCATIONS ON DRAWINGS.
- 7. CONTRACTOR SHALL COMPLY WITH LOCAL CONSTRUCTION STORM WATER DISCHARGE REGULATIONS AND REQUIREMENTS.
- 8. PIPES SMALLER THAN 12" SHALL HAVE A MINIMUM COVER OF 30" UNLESS OTHERWISE NOTED. PIPES SHALL BE ROUTED AS SHOWN UNLESS ADJUSTMENTS ARE NECESSARY TO AVOID EXISTING PIPES, CONDUITS, BURIED STRUCTURES, ETC. CONTRACTOR SHALL BE RESPONSIBLE FOR FURNISHING ALL FITTINGS AND ADAPTERS REQUIRED TO MAKE THE ADJUSTMENTS AND SHALL BE CONSIDERED INCLUDED WITH THE PIPELINE PAY ITEM IN THE BIDDING DOCUMENTS.
- 9. THE CONTRACTOR SHALL TAKE ALL PRECAUTIONARY MEASURES NECESSARY TO PROTECT FROM DAMAGE EXISTING FACILITIES AND UTILITIES SHOWN OR NOT SHOWN THAT ARE TO REMAIN IN PLACE. ALL FACILITIES DAMAGED BY THE CONTRACTOR'S OPERATIONS SHALL BE EXPEDITIOUSLY REPAIRED OR RECONSTRUCTED TO THE ORIGINAL OR BETTER CONDITION AT THE CONTRACTOR'S EXPENSE WITHOUT ADDITIONAL COMPENSATION.
- 10. CONTRACTOR SHALL MAKE CONNECTIONS TO EXISTING PIPE, EQUIPMENT, ETC. AS REQUIRED AND SHALL PROVIDE ALL FITTINGS, ADAPTERS, AND APPURTENANCES REQUIRED TO MAKE THE CONNECTIONS. PROVIDE ALL SUPPORTS REQUIRED FOR A RIGIDLY SUPPORTED COMPLETE AND WORKING SYSTEM.
- 11. ADJUST ALL VALVE BOXES, VAULTS, PULL BOXES, AND MANHOLES TO FINISHED GRADE UNLESS OTHERWISE SHOWN OR DIRECTED. MANHOLES IN OPEN FIELDS SHALL BE SET TWELVE INCHES ABOVE FINISHED GRADE AND VAULTS SHALL BE SIX INCHES ABOVE FINISHED GRADE.
- 12. CONTRACTOR SHALL VERIFY THAT PIPING SHOWN TO BE ABANDONED OR AS ABANDONED PREVIOUSLY IS NO LONGER IN SERVICE. LINES IN SERVICE SHALL BE MAINTAINED UNTIL NO LONGER REQUIRED BY THE OWNER.
- 13. THE CONTRACTOR SHALL TAKE SPECIAL PRECAUTIONS IN THE VICINITY OF ANY UNDERGROUND OR OVERHEAD ELECTRIC LINES. CONTRACTOR SHALL ABIDE BY THE NATIONAL ELECTRIC CODE AND ANY REQUIREMENT BY THE OWNER OF THE ELECTRIC LINES.
- 14. ALL WORK SHALL BE IN ACCORDANCE WITH THE LATEST ADOPTED EDITION OF
- A. SAN BERNARDINO COUNTY GRADING A EXCAVATION REGULATIONS AND GRADING MANUAL B. SAN BERNARDINO COUNTY STANDARD PLANS
- C. SPECIAL REQUIREMENTS OF THE GRADING PERMIT
- D. THE CALIFORNIA BUILDING CODE
- STANDARD SPECIFICATIONS FOR PUBLIC WORKS CONSTRUCTION (GREEN BOOK)
- F. MANUAL OF UNIFORM TRAFFIC CONTROL DEVICES (MUTCD) 2013 CALIFORNIA SUPPLEMENT WHENEVER SPECIAL REQUIREMENTS CONFLICT ON ANY SUBJECT MATTER, THE OWNERS REPRESENTATIVE WILL DETERMINE WHICH SPECIAL REQUIREMENTS AND/OR CODE WILL GOVERN.
- 15. EXPORT SOIL MUST GO TO A LEGAL DUMPSITE OR TO A LEGAL PERMITTED SITE APPROVED BY THE OWNERS REPRESENTATIVE.
- 16. NO DIRT, ROCK OR CONSTRUCTION MATERIAL MAY BE TRACKED OR DROPPED WITHIN THE PUBLIC RIGHTS-OF-WAY DURING THE PROJECT. ANY DEBRIS IN THE PUBLIC. RIGHT-OF-WAY SHALL BE REMOVED IMMEDIATELY AND/OR AS DEEMED NECESSARY BY THE GRADING
- 17. CONTRACTOR SHALL TAKE CARE TO PROVIDE ODOR CONTROL MEASURES AS NECESSARY THROUGHOUT CONSTRUCTION OF PROJECT TIMELINE AT THE SOLE COST OF THE CONTRACTOR.
- 18. CONTRACTOR SHALL PROVIDE STRUCTURAL DESIGN AND CALCULATIONS FOR THE PIPE SUPPORTS IN THE DELEGATED DESIGN SUBMITTAL AND SHALL BE CONSIDERED PART OF THE TOTAL COST OF THE CONSTRUCTION BID. REFER TO THE DELEGATED DESIGN SUBMITTAL NOTES ON SHEET 6 FOR FURTHER GUIDANCE.
- 19. ALL WORK IS SUBJECT TO INSPECTION BY THE COUNTY. THE CONTRACTOR SHALL GIVE NOTICE TO THE COUNTY INSPECTION DEPARTMENT AT LEAST FORTY—EIGHT (48) HOURS PRIOR TO COMMENCING THE WORK. ANY WORK DONE WITHOUT PROPER INSPECTION WILL BE SUBJECT TO REJECTION.

- 20. NEITHER THE AGENCY NOR THE ENGINEER OF WORK WILL ENFORCE SAFETY MEASURES OR REGULATIONS. THE CONTRACTOR SHALL DESIGN. CONSTRUCT AND MAINTAIN ALL SAFETY DEVICES. INCLUDING SHORING. AND SHALL BE SOLELY RESPONSIBLE FOR CONFORMING TO ALL LOCAL, STATE, AND FEDERAL SAFETY AND HEALTH STANDARDS, AND REGULATIONS.
- 21. THE CONTRACTOR SHALL POT HOLE, MAKE EXPLORATION EXCAVATIONS AND LOCATE EXISTING UNDERGROUND FACILITIES SUFFICIENTLY AHEAD OF CONSTRUCTION TO PERMIT CHANGES TO PLANS IF REVISIONS ARE NECESSARY BECAUSE OF THE ACTUAL LOCATION OF EXISTING FACILITIES AND SHALL BE CONSIDERED PART OF THE TOTAL COST OF THE CONSTRUCTION BID. CONTRACTOR SHALL NOTIFY THE ENGINEER OF WORK OF ANY DISCREPANCIES BETWEEN THESE PLANS AND ACTUAL FIELD CONDITIONS PRIOR TO STARTING CONSTRUCTION.
- 22. BEFORE EXCAVATING FOR THIS CONTRACT, CONTRACTOR SHALL POTHOLE TO VERIFY LOCATION OF UNDERGROUND UTILITIES. THE EXISTENCE AND LOCATION OF ANY UNDERGROUND UTILITY CONDUITS OR STRUCTURES SHOWN ON THESE PLANS HAVE BEEN OBTAINED FROM AVAILABLE RECORDS ONLY AND MAY NOT REFLECT ALL EXISTING UTILITIES.
- 23. THE CONTRACTOR IS REQUIRED TO TAKE PRECAUTIONARY MEASURES TO PROTECT THE UTILITY LINES SHOWN HEREON AND ANY OTHER EXISTING LINES NOT OF RECORD OR SHOWN ON THESE PLANS.
- 24. THE CONTRACTOR SHALL REMOVE ALL EXISTING IMPROVEMENTS IN CONFLICT WITH THE PROPOSED IMPROVEMENTS OR PROTECT EXISTING IMPROVEMENTS AS INDICATED ON PLANS. THE CONTRACTOR SHALL REPAIR OR REPLACE ALL DAMAGED IMPROVEMENTS WHICH WERE SHOWN TO BE PROTECTED IN PLACE.
- 25. ALL DRY UTILITIES (GAS, ELECTRICAL AND TELECOMMUNICATIONS) WILL BE RELOCATED OR MODIFIED BY THE RESPECTIVE UTILITY OWNER OR THEIR REPRESENTATIVE.
- 26. ALL WATER AND SEWER FACILITY WORK SHALL BE DONE IN ACCORDANCE WITH THE RESPECTIVE COUNTY STANDARDS AND SPECIFICATIONS AND BE APPROVED BY THEIR INSPECTORS.
- 27. EXISTING UTILITIES NOT RELOCATED BY THE OWNER SHALL BE RELOCATED BY THE CONTRACTOR AS REQUIRED TO INSTALL PROPOSED IMPROVEMENTS. THE CONTRACTOR SHALL COORDINATE WITH UTILITY COMPANY PRIOR TO RELOCATION.
- 28. DURING ACTIVE CONSTRUCTION, AREAS SHALL BE WATERED TO REDUCE FUGITIVE DUST.
- 29. THE CONTRACTOR SHALL GIVE REASONABLE TIME OF NOTIFICATION TO OCCUPANTS OR OWNERS OF PROPERTY ADJACENT TO THE PROJECT TO PERMIT THEM. TO SALVAGE OR RELOCATE EXISTING IMPROVEMENTS ON PRIVATE PROPERTY WHICH WILL BE AFFECTED BY THE WORK.
- 30. THE CONTRACTOR SHALL REMOVE/REPLACE/RELOCATE ANY LANDSCAPING AND/OR HARDSCAPE WHICH CONFLICTS IN ANY WAY WITH THE INSTALLATION OR PROPER FUNCTIONING OF THE PROPOSED IMPROVEMENTS.
- 31. CONTRACTOR SHALL ADJUST ALL PROPOSED AND EXISTING FACILITIES TO GRADE.
- 32. LOCATION AND ELEVATION OF IMPROVEMENTS TO BE MET BY PROPOSED WORK SHALL BE CONFIRMED FIELD MEASUREMENTS PRIOR TO CONSTRUCTION OF NEW WORK.
- 33. "AS-BUILT" DRAWING(S) SHALL BE SUBMITTED BY THE CONTRACTOR AND APPROVED BY THE INSPECTOR AS PART OF THE PROGRESS PAYMENT REQUEST AND PRIOR TO THE ACCEPTANCE OF IMPROVEMENTS BY THE COUNTY ENGINEER.
- 34. THE CONTRACTOR SHALL MAINTAIN THE STREETS, SIDEWALKS AND ALL OTHER PUBLIC AGH -OF-WAY A CLEAN, SAFE AND USABLE CONDITION. ALL SPILLS OF SOIL, ROCK OR CONSTRUCT IS SHALL BE PROMPTLY REMOVED FROM THE PUBLICLY OWNED PROPERTY DURING CONSTRUCTION . COMPLETION OF THE PROJECT. ALL ADJACENT PROPERTY, PRIVATE OR PUBLIC, MAINTAINED IN A CLEAN, SAFE AND USABLE CONDITION.
- 35. SAFETY FENCES SHALL BE PROVIDED BY THE CONTRACTOR IF REQUIRED ENGINEER TO PROTECT THE PUBLIC.
- 36. ALL CONSTRUCTION SHALL BE AS SHOWN ON THESE PLANS, ANY DENTIFY OR REVISIONS SHALL HAVE THE PRIOR WRITTEN APPROVAL OF THE COUNTY ENGINEER.
- 37. IN THE EVENT THAT ANY UNFORESEEN CONDITIONS NOT COVE LED BY THESE PLANS ARE ENCOUNTERED DURING CONSTRUCTION, THE CONTRACTOR SHALL IMMEDIATE Y LOTIFY THE ENGINEER OF WORK FOR DIRECTION.
- 38. ALL MATERIALS PROPOSED FOR USE SHALL BE APPROVED LY THE COUNTY PRIOR TO CONSTRUCTION AND ALL ALTERNATIVE METHODS OR MATERIALS SHALL A SO BE A PROVED BY THE COUNTY PRIOR TO USE.
- HE EXISTING UTILITIES AND RELATED 39. THE CONTRACTOR SHALL BE RESPONSIBLE FOR AM EQUIPMENT, STRUCTURES, IMPROVEMENTS, AS A R. SUL. ALIS OPERATIONS AND WILL BE REQUIRED TO REPAIR OR REPLACE SAME TO THE SATISF STION OF AND AS DIRECTED BY THE COUNTY ENGINEER.
- 40. EXISTING WATER VALVES WILL BE OPENED AN CLOSED BY COUNTY PERSONNEL ONLY.
- 41. PRIOR TO PERFORMING ANY INTERCONNECTION WORK, THE CONTRACTOR SHALL SUBMIT A WORKING SCHEDULE AND WORK PROCEDURE PLAN TO THE COUNTY'S ENGINEER. THE CONTRACTOR SHALL NOT PERFORM ANY INTERCONNECTION WORK UNTIL APPROVED FOR THIS SCHEDULE AND PLAN HAS BEEN OBTAINED FROM THE COUNTY'S ENGINEER.
- 42. THE CONTRACTOR AGREES THAT HE SHALL ASSUME SOLE AND COMPLETE RESPONSIBILITY FOR JOB SITE CONDITIONS DURING THE COURSE OF CONSTRUCTION INCLUDING SAFETY OF ALL PERSONS AND PROPERTY, THAT THIS REQUIREMENT SHALL APPLY CONTINUOUSLY AND NOT BE LIMITED TO NORMAL WORKING HOURS AND THAT THE CONTRACTOR SHALL DEFEND, INDEMNIFY AND HOLD HARMLESS THE COUNTY FROM ANY AND ALL LIABILITY, SOLE NEGLIGENCE OF THE COUNTY.

### PRIVATE ENGINEER'S NOTE TO CONTRACTOR

THE EXISTENCE AND LOCATION OF ANY UNDERGROUND UTILITY PIPES, CONDUITS, OR STRUCTURES SHOWN ON THESE PLANS ARE OBTAINED BY A SEARCH OF THE AVAILABLE RECORDS. TO THE BEST OF OUR KNOWLEDGE THERE ARE NO EXISTING UTILITIES EXCEPT AS SHOWN ON THESE PLANS. THE CONTRACTOR IS REQUIRED TO TAKE DUE PRECAUTIONARY MEASURES TO PROTECT THE UTILITIES SHOWN ON THESE DRAWINGS AND TO VERIFY ALL DIMENSIONS, PIPE SIZES, PIPE MATERIALS, FLANGE SIZES, AND BOLT CONFIGURATIONS PRIOR TO ORDERING PARTS AND BEGINNING WORK. THE CONTRACTOR FURTHER ASSUMES ALL LIABILITY AND RESPONSIBILITY FOR THE UTILITY PIPES, CONDUITS OR STRUCTURES SHOWN ON THESE DRAWINGS.

CONTRACTOR AGREES THAT HE/SHE SHALL ASSUME SOLE AND COMPLETE RESPONSIBILITY FOR JOB SITE CONDITIONS DURING THE COURSE OF CONSTRUCTION OF THIS PROJECT, INCLUDING SAFETY OF ALL PERSONS AND PROPERTY, THAT THIS REQUIREMENT SHALL APPLY CONTINUOUSLY AND NOT BE LIMITED TO NORMAL WORKING HOURS, AND THAT THE CONTRACTOR SHALL DEFEND, INDEMNIFY AND HOLD SAN BERNARDINO COUNTY. CSA 64 (DISTRICT). THE OWNER AND THE ENGINEER HARMLESS FROM ANY AND ALL LIABILITY. REAL OR ALLEGED. IN CONNECTION WITH THE PERFORMANCE OF WORK ON THIS PROJECT. EXCEPTING FOR LIABILITY ARISING FROM THE SOLE NEGLIGENCE OF THE OWNER OR THE ENGINEER.

### LEGEND/ABBREVIATIONS

FLANGE

AC	ASPHALT CONCRETE
ARV	AIR RELEASE VALVE
BFV	BUTTERFLY VALVE
CL	CENTERLINE
CMU	CONCRETE MASONRY UNIT
CONC	CONCRETE
CSA	COUNTY SERVICE AREA
DI	DUCTILE IRON
DIP	DUCTILE IRON PIPE
EG	EXISTING GRADE
EXIST	EXISTING
FG	FINISHED GRADE

0011	0.414.0440.0550.44444.775	55.55	DD00000
GPM	GALLONS PER MINUTE	PROP	PROPOSED
HORZ	HORIZONTAL	PRV	PRESSURE RELEASE VALVE
HP	HORSEPOWER	PVC	POLYVINYL CHLORIDE
HWY	HIGHWAY	RD	ROAD
I.D.	INSIDE DIAMETER	RPM	REVOLUTIONS PER MINUTE
INV	INVERT	SCH	SCHEDULE
MAX	MAXIMUM	SS	STAINLESS STEEL
MIN	MINIMUM	STL	STEEL
O.C.	ON CENTER	TDH	TOTAL DYNAMIC HEAD
O.D.	OUTSIDE DIAMETER	V	VOLT
PCC	PORTLAND CEMENT CONCRETE	VCP	VITRIFIED CLAY PIPE
PE	PLAIN END	VERT	VERTICAL


GROOVE END

YVINYL CHLORIDE VOLUTIONS PER MINUTE IEDULE INLESS STEEL AL DYNAMIC HEAD RIFIED CLAY PIPE TICAL

PROTECT IN PLACE

### SAN BERNARDINO COUNTY

**COUNTY SERVICE AREA 64** DEPARTMENT OF PUBLIC WORKS - SPECIAL DISTRICTS PROJECT MANAGEMENT DIVISION 222 W. HOSPITALITY LANE, 2ND FLOOR SAN BERNARDINO, CA 92415-0763 (909) 386-8800

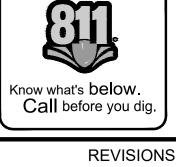

	REVISIONS			DESIGNED BY: RKC	SAN BERNARDINO COUNTY	В
MAR	DATE	BY	APPROVED/RCE NO.	DATE: 7/12/2023	RECOMMENDED BY:	Ι,
				DRAWN BY: SDW		╌╏╏
ì				DATE: 7/12/2023	NAME, TITLE DATE	
				CHECKED BY: SLM	ACCEPTED BY:	
			_	DATE: 7/12/2023	NAME, TITLE DATE	-

\_\_\_\_\_N/A\_\_\_\_ELEV.\_\_\_N/A\_\_ BENCH MARK NO. LOCATION: N/A

401 B STREET, SUITE 600, SAN DIEGO, CA 92101 PHONE: (951) 543-9868 WWW.KIMLEY-HORN.COM 7/12/2023 RENEE CHUANG 92140

PROJECT ENGINEER R.C.E. ##



### **GENERAL NOTES**

SHEET 2	OF 12
CONTRACT	
ACCOUNT	
DWG. NO	GN-02

BID ITEM NO.	CONSTRUCTION NOTE NO.	CONSTRUCTION NOTES	UNITS	TOTAL
4,5	1	FURNISH AND INSTALL FLYGT NON-CLOG SUBMERSIBLE PUMPS Q=810 GPM AT 19.7' TDH EACH PUMP. PUMP MODEL FP 3127 LT 3 ~ 491, 10 HP, 3 PHASE, 460 V, 1745 RPM.	EA	2
9	2	FURNISH AND INSTALL 6" DI 90° BEND	EA	3
9	3	FURNISH AND INSTALL 8" X 6" DI REDUCER	EA	2
26	4	FURNISH AND INSTALL 10" DIP	LF	6
25	5	FURNISH AND INSTALL 6" DIP	LF	9
19	6	FURNISH AND INSTALL USF FABRICATION HATCH SAFETY NET, OR APPROVED EQUAL. SAFETY NETS TO FIT HATCH OPENINGS PER SHEET 4.	EA	3
	7	NOT USED		
9	8	FURNISH AND INSTALL 10" DI 90° BEND	EA	1
9	9	FURNISH AND INSTALL 10" DI TEE	EA	1
9	10	FURNISH AND INSTALL 6" DI 90° BASE BEND	EA	2
9	11	FURNISH AND INSTALL 8" DI 22.5° BEND	EA	2
10	12	STAINLESS STEEL WALL MOUNTED PIPE SUPPORT.	EA	1
10	13	FURNISH AND INSTALL PIPE SUPPORT	EA	3
9	14	FURNISH AND INSTALL 6" VICTAULIC COUPLING	EA	2
	15	NOT USED	_, .	_
15	16	FURNISH AND INSTALL FOUR (4) 3" ELECTRICAL CONDUITS	LS	1
23	17	FURNISH AND INSTALL CORROSION COUPON. ATTACH TO WALL WITH SS HOOK. EPOXY ANCHOR INTO WALL.	EA	2
20	18	FURNISH AND INSTALL VALVE VAULT ACCESS LADDER.	EA	1
10	19	FURNISH AND INSTALL 6" X 6" X 1/4" 316 SST WALL PLATE WITH BOLTS EMBEDDED 4" INTO WET WELL (4 BOLTS TOTAL)	EA	1
9	20	FURNISH AND INSTALL 6" SCH 40 STAINLESS STEEL GOOSENECK VENT WITH INSECT SCREEN. SPLIT BUTT STRAP WELD TO EXISTING 6" RISER, PAINT WHITE.	EA	2
16	21	FURNISH AND INSTALL LEVEL TRANSDUCER	EA	1
16	22	FURNISH AND INSTALL CABLE AND BACKUP FLOATS	EA	1
6	23	FURNISH AND INSTALL 2" X 2" X 1/4" 316 SST SQUARE TUBING. PUMP CONTROL SUPPORT ARM CENTERED BETWEEN PUMPS.	EA	1
9	24	FURNISH AND INSTALL 10" X 8" DI 90° ELBOW REDUCER	EA	2
26	25	FURNISH AND INSTALL 10" DIP (FLG X PE)	LF	3
1	26	CONTRACTOR WORK LIMITS, SITE TEMPORARY FENCING, AND STAGING AREA	LS	1
12	27	CONSTRUCT NEW CONCRETE FOUNDATION. 8' X 5' X 2' WITH #4'S @ 12" O.C. EACH WAY. SET TOP OF CONCRETE 6" ABOVE EG. EXTEND ELECTRICAL CONDUIT STUBS AS NEEDED.	EA	1
22	28	RESTORE SITE TO EXISTING CONDITIONS INCLUDING LANDSCAPING AND IRRIGATION SYSTEMS DISTURBED DURING CONSTRUCTION	LS	1
13	29	CONSTRUCT 6' X 3' X 2' CONCRETE PAD, 4" ABOVE EG WITH #4'S @ 12" O.C. EACH WAY	EA	1
21	30	FURNISH AND INSTALL SINGLE APPLICATION SPRAY-APPLIED EPOXY LINER (250 MILS) ON ALL INTERIOR WALL SURFACES	LS	1
				1
20	31	FURNISH AND INSTALL LADDER UP SAFETY POST	EA	1
27	32	TEMPORARY PLUG. CONTRACTOR SHALL PROVIDE BYPASS OPERATION PLANS TO COUNTY AHEAD OF CONSTRUCTION.	-	-
13	33	FURNISH AND INSTALL EXPANSION JOINT	EA	1
	34	NOT USED		
	35	NOT USED		
	36	NOT USED		
	37	NOT USED		
150	38	NOT USED		
4,5,6	39	FURNISH AND INSTALL 2" PUMP GUIDE RAIL ASSEMBLY PER MANUFACTURER	EA	2
9	40	FURNISH AND INSTALL 8" DI 11.25° BEND	EA	1
9	41	FURNISH AND INSTALL 8" DI 90° BEND	A	2
8	42	FURNISH AND INSTALL 8" DIP	LP =	58
9	43	FURNISH AND INSTALL 6" DI 45° BEND	EA	1
9	44	FURNISH AND INSTALL 6" DI 22.5° BEND	EA	2
9	45	FURNISH AND INSTALL PIPE CASING SPACERS	EA	8
10	46	FURNISH AND INSTALL 8" THICK GROUT FILL WITH WIRE MESH	EA	1
10	47	STAINLESS STEEL PIPE FLANGE SUPPORT.	EA	2
10	48	STAINLESS STEEL PIPE SUPPORT.	EA	2
9	49	PIPE PENETRATION	EA	1
9	50	CONSTRUCT CONCRETE SUPPORT BLOCK	CY	1

### MASTER DEMOLITION NOTES AND QUANTITIES

BID ITEM NO.	DEMOLITION NOTE NO.	DEMOLITION NOTES	UNITS	TOTAL
-	Р	PROTECT IN PLACE	EA/LS	9
-	R	REMOVE AND DISPOSE	EA/LS	20
-	F	FILL/PLUG	EA	5
3	1	SCREW PUMPS	EA	2
3	2	GALVANIZED STL LADDER AND WALL BRACKETS	EA	2
3	3	GALVANIZED BANDED STL GRATING AND SUPPORTS	EA	2
3	4	12" X 5" X 8" EXTRUDED ALUMINUM BRICK VENT	EA	2
2	5	SLOPED CONCRETE FILL	EA	2
3	6	3/8" COPPER TUBE ATTACHED TO CONCRETE WITH CLAMPS AND BOLTS	EA	2
-	7	48" X 48" BILCO ACCESS DOOR	EA	1
-	8	TWO (2) 72" X 48" ACCESS DOORS	EA	2
3	9	6" SCH 40 GALVANIZED STL VENT EXHAUST PIPE	EA	1
3	10	EXHAUST VENT PIPE CAP	EA	1
><	11	NOT USED		
3	12	5" SCH 40 GALVANIZED STL VENT PIPE WITH WALL BRACKETS	EA	1
3	13	VENTILLATION FAN	EA	2
3	14	6" SCH 40 GALVANIZED STL VENT INLET PIPE	EA	2
3	0	FILTER	EA	2
-	16	CONCRETE CHANNEL GROUT	LS	1
	1.	CONCRETE WET WELL STRUCTURE	EA	1
3	8	EXCESS PVC PIPING IN WET WELL	LS	1
-	19	20" DI PIPE WITH TYTON JOINT INFLUENT	EA	1
-	20	21" VCP EFFLUENT	EA	1
3	21	PIPE PENETRATION	EA	3
	22	NOT USED		
3	23	WET WELL SCREW PUMP DIVIDING WALL	EA	1
-	24	STRUCTURAL BASE	EA	1

### MASTER ELECTRICAL NOTES AND QUANTITIES

BID ITEM NO.	ELECTRICAL NOTE NO.	ELECTRICAL NOTES	UNITS	TOTAL
18	1	EXISTING 200A, 277/480V, 3P, 4W METER PEDESTAL TO REMAIN. PROTECT IN PLACE.	LS	1
11,14, 15, 16	2	FURNISH AND INSTALL NEW LIFT STATION CONTROL PANEL. DEMO OF EXISTING LIFT STATION CONTROL PANEL SHOWN ON MECHANICAL PLANS. CONTRACTOR TO LOCATE EXISTING RTU MOUNTED BESIDE EXISTING LIFT STATION CONTROL PANEL AND INSTALL INSIDE OF NEW LIFT STATION CONTROL PANEL ENCLOSURE.	LS	1
18	3	FURNISH AND INSTALL 30A, 480V, 3P, NEMA 4X PUMP DISCONNECT WITH INTERNAL TERMINAL BLOCK. CONTRACTOR TO SPLICE MANUFACTURER CABLE IN DISCONNECT ENCLOSURE, AND SEND PUMP SIGNALS TO CONTROL PANEL VIA LOCAL COMMUNICATIONS JUNCTION BOX. REFER TO CONDUIT SCHEDULE FOR ADDITIONAL DETAIL. PROVIDE EYS FITTING AT BASE OF DISCONNECT FOR ALL CONDUITS ENTERING WET WELL.	LS	1
15, 16, 18	4	FURNISH AND INSTALL 6" X 6" X 4" ABOVE GRADE NEMA 4X JUNCTION BOX WITH INTERNAL TERMINAL BLOCK FOR ULTRASONIC SENSOR CABLING. BOX TO BE MOUNTED ALONGSIDE OTHER ELECTRICAL ENCLOSURES ON UNISTRUT TYPE RACK. MAKE FINAL CONNECTION TO MANUFACTURER CABLE IN JUNCTION BOX. EXTEND MANUFACTURER CABLE FROM JUNCTION BOX INTO WELL AND HANG EXCESS CABLING FROM 316SS CABLE HANGER. PROVIDE EYS FITTING IN LINE WITH CONDUIT TO WET WELL.	LS	1
15, 16, 18	5	FURNISH AND INSTALL 6" X 6" X 4" ABOVE GRADE NEMA 4X JUNCTION BOX WITH INTERNAL TERMINAL BLOCK FOR LEVEL SWITCH CABLING. BOX TO BE MOUNTED ALONGSIDE OTHER ELECTRICAL ENCLOSURES ON UNISTRUT TYPE RACK. MAKE FINAL CONNECTION TO MANUFACTURER CABLE IN JUNCTION BOX. EXTEND MANUFACTURER CABLE FROM JUNCTION BOX INTO WELL AND HANG EXCESS CABLING FROM 316SS CABLE HANGER. PROVIDE EYS FITTING IN LINE WITH CONDUIT TO WET WELL.	LS	1
-	6	PER NFPA 820 TABLE 4.2.2 ROW A, THE WET WELL IS CLASS 1 DIV 1 GROUP D.	-	-
-	7	SEE ELEVATION VIEW FOR LEVEL SWITCH MOUNTING HEIGHTS	-	-
18	8	FURNISH AND INSTALL 2' X 1' PULL BOX WITH DIVIDER FOR DIGITAL AND ANALOG COMMUNICATION SIGNALS.	LS	1
18	9	FURNISH AND INSTALL 2' X 1' ELECTRICAL PULL BOX	LS	1
17	10	FURNISH AND INSTALL 3/4" X 10' GROUND ROD TEST ROD	LS	1
14	11	CONTRACTOR TO RE-MOUNT EXISTING ANTENNA TO NEW CONTROL PANEL AND RECONNECT TO NETWORK FOR A COMPLETE WORKING SYSTEM.	LS	1
15	12	SEE DETAIL A, SHEEET 12 FOR TYPICAL CONDUIT TRENCH DETAIL. SEE CONDUIT SCHEDULE FOR CONDUIT SIZE AND LENGTH.	LS	1

### **SAN BERNARDINO COUNTY**

COUNTY SERVICE AREA 64
DEPARTMENT OF PUBLIC WORKS - SPECIAL DISTRICTS
PROJECT MANAGEMENT DIVISION
222 W. HOSPITALITY LANE, 2ND FLOOR
SAN BERNARDINO, CA 92415-0763
(909) 386-8800




REVISIONS				DESIGNED BY: RKC	SAN BERNARDINO COUNTY		
MARK	DATE	BY	APPROVED/RCE NO.	DATE: 7/12/2023	RECOMMENDED BY:		
				DRAWN BY: <u>SDW</u> DATE: 7/12/2023	NAME, TITLE DA' ACCEPTED BY:	TE	
				CHECKED BY: SLM DATE: 7/12/2023	NAME, TITLE DAT	ΓE	

BENCH MARK NO. N/A ELEV. N/A
LOCATION: N/A





### **QUANTITIES**

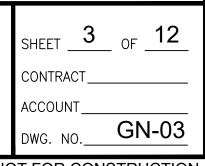

\*ONLY THE CONSTRUCTION NOTES LISTED ARE APPLICABLE TO THIS SHEET

CONSTRUCTION NOTES	QUANTITY
1 FURNISH AND INSTALL FLYGT NON-CLOG SUBMERSIBLE PUMPS Q=810 GPM AT 19.7' TDH EACH PUMP. PUMP MODEL FP 3127 LT 3 ~ 491, 10 HP, 3 PHASE, 460 V, 1745 RPM. SEE DETAIL C, SHEET 7 FOR PUMP CURVE, OR APPROVED EQUAL.	2 EA
6 FURNISH AND INSTALL USF FABRICATION HATCH SAFETY NET, OR APPROVED EQUAL. SAFETY NETS TO FIT HATCH OPENINGS PER SHEET 5.	3 EA
(26) CONTRACTOR WORK LIMITS, SITE TEMPORARY FENCING, AND STAGING AREA	1 LS
(27) CONSTRUCT NEW CONCRETE FOUNDATION. 8' X 5' X 2' WITH #4'S @ 12" O.C. EACH WAY. SET TOP OF CONCRETE 6" ABOVE EG. EXTEND ELECTRICAL CONDUIT STUBS AS NEEDED.	1 EA
(28) RESTORE SITE TO EXISTING CONDITIONS INCLUDING LANDSCAPING AND IRRIGATION SYSTEMS DISTURBED DURING CONSTRUCTION	1 LS
② CONSTRUCT 6' X 3' X 2' CONCRETE PAD, 4" ABOVE EG WITH #4'S @ 12" O.C. EACH WAY	1 EA
32) TEMPORARY PLUG. CONTRACTOR TO PROVIDE BYPASS OPERATION PLANS TO COUNTY AHEAD OF CONSTRUCTION.	-
33 FURNISH AND INSTALL EXPANSION JOINT	1 EA

**SAN BERNARDINO COUNTY** 

**COUNTY SERVICE AREA 64** 

DEPARTMENT OF PUBLIC WORKS - SPECIAL DISTRICTS PROJECT MANAGEMENT DIVISION

> 222 W. HOSPITALITY LANE, 2ND FLOOR SAN BERNARDINO, CA 92415-0763

(909) 386-8800

**REVISIONS SAN BERNARDINO COUNTY** DESIGNED BY: RKC MARK DATE BY APPROVED/RCE NO. DATE: 7/12/2023 DRAWN BY: SDW NAME, TITLE DATE: 7/12/2023 ACCEPTED BY: CHECKED BY: <u>SLM</u>
DATE: 7/12/2023

NAME, TITLE

BENCH MARK NO. N/A ELEV. N/A LOCATION: N/A

 $\frac{\text{SITE PLAN}}{\text{SCALE: } 1" = 10'}$ 


DATE

401 B STREET, SUITE 600, SAN DIEGO, CA 92101 PHONE: (951) 543-9868 WWW.KIMLEY-HORN.COM 7/12/2023 92140 RENEE CHUANG PROJECT ENGINEER R.C.E. ##







LAKEVIEW SEWER LIFT STATION REHABILITATION

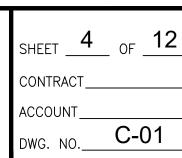

- NOT FOR CONSTRUCTION -

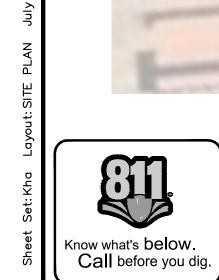

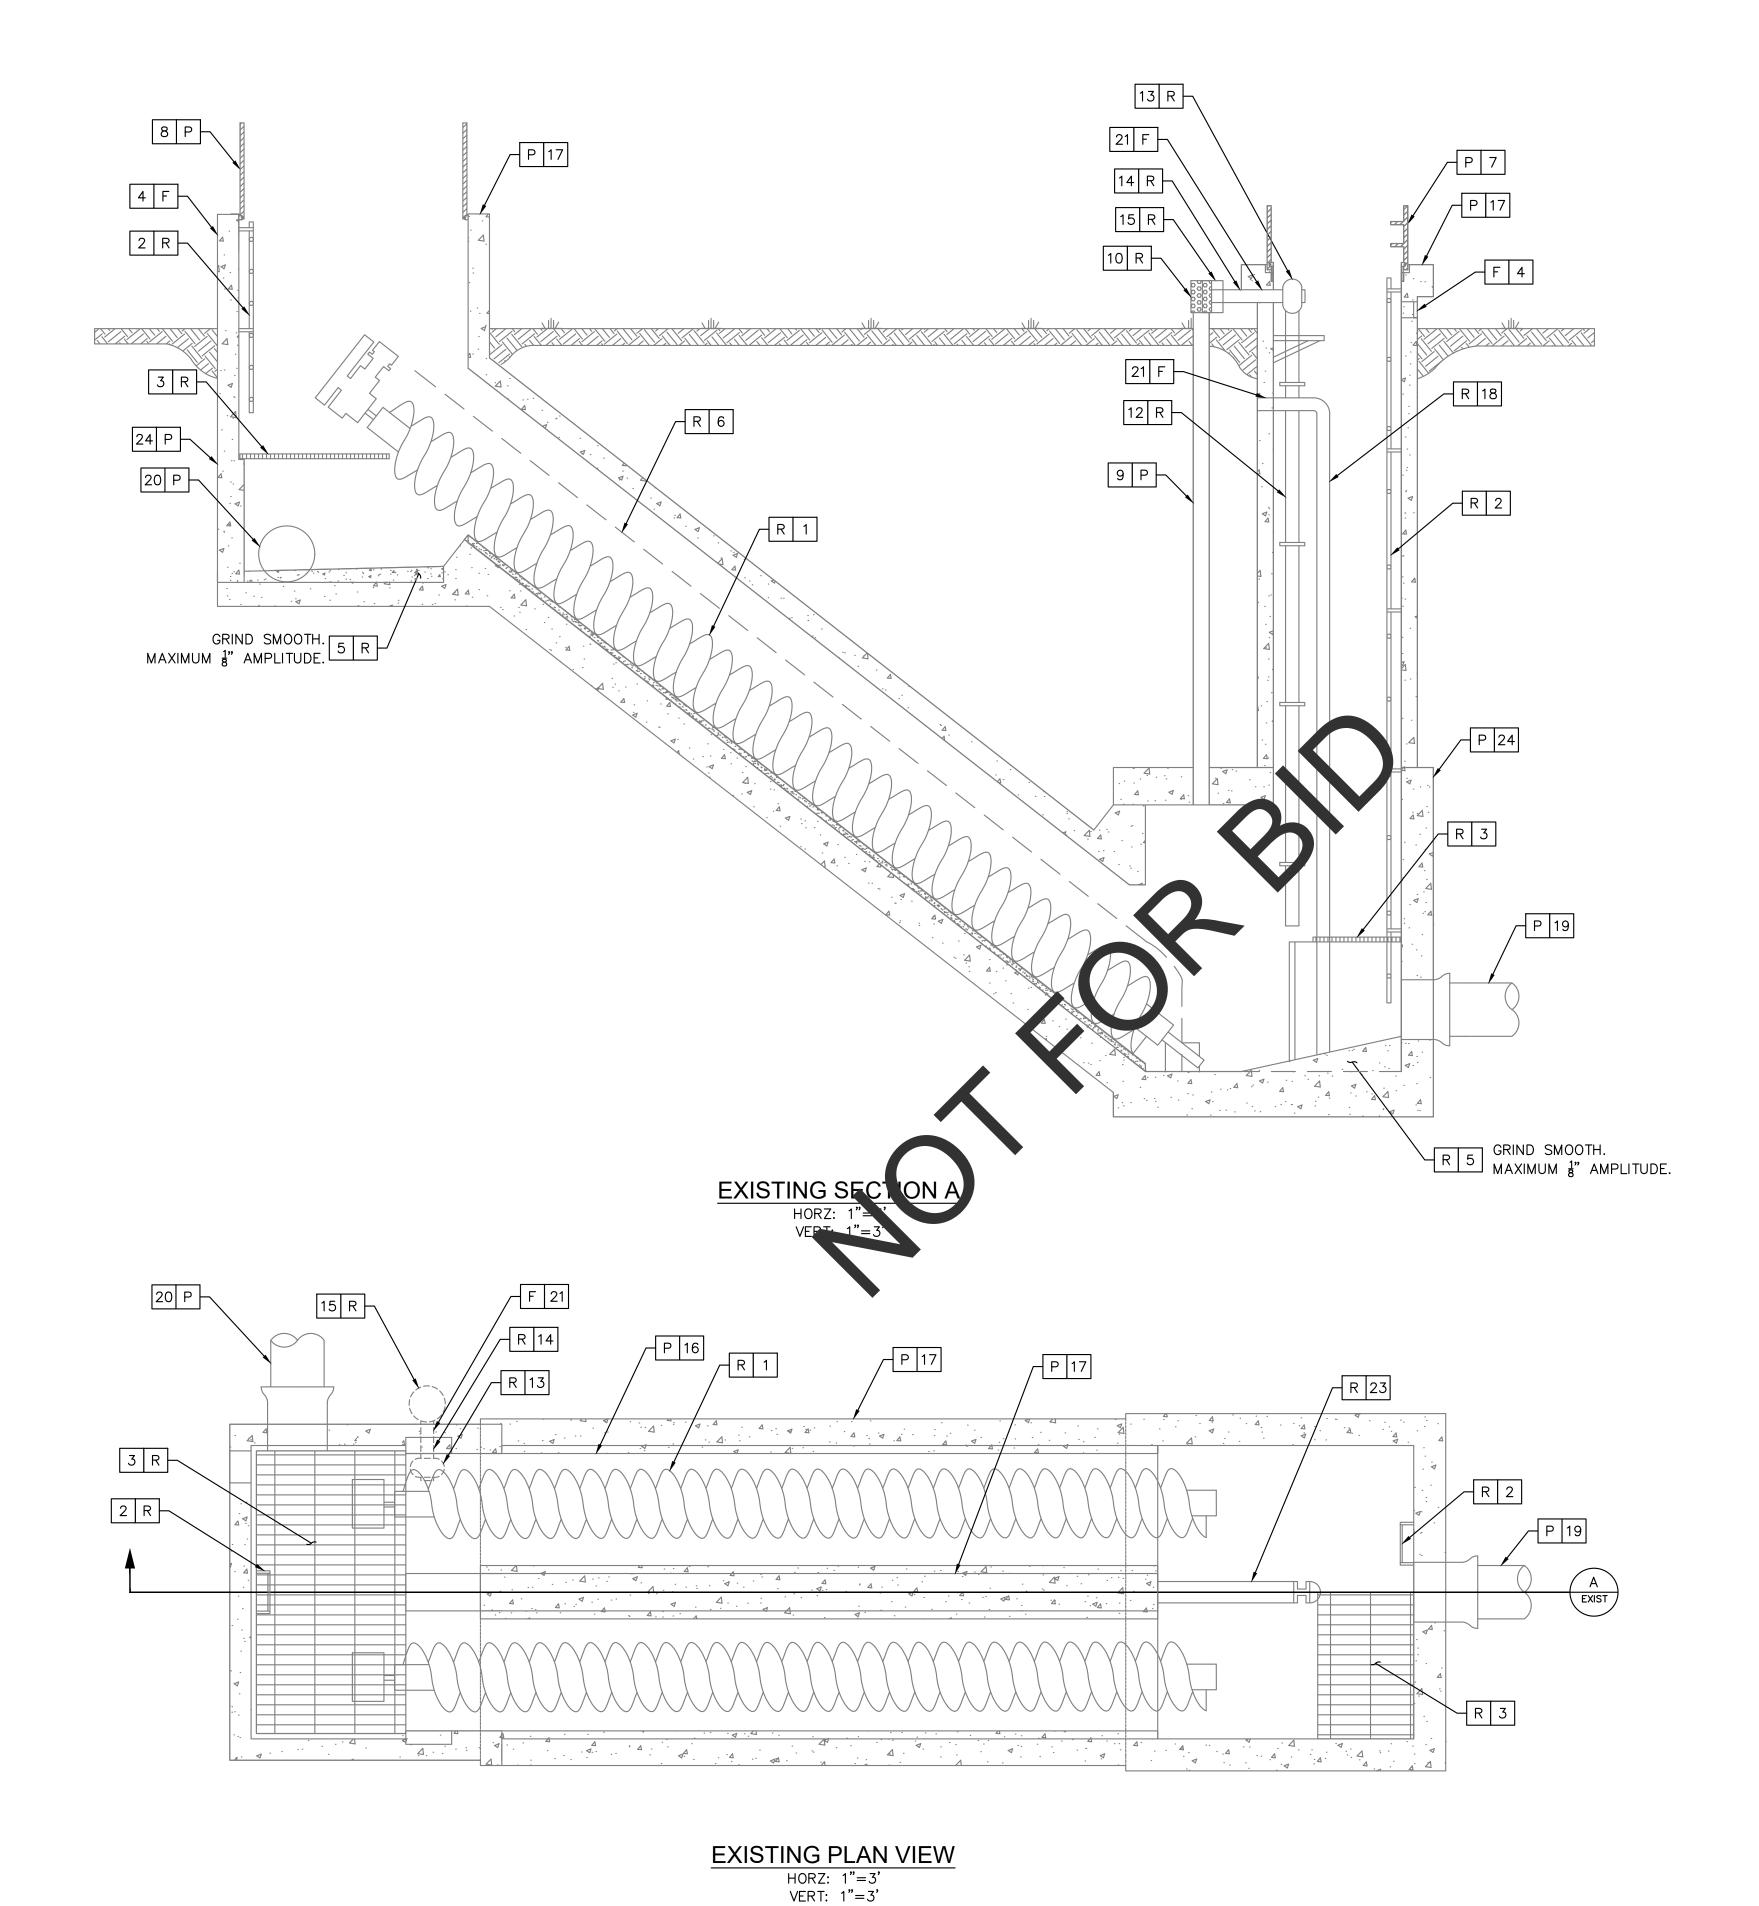

\*ONLY THE DEMOLITION NOTES LISTED ARE APPLICABLE TO THIS SHEET **DEMOLITION NOTES** QUANTITY F FILL/PLUG 9 EA/LS P PROTECT IN PLACE 20 EA/LS R REMOVE AND DISPOSE 5 EA 1 SCREW PUMPS 2 EA 2 GALVANIZED STL LADDER AND WALL BRACKETS 2 EA 3 GALVANIZED BANDED STL GRATING AND SUPPORTS 2 EA 4 12" X 5" X 8" EXTRUDED ALUMINUM BRICK VENT 2 EA 5 SLOPED CONCRETE FILL 2 EA 6 3/8" COPPER TUBE ATTACHED TO CONCRETE WITH CLAMPS AND BOLTS 2 EA 7 48" X 48" BILCO ACCESS DOOR 1 EA 8 TWO (2) 72" X 48" ACCESS DOORS 2 EA 9 6" SCH 40 GALVANIZED STL VENT EXHAUST PIPE 1 EA 10 EXHAUST VENT PIPE CAP 1 EA 12 5" SCH 40 GALVANIZED STL VENT PIPE WITH WALL BRACKETS 1 EA 13 VENTILLATION FAN 2 EA 14 6" SCH 40 GALVANIZED STL VENT INLET PIPE 2 EA 15 FILTER 2 EA 16 CONCRETE CHANNEL GROUT 1 LS 17 CONCRETE WET WELL STRUCTURE 1 EA 18 EXCESS PVC PIPING IN WET WELL 1 LS 19 20" DI PIPE WITH TYTON JOINT INFLUENT 1 EA 20 21" VCP EFFLUENT 1 EA 21 PIPE PENETRATION 3 EA 23 WET WELL SCREW PUMP DIVIDING WALL 1 EA 24 STRUCTURAL BASE 1 EA

### SAN BERNARDINO COUNTY

**COUNTY SERVICE AREA 64** DEPARTMENT OF PUBLIC WORKS - SPECIAL DISTRICTS PROJECT MANAGEMENT DIVISION 222 W. HOSPITALITY LANE, 2ND FLOOR SAN BERNARDINO, CA 92415-0763 (909) 386-8800

### **REVISIONS SAN BERNARDINO COUNTY** MARK DATE BY APPROVED/RCE NO. DATE: 7/12/2023 DRAWN BY: SDW NAME, TITLE DATE: 7/12/2023 ACCEPTED BY: CHECKED BY: SLM DATE: 7/12/2023

NAME, TITLE

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Know what's below.

Call before you dig.

\_\_\_\_N/A\_\_\_ELEV.\_\_N/A BENCH MARK NO. LOCATION: N/A


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401 B STREET, SUITE 600, SAN DIEGO, CA 92101 PHONE: (951) 543-9868 WWW.KIMLEY-HORN.COM RENEE CHUANG 92140 7/12/2023 PROJECT ENGINEER R.C.E. ##



### **DEMOLITION PLAN**

SHEET 5	OF 12
CONTRACT	
ACCOUNT	
DWG. NO	C-02

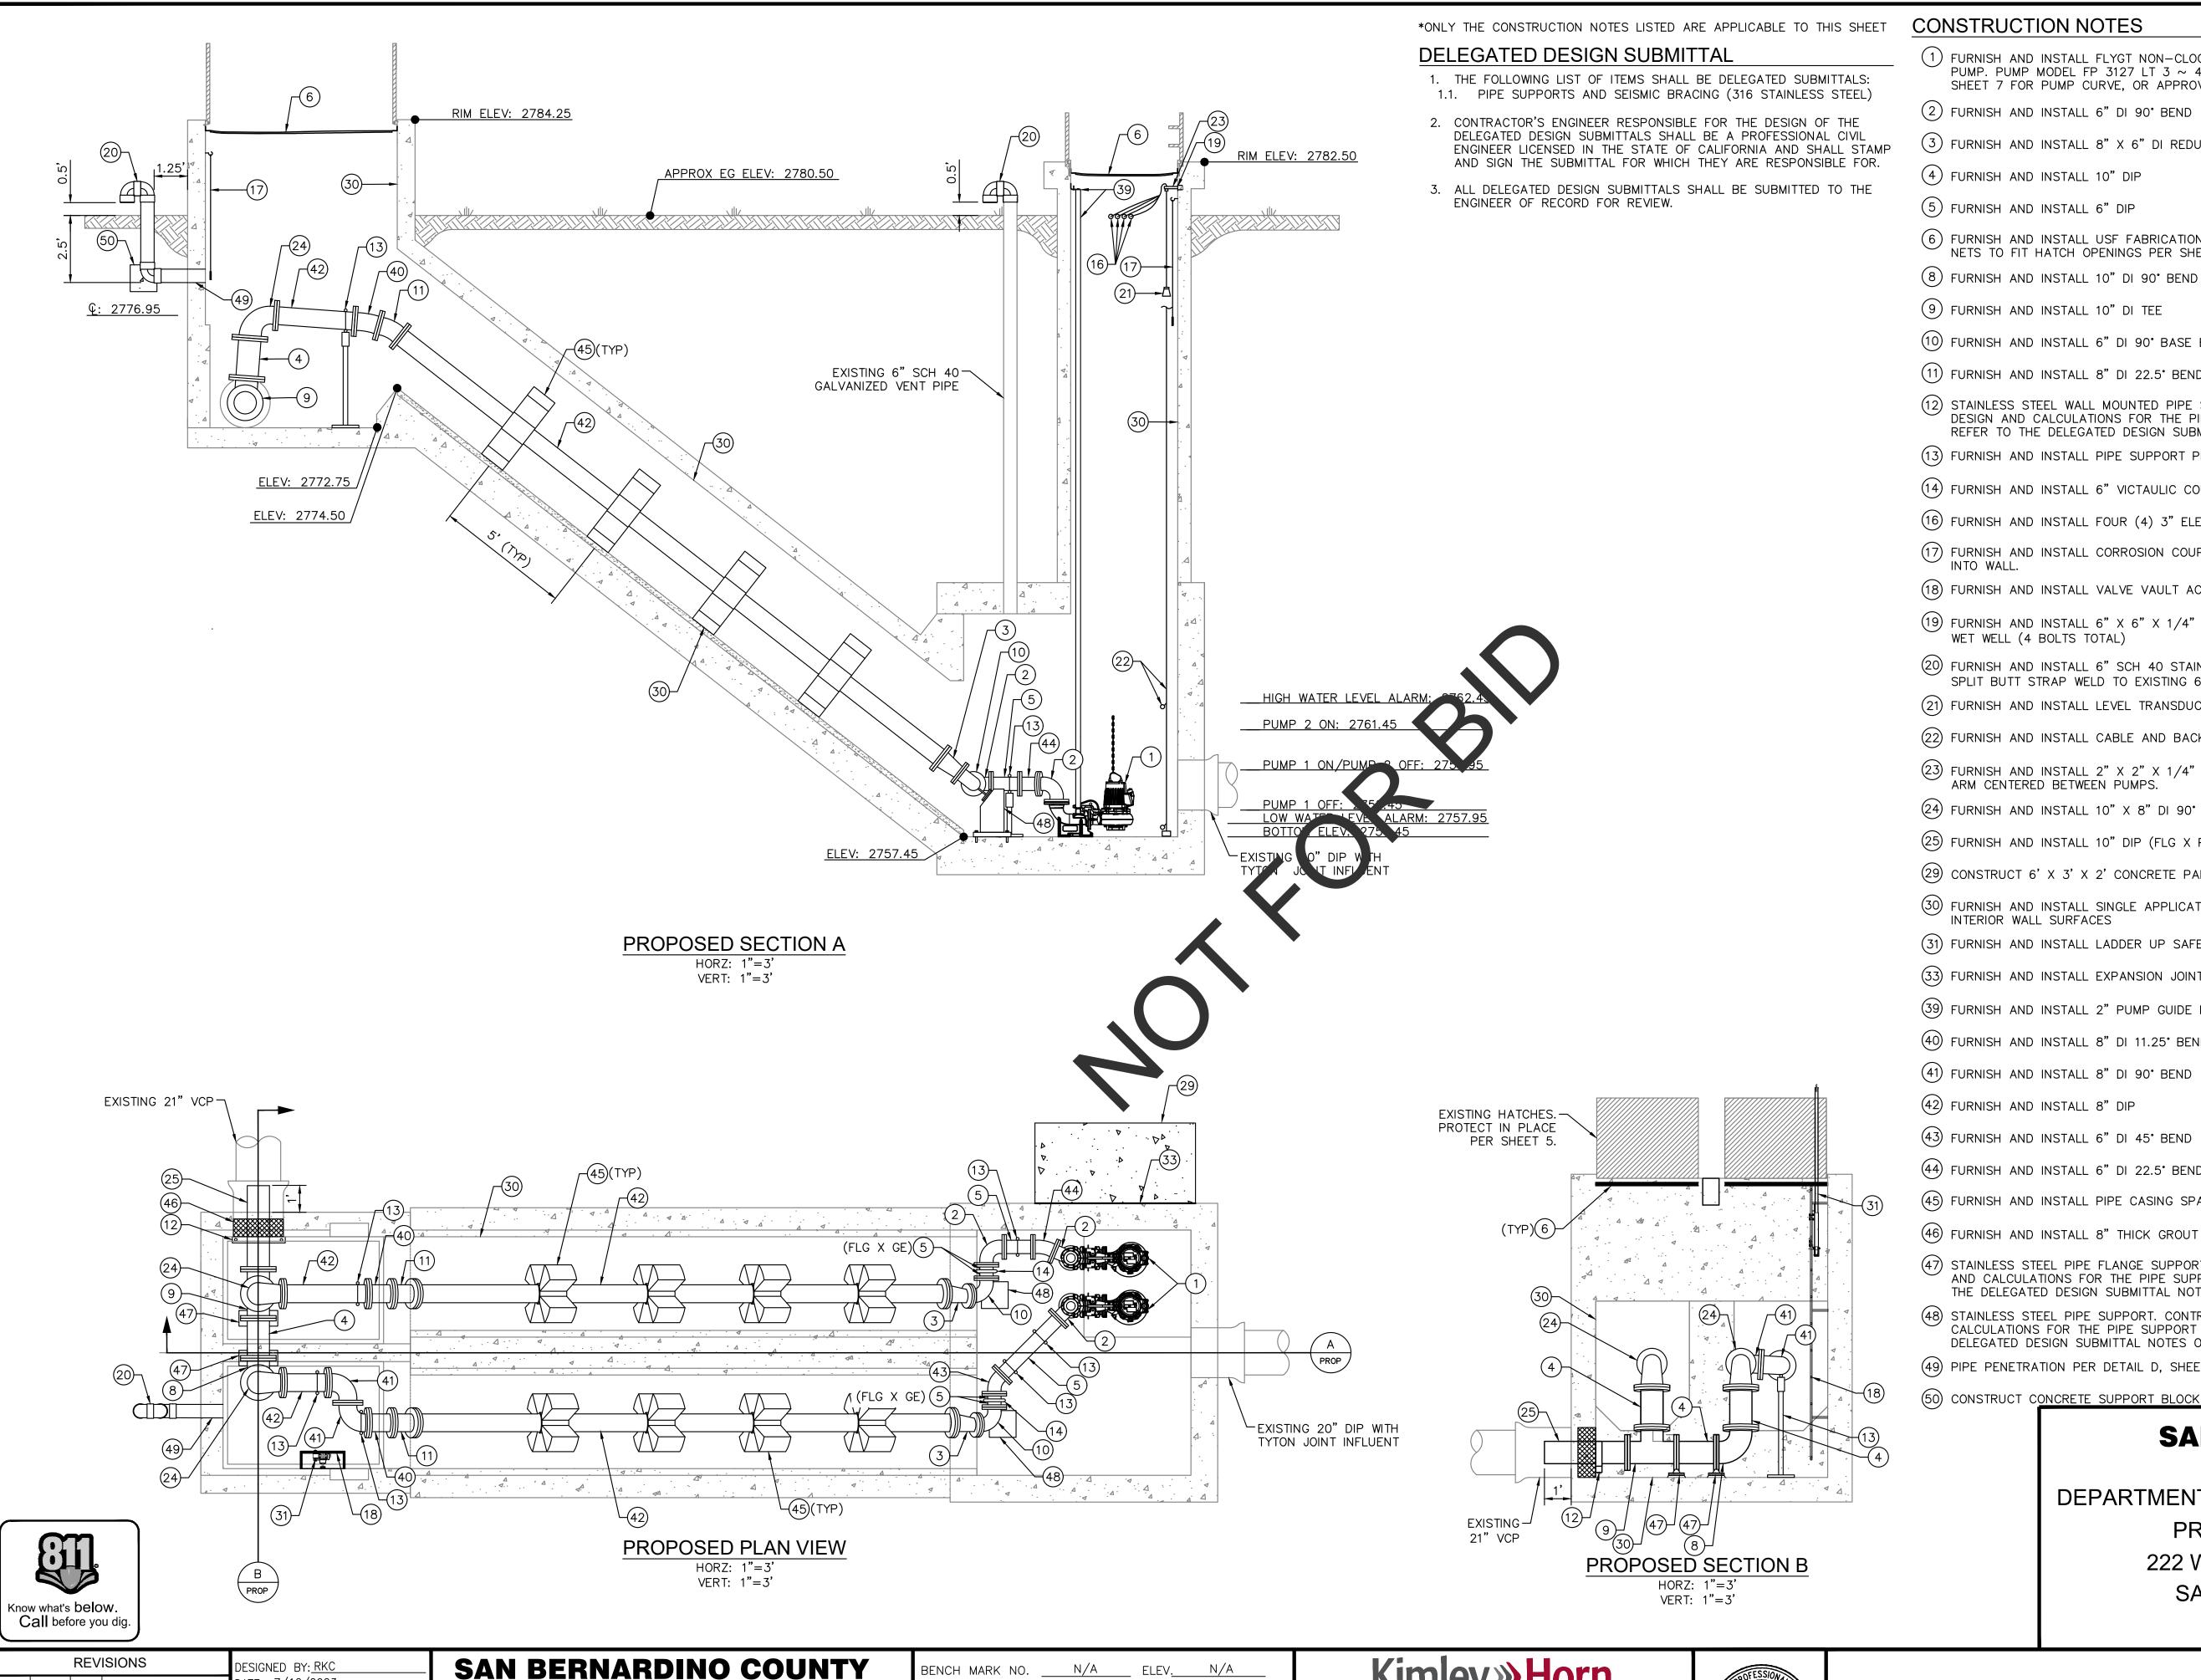

ET	CONSTRUCTION NOTES	QUANTITY
	1 FURNISH AND INSTALL FLYGT NON-CLOG SUBMERSIBLE PUMPS Q=810 GPM AT 19.7' TDH EACH PUMP. PUMP MODEL FP 3127 LT 3 ~ 491, 10 HP, 3 PHASE, 460 V, 1745 RPM. SEE DETAIL C, SHEET 7 FOR PUMP CURVE, OR APPROVED EQUAL.	2 EA
	2 FURNISH AND INSTALL 6" DI 90° BEND	3 EA
MP	3 FURNISH AND INSTALL 8" X 6" DI REDUCER	2 EA
₹.	4 FURNISH AND INSTALL 10" DIP	6 LF
	5 FURNISH AND INSTALL 6" DIP	9 LF
	6 FURNISH AND INSTALL USF FABRICATION HATCH SAFETY NET, OR APPROVED EQUAL. SAFETY NETS TO FIT HATCH OPENINGS PER SHEET 5.	3 EA
	8 FURNISH AND INSTALL 10" DI 90° BEND	1 EA
	9 FURNISH AND INSTALL 10" DI TEE	1 EA
	10 FURNISH AND INSTALL 6" DI 90° BASE BEND	2 EA
	11) FURNISH AND INSTALL 8" DI 22.5° BEND	2 EA
	STAINLESS STEEL WALL MOUNTED PIPE SUPPORT. CONTRACTOR SHALL PROVIDE STRUCTURAL DESIGN AND CALCULATIONS FOR THE PIPE SUPPORT IN THE DELEGATED DESIGN SUBMITTAL. REFER TO THE DELEGATED DESIGN SUBMITTAL NOTES ON THIS SHEET FOR FURTHER GUIDANCE.	1 EA
	13) FURNISH AND INSTALL PIPE SUPPORT PER DETAIL A, SHEET 7	3 EA
	14) FURNISH AND INSTALL 6" VICTAULIC COUPLING	2 EA
	(16) FURNISH AND INSTALL FOUR (4) 3" ELECTRICAL CONDUITS	1 LS
	17) FURNISH AND INSTALL CORROSION COUPON. ATTACH TO WALL WITH SS HOOK. EPOXY ANCHOR INTO WALL.	2 EA
	(18) FURNISH AND INSTALL VALVE VAULT ACCESS LADDER.	1 EA
	(19) FURNISH AND INSTALL 6" X 6" X 1/4" 316 SST WALL PLATE WITH BOLTS EMBEDDED 4" INTO WET WELL (4 BOLTS TOTAL)	1 EA
	20 FURNISH AND INSTALL 6" SCH 40 STAINLESS STEEL GOOSENECK VENT WITH INSECT SCREEN. SPLIT BUTT STRAP WELD TO EXISTING 6" RISER. PAINT WHITE.	2 EA
	21) FURNISH AND INSTALL LEVEL TRANSDUCER	1 EA
	22) FURNISH AND INSTALL CABLE AND BACKUP FLOATS	1 EA
	23) FURNISH AND INSTALL 2" X 2" X 1/4" 316 SST SQUARE TUBING. PUMP CONTROL SUPPORT ARM CENTERED BETWEEN PUMPS.	1 EA
	24) FURNISH AND INSTALL 10" X 8" DI 90° ELBOW REDUCER	2 EA
	25 FURNISH AND INSTALL 10" DIP (FLG X PE)	3 LF
	29 CONSTRUCT 6' X 3' X 2' CONCRETE PAD, 4" ABOVE EG WITH #4'S @ 12" O.C. EACH WAY	1 EA
	FURNISH AND INSTALL SINGLE APPLICATION SPRAY-APPLIED EPOXY LINER (250 MILS) ON ALL INTERIOR WALL SURFACES	1 LS
	(31) FURNISH AND INSTALL LADDER UP SAFETY POST PER DETAIL B, SHEET 7.	1 EA
	33) FURNISH AND INSTALL EXPANSION JOINT	1 EA
	39 FURNISH AND INSTALL 2" PUMP GUIDE RAIL ASSEMBLY PER MANUFACTURER	2 EA
	40 FURNISH AND INSTALL 8" DI 11.25° BEND	2 EA
	41) FURNISH AND INSTALL 8" DI 90° BEND	2 EA
	42 FURNISH AND INSTALL 8" DIP	58 LF
	43 FURNISH AND INSTALL 6" DI 45° BEND	1 EA
	44) FURNISH AND INSTALL 6" DI 22.5° BEND	1 EA
1	45) FURNISH AND INSTALL PIPE CASING SPACERS	8 EA
-	46 FURNISH AND INSTALL 8" THICK GROUT FILL WITH WIRE MESH	1 EA
	STAINLESS STEEL PIPE FLANGE SUPPORT. CONTRACTOR SHALL PROVIDE STRUCTURAL DESIGN AND CALCULATIONS FOR THE PIPE SUPPORT IN THE DELEGATED DESIGN SUBMITTAL. REFER TO THE DELEGATED DESIGN SUBMITTAL NOTES ON THIS SHEET FOR FURTHER GUIDANCE.	2 EA
	48) STAINLESS STEEL PIPE SUPPORT. CONTRACTOR SHALL PROVIDE STRUCTURAL DESIGN AND CALCULATIONS FOR THE PIPE SUPPORT IN THE DELEGATED DESIGN SUBMITTAL. REFER TO THE DELEGATED DESIGN SUBMITTAL NOTES ON THIS SHEET FOR FURTHER GUIDANCE.	2 EA
	49 PIPE PENETRATION PER DETAIL D, SHEET 7	1 EA
8	(50) CONSTRUCT C <u>ONCRETE SUPPORT BLOCK</u>	1 CY

### **SAN BERNARDINO COUNTY**

**COUNTY SERVICE AREA 64** 

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PROJECT MANAGEMENT DIVISION
222 W. HOSPITALITY LANE, 2ND FLOOR
SAN BERNARDINO, CA 92415-0763
(909) 386-8800

			ISIONS	DESIGNED BY: RKC	SAN BERNARDINO COUNTY	E
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				DATE: 7/12/2023  CHECKED BY: SLM	ACCEPTED BY:	
				DATE: 7/12/2023	NAME, TITLE DATE	

LOCATION: N/A

Kimley Horn

401 B STREET, SUITE 600, SAN DIEGO, CA 92101
PHONE: (951) 543-9868 WWW.KIMLEY-HORN.COM

RENEE CHUANG 92140 7/12/2023
PROJECT ENGINEER R.C.E. ## DATE





### PIPING PLAN AND SECTIONS


LAKEVIEW SEWER LIFT STATION REHABILITATION


SHEET 6 OF 12

CONTRACT ACCOUNT C-03

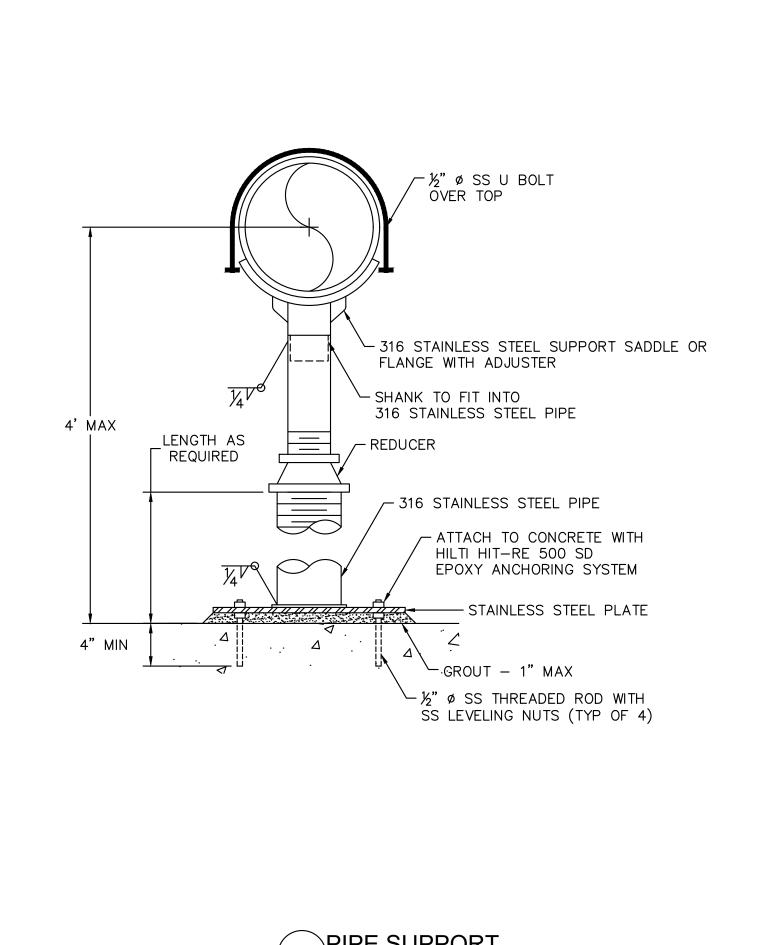

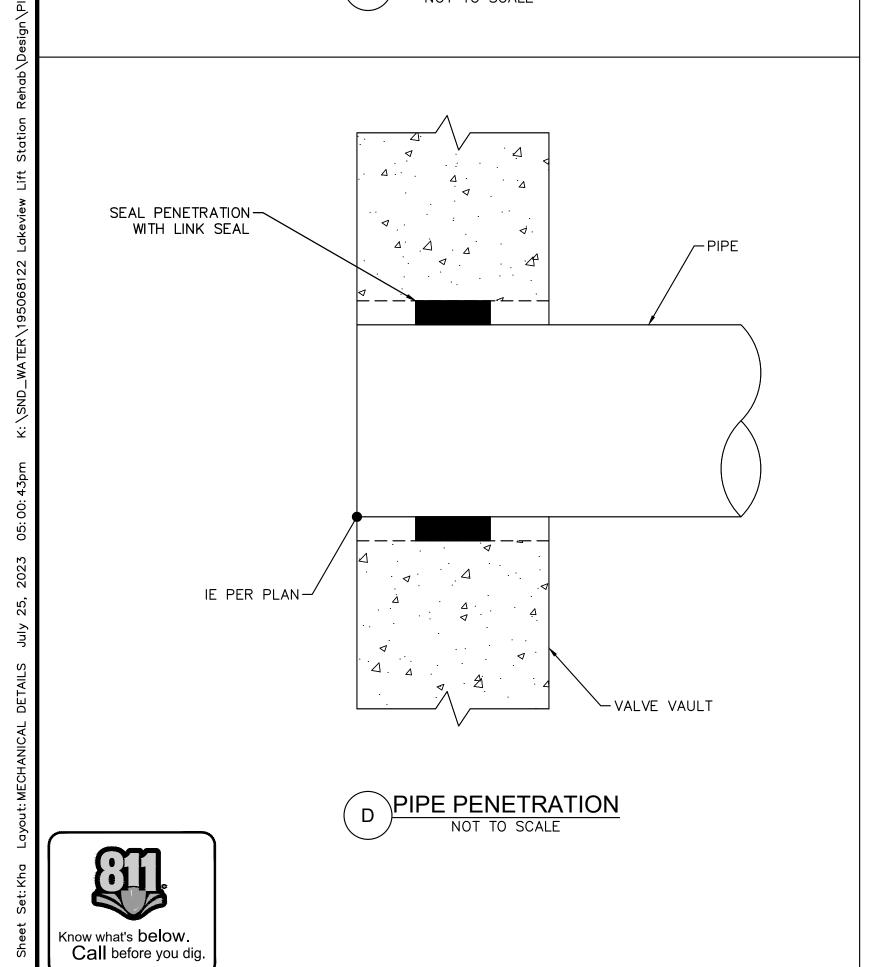

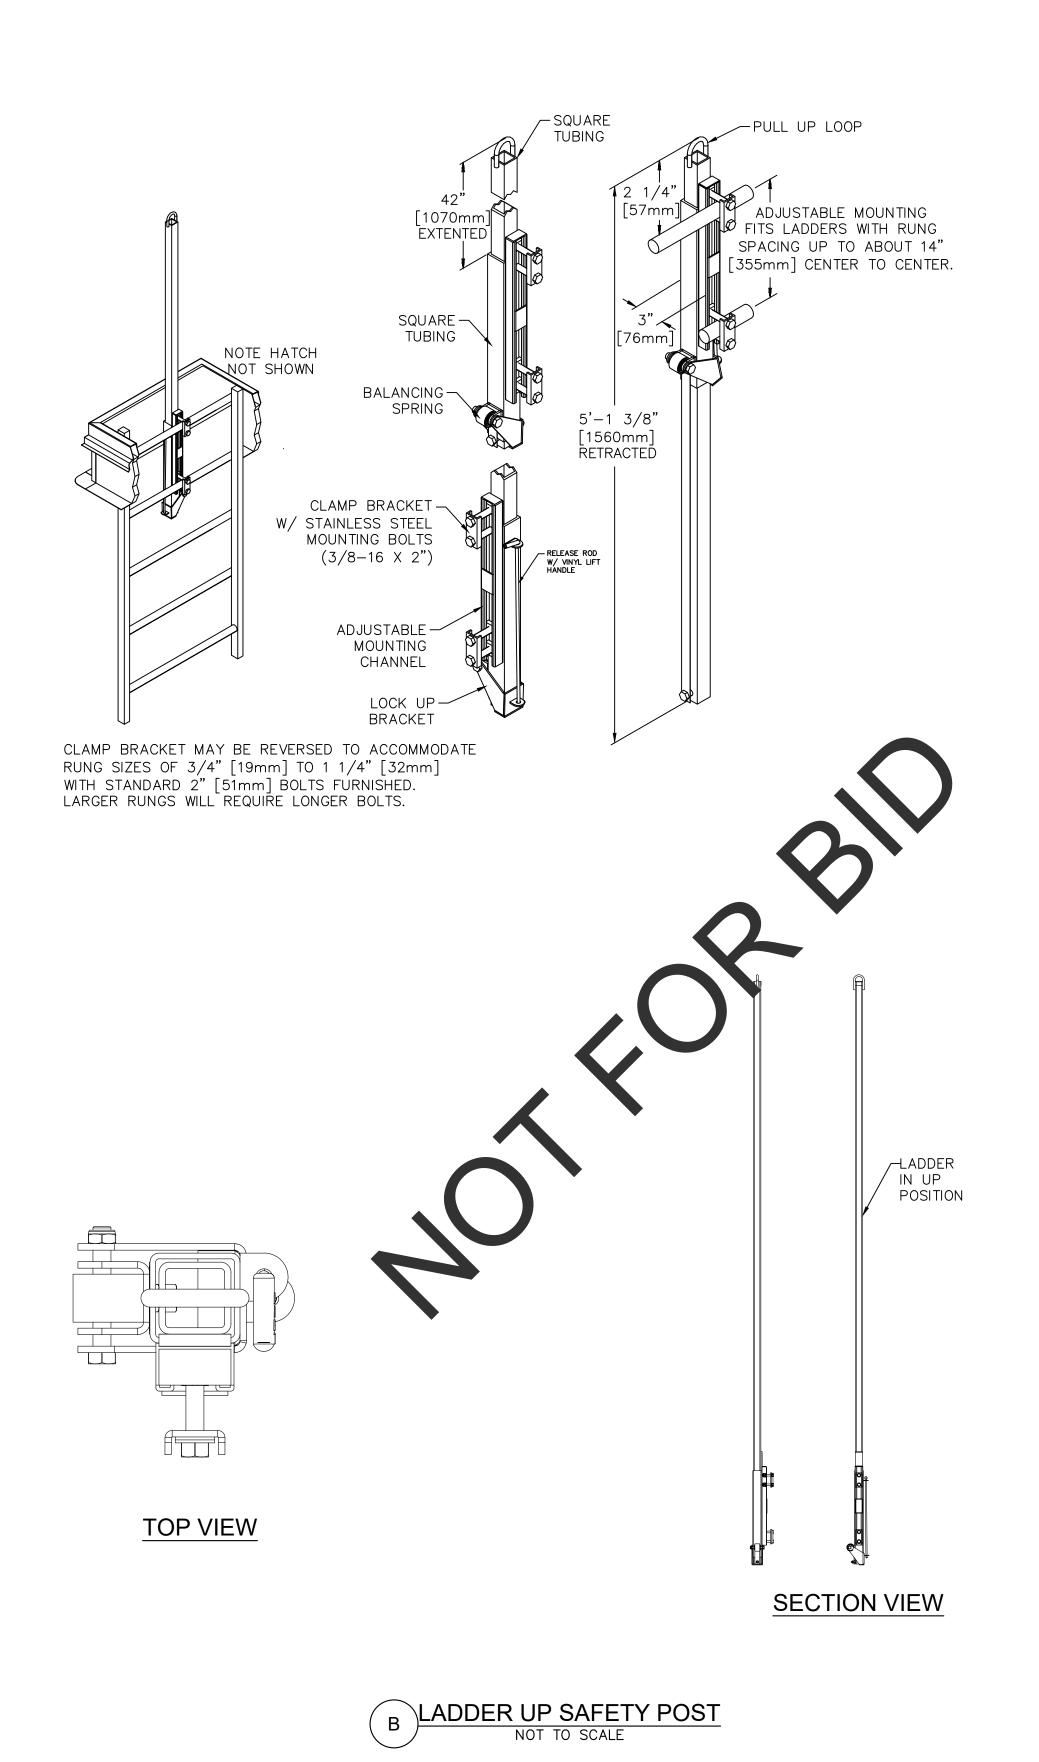

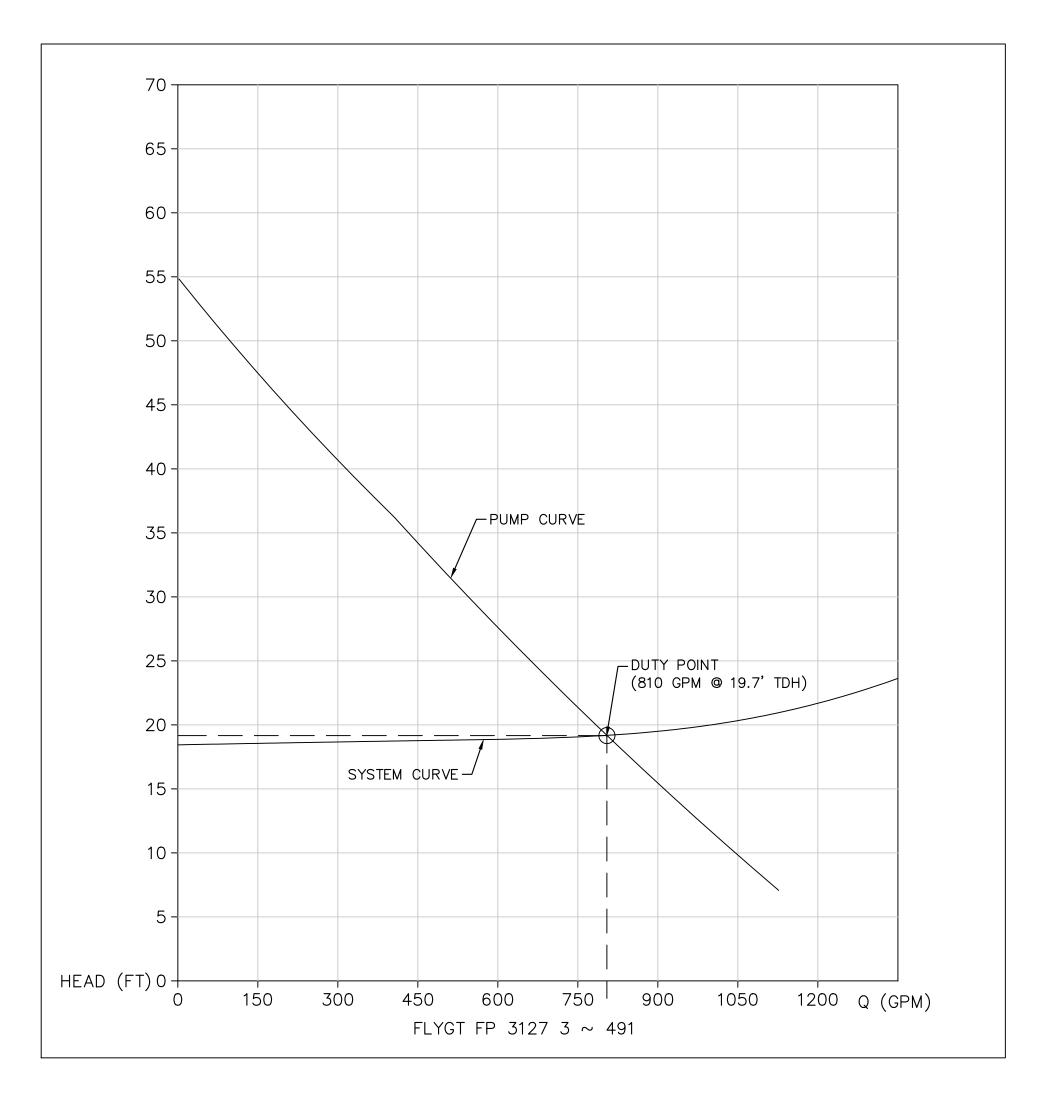



### SAN BERNARDINO COUNTY

COUNTY SERVICE AREA 64
DEPARTMENT OF PUBLIC WORKS - SPECIAL DISTRICTS
PROJECT MANAGEMENT DIVISION
222 W. HOSPITALITY LANE, 2ND FLOOR
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BENCH MARK NO. N/A ELEV. N/A
LOCATION: N/A


Kimley Horn

401 B STREET, SUITE 600, SAN DIEGO, CA 92101
PHONE: (951) 543-9868 WWW.KIMLEY-HORN.COM

RENEE CHUANG 92140 7/12/2023
PROJECT ENGINEER R.C.E. ## DATE



### MECHANICAL DETAILS

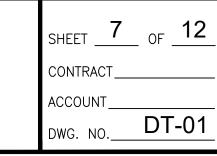

### **ABBREVIATIONS**

EA EACH

AMP AMPERE ELECT ELECTRICAL LTG LIGHTING NO. NUMBER TEL TELEPHONE AL ALUMINUM **ELEV ELEVATION** MAX MAXIMUM PLC PROGRAMMABLE LOGIC TDR TIME DELAY RELAY ATS AUTOMATIC TRANSFER **EXIST EXISTING** MCC MOTOR CONTROL CENTER CONTROLLER TTB TELEPHONE TERMINAL MCP MAIN CONTROL PANEL FLA FULL LOAD AMPS PNL PANEL BACKBOARD AWG AMERICAN WIRE GAUGE MCM THOUSAND CIRCULAR MIL PR PAIR TYP TYPICAL FUT FUTURE BRK BREAKER GFCI GROUND FAULT UCP UNIT CONTROL PANEL PVC POLYVINYL CHLORIDE CAT CATALOG CIRCUIT INTERRUPTER MFR MANUFACTURER REC RECEPTACLE V VOLTS CIRC. MIL CIRCULAR MILS (AWG) GND GROUND MIN MINIMUM RGS RIGID GALVANIZED STEEL WP WEATHERPROOF C.O. CONDUIT ONLY HP HORSEPOWER MIS MISCELLANEOUS SCE SOUTHERN CALIFORNIA XFMR TRANSFORMER CKT CIRCUIT HPS HIGH PRESSURE SODIUM MPZ MINI POWER ZONE HZ HERTZ (CYCLES PER SECOND) MTG MOUNTING CP CONTROL PANEL SCHED SCHEDULE IC INTERRUPTING CAPACITY DIA DIAMETER N.C. NORMALLY CLOSED SES SERVICE ENTRANCE SECTION NEC NATIONAL ELECTRICAL CODE SPECS SPECIFICATIONS DWG DRAWING KV KILOVOLTS

LCL LONG CONTINUOUS LOAD N.O. NORMALLY OPEN

### GENERAL ELECTRICAL REQUIREMENTS

1. THE COMPLETED INSTALLATION SHALL CONFORM TO ALL APPLICABLE FEDERAL, STATE AND LOCAL CODE ORDINANCES AND REGULATIONS. CONTRACTOR SHALL OBTAIN NECESSARY PERMITS AND INSPECTIONS REQUIRED BY THE AUTHORITIES HAVING JURISDICTION. ALL WORK SHALL BE DONE IN A NEAT, WORKMANLIKE, FINISHED AND SAFE MANNER, ACCORDING TO THE LATEST PUBLISHED N.E.C.A. STANDARDS OF INSTALLATION, UNDER COMPETENT SUPERVISION. INSTALL GROUNDING AS REQUIRED BY THE CODE(S).

SSS SOLID STATE STARTER

- 2. VISIT THE SITE PRIOR TO BIDDING TO BECOME FAMILIAR WITH EXISTING CONDITIONS AND ALL OTHER FACTORS WHICH MAY AFFECT THE EXECUTION OF THIS WORK. INCLUDE ALL RELATED COSTS IN THE INITIAL BID PROPOSAL
- 3. ALL MATERIALS SHALL BE NEW AND OF THE BEST QUALITY. MANUFACTURED IN ACCORDANCE WITH NEMA, ANSI, U.L. OR OTHER APPLICABLE STANDARDS. THE USE OF MANUFACTURER'S NAMES, MODELS, AND NUMBERS IS INTENDED TO ESTABLISH STYLE, QUALITY, APPEARANCE, USEFULNESS AND BID PRICE. PROPOSED SUBSTITUTIONS SHALL BE SUBMITTED IN WRITING AND REVIEWED BY THE ENGINEER BEFORE ORDERING.
- 4. PROTECT ALL ELECTRICAL MATERIAL AND EQUIPMENT INSTALLED AGAINST DAMAGE BY OTHER TRADES, WEATHER CONDITIONS OR ANY OTHER CAUSES. EQUIPMENT FOUND DAMAGED OR IN OTHER THAN NEW CONDITION WILL BE REJECTED AS DEFECTIVE.
- EALL DEBRIS, EMPTY CARTONS, TOOLS, CONDUIT, WIRE SCRAPS AND ALL MISCELLANEOUS SPARE EQUIPMENT AND MATERIALS USED IN THE WORK DURING CONSTRUCTION. ALL COMPONENTS ST, GRIT IND FOREIGN MATERIALS, LEFT AS NEW BEFORE FINAL ACCEPTANCE OF WORK. SHALL BE FREE OF
- CIRCUIT CONDUCT OR SMALLER TO BE COPPER TYPE "XHHW" FOR BELOW GRADE INSTALLATION OR COPPER TYPE THHN/THWN FOR ABOVE GRADE INSTALLATIONS. #1 AWG OR LARGER SHALL BE COPPER TYPE "XHHW-2" ST . MINIMUM CONDUCTOR SIZE TO BE #10 AWG WITH #10 GND.
- TS TO BE SCHEDULE 40 PVC. MINIMUM DEPTH 30", MINIMUM SIZE 1", UNLESS OTHERWISE SHOWN ON THE PLANS. CONDUITS AS SHOWN ARE FOR INFORMATION ONLY. EXACT CONDUIT ROUTING SHALL BE FIELD BY THE CONTRACTOR AND SHALL BE CONSIDERED PART OF THE TOTAL COST OF THE CONSTRUCTION BID.
- ITS EXPOSED TO BE PVC COATED RIGID WITH PLUGS FOR WELLS, MINIMUM SIZE 3/4", UNLESS OTHERWISE NOTED ON THE PLANS. PVC COATED RIGID CONDUIT SHALL EXTEND BELOW GRADE TO THE FIRST W. ALL PVC COATED RIGID CONDUIT EXPOSED TO EARTH SHALL BE HALF LAPPED WRAPPED IN SCOTCHRAP 50 10 MIL TAPE OR EQUAL. EXTEND WRAP TO A HEIGHT OF 12" ABOVE GRADE. INDOOR CONDUITS SHALL BE IMC MT UNLESS OTHERWISE SHOWN ON PLAN.
- L SAFETY SWITCHES AND OTHER DISTRIBUTION AND CONTROL ELECTRICAL EQUIPMENT SHALL BE U.L. LISTED AND RATED FOR HEAVY DUTY SERVICE.
- ALL WIRING DEVICES SHALL BE SPECIFICATION GRADE.
- ELECTRICAL EQUIPMENT, CONDUIT, WIRING, BOXES, ETC. SHALL BE SUBMITTED TO THE ENGINEER FOR REVIEW PRIOR TO ORDERING. THE SUBMITTALS SHALL BE NEATLY GROUPED AND ORGANIZED. PERTINENT INFORMATION SHALL BE HIGHLIGHTED, AND THE SPECIFIC PRODUCT SHALL BE IDENTIFIED. ALL SUBMITTALS SHALL BE COMPLETE, AND PRESENTED IN ONE PACKAGE. THE SUBMITTAL SHALL INCLUDE A COMPLETE LIST OF THE EQUIPMENT AND MATERIALS, INCLUDING THE MANUFACTURER'S NAME, PRODUCT SPECIFICATION, DESCRIPTIVE DATA, TECHNICAL LITERATURE, PERFORMANCE CHARTS, CATALOG CUTS, INSTALLATION INSTRUCTIONS, AND SPARE PART RECOMMENDATIONS FOR EACH DIFFERENT ITEM OF THE EQUIPMENT SPECIFIED.
- 12. IT IS THE OBLIGATION AND RESPONSIBILITY OF THE CONTRACTOR TO ORGANIZE HIS WORK, SO THAT A COMPLETE ELECTRICAL, INSTRUMENTATION, AND CONTROL SYSTEM FOR THE FACILITY WILL BE PROVIDED, AND WILL BE SUPPORTED BY ACCURATE SHOP AND RECORD DRAWINGS, AND O & M MANUALS AND SHALL BE CONSIDERED PART OF THE TOTAL COST OF THE CONSTRUCTION BID.

### SAN BERNARDINO COUNTY

**COUNTY SERVICE AREA 64** DEPARTMENT OF PUBLIC WORKS - SPECIAL DISTRICTS PROJECT MANAGEMENT DIVISION 222 W. HOSPITALITY LANE, 2ND FLOOR SAN BERNARDINO, CA 92415-0763 (909) 386-8800

	-			<u> </u>			
			REVI	SIONS	DESIGNED BY: EG	SAN BERNARDINO COUNTY	
MA	ARK	DATE	BY	APPROVED/RCE NO.	DATE: 7/12/2023	RECOMMENDED BY:	
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811

Know what's below. Call before you dig.

> Kimley» Horn <u> N/A</u> ELEV.<u> N/A</u> 401 B STREET, SUITE 600, SAN DIEGO, CA 92101 PHONE: (951) 543-9868 WWW.KIMLEY-HORN.COM MICHAEL COLOMBO 19280 PROJECT ENGINEER R.C.E. ##

BENCH MARK NO.


LOCATION: N/A



7/12/2023

### **ELECTRICAL LEGEND AND NOTES**

	SHEET 8 OF 12	2
	CONTRACT	
	ACCOUNT	
	DWG. NO. <b>E-01</b>	
_	T 500 000000000	

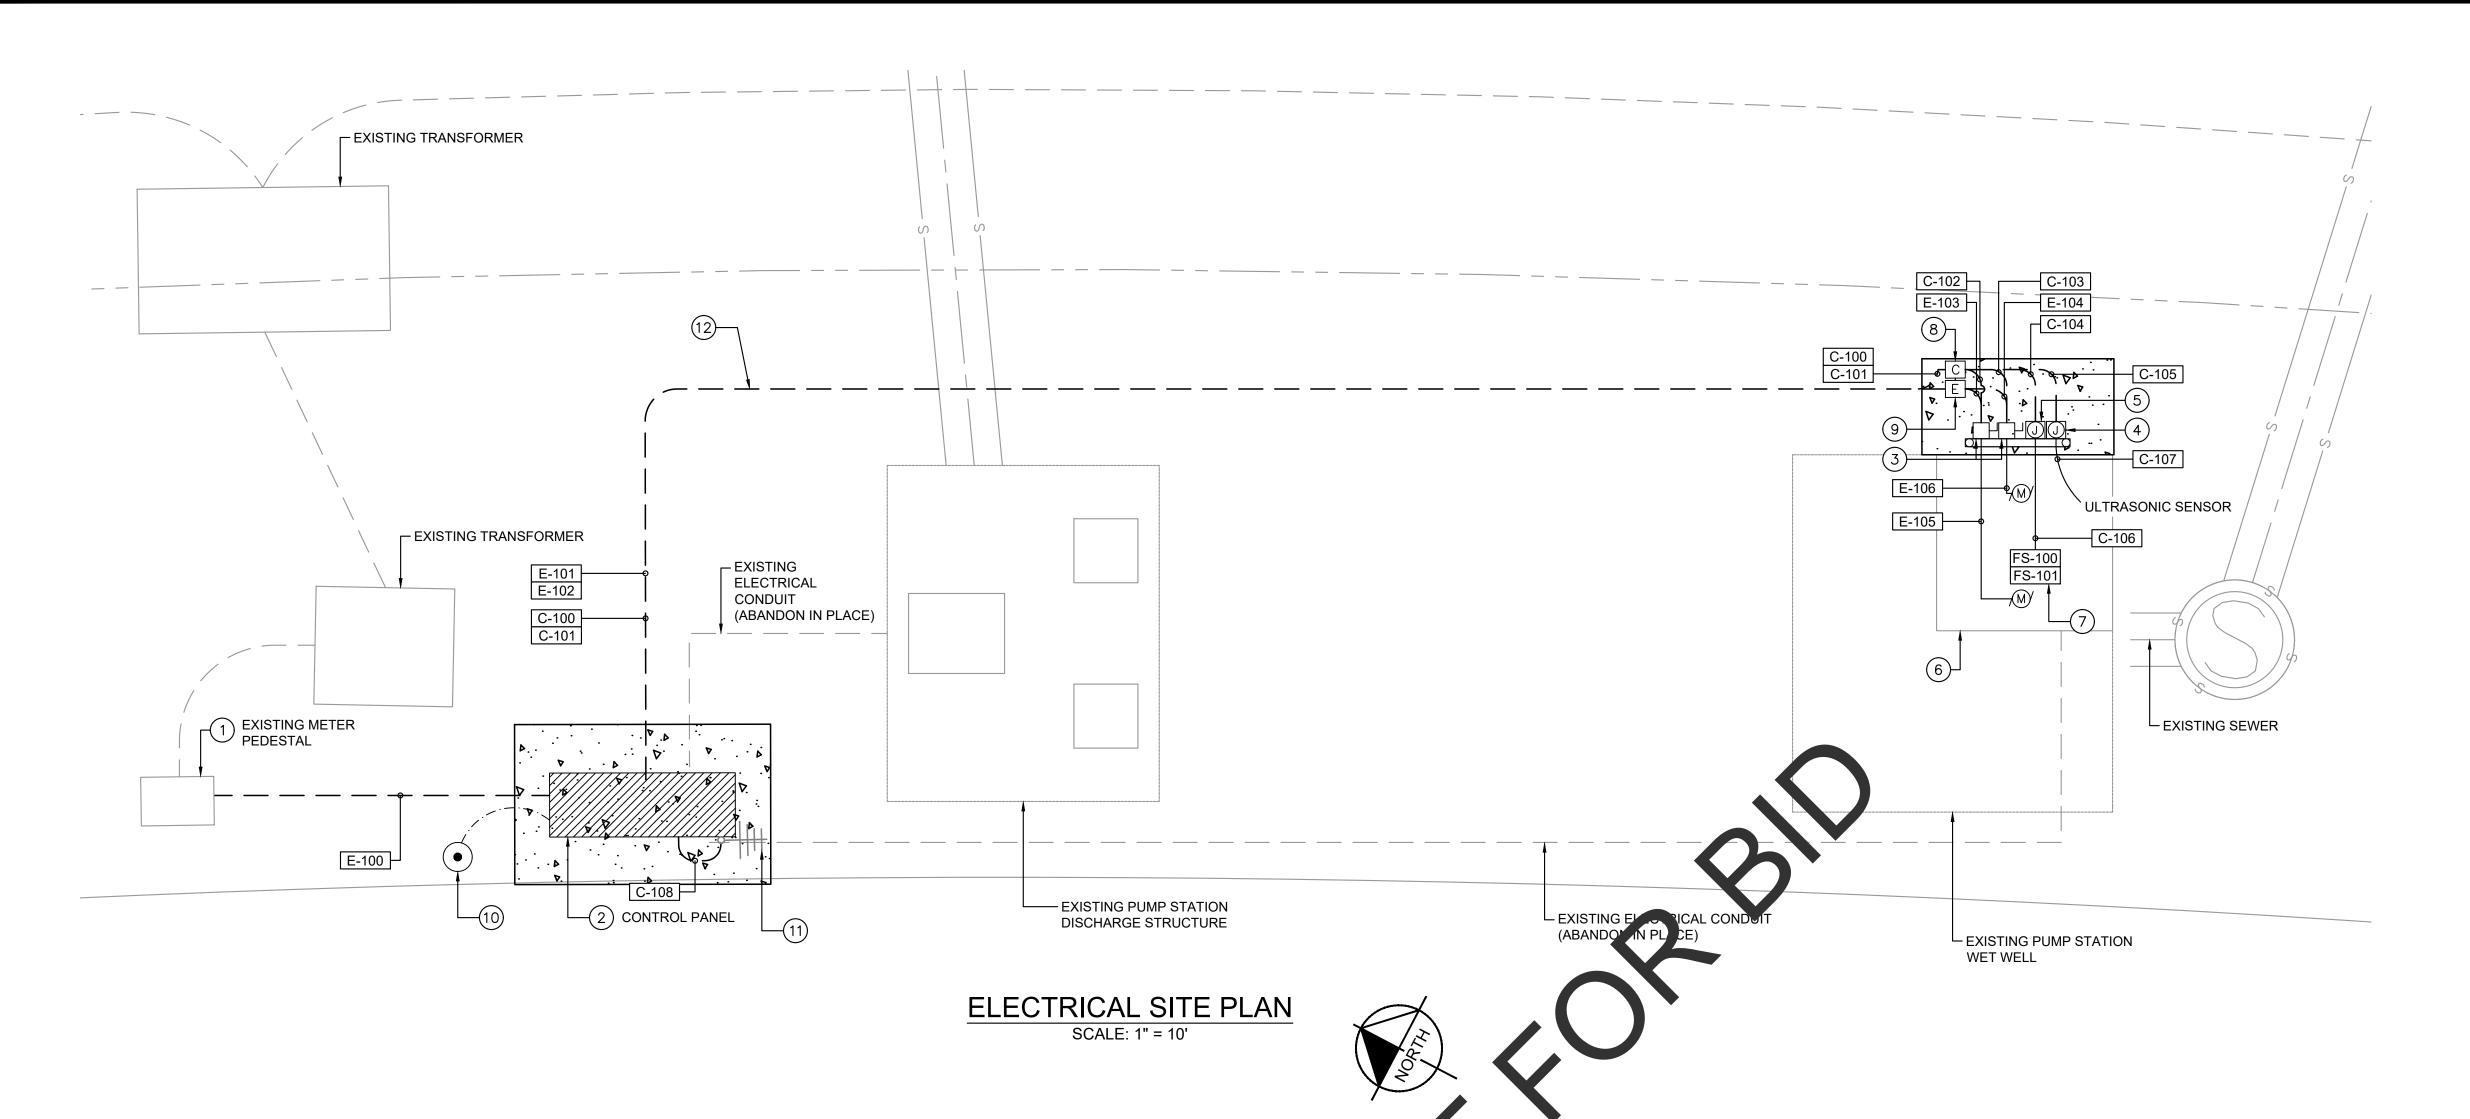

					CONDUIT SCHEDULE LS-A			
CONDUIT TAG	STATUS	CONDUIT TYPE	CONDUIT SIZE	APPROXIMATE CONDUIT LENGTH	FROM	то	CONDUCTOR (EACH CONDUIT)	CONDUCTOR (EACH CONDUIT)
E-100	NEW	UG SCHED 40 PVC	2.5"	14 LF	METER	CONT OL PANEL	(4) #3/0 AWG + (1) #6 GND	POWER
E-101	NEW	UG SCHED 40 PVC	1"	60 LF	CONTROL DANEL	POWER PULLBOX	(3) #10 AWG + (1) #10 GND	PUMP #1 POWER
E-102	NEW	UG SCHED 40 PVC	1"	60 LF	CONTROL PAR TL	POWER PULLBOX	(3) #10 AWG + (1) #10 GND	PUMP #2 POWER
E-103	NEW	UG SCHED 40 PVC/PVC COATED RGS	1"	4 LF	POWER PULLBOX	DISCONNECT #1	(3) #10 AWG + (1) #10 GND	PUMP 1 POWER
E-104	NEW	UG SCHED 40 PVC/PVC COATED RGS	1"	5 LF	POWER PULLBOX	DISCONNECT #2	(3) #10 AWG + (1) #10 GND	PUMP 2 POWER
E-105	NEW	PVC COATED RGS	3"	4 LF	DISCONNECT #1	PUMP #1	MANUFACTURER CABLE	SPLICE COMMS AND POWER AT DISCONNECT
E-106	NEW	PVC COATED RGS	3"	4 LF	DISCONNECT #2	PUMP #2	MANUFACTURER CABLE	SPLICE COMMS AND POWER AT DISCONNECT
C-100	NEW	UG SCHED 40 PVC	2"	60 LF	CONTROL PANEL	COMMUNICATIONS PULLBOX (SECTION 1)	6-PAIR #16 AWG	2 - FLOATS, 2 - LEAKAGE, 2-OVERTEMP SIGNALS
C-101	NEW	UG SCHED 40 PVC	1"	60 LF	CONTROL PANEL	COMMUNICATIONS PULLBOX (SECTION 2)	MANUFACTURER CABLE	ULTRASONIC SIGNAL
C-102	NEW	UG SCHED 40 PVC/PVC COATED RGS	1"	4 LF	COMMUNICATIONS PULLBOX (SECTION 1)	DISCONNECT #1	2-PAIR #16 AWG	PUMP 1 LEAKAGE AND OVERTEMP SIGNALS. SPLICE WITH MANUFACTURER CABLE AT DISCONNECT
C-103	NEW	UG SCHED 40 PVC/PVC COATED RGS	1"	5 LF	COMMUNICATIONS PULLBOX (SECTION 1)	DISCONNECT #2	2-PAIR #16 AWG	PUMP 2 LEAKAGE AND OVERTEMP SIGNALS. SPLICE WITH MANUFACTURER CABLE AT DISCONNECT
C-104	NEW	UG SCHED 40 PVC/PVC COATED RGS	1"	5 LF	COMMUNICATIONS PULLBOX (SECTION 1)	FLOAT J-BOX	2-PAIR #16 AWG	2-FLOAT SIGNALS
C-105	NEW	UG SCHED 40 PVC/PVC COATED RGS	1"	5 LF	COMMUNICATIONS PULLBOX (SECTION 2)	ULTRASONIC SENSOR J-BOX	MANUFACTURER CABLE	ULTRASONIC SIGNAL
C-106	NEW	PVC COATED RGS	3"	5 LF	FLOAT J-BOX	FLOATS	2-PAIR #16 AWG	2-FLOAT SIGNALS
C-107	NEW	PVC COATED RGS	3"	5 LF	ULTRASONIC SENSOR J-BOX	ULTRASONIC SENSOR	MANUFACTURER CABLE	MANUFACTURER CABLE

Know what's below.
Call before you dig.

CONDUIT AND CONDUCTOR SCHEDULE

CONTROL PANEL

PVC COATED RGS

*ELECTRICAL NOTES LISTED ARE APPLICABLE TO THIS SHEET ONLY	
ELECTRICAL NOTES  1 EXISTING 200A, 277/480V, 3P, 4W METER PEDESTAL TO REMAIN. PROTECT IN PLACE. SEE DETAIL D ON SHEET 12 FOR SINGLE LINE DIAGRAM	QUANTITY  1 LS
FURNISH AND INSTALL NEW LIFT STATION CONTROL PANEL. DEMO OF EXISTING LIFT STATION CONTROL PANEL SHOWN ON MECHANICAL PLANS. CONTRACTOR TO LOCATE EXISTING RTU MOUNTED BESIDE EXISTING LIFT STATION CONTROL PANEL AND INSTALL INSIDE OF NEW LIFT STATION CONTROL PANEL ENCLOSURE. SEE DETAIL A ON SHEET 10 FOR CONTROL PANEL ELEVATION DETAIL.	1 LS
FURNISH AND INSTALL 30A, 480V, 3P, NEMA 4X PUMP DISCONNECT WITH INTERNAL TERMINAL BLOCK. CONTRACTOR TO SPLICE MANUFACTURER CABLE IN DISCONNECT ENCLOSURE, AND SEND PUMP SIGNALS TO CONTROL PANEL VIA LOCAL COMMUNICATIONS JUNCTION BOX. REFER TO CONDUIT SCHEDULE FOR ADDITIONAL DETAIL. PROVIDE EYS FITTING AT BASE OF DISCONNECT FOR ALL CONDUITS ENTERING WET WELL.	1 LS
FURNISH AND INSTALL 6" X 6" X 4" ABOVE GRADE NEMA 4X JUNCTION BOX WITH INTERNAL TERMINAL BLOCK FOR ULTRASONIC SENSOR CABLING. BOX TO BE MOUNTED ALONGSIDE OTHER ELECTRICAL ENCLOSURES ON UNISTRUT TYPE RACK. MAKE FINAL CONNECTION TO MANUFACTURER CABLE IN JUNCTION BOX. EXTEND MANUFACTURER CABLE FROM JUNCTION BOX INTO WELL AND HANG EXCESS CABLING FROM 316SS CABLE HANGER. PROVIDE EYS FITTING IN LINE WITH CONDUIT TO WET WELL.	1 LS
FURNISH AND INSTALL 6" X 6" X 4" ABOVE GRADE NEMA 4X JUNCTION BOX WITH INTERNAL TERMINAL BLOCK FOR LEVEL SWITCH CABLING. BOX TO BE MOUNTED ALONGSIDE OTHER ELECTRICAL ENCLOSURES ON UNISTRUT TYPE RACK. MAKE FINAL CONNECTION TO MANUFACTURER CABLE IN JUNCTION BOX. EXTEND MANUFACTURER CABLE FROM JUNCTION BOX INTO WELL AND HANG EXCESS CABLING FROM 316SS CABLE HANGER. PROVIDE EYS FITTING IN LINE WITH CONDUIT TO WET WELL.	1 LS
6 PER NFPA 820 TABLE 4.2.2 ROW A, THE WET WELL IS CLASS 1 DIV 1 GROUP D.	-
7 SEE ELEVATION VIEW FOR LEVEL SWITCH MOUNTING HEIGHTS ON SHEET 6.	_
8 FURNISH AND INSTALL 2'X 1' PULL BOX WITH DIVIDER FOR DIGITAL AND ANALOG COMMUNICATION SIGNALS.	1 LS
9 FURNISH AND INSTALL 2' X 1' ELECTRICAL PULL BOX PER DETAIL G ON SHEET 11.	1 LS
10) FURNISH AND INSTALL 3/4" X 10' GROUND ROD TEST ROD SHOWN IN DETAIL C, SHEET 12.	1 LS
(11) CONTRACTOR TO RE-MOUNT EXISTING ANTENNA TO NEW CONTROL PANEL AND RECONNECT TO NETWORK FOR A COMPLETE WORKING SYSTEM.	1 LS
(12) SEE DETAIL A, SHEET 12 FOR TYPICAL CONDUIT TRENCH DETAIL. SEE CONDUIT AND CONDUCTOR SCHEDULE FOR CONDUIT SIZE AND LENGTH.	1 LS

### **SAN BERNARDINO COUNTY**

**COUNTY SERVICE AREA 64** 

DEPARTMENT OF PUBLIC WORKS - SPECIAL DISTRICTS

PROJECT MANAGEMENT DIVISION

222 W. HOSPITALITY LANE, 2ND FLOOR

SAN BERNARDINO, CA 92415-0763

(909) 386-8800

CONTRACT\_ ACCOUNT\_ DWG. NO. E-02

				DESIGNED BY: EG	SAN BERNARDINO COUNTY	BENCH MARK NO
MARK	DATE	BY	APPROVED/RCE NO.	DATE: 7/12/2023	RECOMMENDED BY:	LOCATION, NI /A
				DRAWN BY: EG		LOCATION: N/A
				DATE: 7/12/2023	NAME, TITLE DATE	
				CHECKED BY: MAC	ACCEPTED BY:	
				DATE: 7/12/2023	NAME, TITLE DATE	—

C-108

NEW

BENCH MARK NO. N/A ELEV. N/A


LMR 400


EXISTING ANTENNA

401 B STREET, SUITE 600, SAN DIEGO, CA 92101 PHONE: (951) 543-9868 WWW.KIMLEY-HORN.COM MICHAEL COLOMBO 19280 7/12/2023 DATE PROJECT ENGINEER R.C.E. ##

LMR400



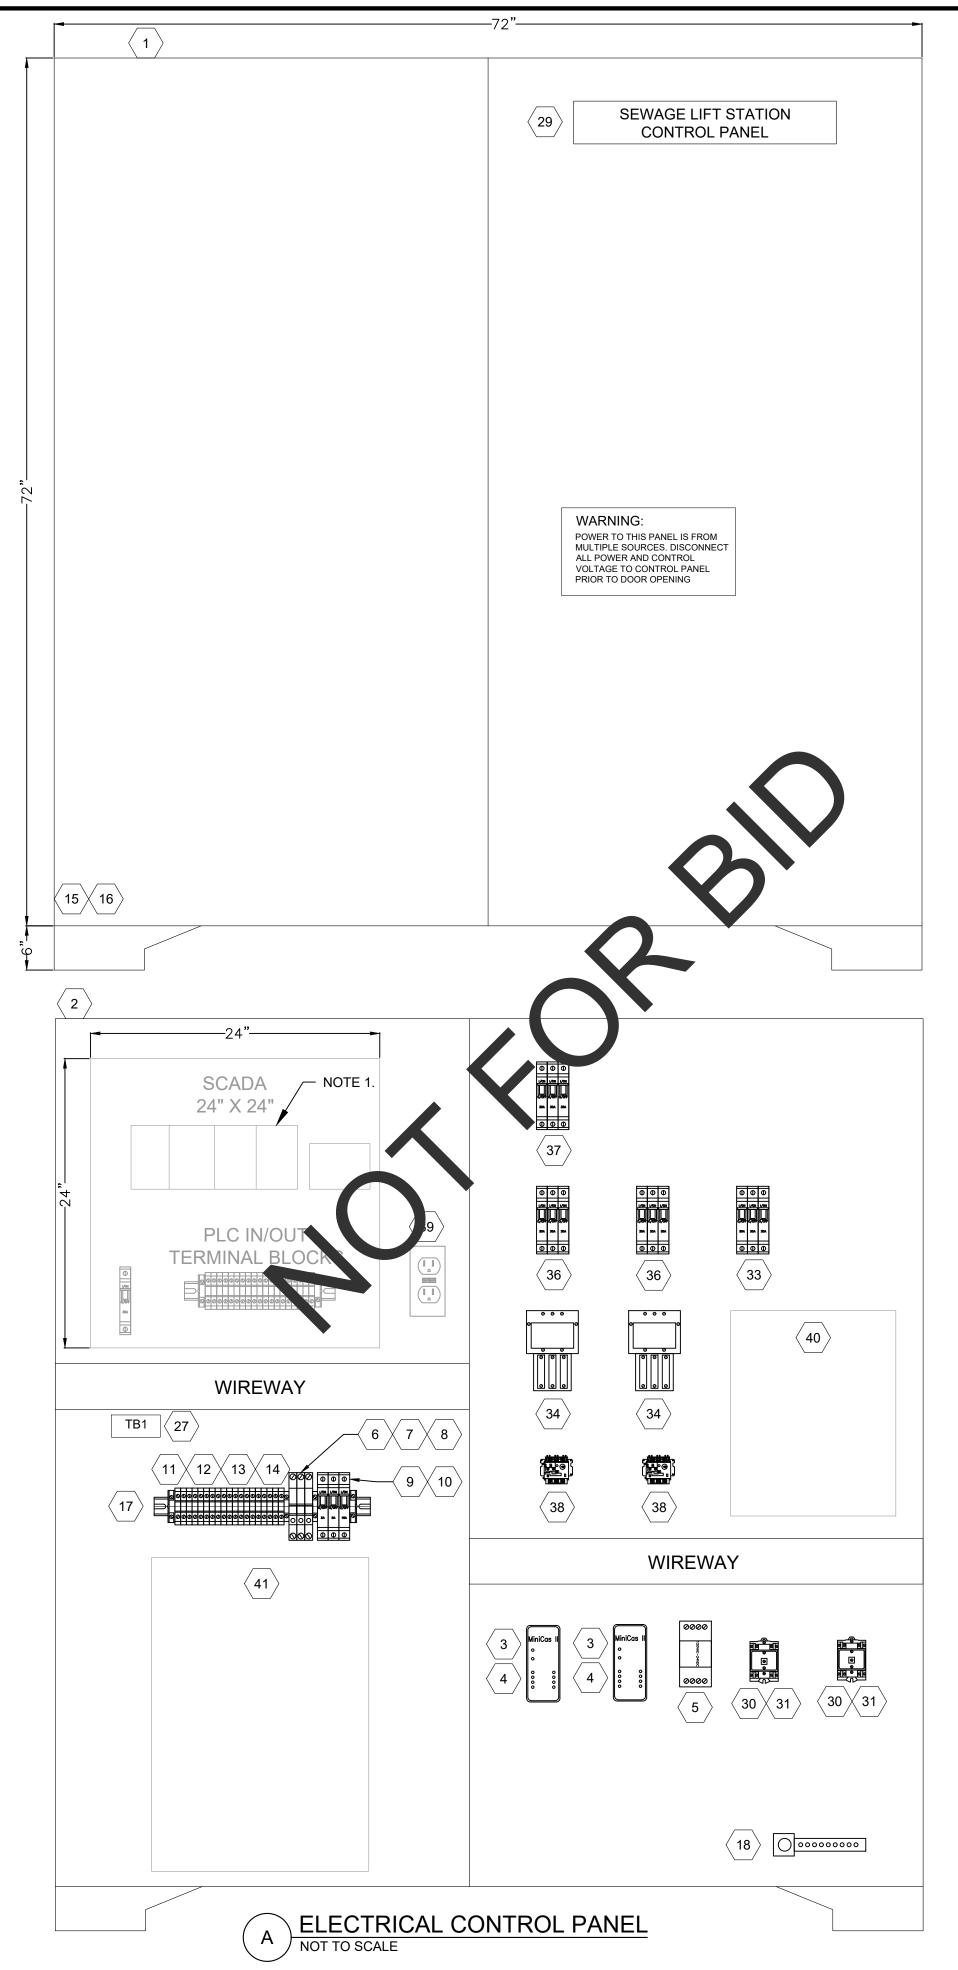

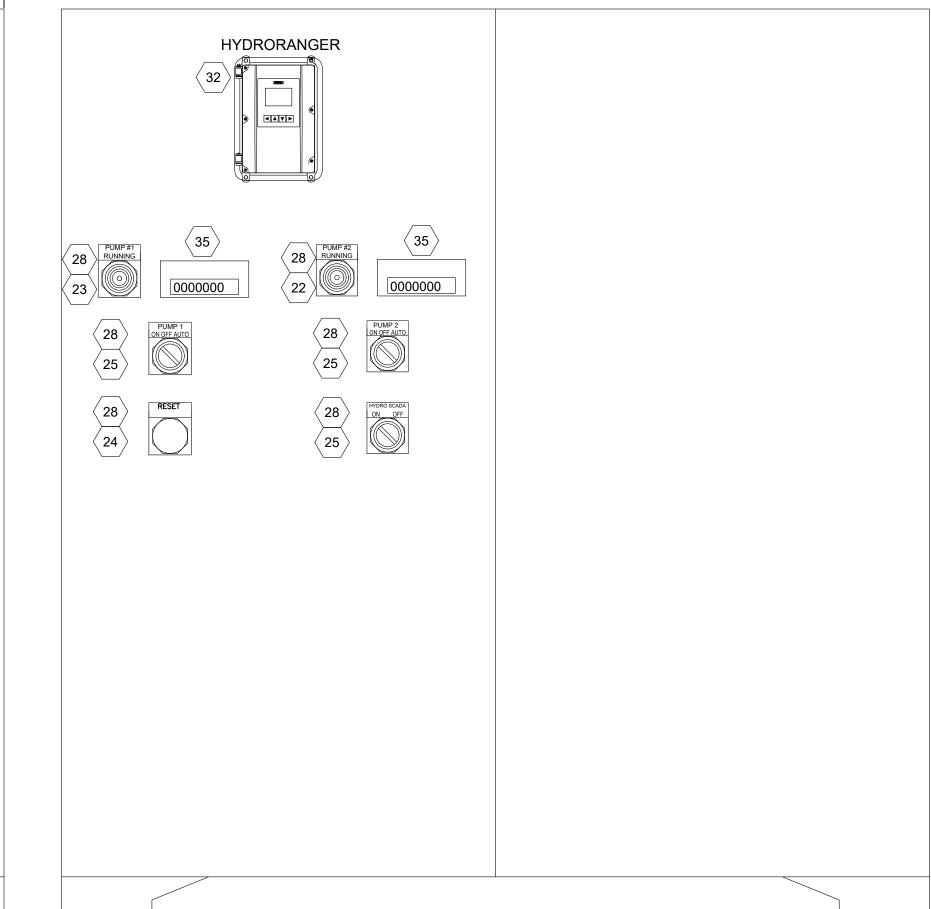

1. EXISTING RTU PANEL TO REMAIN AND BE RE-CONNECTED TO NEW PUMP CONTROLS AND INSTRUMENTATION AS SHOWN. RTU RADIO, PANEL TERMINALS, SURGE PROTECTION, POWER SUPPLY AND BATTERY BACKUP TO BE CONSOLIDATED WITHIN NEW SECTION OF NEW NEW LIFT STATION CONTROL PANEL ENCLOSURE. SEE SHEET E-05 FOR MOUNTING DETAIL. ALL WORK, MATERIALS AND APPURTENANCES SHALL BE CONSIDERED PART OF THE TOTAL COST OF THE CONSTRUCTION BID.

**GENERAL NOTES** 

LOAD CALCULATION	
OAD DESCRIPTION	
PROPOSED LOADS	
10HP PUMP	14.0 AMPS
10HP PUMP	14.0 AMPS
LP-1	4.5 AMPS
25% (PER NEC)	3.5 AMPS
TOTAL LOAD (@480V, 3 PHASE)	36.0 AMPS
TOTAL KVA	30 KVA
SERVICE SIZE	200 AMPS
PERCENT LOADED	18 %

B CONTROL PANEL LOAD SUMMARY
NOT TO SCALE

### **SAN BERNARDINO COUNTY**

COUNTY SERVICE AREA 64
DEPARTMENT OF PUBLIC WORKS - SPECIAL DISTRICTS
PROJECT MANAGEMENT DIVISION
222 W. HOSPITALITY LANE, 2ND FLOOR
SAN BERNARDINO, CA 92415-0763
(909) 386-8800

r, Sa			REVI	ISIONS	DESIGNED BY: EG	SAN BERNARDINO COUNTY		
N Ine	IARK	DATE	BY	APPROVED/RCE NO.	DATE: <u>7/12/2023</u>	- RECOMMENDED BY:	1.7	
Ву: Wue					DRAWN BY: <u>EG</u> DATE: 7/12/2023	NAME, TITLE DATE	-   L(	
Plotted					CHECKED BY: MAC DATE: 7/12/2023	ACCEPTED BY:  NAME, TITLE  DATE	-	

BENCH MARK NO. N/A ELEV. N/A

LOCATION: N/A

Kimley» Horn


401 B STREET, SUITE 600, SAN DIEGO, CA 92101
PHONE: (951) 543-9868 WWW.KIMLEY-HORN.COM


MICHAEL COLOMBO 19280 7/12/2023
PROJECT ENGINEER R.C.E. ## DATE



### **ELECTRICAL CONTROL PANEL**

CONTRACT
CONTRACT
ACCOUNT
DWG. NO. <b>E-02</b>

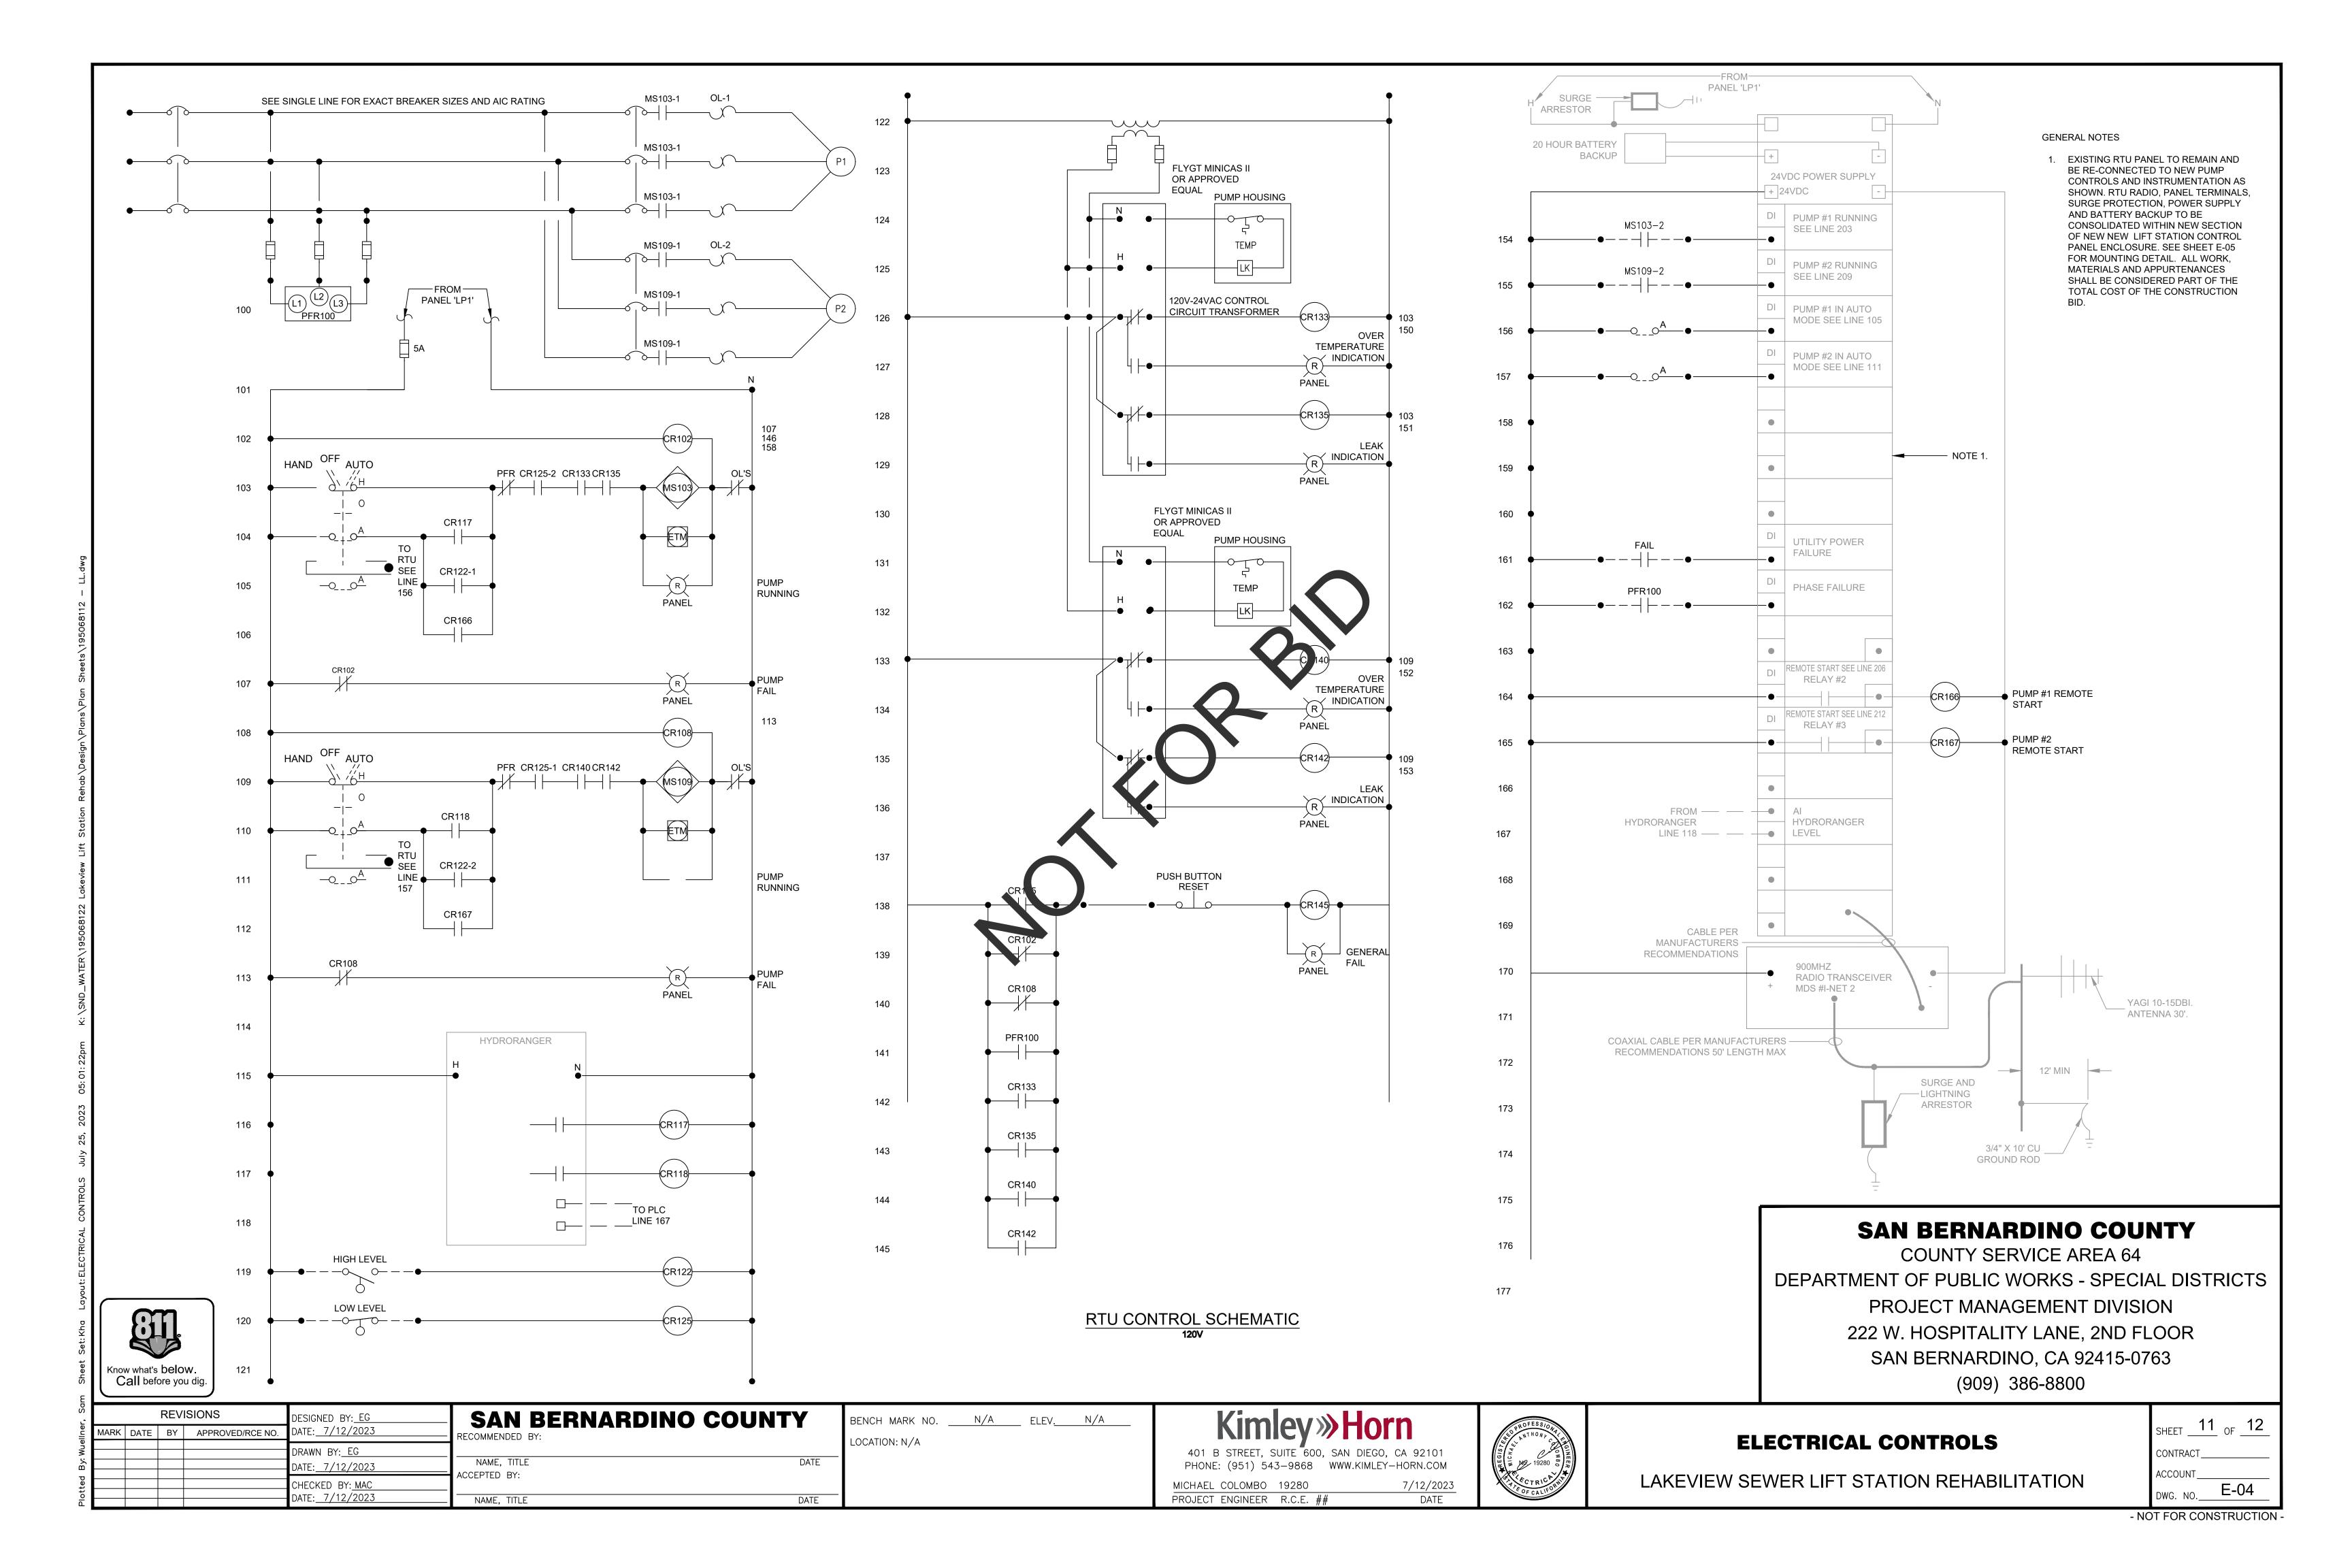

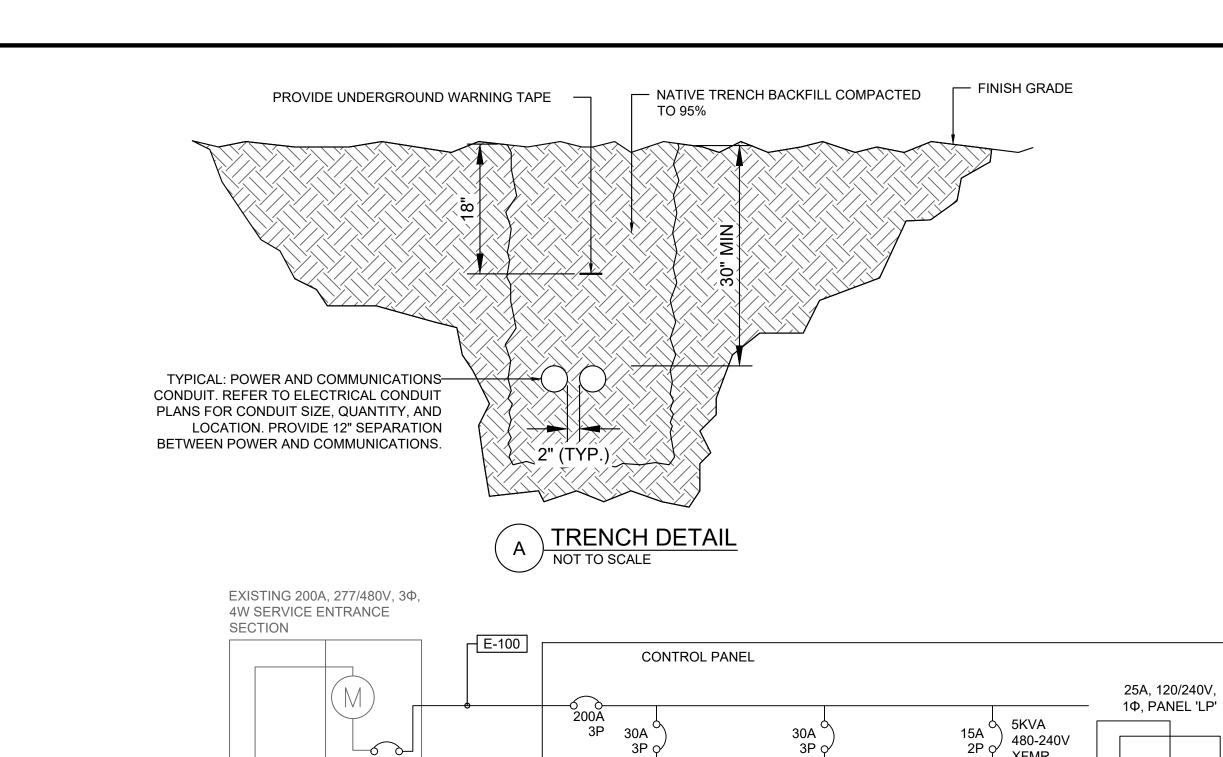

SINGLE LINE DIAGRAM

HOA HUIH

FVNR ⊥ NEMA 3 T

30A, 480V, 3W, 3P,

NEMA 4X PUMP DISCONNECT

TO UTILITY ---

X 3/4" GROUND 7

TRANSFORMER

Know what's **below**. **Call** before you dig.

MS103

HOA MS100

FVNR 🕹

NEMA 3 T

MS109

GND NTRL


E-102 E-104

30A, 480V, 3W, 3P,

NEMA 4X PUMP

DISCONNECT

E-106

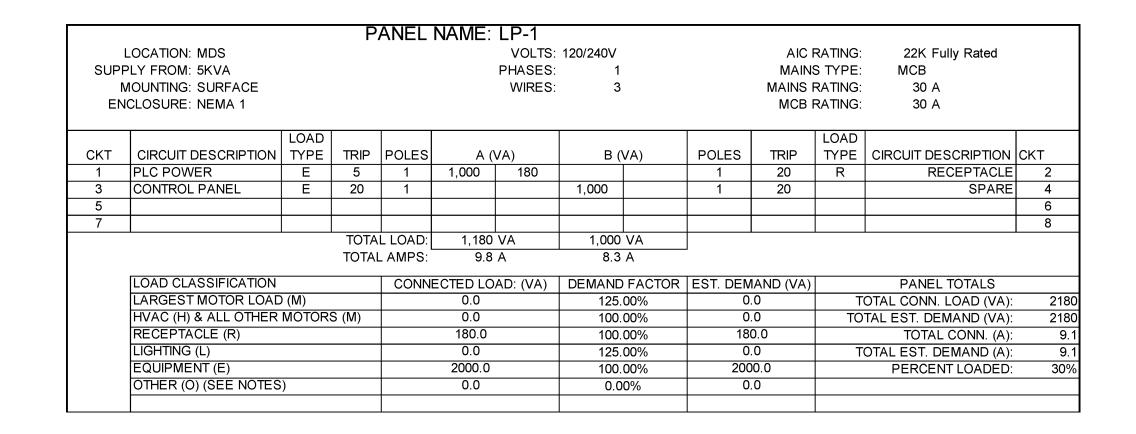

\ 'LP1' PANEL SCHEDULE


TYPE PT

TYPE VS



TYPE GL LUG


TYPE GR

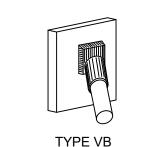


(TOWER GROUNDING TAB)

TYPE VBC


APPROPRIATE TYPES AS REQUIRED.

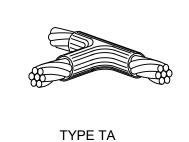

TYPE GT

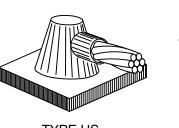


TYPE HA

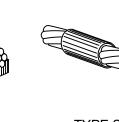

TYPE XA

TYPE SS

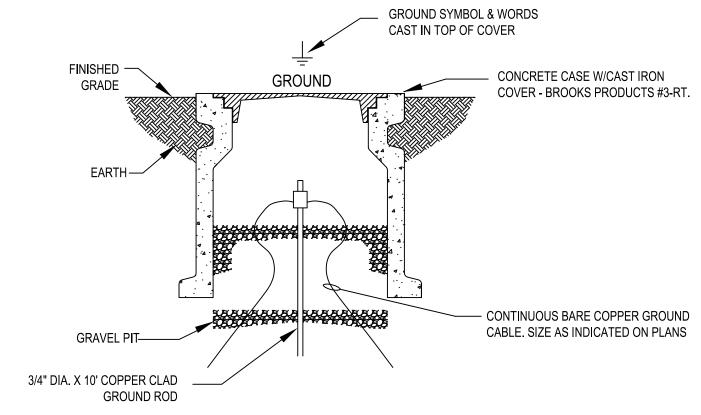

NOTES: 1. CADWELD "TYPES" SHOWN ABOVE ARE EXAMPLES. PROVIDE


**GATES ONLY** 


TYPICAL CAD WELDS NOT TO SCALE

GROUND ROD DETAIL NOT TO SCALE

					CONDUIT SCHEDULE LS-A			
CONDUIT TAG	STATUS	CONDUIT TYPE	CONDUIT SIZE	APPROXIMATE CONDUIT LENGTH	FROM	то	CONDUCTOR (EACH CONDUIT)	CONDUCTOR (EACH CONDUIT)
E-100	NEW	UG SCHED 40 PVC	2.5"	14 LF	METER	CONTROL PANEL	(4) #3/0 AWG + (1) #6 GND	POWER
E-101	NEW	UG SCL 3D 40 PVC	1"	60 LF	CONTROL PANEL	POWER PULLBOX	(3) #10 AWG + (1) #10 GND	PUMP #1 POWER
E-102	NEW	IG SCHF → 40 PVC	1"	60 LF	CONTROL PANEL	POWER PULLBOX	(3) #10 AWG + (1) #10 GND	PUMP #2 POWER
E-103	NW	IG SCLED 40 PVC/PVC COATED RGS	1"	4 LF	POWER PULLBOX	DISCONNECT #1	(3) #10 AWG + (1) #10 GND	PUMP 1 POWER
E-104	NE	UG SCHED 40 PVC/PVC COATED RGS	1"	5 LF	POWER PULLBOX	DISCONNECT #2	(3) #10 AWG + (1) #10 GND	PUMP 2 POWER
E-105	NEW	PVC COATED RGS	3"	4 LF	DISCONNECT #1	PUMP #1	MANUFACTURER CABLE	SPLICE COMMS AND POWER AT DISCONNECT
E-106	IVÉW	PVC COATED RGS	3"	4 LF	DISCONNECT #2	PUMP #2	MANUFACTURER CABLE	SPLICE COMMS AND POWER AT DISCONNECT
C-100	NEW	UG SCHED 40 PVC	2"	60 LF	CONTROL PANEL	COMMUNICATIONS PULLBOX (SECTION 1)	6-PAIR #16 AWG	2 - FLOATS, 2 - LEAKAGE, 2-OVERTEMP SIGNALS
01	NEW	UG SCHED 40 PVC	1"	60 LF	CONTROL PANEL	COMMUNICATIONS PULLBOX (SECTION 2)	MANUFACTURER CABLE	ULTRASONIC SIGNAL
C-102	NEW	UG SCHED 40 PVC/PVC COATED RGS	1"	4 LF	COMMUNICATIONS PULLBOX (SECTION 1)	DISCONNECT #1	2-PAIR #16 AWG	PUMP 1 LEAKAGE AND OVERTEMP SIGNALS. SPLICE WITH MANUFACTURER CABLE AT DISCONNECT
C-103	NEW	UG SCHED 40 PVC/PVC COATED RGS	1"	5 LF	COMMUNICATIONS PULLBOX (SECTION 1)	DISCONNECT #2	2-PAIR #16 AWG	PUMP 2 LEAKAGE AND OVERTEMP SIGNALS. SPLICE WITH MANUFACTURER CABLE AT DISCONNECT
C-104	NEW	UG SCHED 40 PVC/PVC COATED RGS	1"	5 LF	COMMUNICATIONS PULLBOX (SECTION 1)	FLOAT J-BOX	2-PAIR #16 AWG	2-FLOAT SIGNALS
C-105	NEW	UG SCHED 40 PVC/PVC COATED RGS	1"	5 LF	COMMUNICATIONS PULLBOX (SECTION 2)	ULTRASONIC SENSOR J-BOX	MANUFACTURER CABLE	ULTRASONIC SIGNAL
C-106	NEW	PVC COATED RGS	3"	5 LF	FLOAT J-BOX	FLOATS	2-PAIR #16 AWG	2-FLOAT SIGNALS
C-107	NEW	PVC COATED RGS	3"	5 LF	ULTRASONIC SENSOR J-BOX	ULTRASONIC SENSOR	MANUFACTURER CABLE	MANUFACTURER CABLE
C-108	NEW	PVC COATED RGS	1"	4 LF	CONTROL PANEL	EXISTING ANTENNA	LMR 400	LMR400

### CONDUIT AND CONDUCTOR SCHEDULE NOT TO SCALE

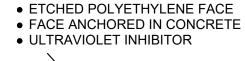

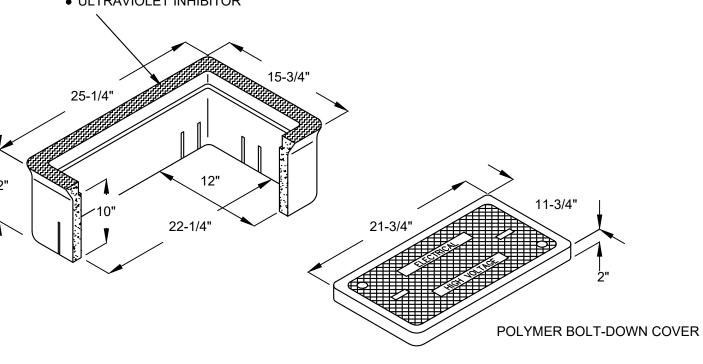

G PULL BOX DETAIL

NOT TO SCALE


### **SAN BERNARDINO COUNTY**

**COUNTY SERVICE AREA 64** DEPARTMENT OF PUBLIC WORKS - SPECIAL DISTRICTS PROJECT MANAGEMENT DIVISION 222 W. HOSPITALITY LANE, 2ND FLOOR SAN BERNARDINO, CA 92415-0763 (909) 386-8800

		DESIGNED BY: EG	SAN BERNARDINO COUNT	Y
MARK DATE	BY APPROVED/RCE NO.	DATE: 7/12/2023	RECOMMENDED BY:	•
		DRAWN BY: <u>EG</u> DATE: 7/12/2023	NAME, TITLE	DATE
		CHECKED BY: MAC DATE: 7/12/2023	ACCEPTED BY:  NAME, TITLE	DATE

N/A ELEV. N/A BENCH MARK NO. LOCATION: N/A

401 B STREET, SUITE 600, SAN DIEGO, CA 92101 PHONE: (951) 543-9868 WWW.KIMLEY-HORN.COM MICHAEL COLOMBO 19280 7/12/2023 PROJECT ENGINEER R.C.E. ##

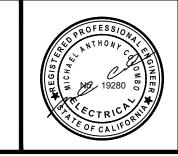

### **ELECTRICAL DETAILS**

	SHEET 12 OF 12
	CONTRACT
	ACCOUNT
	DWG. NO. <b>E-05</b>
NOT FOR CONSTRUCTION	