SAN BERNARDINO COUNTY LAKE GREGORY REGIONAL PARK SAN MORITZ - PREFAB RESTROOM

PROJECT # 10.10.1398 24746 SAN MORITZ WAY CRESTLINE, CA 92335

- GENERAL CONTRACTOR SHALL PROVIDE SECURITY/TEMPORATY FENCING FOR DURATION OF THE PROJECT AS REQUIRED AT NO ADDITIONAL COST TO OWNER,
- GENERAL CONTRACTOR SHALL PROVIDE AND PAY FOR ANY REQUIRED SURVEY WORK BY A LICENSED CALIFORNIA SURVEYOR.
- PREFABRICATED RESTROOM BUILDING. CONTRACTOR SHALL PERFORM THE FOLLOWING FOR BOTH SITES:
 - PREPARE THE SITE / BUILDING PAD TO ACCEPT THE BUILDING PER CIVIL DRAWING.
 - COORDINATE WITH OWNER & MANUFACTURER FOR ACCEPTANCE OF BUILDING, INCLUDING OFF-LAODING &
- PROVIDE ALL UTILITY CONNECTIONS AS REQUIRED (WATER, SEWER & ELECTRICAL) PER REFERENCE DRAWINGS.
- THE GENERAL BULDING CONTRACTOR SHALL SUBMIT TO THE COUNTY OF SAN BERNARDIND DEPARTMENT OF BUILDING AND SAFETY THE FOLLOWING DOCUMENTS FOR REVIEW AND APPROVAL PRIOR TO OBTAINING BUILDING PERMIT:

A, DEFERRED SUBMITTAL / SEPARATE PERMITS

BUILDING PLACEMENT.

THE FOLLOWING ARE UNDER DEFERRED SUBMITTAL/SEPARATE PERMITS (TO BE OBTAINED BY THE GENERAL CONTRACTOR):

I. PREFABRICATED RESTROOM BUILDING

SLEMITTAL DOCUMENTS (PLANS & CALCULATIONS) FOR DEFERRED ITEMS SHALL BE SUBMITTED TO THE ARCHITECT OR ENSINEER OF RECORD, WHO SHALL REVIEW THEM AND FORWARD THEM TO THE BUILDING OFFICIAL WITH A NOTATION INDICATING THAT THE DEFERRED DOCUMENTS HAVE BEEN REVIEWED AND THAT THEY HAVE BEEN FOUND TO BE IN GENERAL CONFORMANCE WITH THE DESIGN OF THE STRUCTURE. THE DEFERRED ITEMS SHALL NOT BE INSTALLED UNTIL THEIR DESIGN AND SUBMITTAL DOCUMENTS HAVE BEEN APPROVED BY THE BUILDING OFFICIAL.

- 5. THERE ARE NO AS BUILT PLANS FOR UNDERGROUND UTILITIES AND IRRIGATION AVAILABLE, CONTRACTOR SHALL TAKE SPECIAL. CARE TO LOCATE ALL UNDERGROUND UTILITIES AND REIGATION LINES TO AVOID DAWAGE PRIOR TO EXCAVATION CONTRACTOR SHALL REPAIR, RELOCATE, AND OR RE-ROUTE ANY UTILITIES AND OR REROUTED TO THE REPAIR AND THE PAIR AND THE PAI CONFLICT WITH THE NEW CONSTRUCTION AT NO ADDED COST TO OWNER TO PROVIDE A FULLY FUNCTIONAL SYSTEM.
- 6. THE GENERAL CONTRACTOR SHALL BE RESPONSILE FOR OBTAINING ENCROACHMENT FERMIT(S) FOR ALL WORK THAT OCCURS IN THE PLEBLIC RIGHT OF WAY, GC SHALL PAY PERMIT FEES AND PROVIDE ALL REQUIRED DOCUMENTS INCLUDING A TRAFFIC CONTROL PLAN ETC. AS REQUIRED BY COLINTY TRANSPORTATION.



VICINITY MAP

ASSESSOR'S PARCEL NUMBERS:

LIST OF APPLICABLE CODES

ALL WORK SHALL COMPLY WITH CURRENTLY ADOPTED: 2022 CALIFORNA BUILDING CODE (CBC), PART 2, TITLE 24 C.C.R., (2021 INTERNATIONAL BUILDING CODE)

2022 CALIFORNIA ELECTRICAL CODE (CEC), PART 3, TITLE 24 C.C.R. (2021 NATIONAL ELECTRICAL CODE)

2022 CALFORNA MECHANICAL CODE (CMC) PART 4, TITLE 24 C.C.R. (2021 LINFORM MECHANICAL CODE)

2022 CALIFORNA PLUMBING CODE (CPC), PART 5, TITLE 24 C.C.R. (2021 LINFORM PLUMBING CODE)

2022 CALIFORNIA OPERN BLILDING STANDARDS CODE

2022 CALIFORNIA ENERGY CODE

AMERICANS WITH DISABILITIES ACT 1990 WITH 2010 ADA STANDARDS FOR ACCESSIBLE DESIGN AND 2010 REVISIONS TO TITLE II

SHEET INDEX

TIJ - TITLE SHEET

CLI - PRECISE GRADING PLAN Cl2 - UTILITY PLAN

CL3 - DETAILS AND NOTES - EROSION CONTROL

ARCHITECTURAL

AOJ - UTILITY PLAN - SCE

ALI - SITE PLANS AND SITE DETAILS A2.0 - PREFABRICATED RESTROOM BUILDING

A2.I - PREFABRICATED RESTROOM BUILDING

ELECTRICAL

EO.I - ELECTRICAL LEGENDS AND NOTES

EO.2 - SINGLE LINE DIAGRAM ELI - ELECTRICAL SITE PLAN E3,I - ELECTRICAL DETAILS

PROJECT ADMINISTERED BY

SAN BERNARDING COUNTY DEPARTMENT -PROJECT MANAGEMENT DIVISION

385 N. ARROWHEAD AVE. SAN BERNARDINO, CA 9246

LAKE GREGORY **REGIONAL PARK** SAN MORITZ PREFAR RESTROOM

PROJECT #IOJOJ398

APN #: 0337-202-07

PROVIDE A PREFABRICATED ACCESSIBLE RESTROOM WITH AN ACCESSIBLE CONCRETE WALKWAY AROUND BUILDING,

DESCRIPTION	OF WORK / SCOPE	

<u>OWNER</u>

SAN BERNARDINO COUNTY REAL ESTATE SERVICES DEPARTMENT PROJECT DEVELOPMENT DIVISION GLORIA LOOFBOURROW, PROJECT MANAGER 385 N. ARROWLEAD AVE., THIRD FLOOR SAN BERNARDINO, CA 92415 PHONE: (909) 387-5000

ARCHITECTURAL

STK ARCHITECTURE, INC. STIK ARCHITECTURE, INC. TONY FINALDI, ARCHITECT 42095 ZEVO DR., SUITE AIS TEMECULA, CA 92590 PHONE: (951) 296-9110 FAX: (951) 296-6079

CIVIL ENGINEER

ERSC INC. MATT BRUDIN 1861 W. REDLANDS BLVD. REDLANDS, CA 92373 PHONE: (909) 890-1255

ELECT./PLUMBING ENGINEER

DESIGN WEST ENGINEERING ADRAIN JACQUEZ 1845 BUSINESS CENTER DR., SUITE 215. SAN BERNARDING CA 92408 PHONE: (909) 890-3700 FAX: (909) 890-3770

DATE: INFORMATION: 10-17-23 D.D. PROGRESS 12-08-23 01-23-24

ISSUE INFORMATION:

SHEET INFORMATION:

STK PROJECT NO.874-178-23 SCALE: DECEMBER 2023 DATE: PLOT DATE:






TITLE SHEET

T1.1

NOTES TO GENERAL CONTRACTOR **LOCATION MAP** CODE ANALYSIS PROJECT TEAM

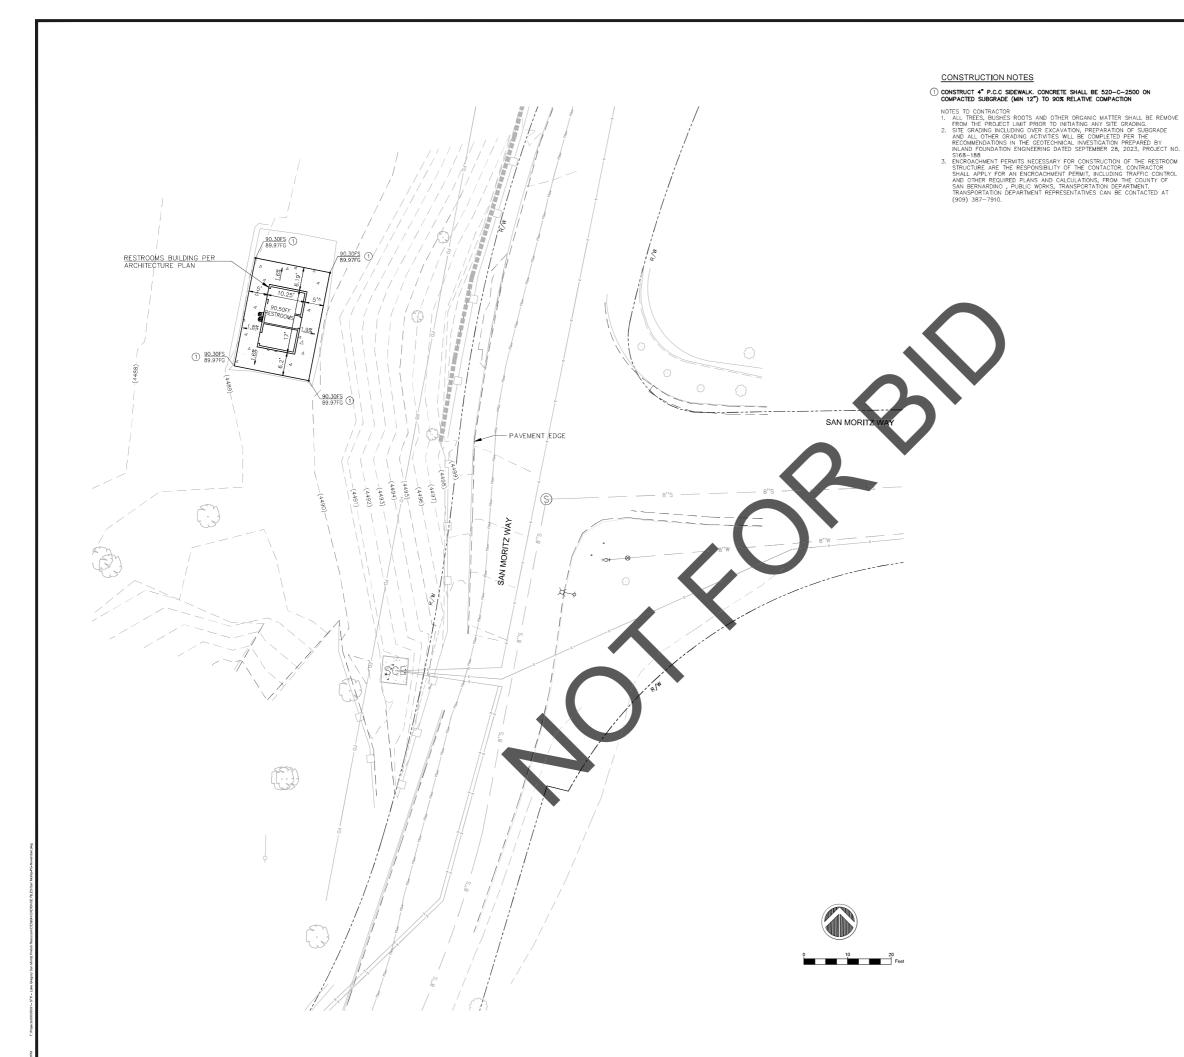

QUANTITIES

420.9 SF

LEGEND

AC CONC. CATV SCE TR GAS

GAS VALVE

CONCRETE SURFACE

--- -8"S --- EX 8" SEWER O SEWER CLEAN OUT ----E--- EDISON ELECTRIC F0-SPECTRUM

SIGNAL POLE > STREET LIGHT TREE - - EDGE OF PAVEMENT

1861 W. Redlands Blvd, Bldg 7B Redlands, Ca. 92373 P: (909) 890-1255 F: (909) 890-0995

SAN BERNARDINO COUNTY REAL ESTATE SERVICES DEPARTMENT -PROJECT MANAGEMENT DIVISION

LAKE GREGORY **REGIONAL PARK** SAN MORITZ PREFAB RESTROOM

PROJECT #10.10.1398

APN # 0337-202-07

24746 SAN MORITZ WAY CRESTLINE, CA 92325

10-02-2023 50%-DESIGN DEVELOPMENT 12-18-23 CD's 01-23-24 BID


SHEET INFORMATION:

STK PROJECT NO.: 374-178-23 SCALE: DATE: I PLOT DATE: DRAWING NAME: DECEMBER 2023



GRADING

C1.1

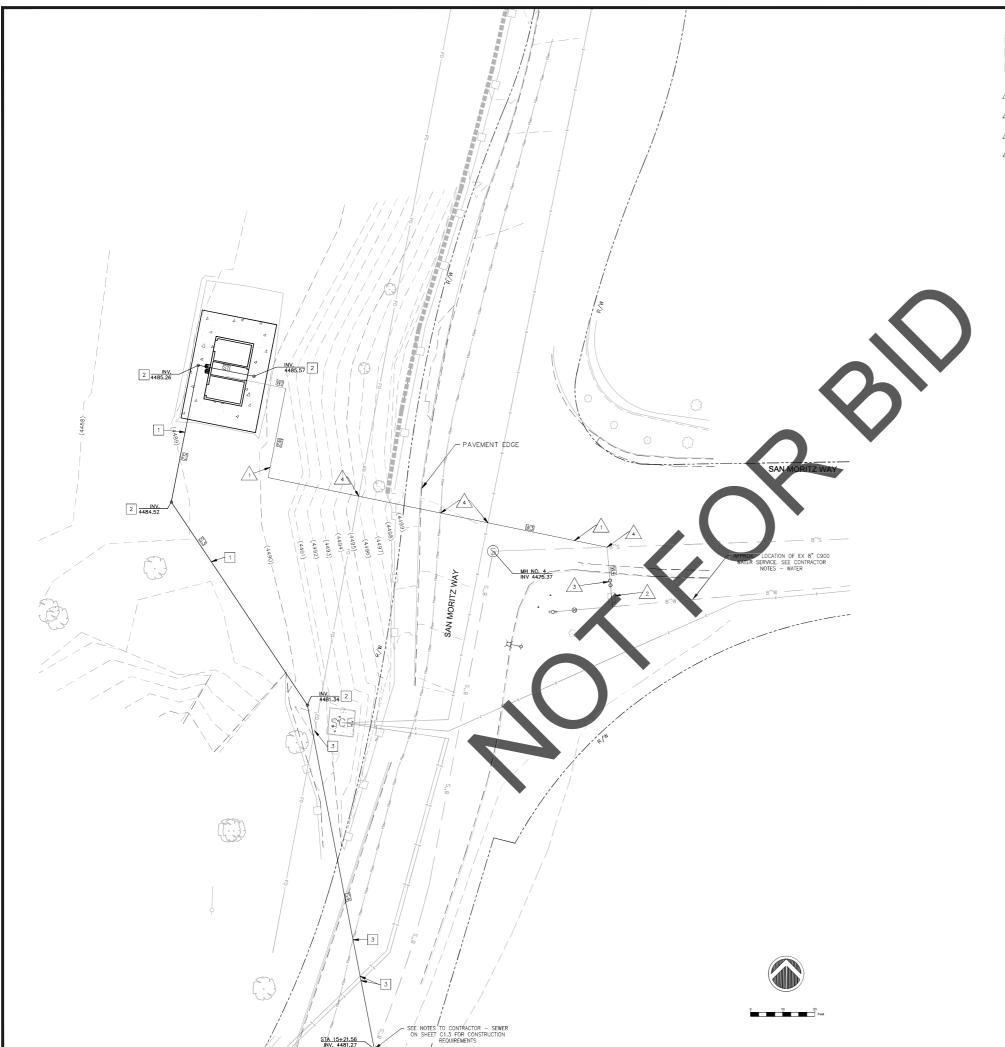


	SEWER CONSTRUCTION NOTES	QUANTITIES
1	4" LATERALS. SDR 26 PVC PIPE PER ASTM STANDARD DWG 303D	211.4 LF
2	4" SEWER CLEAN OUT PER APWA STANDARD DWG 204-3. SEE DETAIL 1 SHEET C1.3	4 EA
3	POTHOLE EXISTING UTILITY. SEE NOTES TO CONTRACTOR HEREON	4 EA
	WATER CONSTRUCTION NOTES	
$\sqrt{1}$	1-1/2" SCHEDULE 40 PVC PIPE	145.6 LF
2	1" WATER SERVICE PER DETAIL 2, SHEET C1.3	1 EA
<u>_3</u>	1" REDUCED PRESSURE PRINCIPAL BACKFLOW DEVICE PER DETAIL 3, SHEET C1.3	1 EA
$\sqrt{4}$	POTHOLE EXISITING UTILITY. SEE NOTES TO CONTRACTOR HEREON	4 EA
	NOTES TO CONTRACTOR 1. THE EXISTING UTILITIES SHOWN ON THIS PLAN ARE PLOTTED BASED ON	THE BEST AVAILA

THE EXISTING UTILITIES SHOWN ON THIS PLAN ARE PLOTTED BASED ON THE BEST AVAILABLE UTILITY RECORDS. AT ALL LOCATIONS WHERE PROPOSED UTILITIES CROSS EXISTING UTILITY RECORDS. AT ALL LOCATIONS WHERE PROPOSED UTILITIES CROSS EXISTING UTILITY PRIOR TO INITIATING THE INSTALLATION OF THE PROPOSED UTILITIES. POTHOLE DATA SHALL INCLUDE THE HORIZONTAL AND VERTICAL LOCATION OF THE UTILITY, THE SIZE OF THE UTILITY AND MATERIAL TYPE. IF A CONFICIO EXISTS, THE CONTRACT SHALL NOTIFY THE ENGINEER OF RECORD AND PROVIDE THE FIELD DATA FOR REVIEW. THE CONTRACTOR SHALL ALLOW IN OWORKING DAYS FOR THE ENGINEER OF RECORD TO MAKE AND NECESSARY ADJUSTMENTS TO THE DESIGN

- ALL SERVICE PIPING IN THE PUBLIC RIGHT OF WAY SHALL HAVE UNDERGROUND UTILITY MARKING TAPE, REEF INDUSTRIES, TERRA TAPE, SAFETY BLUE OR APPROVED EQUIL. TAPE SHALL BE LOCATED 1' ABOVE SERVICE PIPING.

LEGEND
POWER POLE GUY WIRE ROAD OR TRAIL 8"W EX WATER PROP WATER
FIRE HYDRANT UTILITY BOX AR VALVE
WATER METER ⊗ WATER VALVE S IRRIGATION VALVE ——————— FENCE LINE
a SIGN AC ASPHALT CONC. CONCRETE CATV CABLE TV
SCE EDISON PULL BOX TR TRAFFIC GAS GAS VALVE J SIGNAL POLE
STREET LIGHT
TREE — — EDGE OF PAVEMENT
CONCRETE SURFACE
o SEWER CLEAN OUT
SEWER FORCE MAIN E——EDISON ELECTRIC
F0 SPECTRUM

LINE LENGTHS				
SEWER		WATER		
L I NE#	LENGTH	SLOPE	LINE#	LENGTH
S1	15.2	2.0%	W1	16.2
S4	37.3	2.0%	W2	24.3'
S3	65,3'	2.0%	W3	92.4
S4	93.6'	2.0%	W4	15.9

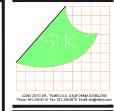

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SAN BERNARDINO COUNTY
REAL ESTATE SERVICES
DEPARTMENT PROJECT MANAGEMENT
DIVISION

LAKE GREGORY REGIONAL PARK SAN MORITZ PREFAB RESTROOM

PROJECT #10.10.1398

APN # 0337-202-07

24746 SAN MORITZ WAY CRESTLINE, CA 92325


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10-02-2023	50%-DESIGN DEVELOPME	
12-18-23	CD's	
01-23-24	BID	

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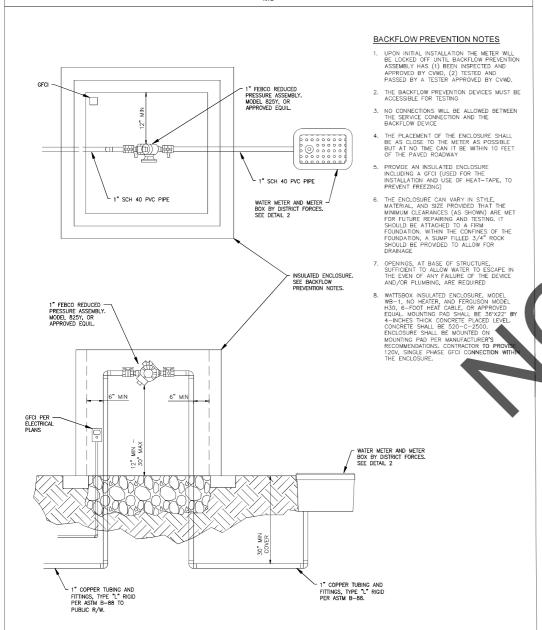


UTILITIES


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C1.2

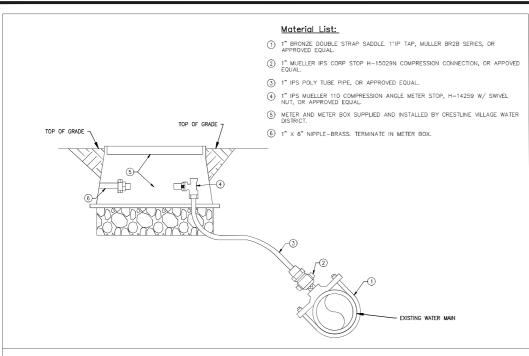


DETAIL 2: WATER METER AND METER BOX



DETAIL 3: BACKFLOW PREVENTION

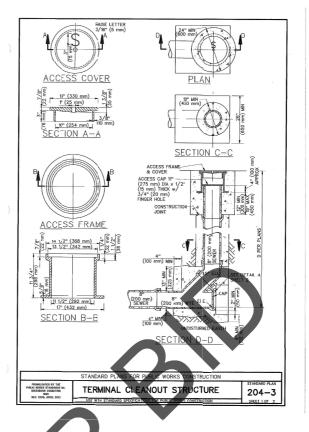

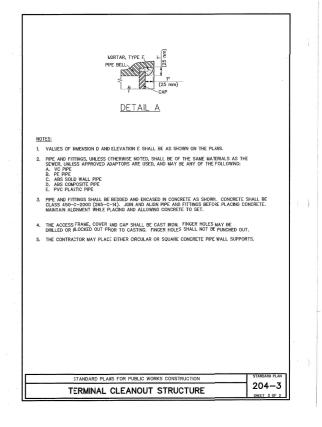

SPECIFICATIONS - CRESTLINE SANITATION DISCTRICT

MATERIALS: SEWER LINES MAY BE CONSTRUCTED WITH ANY OF THE FOLLOWING MATERIALS AS LISTED IN OSD STANDARDS FOR SANITARY SEWERS."

EXTRA STRENGTH CLAY SEWER PIPE WITH REXIBLE COMPRESSION JOINTS OR MOLDED RUBBER COLDING JOINT. CAST IRON PIPE WITH APPROVED FLAVALE COMPRESSION

PLASTIC PIPE: ABS DWV SCHEDULE 40 ASTMF628 RVC SEWER PIPE, SDR 26 AND 35, COMPLYING MITH ASTM STANDARDS 3034

NSTALLATION ALL PIPING SHALL BE LAID ON A FIRM BED ITS ENTIRE ENGTH. OF MAYATE PROPERTY, NORMETALLIC PIPE SHALL BE BURIED IN LESS HANN TWELVE (12) INCHES BELOW FINISHED GRADE. IN ANY SUN BESKARDING COUNTY RODA RIGHT OF WAY, MINIMUM COVERAGE IS THING GO) INCHES. CONNECTIONS BETWEEN DIFFERENT MATERIALS AND PRACTISE ALLIENMENT AND A SLOPE OF NOT LESS THAN ONE QUARTER (1/4) OF KAN NOTE PEOPLY AND A SLOPE OF NOT LESS THAN ONE QUARTER FOOT IS HALL BE MAINTAINED THROUGHOUT THE ENTIRE RUN, WITH THE EXCEPTION: ONE EIGHTH (1/8) OF AN INCH PER FOOT IS PLAY LARGER IN DIMMETER WHERE IT IS IMPRACTICAL DUE TO THE DEPTH OF THE STRUCT MAJETER WHERE IT IS IMPRACTICAL DUE TO THE DEPTH OF THE STRUCT MAJETER WHERE IT IS IMPRACTICAL DUE TO THE DEPTH OF THE STRUCT MAJETER WHERE IT IS IMPRACTICAL DUE TO THE DEPTH OF THE STRUCT SEWER, TO THE STRUCTURAL FEATURES, OR TO THE ARRANGEMENT OF A BUILDING OR STRUCTURE.

CLEANOUTS: A CLEANOUT FITTING (PREFERABLE A TWO—WAY TEE) MUST BE PROVIDED AT THE UPPER AND LOWER TERMINAL OF ALL BUILDING SEWERS. CLEANOUTS MUST BE BROUGHT TO FINISHED GRADE* WITH CAST IRON TWELVE (12) INCH MINIMUM SECTION OR MADE ACCESSIBLE BY ACCEPTABLE YARD BOXES. WHEN INSTALLING YARD BOXES A ½"X IS "PIECE OF REBAR INSTALLED HORIZONTALLY WILL BE BURIED SIX (6) INCHES DEEP BELOW THE YARD BOX. THIS MARKER WILL ACT AS A TARGET FOR MAGNETIC LOCATIONS. ADDITIONAL CLEANOUTS SHALL BE INSTALLED AT INTERVALS NOT TO EXCEED ONE HUNDRED (100) FEET IN STRAIGHT RUNS, AND FOR EACH AGGREGATE CHANGE IN DIRECTION EXCEDING ONE HUNDRED AND THIRTY FIVE (135) DEGREES. THE DISTRICT MAY DEEM IT NECESSARY TO INSTALL CLANDUTS AT SHORTER INTERVALS, CLEANOUTS INSTALLED IN ROADWAYS, IN CONCRETE OR ASPHALT PAYED AREAS SHALL BE MADE ACCESSIBLE BY TRAFFIC GRADE YARD BOXES.

NOTE: AN ACCESSIBLE CLEAN OUT INSIDE THE BUILDUP CAN TAKE THE PLACE OF AN OUTSIDE CLEANOUT, IF CLEANOUT IS OUTSIDE THE BUILDUP IT SHALL BE LOCATED WITHIN TWO (2) FEET OF FOUNDATION AND PLACED IN A YARD BOX.

*THE CLEANOUT OR 'TEST TEE' AT THE PROPERTY LINE, AT MINIMUM IS TO BE BROUGHT TO WITHIN ONE FOOT OF FINISHED GRADE. A YARD BOX IS NOT REQUIRED, BUT RECOMMENDED. A REBAR MARKER IS REQUIRED CONJISTING OF 1½"X 18"STEEL REBAR WHICH IS BURIED HORIZONTALLY SIX (6) INCHES BELOW THE FINISHED GROUND SURFACE.

TESTING & INSPECTION: A CLEANOUT (PREFERABLY TWO-WAY TEE)
SHALL BE INSTALLED AT THE POINT THE BUILDING SEWER EXITS THE

THE FIRST THREE (3) INSPECTIONS BY THE DISTRICT INSPECTOR ARE COVERED BY THE BASIC INSPECTION FEE PAID AT THE TIME A CONNECTION PERMIT IS ISSUED. WHEN THE INSTALLATION IS FOUND TO CONFORM WITH ALL DISTRICT STANDARDS APPLICABLE, A WHITE TAG WILL BE GIVEN TO THE PERMITTED (FR ON ONE IS AVAILABLE TO RECEIVE THE WHITE TAG IT WILL BE LEFT ON THE JOB SIE). DO NOT CONCSAL ANY WORK UNIT, THE JOB HAS BEEN INSPECTED AND APPROVED. A CORRECTION NOTICE WILL BE LEFT IF THE JOB IS UNFINISHED OR UNSATISFACTORY.

PROTECTION FOR STEEP SLOPES (EROSION CONTROL): IN CASES WHERE THE GRADE OVER THE PIPELINE EQUALS OR EXCEEDS TWENTY-PIVE (25) PERCENT SLOPE, THE OWNER/CONTRACTOR SHALL PROVIDE ADDITIONAL EROSION CONTROL MEASURES TO STABILIZE THE BACKFILL MATERIAL. SEE STANDARD DRAWINGS E-16, E-18.

EXCAVATION: NO SEWER EXCAVATION SHALL BE LEFT UNATTENDED AT ANY TIME UNLESS THE PERMITTED HAS PROVIDED SUITABLE AND ADEQUALTE BARRICADE MEASURES TO INSURE PUBLIC SAFETY. TRENCH SHORING OR SLOPING MUST COMPLY WITH CURRENT CAL OSHA


CONDENNED WORK: WHEN ANY WORK SUBJECT TO A PERMIT HAS BEEN INSPECTED AND THE WORK DISAPPROVED OR CONDENMED, A WRITTEN NOTICE (CORRECTION NOTICE) TO THAT EFFECT WILL BE GIVEN TO THE APPLICANT, INSTRUCTING OWNEX/CONTRACTOR TO REPAIR OR REMEDY SUCH WORK IN ACCORDANCE WITH THE APPLICABLE DISTRICT RULES, REGULLATIONS, OR STANDARDS, WHEN ANY WORK IS DISAPPROVED OR CONDENNED, A RE-INSPECTION FEE SHALL BE APPLICABLE, FIFTY-FIVE (\$55.00) DOLLARS PER VISIT (AFTER THREE PRIOR INSPECTIONS [PER ITEM 11 PARAGRAPH 2]).

CONTRACTOR NOTES - WATER

- PRIOR TO INITIATING WORK ON OR ABOVE THE EXISTING WATER MAIN, THE CONTRACTOR SHALL MEET WITH REPRESENTATIVES OF THE CRESTLINE VILLAGE WATER DISTRICT ((909) 338-1727) TO DISCUSS THE WORK AND REVIEW THE CONTRACTOR'S MEANS AND METHODS. IN ADDITION, THE CONTRACTOR SHALL CONTACT THE COUNTY OF SAN BERNARDINO ((909) 387-7910) TO ACQUIRE AN ENCROACHMENT PERMIT FOR THE WORK IN SAN MORITZ DRIVE.
- 2. UNDER THE SUPERVISION OF CRESTLINE VILLAGE WATER DISTRICT REPRESENTATIVES, THE CONTRACTOR SHALL EXPOSE THE POINT OF CONNECTION ON THE EXISTING WATER MAIN, OBSERVE AND RECORD THE HORIZONTAL AND VERTICAL LOCATION OF THE MAIN, RECORD THE SIZE AND MATERIAL TYPE OF THE MAIN, AND REPORT THIS INFORMATION TO THE ENGINEER OF RECORD. THE CONTRACTOR SHALL ALLOW UP TO 10 WORKING DAYS FOR THE ENGINEER OF RECORD TO REVEW THE FIELD DATA AND MAINT HE DESIGN OF THE SERVICE CONNECTION AND SERVICE ALLOWED AND WITH ADDITIONAL FUNDS FOR THE 10 WORKING DAYS REVIEW PERIOD AND MINOR MODIFICATIONS TO THE DESIGN.
- 3. UNDER THE SUPERVISION OF CRESTLINE VILLAGE WATER DISTRICT REPRESENTATIVES, THE CONTRACTOR SHALL INSTALL THE WATER SERVICE, INCLUDING EXCAVATION AND BACKFILL, BEDDING, ALL PIPE MATERIAL AND FITTINGS, AND REPARTS TO EXISTING IMPROVEMENTS. INSTALLATION OF THE WATER SERVICE AND ASSOCIATED PIPING AND FITTINGS SHALL COMPLY WITH THE LAYOUT, DETAILS AND SPECIFICATIONS INCLUDED IN THE CONTRACT DOCUMENTS.
- 4. INSTALLATION OF THE WATER METER AND METER BOX WILL BE THE RESPONSIBILITY OF THE CRESTLINE VILLAGE WATER DISTRICT, THE CONTRACTOR SHALL COORDINATE WITH THE CRESTLINE VILLAGE WATER DISTRICT AND ALLOW TIME OF THE INSTALLATION OF THE WATER METER AND METER BOX.
- THE CONTRACTOR IS RESPONSIBLE FOR ARRANGING ALL INSPECTIONS. CONTACT THE CRESTLINE VILLAGE WATER DISTRICT ((909) 338-1727) AND THE COUNTY OF SAN BERNARDINO ((909) 387-8311) 48 HOURS IN ADVANCE.

CONTRACTOR NOTES - SEWER

- 1. PRIOR TO INITIATING WORK ON OR ABOVE THE EXISTING SEWER LINE, THE CONTRACTOR SHALL MEET WITH REPRESENTATIVES OF THE CRESTLINE SANITATION DISTRICT (DISTRICT) TO DISCUISS THE WORK AND REMEW PROCEDURES FOR DISTRICT SUPPLIED WORK AND INSPECTION OF THE CONTRACTOR'S WORK. CONTACT CRESTLINE SANITATION DISTRICT AT (909) 338-1751. IN ADDITION, THE CONTRACTOR SHALL CONTACT THE COUNTY OF SAN BERNARDINO ((909) 387-7910 TO ACQUIRE AN ENCROACHMENT PERMIT FOR THE WORK IN SAN MORITZ DRIVE.
- 2. UNDER THE SUPERVISION OF DISTRICT REPRESENTATIVES, THE CONTRACTOR SHALL EXPOSE THE EXISTING POINT OF CONNECTION ON THE SEWER LINE, OBSERVE AND RECORD THE SIZE OF THE MAIN, THE PIPE MATERIAL AND THE HORIZONTAL AND VERTICAL LOCATION AND REPORT THIS INFORMATION TO THE ENGINEER OF RECORD. THE CONTRACTOR SHALL ALLOW UP TO 10 WORKING DAYS FOR ENGINEER OF RECORD TO REVIEW THE FIELD DATA AND ADJUST THE DESIGN, AS NECESSARY. THE CONTRACTOR SHALL NOT BE ALLOWED OF PROVIDED WITH ADDITIONAL FUNDS FOR THE 10 DAYS REVIEW PERIOD AND MINOR MODIFICATIONS TO THE DESIGN.
- 3. IF IT IS DETERMINED THE PROPOSED CONNECTION POINT IS ACCEPTABLE. DISTRICT PERSONNEL WILL CONSTRUCT A NEW POINT OF CONNECTION USING A ROMAC CRESTANCE SEWER SADULE. THE CONTRACTOR WILL THEN INSTALL THE REMAINING PORTION OF THE PROPOSED 4—INCH SEWER LATERAL AND CONSTRUCT A 4—NOCH CLEAN OUTS AS REQUIRED BY THE APPROVED LATERAL ALIGNMENT.
- THE INSTALLATION PROCESS, INCLUDING EXCAVATION AND BACKFILL, BEDDING AND ALL PIPE MATERIAL AND FITTINGS SHALL COMPLY WITH THE CRESTLINE SANITATION DISTRICT INFORMATION CONCERNING THE SANITARY SEWER SYSTEM.
- THE CONTRACTOR IS RESPONSIBLE FOR ARRANGING ALL INSPECTIONS. CONTACT THE CRESTLINE SANITATION DISTRICT 24 HOURS IN ADVANCE AT (909) 338-1751 FOR INSPECTION.

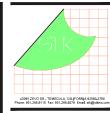

Engineering Resources of Southern Californ

361 W. Redlands Blvd, Bldg 7B edlands, Ca. 92373 (909) 890-1255

PROJECT ADMINISTERED BY:

SAN BERNARDINO COUNTY

REAL ESTATE SERVICES

DEPARTMENT
PROJECT MANAGEMENT

DIVISION

385 N. ARROWHEAD AVE. SAN BERNARDINO, CA 92415

ROJECT NAME:

LAKE GREGORY REGIONAL PARK SAN MORITZ PREFAB RESTROOM

PROJECT #10.10.1398

APN # 0337-202-07

24746 SAN MORITZ WAY CRESTLINE, CA 92325

| ISSUE INFORMATION: | DATE: | INFORMATION: | 10-02-2023 | 50%-DESIGN DEVELOPMENT | 12-18-23 | CD's | 01-23-24 | BID |

SHEET INFORMATION

STK PROJECT NO.: 374-178-23
SCALE: AS NOTED
DATE: DECEMBER 2023
PLOT DATE: DRAWING NAME:

EAL:



SHEET TITLE:

DETAILS AND NOTES

SHEET NO.

C1.3

EROSION CONTROL CONSTRUCTION NOTES

- ① SILT FENCE (SC-1). SEE DETAIL 1 HEREON. 190 LF ④ MATERIAL DELIVERY AND STORAGE (WM-01). 1 EA
- (2) STABILIZED CONSTRUCTION ENTRANCE/EXIT (TC-1) 1 EA (5) VEHICLE STORAGE.
 WITH FUMBLE RACKS (10'x24' MIN.). SEE DETAIL (6) SOLID WASTE MANAGE. 6 SOLID WASTE MANAGEMENT AREA (WM-05). 1 EA
- 3 GRAVEL BAG BERM (SC-6).

EROSION CONTROL NOTES

1. IN CASE OF EMERGENCY, CALL ROBERT BURTON AT 909 387 5000


- 2. POLLUTION AND EROSION PREVENTION MEASURES, ALSO KNOWN AS BEST MANAGEMENT PRACTICES (BMPS), MUST BE INSTALLED PRIOR TO GRADING. THESE MEASURES, INCLUDING THE PREVENTION OF ESDIMENTATION OF FLOOD DAMAGE, TO OFFSITE PROPERTY SHALL BE ADEQUATE WHETHER OR NOT AN EROSION CONTROL PERMIT IS REQUIRED.
- 3. ERODED SEDIMENTS AND OTHER POLLUTANTS MUST BE RETAINED ONSITE AND MAY NOT BE TRANSPORTED FROM THE SITE VIA SHEET FLOW, SWALES, AREA DRAINS, NATURAL DRAINAGE COURSES, OR WIND.
- 4. EROSION CONTROL DEVICES SHALL BE FUNCTIONING AT ALL TIMES. IN CASE OF FAILURE, RAPID CONSTRUCTION OF EMERGENCY DEVICES SHALL BE IMPLEMENTED.


- 10. SEDIMENTS AND OTHER MATERIALS MAY NOT BE TRACKED FROM THE SITE BY VEHICLE TRAFFIC. THE CONSTRUCTION ENTRANCE ROADWAYS MUST BE STABILIZED SO AS TO INHIBIT SEDIMENTS FROM BEING DEPOSITED INTO THE PUBLIC WAY. ACCIDENTAL DEPOSITIONS MUST BE SWEPT UP IMMEDIATELY AND MAY NOT BE WASHED DOWN BY RAIN OR OTHER MEANS.
- 11. ANY SLOPES WITH DISTURBED SOILS OR DENUDED OF VEGETATION MUST BE STABILIZED SO AS TO INHIBIT EROSION BY WIND AND WATER.
- 12. ALL SILT AND DEBRIS SHALL BE REMOVED FROM ALL DEVICES WITHIN 24 HOURS AFTER EACH RAINSTORM AND BE DISPOSED OF PROPERLY. ALL STORM WATER CAPTURE DEVICES SHALL BE PROTECTED AT ALL TIMES.



VEHICLE STORAGE AND MAINTENANCE AREA

WASTE STORAGE AREA

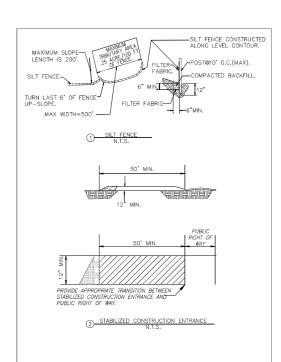

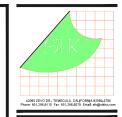

1861 W. Redlands Blvd, Bldg 7B Redlands, Ca. 92373 P: (909) 890-1255 F: (909) 890-0995

SAN BERNARDING COUNTY DEPARTMENT -PROJECT MANAGEMENT DIVISION

385 N. ARROWHEAD AVE. SAN BERNARDINO, CA 92415

LAKE GREGORY **REGIONAL PARK** SAN MORITZ PREFAB RESTROOM

PROJECT #10.10.1398

APN # 0337-202-07

24746 SAN MORITZ WAY CRESTLINE, CA 92325

DATE:	INFORMATION:
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SHEET INFORMATION: STK PROJECT NO.: 374-178-23 SCALE: AS NOTED


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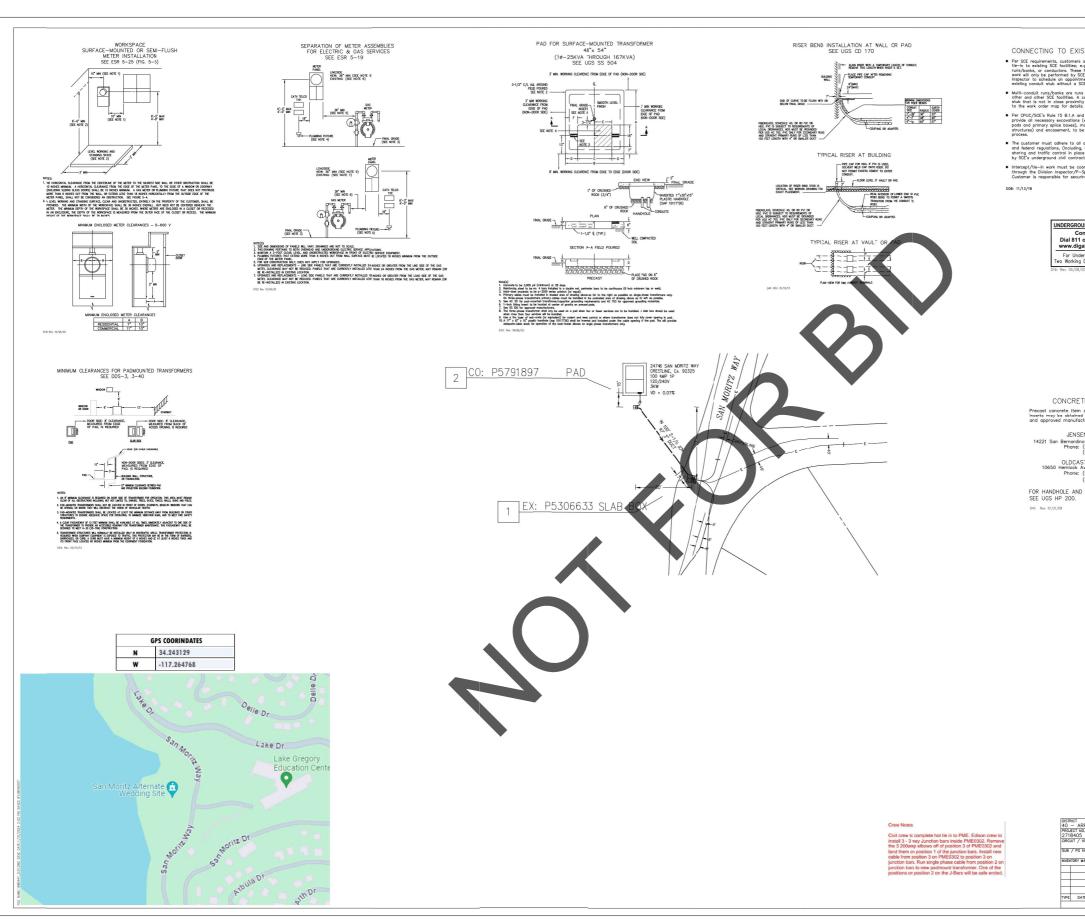
DATE: I PLOT DATE: DRAWING NAME:



EROSION CONTROL

C1.4



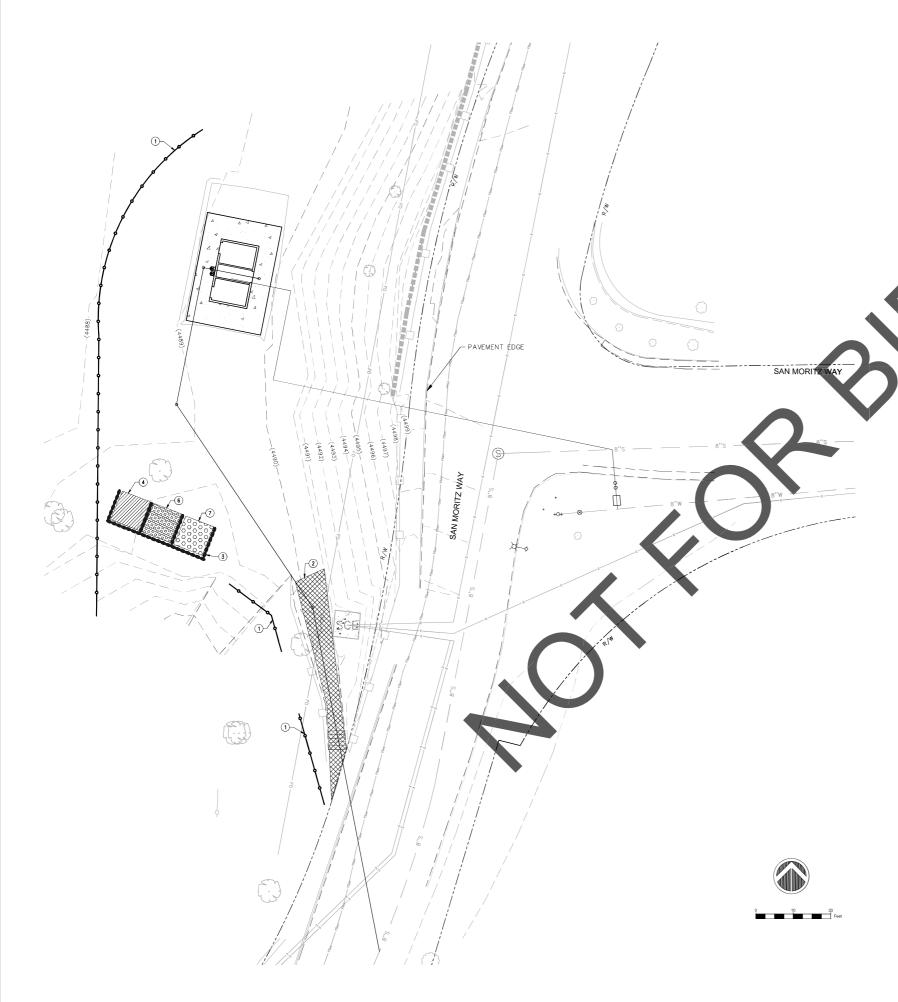

CONNECTING TO EXISTING SCE STRUCTURES

CONSTRUCTION BEGINS TO GO OVER THIS PROJECT.

SCE CONTACT: Garrett McCov Garrett.McCoy@sce.com

(626) 632-9285

TIE—IN MADE THROUGH BOTTOM OF STRUCTURE (Pad, Primary Spice Box)
The customer is responsible to trench and bring the conduit to within the last riser bend of the structure being entered (6o not undermine structure being entered). The customer is to provide coupling and bend.

APN #: 0337-202-07 24746 SAN MORITZ WAY CRESTLINE, CA 92325

> ISSUE INFORMATION: DATE: INFORMATION: 10-02-2023 50%-D.D. IO-I7-23 D.D. PROGRESS 12-08-23 CDs 12-18-23 CDs OI-23-24 BID

42095 ZEVO DR., TEMECULA, CALIFORNIA 92590-3780 Phone: 951.296.9110 Fax: 951.296.6079 Email: stk@stkinc.com

PROJECT ADMINISTERED BY

SAN BERNARDINO COUNTY REAL ESTATE SERVICES

DEPARTMENT -

PROJECT MANAGEMENT DIVISION

385 N. ARROWHEAD AVE SAN BERNARDINO, CA 92415

LAKE GREGORY REGIONAL PARK

SAN MORITZ

PREFAB RESTROOM

PROJECT #10,10,1398

CONSULTANT

SHEET INFORMATION:

STK PROJECT NO.874-178-23 SCALE: DATE: DECEMBER 2023 PLOT DATE: DRAWING NAME:




UTILITY PLAN SCE

SHEET NO.

A0.1

SCE ELECTRICAL PLAN

SCALE: 4

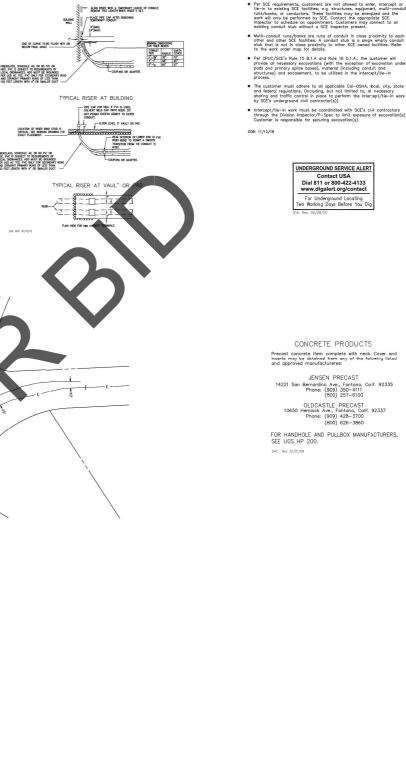


PLEASE HAVE THE CONTRACTOR REACH OUT TO THE PLANNER LISTED BELOW TO MEET OUT ON SITE BEFORE ANY

CUSTOMER-OWNED CONDUIT MATERIAL* AND CONCRETE ENCASEMENT AFE TO BE INSTALLED IN ACCORDANCE WITH EDISON ELECTRICAL SERVICE REQUIREMENTS.

EDISON SCALE: 1" = 40"

VENTORY MAP # or ## 1680447_0.01

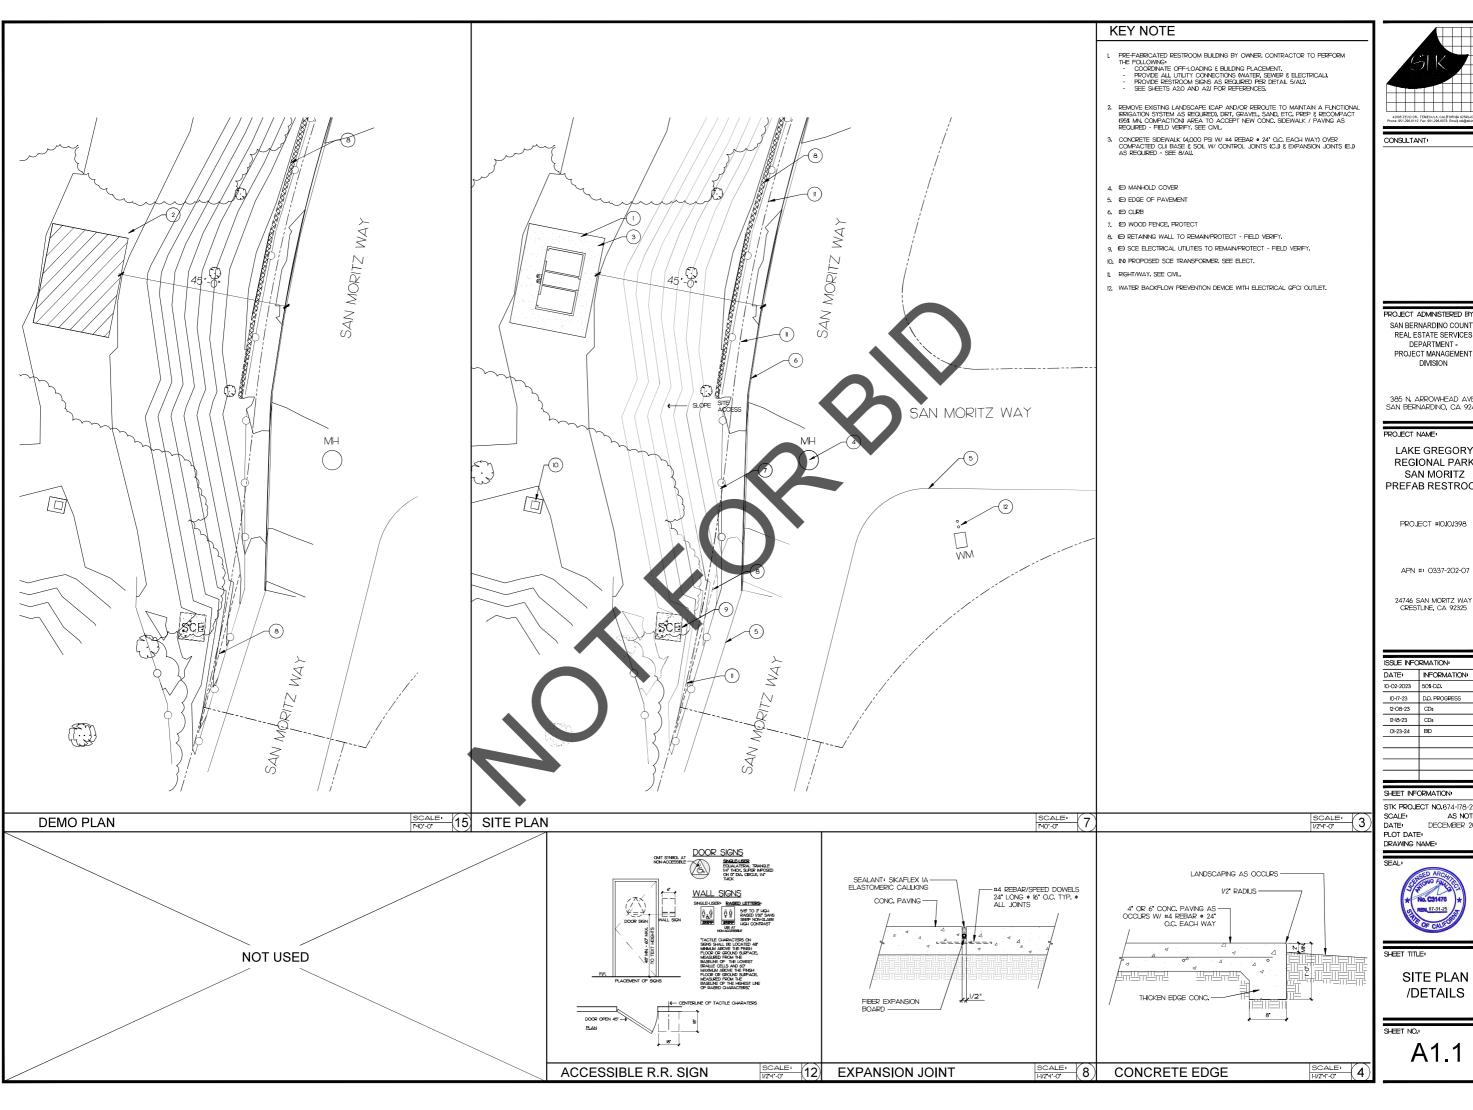



SAN BERNARDINO COUNTY REAL ESTATE SERVICES DEPARTMENT -PROJECT MANAGEMENT DIVISION

385 N. ARROWHEAD AVE, SAN BERNARDINO, CA 92415

LAKE GREGORY REGIONAL PARK SAN MORITZ PREFAB RESTROOM

PROJECT #10,10,1398

APN #: 0337-202-07

24746 SAN MORITZ WAY CRESTLINE, CA 92325

ISSUE INFO	DRMATION:
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10-17-23	D.D. PROGRESS
12-08-23	CDs
12-18-23	CDs
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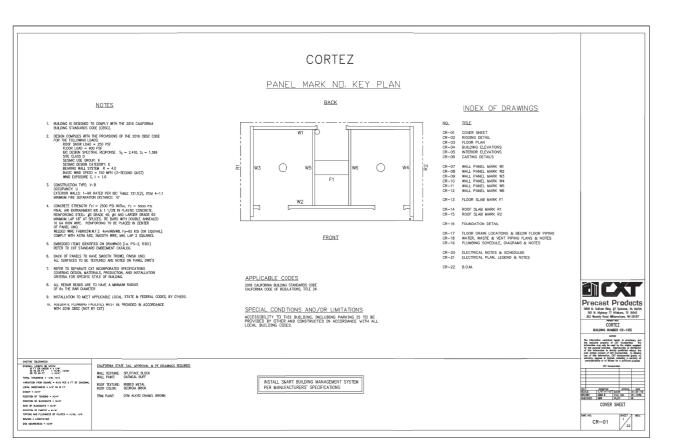
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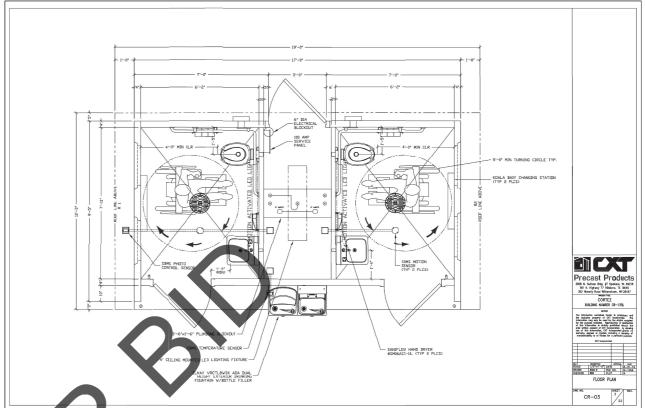
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DECEMBER 2023 PLOT DATE:





SITE PLAN /DETAILS

A1.1





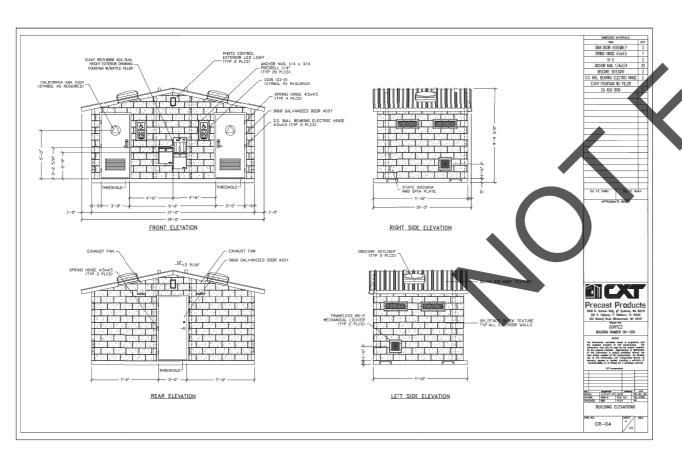

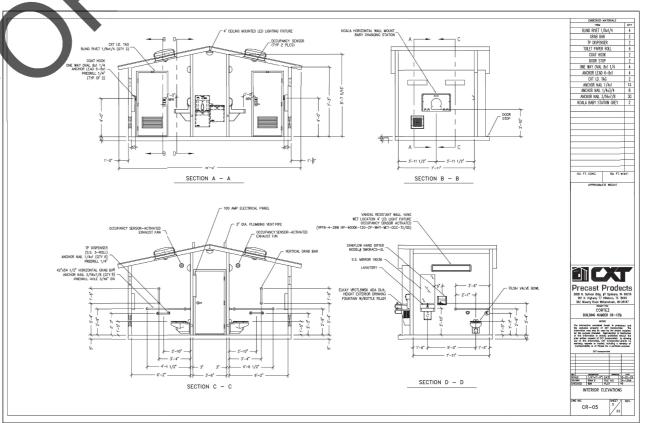

NOTES:

THE DRAWING & NOTES SHOWN ON THIS SHEET IS FOR INFORMATION & REFERENCE ONLY. THIS STRUCTURE IS AN OWNER PURCHASED & DELIVERED TO THE SITE, INCLUDING CRANE SERVICES, CONTRACTOR TO COORDINATE WITH OWNER FOR BULDING DELIVERY & ACCEPTANCE, CONTRACTOR SHALL PROVIDE ALL UTILITY CONNECTIONS AS REQUIRED

FOR REFERENCE ONLY



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385 N. ARROWHEAD AVE. SAN BERNARDINO, CA 92415

LAKE GREGORY REGIONAL PARK SAN MORITZ PREFAB RESTROOM

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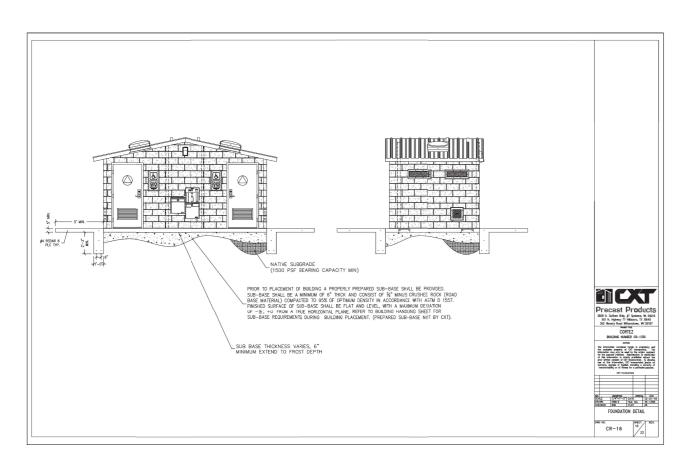





SHEET TITLE:

PREFABRICATED RESTROOM

A2.0



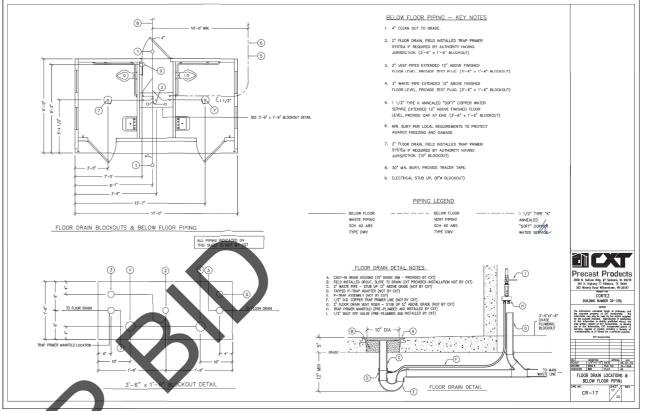



CONSULTANT

SAN BERNARDINO COUNTY REAL ESTATE SERVICES DEPARTMENT -PROJECT MANAGEMENT DIVISION

385 N, ARROWHEAD AVE, SAN BERNARDINO, CA 92415

LAKE GREGORY REGIONAL PARK SAN MORITZ PREFAB RESTROOM

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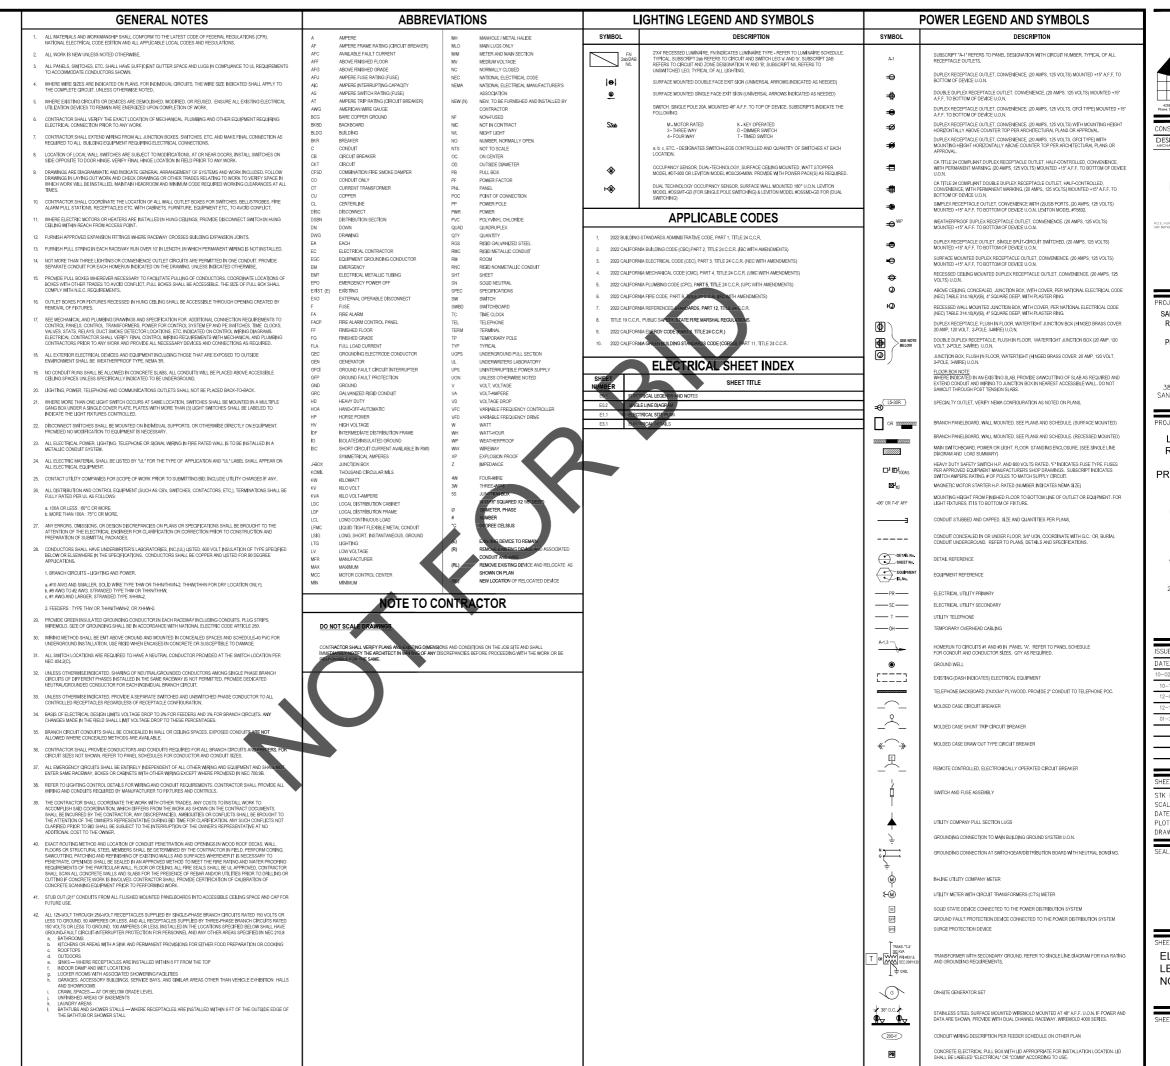
PREFABRICATED RESTROOM

A2.1

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DESIGN WEST ENGINEERING

SAN BERNARDING COUNTY REAL ESTATE SERVICES DEPARTMENT. PROJECT MANAGEMENT DIVISION

385 N. ARROWHEAD AVE SAN BERNARDING, CA 92415

LAKE GREGORY REGIONAL PARK SAN MORITZ PREFAB RESTROOM

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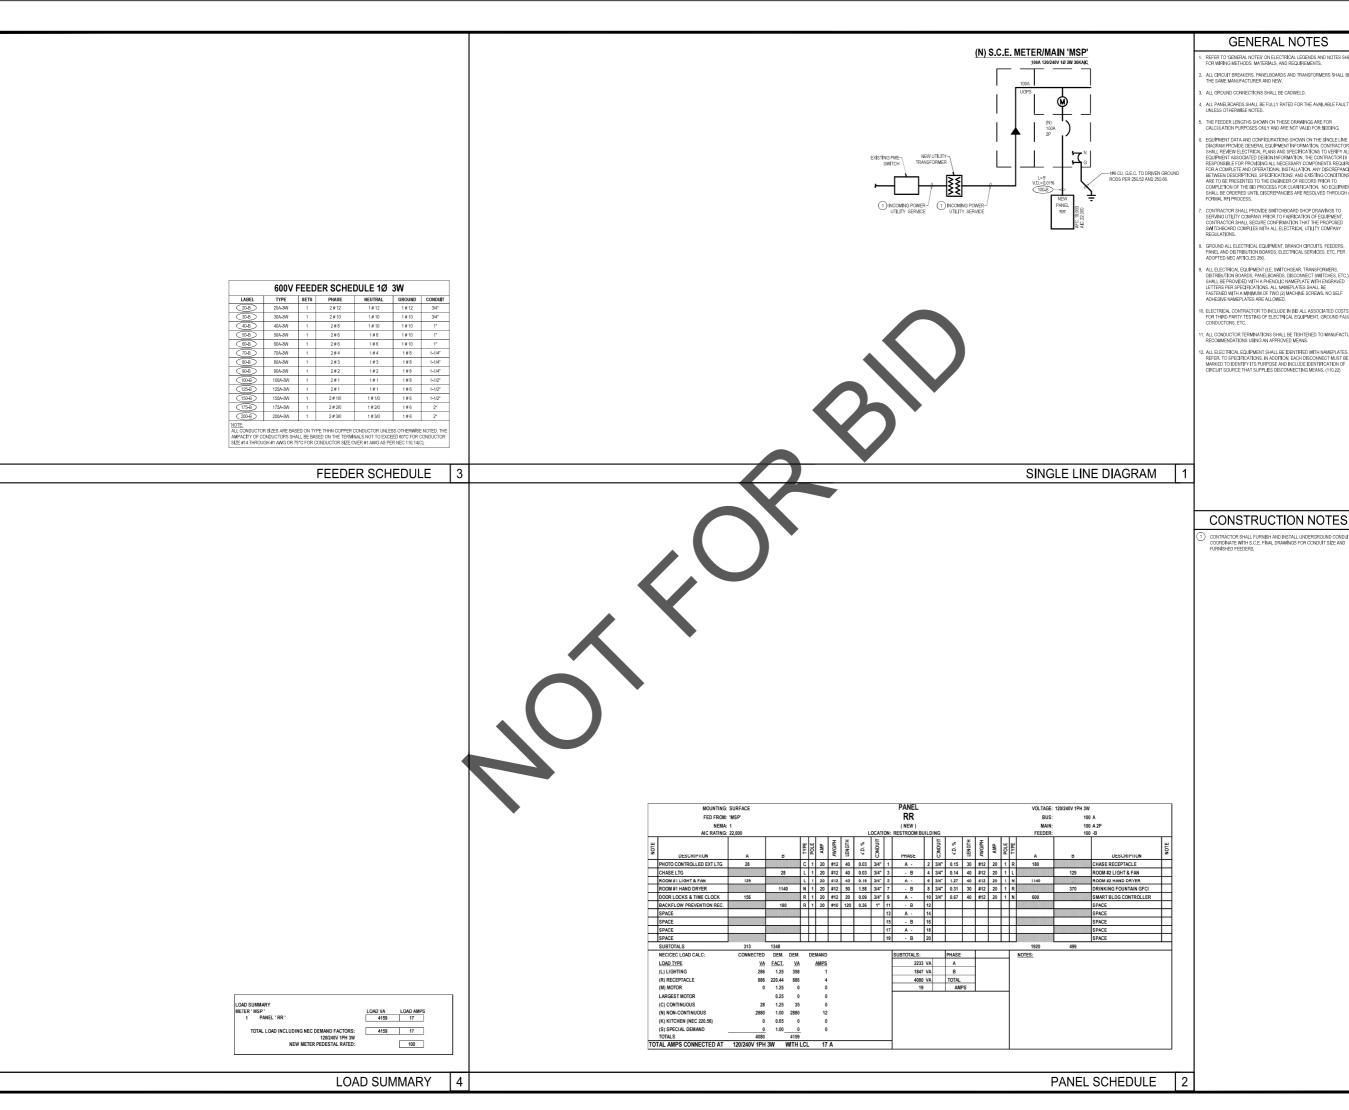
STK PROJECT NO.: 374-178-23 DECEMBER 2023 PLOT DATE:

DRAWING NAM



ELECTRICAL LEGENDS AND NOTES

E0.1



DESIGN WEST ENGINEERING

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385 N. ARROWHEAD AVE. SAN BERNARDINO, CA 92415

LAKE GREGORY REGIONAL PARK SAN MORITZ PREFAB RESTROOM

CONSTRUCTION NOTES

PROJECT #10.10.1398

APN #: 0337-202-07

24746 SAN MORITZ WAY CRESTLINE, CA 92325


DATE:	INFORMATION:
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10-17-23	D.D. PROGRESS
12-08-23	CDs
12-18-23	CDs
01-23-24	BID

STK PROJECT NO.: 374-178-23 DATE: DECEMBER 2023 PLOT DATE: DRAWING NAME



SINGLE LINE DIAGRAM

E0.2

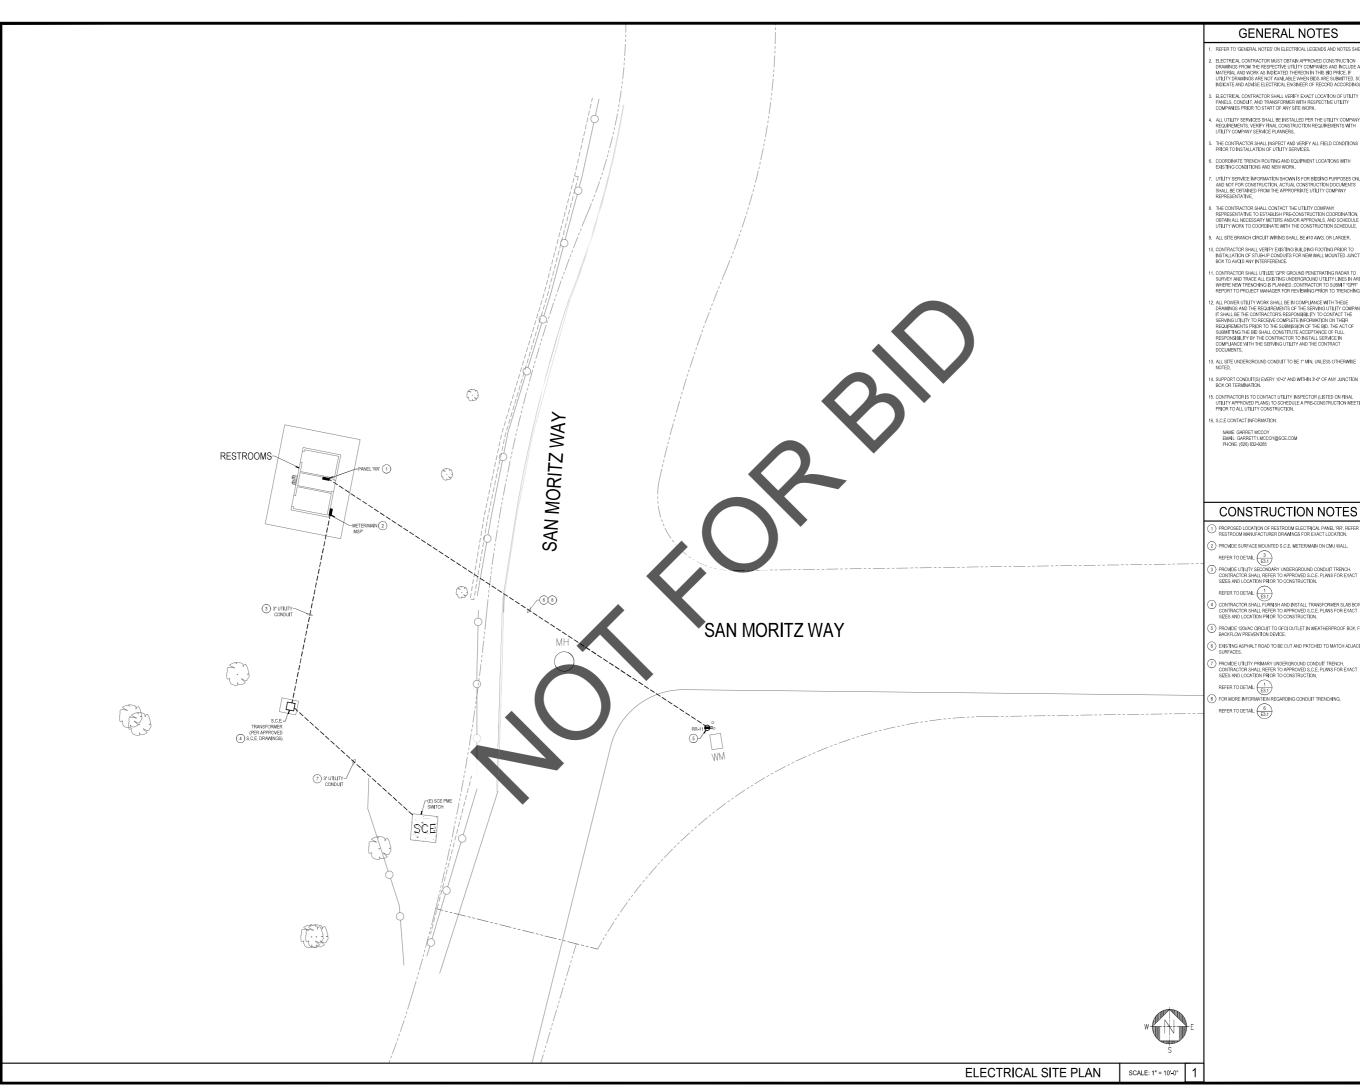

GENERAL NOTES

- ELECTRICAL CONTRACTOR SHALL VERIFY EXACT LOCATION OF UTILITY PANELS, CONDUIT, AND TRANSFORMER WITH RESPECTIVE UTILITY COMPANIES PRIOR TO START OF ANY SITE WORK.
- ALL UTILITY SERVICES SHALL BE INSTALLED PER THE UTILITY COMPAN REQUIREMENTS. VERIFY FINAL CONSTRUCTION REQUIREMENTS WITH UTILITY COMPANY SERVICE PLANNERS.
- COORDINATE TRENCH ROUTING AND EQUIPMENT LOCATIONS WITH EXISTING CONDITIONS AND NEW WORK.

- I. SUPPORT CONDUIT(S) EVERY 10'-0' AND WITHIN 3'-0' OF ANY JUNCTION BOX OR TERMINATION.
- S. S.C.E CONTACT INFORMATION:
- NAME: GARRET MCCOY EMAIL: GARRETT1.MCCOY@SCE.COM PHONE: (626) 632-9265

LAKE GREGORY REGIONAL PARK SAN MORITZ PREFAB RESTROOM

385 N. ARROWHEAD AVE. SAN BERNARDINO, CA 92415

SAN BERNARDINO COUNTY REAL ESTATE SERVICES DEPARTMENT -PROJECT MANAGEMENT DIVISION

CONSTRUCTION NOTES

- PROPOSED LOCATION OF RESTROOM ELECTRICAL PANEL 'RR', REFER ' RESTROOM MANUFACTURER DRAWINGS FOR EXACT LOCATION.
- 2 PROVIDE SURFACE MOUNTED S.C.E. METER/MAIN ON CMU WALL.
- PROVIDE UTILITY SECONDARY UNDERGROUND CONDUIT TRENCH.
 CONTRACTOR SHALL REFER TO APPROVED S.C.E. PLANS FOR EXACT SIZES AND LOCATION PRIOR TO CONSTRUCTION.

- REFER TO DETAIL: (1) (E3.1)

 3) FOR MORE INFORMATION REGARDING CONDUIT TRENCHING,

PROJECT #10.10.1398

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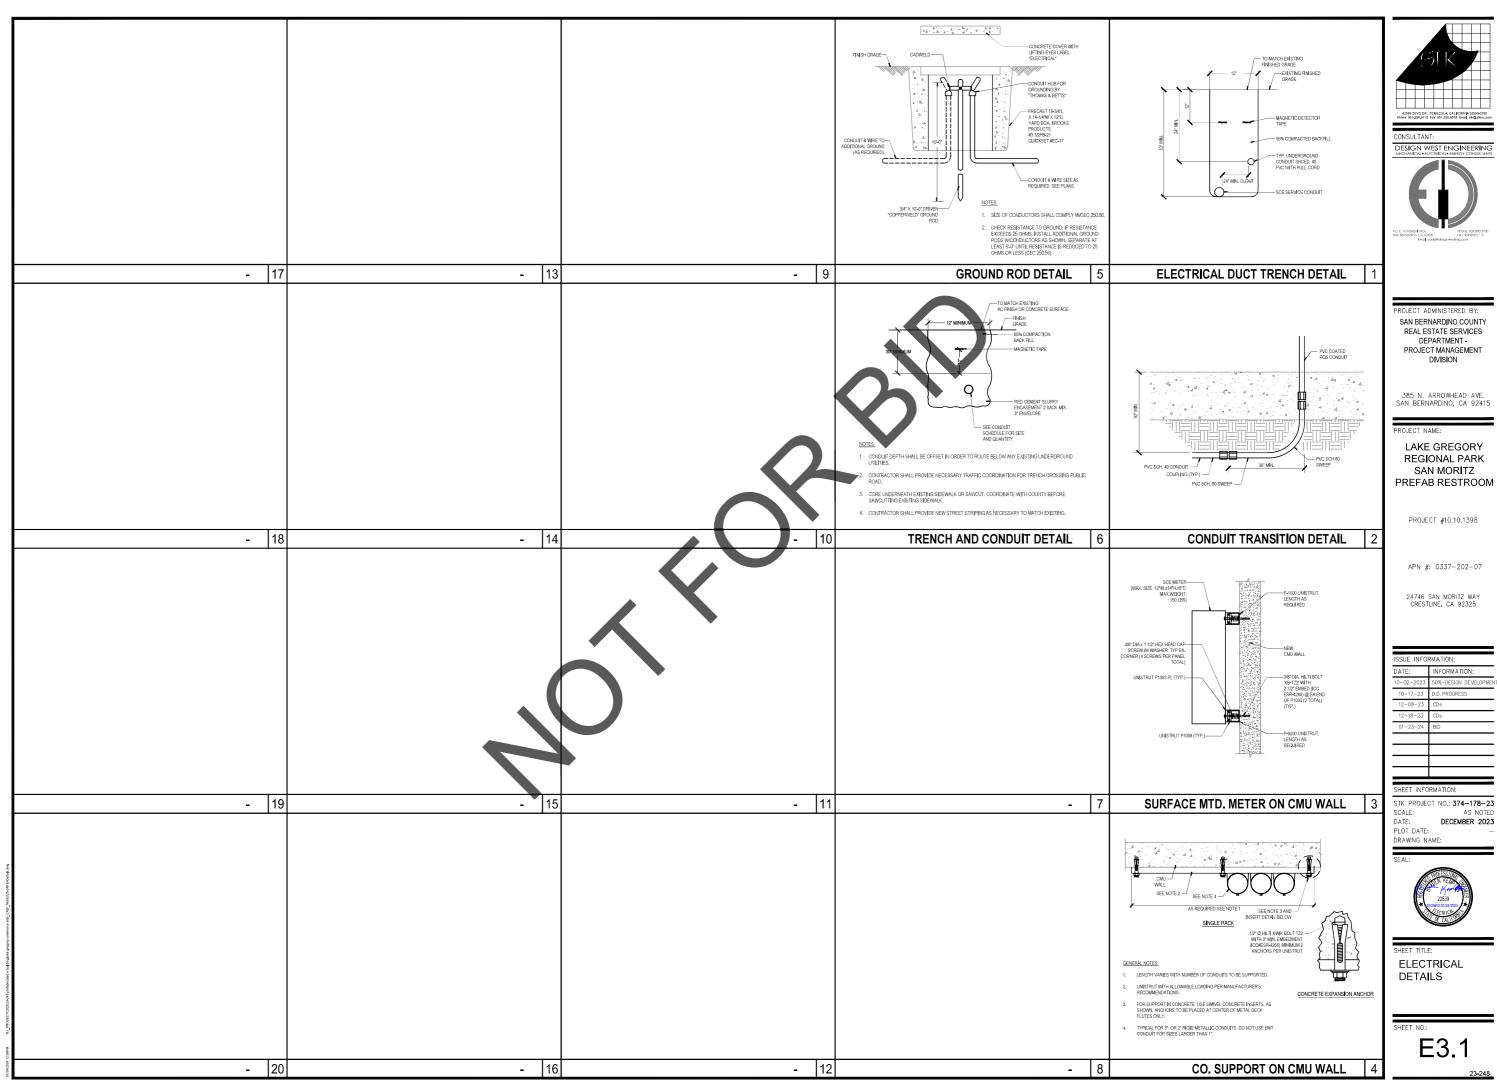
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	,

STK PROJECT NO.: 374-178-23 SCALE: DATE: AS NOTED
DECEMBER 2023

PLOT DATE: DRAWING NAM



ELECTRICAL SITE PLAN





DATE:	INFORMATION:
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