ALTADENA DR

EL DERRADO DR

STREAM -

#### DECLARATION OF ENGINEER OF RECORD

EL DORADO DR

I HEREBY DECLARE THAT THE DESIGN OF THE IMPROVEMENTS AS SHOWN ON THESE PLANS COMPLIES WITH PROFESSIONAL ENGINEERING STANDARDS AND PRACTICES. AS THE ENGINEER IN RESPONSIBLE CHARGE OF THE DESIGN OF THESE IMPROVEMENTS, I ASSUME FULL RESPONSIBLE CHARGE FOR SUCH DESIGN. I UNDERSTAND AND ACKNOWLEDGE THAT THE PLAN CHECK OF THESE PLANS BY SAN BERNARDINO COUNTY DEPARTMENT OF PUBLIC WORKS - SPECIAL DISTRICTS (SD) IS A REVIEW FOR THE LIMITED PURPOSE OF ENSURING THAT THE PLANS COMPLY WITH SD PROCEDURES, APPLICABLE POLICES AND ORDINANCES. THE PLAN CHECK IS NOT A DETERMINATION OF THE TECHNICAL ADEQUACY OF THE DESIGN OF THE IMPROVEMENTS. SUCH PLAN CHECK DOES NOT, THEREFORE, RELIEVE ME OF MY RESPONSIBILITY FOR THE DESIGN OF THESE IMPROVEMENTS. AS ENGINEER OF RECORD, I AGREE TO INDEMNIFY AND HOLD SD, IT'S OFFICERS. AGENTS. AND EMPLOYEES HARMLESS FROM ANY AND ALL LIABILITY, CLAIMS, DAMAGES OR INJURIES TO ANY PERSON OR PROPERTY WHICH MIGHT ARISE FROM THE NEGLIGENT ACTS, ERRORS OR OMISSIONS OF THE ENGINEER OF RECORD. I HAVE READ AND INFORMED THE PROJECT APPLICANT/DEVELOPER THAT APPROVAL OF THESE PLANS DO NOT RELIEVE THEM FROM THE REQUIREMENTS OF THE DESIGN CONDITIONS.

**LOCATION MAP** 

NOT TO SCALE



#### **ENGINEER'S CERTIFICATION**

I CERTIFY THAT THE DESIGN OF THE WATER SYSTEM HAS BEEN DISCUSSED WITH THE SAN BERNARDINO COUNTY FIRE DEPARTMENT, AND IS EXEMPT FROM THEIR REQUIREMENTS.



#### NOTIFICATIONS

- AT LEAST 48 HOURS PRIOR TO COMMENCING CONSTRUCTION, CONTRACTOR SHALL NOTIFY:
- SPECIAL DISTRICTS WATER AND SANITATION DIVISION: DEVELOPMENT SERVICES (760) 955-9885 UNDERGROUND SERVICE ALERT (USA): 811
- 3. ALL OTHER AFFECTED AGENCIES THAT ARE NOT MEMBERS OF USA ALERT

## SAN BERNARDINO COUNTY DEPARTMENT OF PUBLIC WORKS SPECIAL DISTRICTS

CSA 70F - MORONGO VALLEY MORONGO VALLEY WATER TANK REPLACEMENT

**RE-BID SET** 

TANK SITE R1 BID SET

APN: 0580-241-16-0000

#### SHEET LIST TABLE SHEET NUMBER SHEET TITLE COVER SHEET GENERAL NOTES QUANTITIES EXISTING CONDITIONS SITE PLAN TEMPORARY TANK MECHANICAL PLAN **DEMOLITION PLAN** GRADING PLAN SITE AND MECHANICAL PLAN TANK SECTIONS EROSION CONTROL PLAN DETAILS 13 DETAILS DETAILS 14 TEMPORARY ELECTRICAL PLAN 15 ELECTRICAL SITE PLAN

OWNER/DEVELOPER SAN BERNARDINO COUNTY DEPARTMENT OF PUBLIC WORKS, SPECIAL DISTRICTS 222 W. HOSPITALITY LANE, 2ND FLOOR SAN BERNARDINO, CA 92415 PHONE: 909.386.8800

**CIVIL ENGINEER** SARP SEKEROGLU, PE KIMLEY-HORN AND ASSOCIATES 401 B STREET, SUITE 600 SAN DIEGO CA 92101

ELECTRICAL DETAILS

#### GEOTECHNICAL ENGINEER JOSE TAPIA, PE

LEIGHTON CONSULTING 10532 ACACIA STREET, SUITE B-6 RANCHO CUCAMONGA, CALIFORNIA 91730

GEOTECHNICAL EXPORATION: PROPOSED MORONGO VALLEY WATER TANK REPLACEMENT PROJECT. JANUARY 10, 2024 PROJECT SERVICE REQUEST: SD003 PROJECT NO: 038.0000020646

#### **DETAIL/SECTION REFERENCES** SECTION CUT AND DIRECTION TAIL (ROTATED AS REQUIRED) (INDICATES VIEW DIRECTION) SECTION OR DETAIL DETAIL OR SECTION SCALE: N.T.S. DRAWING WHERE NUMBER/LETTER SHEET FROM WHERE DETAIL SHEET WHERE

HJ	AUTHORITIES HAVING JURISDICTION	MJ	MECHANICAL JOINT
NSI	AMERICAN NATIONAL STANDARDS INSTITUTE	NSF	NATIONAL SANITATION FOUNDATION
PPROX	APPROXIMATE	N	NORTHING
٧E	AVENUE	NPT	NATIONAL PIPE TAPERED
WWA	AMERICAN WATER WORKS ASSOCIATION	NTS	NOT TO SCALE
_	CEMENT LINED	O.D.	OUTER DIAMETER
	DUCTILE IRON	PROP	PROPOSED
	EASTING	PSI	POUNDS PER SQUARE INCH
<	EXISTING	PVC	POLYVINYL CHLORIDE
=	FINISHED FLOOR	ROW	RIGHT OF WAY
3	FINISHED GRADE	SBCSD	SAN BERNARDINO COUNTY SPECIAL DISTRICTS
_G	FLANGE	SF	SQUARE FOOT
NPT	FEMALE NATIONAL PIPE TAPERED	SCH	SCHEDULE
₹	FIBER ROLL	SPPWC	STANDARD PLANS FOR PUBLIC WORKS CONSTRUCT
	GAS	SS	SANITARY SEWER
A	GAUGE	ST	STREET
ALV	GALVANIZED	STA	STATION
OPE	HIGH DENSITY POLYETHYLENE	TEMP	TEMPORARY
ΝL	HIGH WATER LEVEL	TYP	TYPICAL
).	INNER DIAMETER	UG	UNDERGROUND
•	LINEAR FEET		

DRAFIII	NG LEGEND
NOTE (TYP)	ANNOTATION, SINGLE LEADER (INDICATING TYPICAL AT MULTIPLE LOCATIONS)

DDAETING LEGENID

ANNOTATION, MULTIPLE LÉADERS INDICATING DISCRETE

STANDARD NORTH ARROW (ROTATED AS REQUIRED)

NORTH ARROY GRAPHIC SCALE IN FEET VIEWPORT VIEWPOR1 SCALE SCALE

IS FIRST REFERENCED



<b>Kimley</b> » Horn
401 B STREET, SUITE 600, SAN DIEGO, CA 92101 PHONE: (619) 234—9411 WWW.KIMLEY—HORN.COM
PREPARED UNDER THE SUPERVISION OF:
04/10/2024

R.C.E. No. 71474 EXP. 12/31/2025

REVISIONS		•		<u> </u>
ADDENDUM NO. 2		6/24	ļ S	AN
ADDENDUM NO. 5		6/24		
			ASSISTANT DIR	ECTO
			APPROVALS	
			711111017120	
DESCRIPTION	APPR.	DATE		

	6/24	5	AN BERNARDING COUNTY - PI SPECIAL DISTRICT		.5	
	6/24		OF LOIAL DISTRICT	J		
					07/18/2024	
		ASSISTANT DIR	ECTOR			
			REVIEWER	INITIAL	DATE	
		APPROVALS	PROJECT MANAGER		07/16/2024	
		ALLINOVALO	PM, DIVISION MANAGER		07/16/2024	
ADDD	DATE		WAS DIVISION MANAGER		07/17/2024	

SCOPE OF WORK

SITE ADDRESS

8355 TERRACE DRIVE

MORONGO VALLEY, CA 92256

THE PROPOSES TO DEMOLISH AN EXISTING

BOLTED STEEL WATER TANK AND REPLACE

IT WITH A NEW BOLTED STEEL WATER TANK.

<del>/24</del> 5/24	- S.	WATER TANK REPLACEMENT PLANS AN BERNARDINO COUNTY - SPECIAL DISTRIC	PUBLIC WOR	KS	WATER TANK REPLACEMENT PLANS	DWG NO. 30.30.00157
7 24	ASSISTANT DIRE			07/18/2024	APN: 0580-241-16-0000 MORONGO VALLEY WATER TANK	FILE NO. SD003
		REVIEWER	INITIAL	DATE	REPLACEMENT PROJECT	30003
	APPROVALS	PROJECT MANAGER		07/16/2024	COVER SHEET	
	ALOVALO	PM, DIVISION MANAGER		07/16/2024	JOVER OFFICE	SHEET 1 OF 17

# SAN BERNARDINO PUBLIC WORKS

### **ABBREVIATIONS**

**LEGEND** EXIST CONTOUR

EXIST GAS **EXIST OVERHEAD** EXIST FENCE **EXIST EASEMENT** PROPERTY LINE

**EXIST WATER** 

GRADING LIMITS PROP WATER TEMPORARY WATER EXIST ELECTRICAL PROP ELECTRICAL

EXIST DIRT ROAD EXIST GRAVEL

RIGHT OF WAY

VIEWPORT OR FEATURE VIEW FRAME EXTENT (WITH DRAWING LOCATION REFERENCE)

(HORIZONTAL AND/OR VERTICAL AS REQUIRED)

UNDERGROUND SERVICE ALERT Call: TOLL FREE 1-800-227-2600

TWO WORKING DAYS BEFORE YOU DIG

**BENCHMARK:** CCS83 ZONE 5, NAD83(2011), EPOCH 2010.0

BASIS OF BEARINGS: FD GLO BRASS CAP UP 0.6', CN 1/16 COR S.12. PER RS 103/74. ELEVATION DETERMINED VIA STATIC GPS OBSERVATION, PROCESSED THROUGH NAVD-88 ELEV = 3066.588'

DETAIL IS REFERENCED DETAIL IS FOUND

#### **GENERAL NOTES**

- 1. ALL WORK SHALL BE DONE IN ACCORDANCE WITH THESE PLANS AND TO THE LATEST SPECIAL DISTRICTS "STANDARDS FOR DOMESTIC WATER SYSTEMS" AS POSTED ON SPECIAL DISTRICTS WEBSITE AT: https://specialdistricts.sbcounty.gov/project-management/water-sewer-standards/
- 2. IT IS THE CONTRACTOR'S RESPONSIBILITY TO MAINTAIN A CURRENT AND APPROVED SET OF SPECIAL DISTRICTS STANDARD SPECIFICATIONS ON THE JOB SITE AT ALL TIMES. STANDARD SPECIFICATIONS CAN BE PURCHASED AT THE SAN BERNARDINO COUNTY SPECIAL DISTRICTS OFFICE.
- 3. THE CONTRACTOR SHALL BE RESPONSIBLE FOR MAKING ARRANGEMENTS FOR CONSTRUCTION INSPECTION AT LEAST 48 HOURS PRIOR TO BEGINNING WORK BY CALLING DEVELOPMENT SERVICES AT (760) 955-9885 OR BY EMAIL AT DEVSERVICES@SDD.SBCOUNTY.GOV
- 4. IT SHALL BE THE RESPONSIBILITY OF THE CONTRACTOR TO FAMILIARIZE ITSELF WITH THE JOB SITE AND THE LOCATION OF ALL UNDERGROUND FACILITIES SHOWN OR NOT SHOWN ON THESE PLANS. THE CONTRACTOR IS RESPONSIBLE FOR ALL DIG ALERT REQUESTS AND EXPLORATORY EFFORTS NECESSARY TO VERIFY ANY UNDERGROUND OBSTRUCTIONS. THE CONTRACTOR WILL BE UNILATERALLY RESPONSIBLE FOR ANY DAMAGE DONE TO EXISTING UTILITIES THAT ARE SHOWN OR NOT SHOWN ON THESE PLANS.
- 5. THE CONTRACTOR SHALL BE RESPONSIBLE FOR ANY AND ALL DAMAGES TO PIPE INCURRED WHILE BACK FILLING AND COMPACTING.
- THE CONTRACTOR SHALL OBTAIN ALL NECESSARY STATE, COUNTY OR LOCAL PERMITS.
- 7. CONTRACTOR SHALL OBTAIN AN EXCAVATION PERMIT AND ENCROACHMENT PERMIT OR OTHER REQUIRED PERMITS FROM THE SAN BERNARDINO COUNTY DEPARTMENT OF PUBLIC WORKS TRANSPORTATION, PRIOR TO ANY GRADING OR PIPELINE EXCAVATION WITHIN THE COUNTY RIGHT OF WAY BY CALLING (909) 387-7910.
- 8. THRUST BLOCKS SHALL BE INSTALLED PER SPECIAL DISTRICTS "STANDARDS FOR DOMESTIC WATER SYSTEMS" PER STANDARD DRAWING H-3A AND H-3B.
- 9. THE CONTRACTOR SHALL NOTIFY ALL SERVING UTILITY COMPANIES 48 HOURS PRIOR TO BEGINNING ANY DITCH EXCAVATION WHEN WORK IS TO BE PERFORMED NEAR THEIR FACILITIES BY CALLING 811.
- 10. ALL PIPE SHALL BE CLASS 150 AND INSTALLED WITH LOCATION TAPE 18" BELOW FINISHED GRADE AND 14 GA. INSULATED WIRE TAPED TO PIPE AND BROUGHT TO SURFACE AT HYDRANTS, METER SERVICES, AIR VAC &
- 11. THE CONTRACTOR SHALL COORDINATE ALL TIE-INS OF NEW WATER MAINS IN COUNTY SERVICE AREAS WITH THE WATER AND SANITATION SUPERVISOR, 222 W. HOSPITALITY LANE, 2ND FLOOR, SAN BERNARDINO, CA 92415-0450; PHONE: (760) 955-9885 TO KEEP INTERRUPTIONS TO A MINIMUM. NO INTERRUPTIONS TO EXISTING SERVICES SHALL BE MADE UNLESS THE DISTRICT GRANTS PRIOR APPROVAL.
- 12. CONTRACTOR SHALL ENSURE THAT UTILITY EASEMENTS HAVE BEEN RECORDED PRIOR TO START OF WORK.
- 13. WATER MAIN SHALL HAVE A MINIMUM OF 48" OF COVER FROM TOP OF PIPE TO FINAL GRADE.
- 14. HYDRO TEST AT 200 PSI MINIMUM FOR A 2 HOUR DURATION AT LOWEST POINT IN THE WATER LINE.
- 15. METER BOXES SHALL BE PLACED WITHIN 1 FOOT MINIMUM, 3 FEET MAXIMUM FROM ADJACENT PROPERTY LINE. METER BOXES IN THE SIDEWALK SHALL HAVE CONCRETE LIDS.
- 16. THE CONTRACTOR SHALL BE HELD RESPONSIBLE FOR ANY FIELD CHANGES MADE WITHOUT PRIOR WRITTEN AUTHORIZATION FROM THE UNDERSIGNED ENGINEER AND THE COUNTY OF SAN BERNARDINO SPECIAL
- 17. THE CONTRACTOR AGREES THAT IT SHALL ASSUME SOLE AND COMPLETE RESPONSIBILITY FOR JOB SITE CONDITIONS DURING THE COURSE OF CONSTRUCTION OF THIS PROJECT, INCLUDING SAFETY OF ALL PERSONS AND PROPERTY; THAT THIS REQUIREMENT SHALL APPLY CONTINUALLY AND NOT BE LIMITED TO NORMAL WORKING HOURS; AND THAT CONTRACTOR SHALL DEFEND, INDEMNIFY AND HOLD THE OWNER AND THE ENGINEER HARMLESS FROM ANY AND ALL LIABILITY, REAL OR ALLEGED, IN CONNECTION WITH THE PERFORMANCE OF WORK ON THIS PROJECT EXCEPTING FOR LIABILITY ARISING FROM THE SOLE NEGLIGENCE OF THE OWNER OR THE ENGINEER.
- 18. ALL STATIONING IS BASED ON THE CENTER LINE OF THE STREET.
- 19. ALL EXCAVATIONS SHALL BE BACKFILLED AT THE END OF EACH WORKING DAY AND ROADS OPEN TO VEHICULAR TRAFFIC UNLESS OTHERWISE APPROVED BY THE SPECIAL DISTRICTS ENGINEER.
- 20. ALL PIPE DISTANCES SHOWN ARE HORIZONTAL.

- 21. ALL WORK SHALL BE CONSTRUCTED ACCORDING TO THE VERTICAL AND HORIZONTAL MEASUREMENTS OF THESE PLANS AND EXISTING DESIGN STANDARDS. ADEQUATE STAKES SHALL BE SET UNDER THE DIRECTION OF A LICENSED SURVEYOR/ENGINEER FOR THE CONSTRUCTOR. ALL CONSTRUCTION SURVEYING SHALL BE PERFORMED IN ACCORDANCE TO THE SURVEYING PROCEDURES OF THE SURVEYOR/ENGINEER OF RECORD. IF THIRD PARTY SUBCONTRACTORS PERFORM THE CONSTRUCTION LAYOUT AND SURVEYING FOR THIS PROJECT WITHOUT THE COORDINATION OF THE SURVEYOR/ENGINEER OR RECORD, THEY HAVE ASSUMED THE POSITION OF SURVEYOR/ENGINEER OF RECORD. THE FINAL CHECK OF THIS DESIGN IS TO BE THE CONSTRUCTION STAKING AS THE DESIGN MEETS THE EXISTING CONTROL AND ELEVATIONS. ALL EXISTING DISCREPANCIES TO THE STANDARD DESIGN CRITERIA SHALL BE BROUGHT TO THE SURVEYOR/ENGINEER OF RECORD'S ATTENTION PRIOR TO PROCEEDING WITH CONSTRUCTION. IF CONSTRUCTION CONTINUES WITHOUT VERIFICATION THE CONSTRUCTOR ASSUMES THE RESPONSIBILITY OF THE CORRECTNESS OF THE INTENDED DESIGN.
- 22. THE METHOD AND LOCATION OF CONNECTION TO THE PUBLIC WATER SUPPLY AND REQUIREMENTS FOR BACKFLOW PROTECTION SHALL BE PROVIDED IN ACCORDANCE WITH LOCAL WATER SUPPLIES REQUIREMENTS.
- 23. CONTRACTOR TO COORDINATE WITH OTHER UTILITIES, TRADES, AND ARCHITECTURAL PLANS TO AVOID CONFLICTS AND VERIFY BUILDING TIE-IN LOCATIONS.
- 24. CONTRACTOR SHALL DISINFECT THE WATER LINE IN ACCORDANCE WITH THE AMERICAN WATER WORKS ASSOCIATION (AWWA) STANDARD C651 PRIOR TO PLACING LINE IN SERVICE.
- 25. THESE PLANS WERE DESIGNED FOR THE IN-SERVICE CONDITIONS ONLY. THE METHODS, PROCEDURES AND SEQUENCES OF CONSTRUCTION ARE THE RESPONSIBILITY OF THE CONTRACTOR. THE CONTRACTOR SHALL TAKE ALL NECESSARY PRECAUTIONS TO MAINTAIN AND ENSURE THE INTEGRITY OF THE PIPELINE AND ASSOCIATED APPURTENANCES AT ALL STAGES OF CONSTRUCTION. THE CONTRACTOR SHALL MAINTAIN WATER SERVICE TO ALL CUSTOMERS AT ALL STAGES OF CONSTRUCTION.
- 26. DRAWINGS DO NOT INDICATE TEMPORARY OR BYPASSING REQUIREMENTS. NEED FOR TEMPORARY SHORING AND BRACING, TEMPORARY DEWATERING, TEMPORARY BYPASSING OR OTHER TEMPORARY MEASURES MAY BE INDICATED ON DRAWINGS AT SELECTED AREAS AS SUGGESTIONS FOR THE CONTRACTOR'S CONVENIENCE. THE DRAWINGS DO NOT IDENTIFY ALL AREAS OR CONDITIONS REQUIRING TEMPORARY MEASURES. IT IS THE CONTRACTOR'S RESPONSIBILITY TO CONFIRM TEMPORARY MEASURES INDICATED ON THE DRAWINGS, IDENTIFY OTHER AREAS OR CONDITIONS REQUIRING TEMPORARY MEASURES, DETERMINE MOST EFFICIENT TEMPORARY SYSTEMS, AND DESIGN AND CONSTRUCT THE REQUIRED TEMPORARY SYSTEMS. ALL TEMPORARY SYSTEMS SHALL BE DESIGNED BY A CA LICENSED ENGINEER AND SUBMITTED TO THE COUNTY ENGINEER FOR REVIEW PRIOR TO CONSTRUCTION.

#### ENGINEER'S NOTE TO CONTRACTOR

- 1. THE EXISTENCE AND LOCATION OF ANY UNDERGROUND UTILITY PIPES, CONDUITS, OR STRUCTURES SHOWN ON THESE PLANS ARE OBTAINED BY A SEARCH OF THE AVAILABLE RECORDS. TO THE BEST OF OUR KNOWLEDGE THERE ARE NO EXISTING UTILITIES EXCEPT AS SHOWN ON THESE PLANS. THE CONTRACTOR IS REQUIRED TO TAKE DUE PRECAUTIONARY MEASURES TO PROTECT THE UTILITIES SHOWN ON THESE DRAWINGS AND TO VERIFY ALL DIMENSIONS, PIPE SIZES, PIPE MATERIALS, FLANGE SIZES, AND BOLT CONFIGURATIONS PRIOR TO ORDERING PARTS AND BEGINNING WORK. THE CONTRACTOR FURTHER ASSUMES ALL LIABILITY AND RESPONSIBILITY FOR THE UTILITY PIPES, CONDUITS OR STRUCTURES SHOWN ON THESE DRAWINGS.
- 2. CONTRACTOR AGREES THAT THEY SHALL ASSUME SOLE AND COMPLETE RESPONSIBILITY FOR JOB SITE CONDITIONS DURING THE COURSE OF CONSTRUCTION OF THIS PROJECT, INCLUDING SAFETY OF ALL PERSONS AND PROPERTY, THAT THIS REQUIREMENT SHALL APPLY CONTINUOUSLY AND NOT BE LIMITED TO NORMAL WORKING HOURS, AND THAT THE CONTRACTOR SHALL DEFEND, INDEMNIFY AND HOLD SAN BERNARDINO COUNTY, CSA 70F (DISTRICT), THE OWNER AND THE ENGINEER HARMLESS FROM ANY AND ALL LIABILITY, REAL OR ALLEGED, IN CONNECTION WITH THE PERFORMANCE OF WORK ON THIS PROJECT, EXCEPTING FOR LIABILITY ARISING FROM THE SOLE NEGLIGENCE OF THE OWNER OR THE ENGINEER.

#### DEFERRED SUBMITTAL

TANK FOUNDATION AND TANK STRUCTURAL DESIGN BY TANK MANUFACTURER. ALL SUBMITTED DOCUMENTS SHALL BE ACCEPTED BY THE ENGINEER OF RECORD AND APPROVED BY THE AUTHORITIES HAVING JURISDICTION (AHJ).

#### **GEOTECHNICAL**

GEOTECHNICAL REPORTS HAVE BEEN PROVIDED BY THE SAN BERNARDINO COUNTY SPECIAL DISTRICTS DEPARTMENT. DESIGN OF THE NEW TANK WAS BASED ON RECOMMENDATIONS CONTAINED IN THE GEOTECHNICAL INVESTIGATION REPORT PREPARED BY LEIGHTON. THESE RECOMMENDATIONS ARE NOTED ON THE INDIVIDUAL DESIGN DETAILS AND INCLUDE OVEREXCAVATION OF THE TANK FOUNDATION, OVEREXCAVATION OF THE TEMPORARY TANKS, SCARIFICATION OF SUBGRADE, BEDDING MATERIAL, BACKFILL MATERIAL, AND COMPACTION.

#### TOPOGRAPHY SOURCE

SOURCE PROVIDED BY THE SAN BERNARDINO COUNTY SPECIAL DISTRICTS DEPARTMENT DATE OF SURVEY AUGUST 9, 2023

#### TIME LIMITATION

THE TIME LIMIT ON DRAWING(S) APPROVAL SHALL BE TWELVE (12) MONTHS FROM THE DATE ON THE APPROVAL. IF CONSTRUCTION HAS NOT COMMENCED WITHIN STATED TIME, SD REQUIRES DRAWING(S) TO BE REVIEWED BY THE DEVELOPER/DESIGN ENGINEER AND RESUBMITTED TO SD FOR POSSIBLE CHANGES IN SPECIFICATIONS AND STANDARDS.

#### BASIS OF BEARINGS

CCS83 ZONE 5, NAD83(2011), EPOCH 2010.0

#### BENCHMARK

FD GLO BRASS CAP UP 0.6', CN  $\frac{1}{16}$  COR S.12, PER RS 103/74. ELEVATION DETERMINED VIA STATIC GPS OBSERVATION, PROCESSED THROUGH OPUS. NAVD-88 ELEV = 3066.588'

#### **UTILITY PROVIDERS**

TELECOMM:	FRONTIER COMMUNICATIONS	(855) 226-5799
WATER:	SAN BERNARDINO COUNTY -	(909) 386-8800
	SPECIAL DISTRICTS DEPARTMENT	
ELECTRIC:	SOUTHERN CALIFORNIA EDISON	(800) 655-4555
GAS:	SOUTHERN CALIFORNIA GAS CO.	(213) 231-1840

#### PROJECT SPECIFIC DESIGN CRITERIA

DUE TO PROJECT CONSTRAINTS, THE FOLLOWING DESIGN DECISIONS WERE COORDINATED AND EVALUATED WITH PROJECT STAKEHOLDERS IN CONSULTATION WITH THE SAN BERNARDINO COUNTY SPECIAL DISTRICTS DEPARTMENT.

- FIRE WATER SUPPLY WILL NOT BE PROVIDED DURING CONSTRUCTION OF THE REPLACEMENT TANK. THE
- TEMPORARY WATER STORAGE PROVIDES DOMESTIC DEMAND ONLY.
- 2. TANK SIZE WAS SELECTED BASED ON DOMESTIC USER DEMANDS, EXISTING HYDRAULIC PROFILE, AND WATER TURNOVER. THE TANK IS NOT SIZED TO PROVIDE FIRE STORAGE PER DISCUSSIONS WITH SAN BERNARDINO COUNTY FIRE DEPARTMENT.

#### DESIGN STANDARDS

#### GOVERNING CODES

CALIFORNIA BUILDING CODE - VOLUMES 1 AND 2 (2022)

AMERICAN WATER WORKS ASSOCIATION (AWWA) D103 STANDARD

NATIONAL ELECTRICAL CODE (2022)

AWWA C151 STANDARD

#### AWWA C900 STANDARD

NATIONAL ELECTRICAL CODE (2022)

#### SAN BERNARDINO COUNTY STANDARD DRAWINGS

- STANDARD RESTRAINT TEES. DEAD ENDS & BENDS FOR PVC C-900. STANDARD RESTRAINT TEES. DEAD ENDS & BENDS FOR PVC C-900.
- H-3D
- H-20 CHAIN LINK GATE DETAIL

WAS, DIVISION MANAGER

APPR. DATE

DESCRIPTION

07/17/2024

H-19	CHAIN LINK FENCE DET
	OLIABALI BUZ OATE DETA

UNDERGROUND	SERVICE ALERT	BENCHMARK: CCS83 ZONE 5, NAD83(2011), EPOCH 2010.0	BASIS OF BEARINGS: FD GLO BRASS CAP UP 0.6', CN 1/16 COR S.12, PER RS 103/74.	CEVE	Kimley» Horn	REVISIONS  ADDENDUM NO. 2  ADDENDUM NO. 5	6/24 6/24	WATER TANK REPLACEMENT PLANS A SAN BERNARDINO COUNTY - P SPECIAL DISTRICT	UBLIC WORKS	WATER TANK REPLACEMENT PLANS	DWG NO. 30.30.00157
	Call: TOLL FREE 1-800-227-2600		ELEVATION DETERMINED VIA STATIC GPS OBSERVATION, PROCESSED THROUGH	02 C71474 C71474	401 B STREET, SUITE 600, SAN DIEGO, CA 92101 PHONE: (619) 234-9411 WWW.KIMLEY-HORN.COM		ASSISTA	ANT DIRECTOR	07/18/2024	APN: 0580-241-16-0000 MORONGO VALLEY WATER TANK	FILE NO.
	OR 811		OPUS.		PREPARED, UNDER THE SUPERVISION OF:			REVIEWER	INITIAL DATE	REPLACEMENT PROJECT	SD003
	011		NAVD-88 ELEV = 3066.588'	STVIL			APPROV	VALS PROJECT MANAGER	07/16/2024	GENERAL NOTES	
TIME IMPRIME DAY	(0. DEE0.DE VOU DIO			OF CALIFORNIA	04/10/2024		7,111,01	PM, DIVISION MANAGER	07/16/2024	GENERAL NOTES	SHEET 2 OF 17
TWO WORKING DAY	YS BEFORE YOU DIG				SARP SEKEROGLU R.C.E. No. 71474 EXP. 12/31/2025	DECODIDATION	ADDD DATE	WAS DIVISION MANAGED	07/17/2024		

#### CONSTRUCTION NOTES AND QUANTITIES

BID ITEM NUMBER	CONSTRUCTION NOTE NUMBER	ITEM	UNITS	TOTAL
1	N/A	MOBILIZATION	LS	1
2	1	TEMPORARY POLYETHYLENE TANK (7,510 GALLONS)	EA	3
3	7	BOLTED STEEL WATER STORAGE TANK WITH OPERATIONAL VOLUME OF 139,112 GALLONS	EA	1
4	DEMO ②	DEMOLITION AND DISPOSAL OF EXISTING BOLTED STEEL WATER TANK	LS	1
5	(14)	EXCAVATION AND BACKFILL	LS	1
6	SEE EROSION CONTROL NOTES	EROSION AND SEDIMENTATION CONTROL	LS	1
7	14) 27	REINFORCED CAST IN PLACE CONCRETE FOR TANK FOUNDATION	CY	65*
8	(14) (27)	SAND AND CRUSHED AGGREGATE BASE FOR TANK FOUNDATION	LS	1
9	10)	8" DI GV	EA	1
10	34)	6" DI GV	EA	1
11	(15)	INSTALL 8" FORCE BALANCED FLEXIBLE EXPANSION JOINT	EA	1
12	35)	INSTALL 6" FORCE BALANCED FLEXIBLE EXPANSION JOINT	EA	1
13	23	REMOVABLE PROTECTION POSTS	EA	15
14	②8 & SEE ELECTRICAL PLANS	ELECTRICAL AND TRANSDUCER REINSTALLATION	LS	1
15	SEE TEMP TANK MECHANICAL PLAN	TEMPORARY PIPING AND VALVES AND TEMP DEMOBILIZATION	DAY	7
16 2 *NOTE: FIND QUANTITY TO BE	SEE SITE AND MECHANICAL PLAN  45  E DETERMINED BY TANK MANUFACTURER.	MISCELLANEOUS PIPING SPOOLS AND FITTINGS  8 INCH THICK CONCRETE PAD. #4 BARS 18 INCH O.C. EACH WAY	LS	1 11

### Remarks:


1. Bid line items 2, 15, and 17 are excluded from this scope, as they will be done "In-House" by Department of Public Works Special Districts - Water and Sanitation Division. RV 07-02-2024.



BENCHMARK: CCS83 ZONE 5, NAD83(2011), EPOCH 2010.0

BASIS OF BEARINGS: FD GLO BRASS CAP UP 0.6', CN 1/16 COR S.12, PER RS 103/74. ELEVATION DETERMINED VIA STATIC GPS
OBSERVATION, PROCESSED THROUGH

NAVD-88 ELEV = 3066.588'

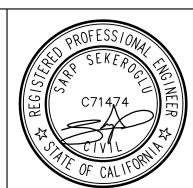

Kin	nley»	»Hori	1
401 B STREET PHONE: (619)	·	SAN DIEGO, C WWW.KIMLEY-H	
PREPARED UNDER THE S	UPERVISION OF:		04/10/2024
SARP SEKEROGLU	R.C.E. No. 71474	EXP. 12/31/2025	

		REVISIONS
6/24 S/		ADDENDUM NO. 2
6/24		ADDENDUM NO. 5
ASSISTANT DIRE		
7,000017,111 51112		
APPROVALS		
PPR. DATE	APPR.	DESCRIPTION

-0.700
07/18/20
SPECIAL DISTRICTS
AN BERNARDINO COUNTY - PUBLIC WORKS
WATER TANK REPLACEMENT PLANS APPROVED BY:

PM, DIVISION MANAGER

WAS, DIVISION MANAGER


ATER TANK REPLACEMENT PLANS APPROVED BY:  ERNARDINO COUNTY - PUBLIC WORKS  SPECIAL DISTRICTS		(S	WATER TANK REPLACEMENT PLANS
		07/18/2024	APN: 0580-241-16-0000 MORONGO VALLEY WATER TANK
REVIEWER	INITIAL	DATE	REPLACEMENT PROJECT
PROJECT MANAGER		07/16/2024	OUANTITIES

07/16/2024


07/17/2024

	30.30.00157
: 0580-241-16-0000 O VALLEY WATER TANK ACEMENT PROJECT	FILE NO. SD003
QUANTITIES	SHEET <b>3</b> OF <b>17</b>

DWG NO.

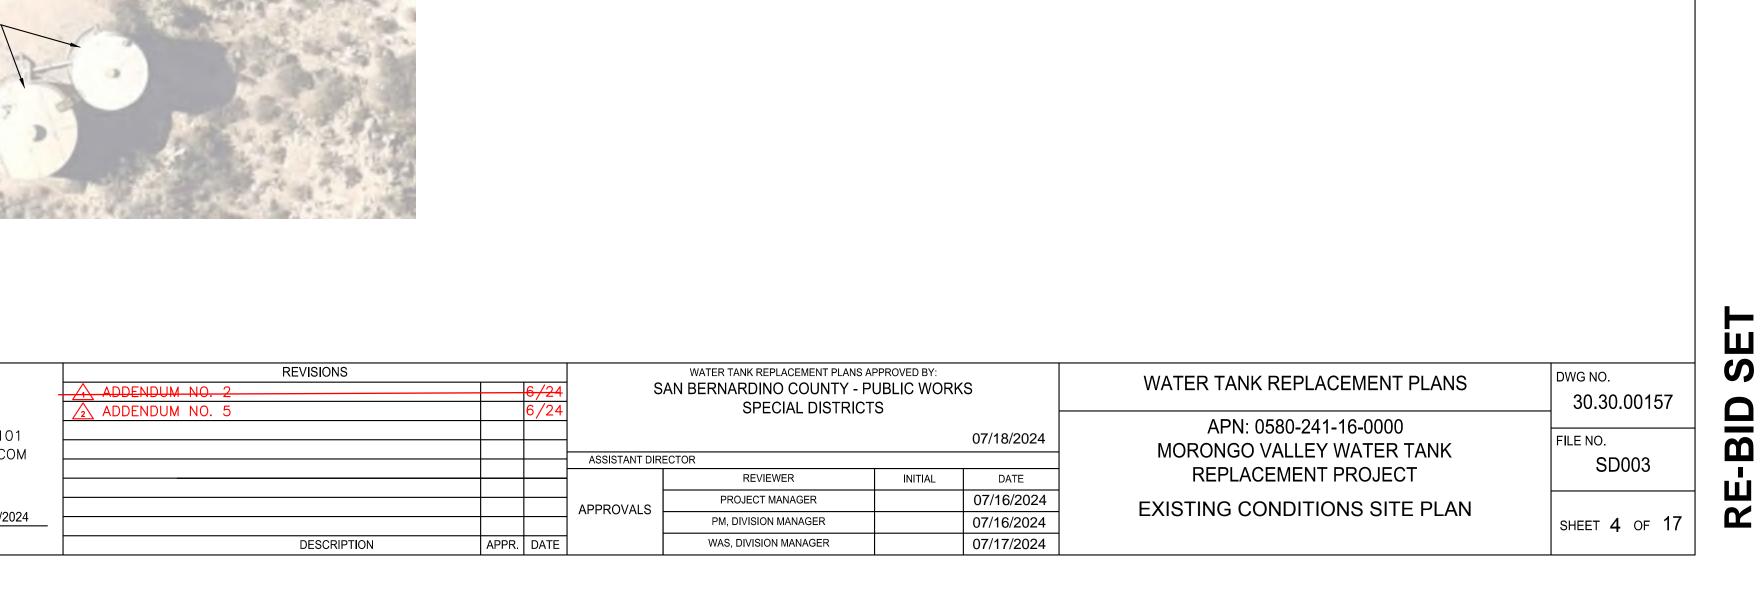



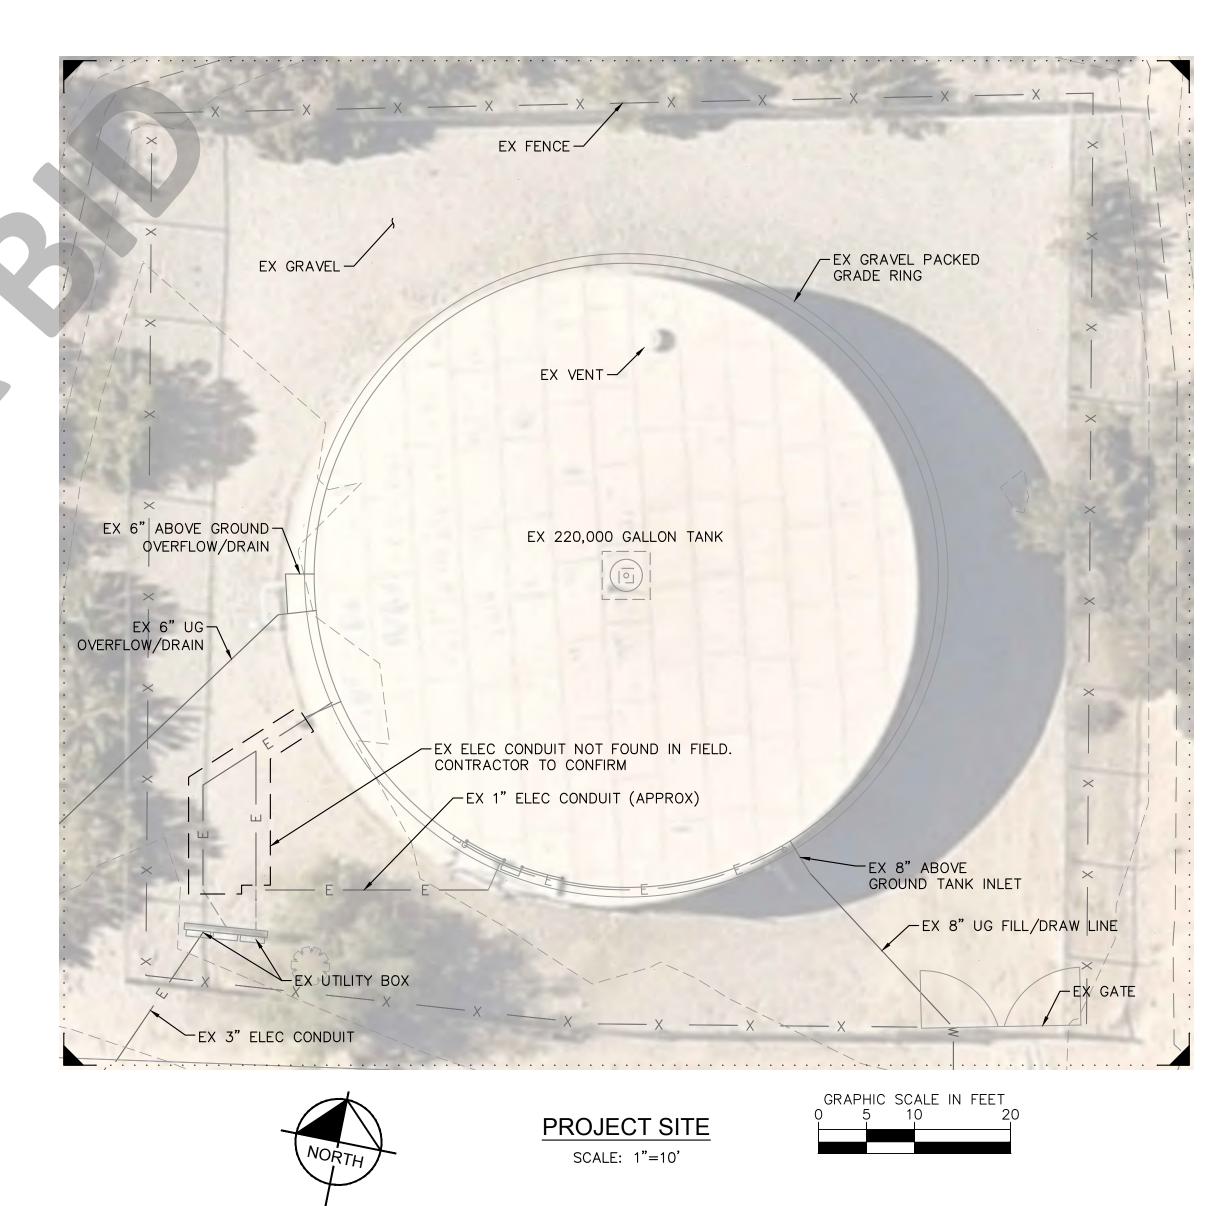



UNDERGROUND SERVICE ALERT

TWO WORKING DAYS BEFORE YOU DIG

Call: TOLL FREE 1-800-227-2600 BENCHMARK: CCS83 ZONE 5, NAD83(2011), EPOCH 2010.0

BASIS OF BEARINGS: FD GLO BRASS CAP UP 0.6', CN 1/16 COR S.12, PER RS 103/74. ELEVATION DETERMINED VIA STATIC GPS OBSERVATION, PROCESSED THROUGH NAVD-88 ELEV = 3066.588'


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Kimley» Hor	n
401 B STREET, SUITE 600, SAN DIEGO, C PHONE: (619) 234-9411 WWW.KIMLEY-F	
PREPARED UNDER THE SUPERVISION OF:	
	04/10/202
SARP SEKEROGLU R.C.E. No. 71474 EXP. 12/31/2025	

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BID



WAS, DIVISION MANAGER

DESCRIPTION

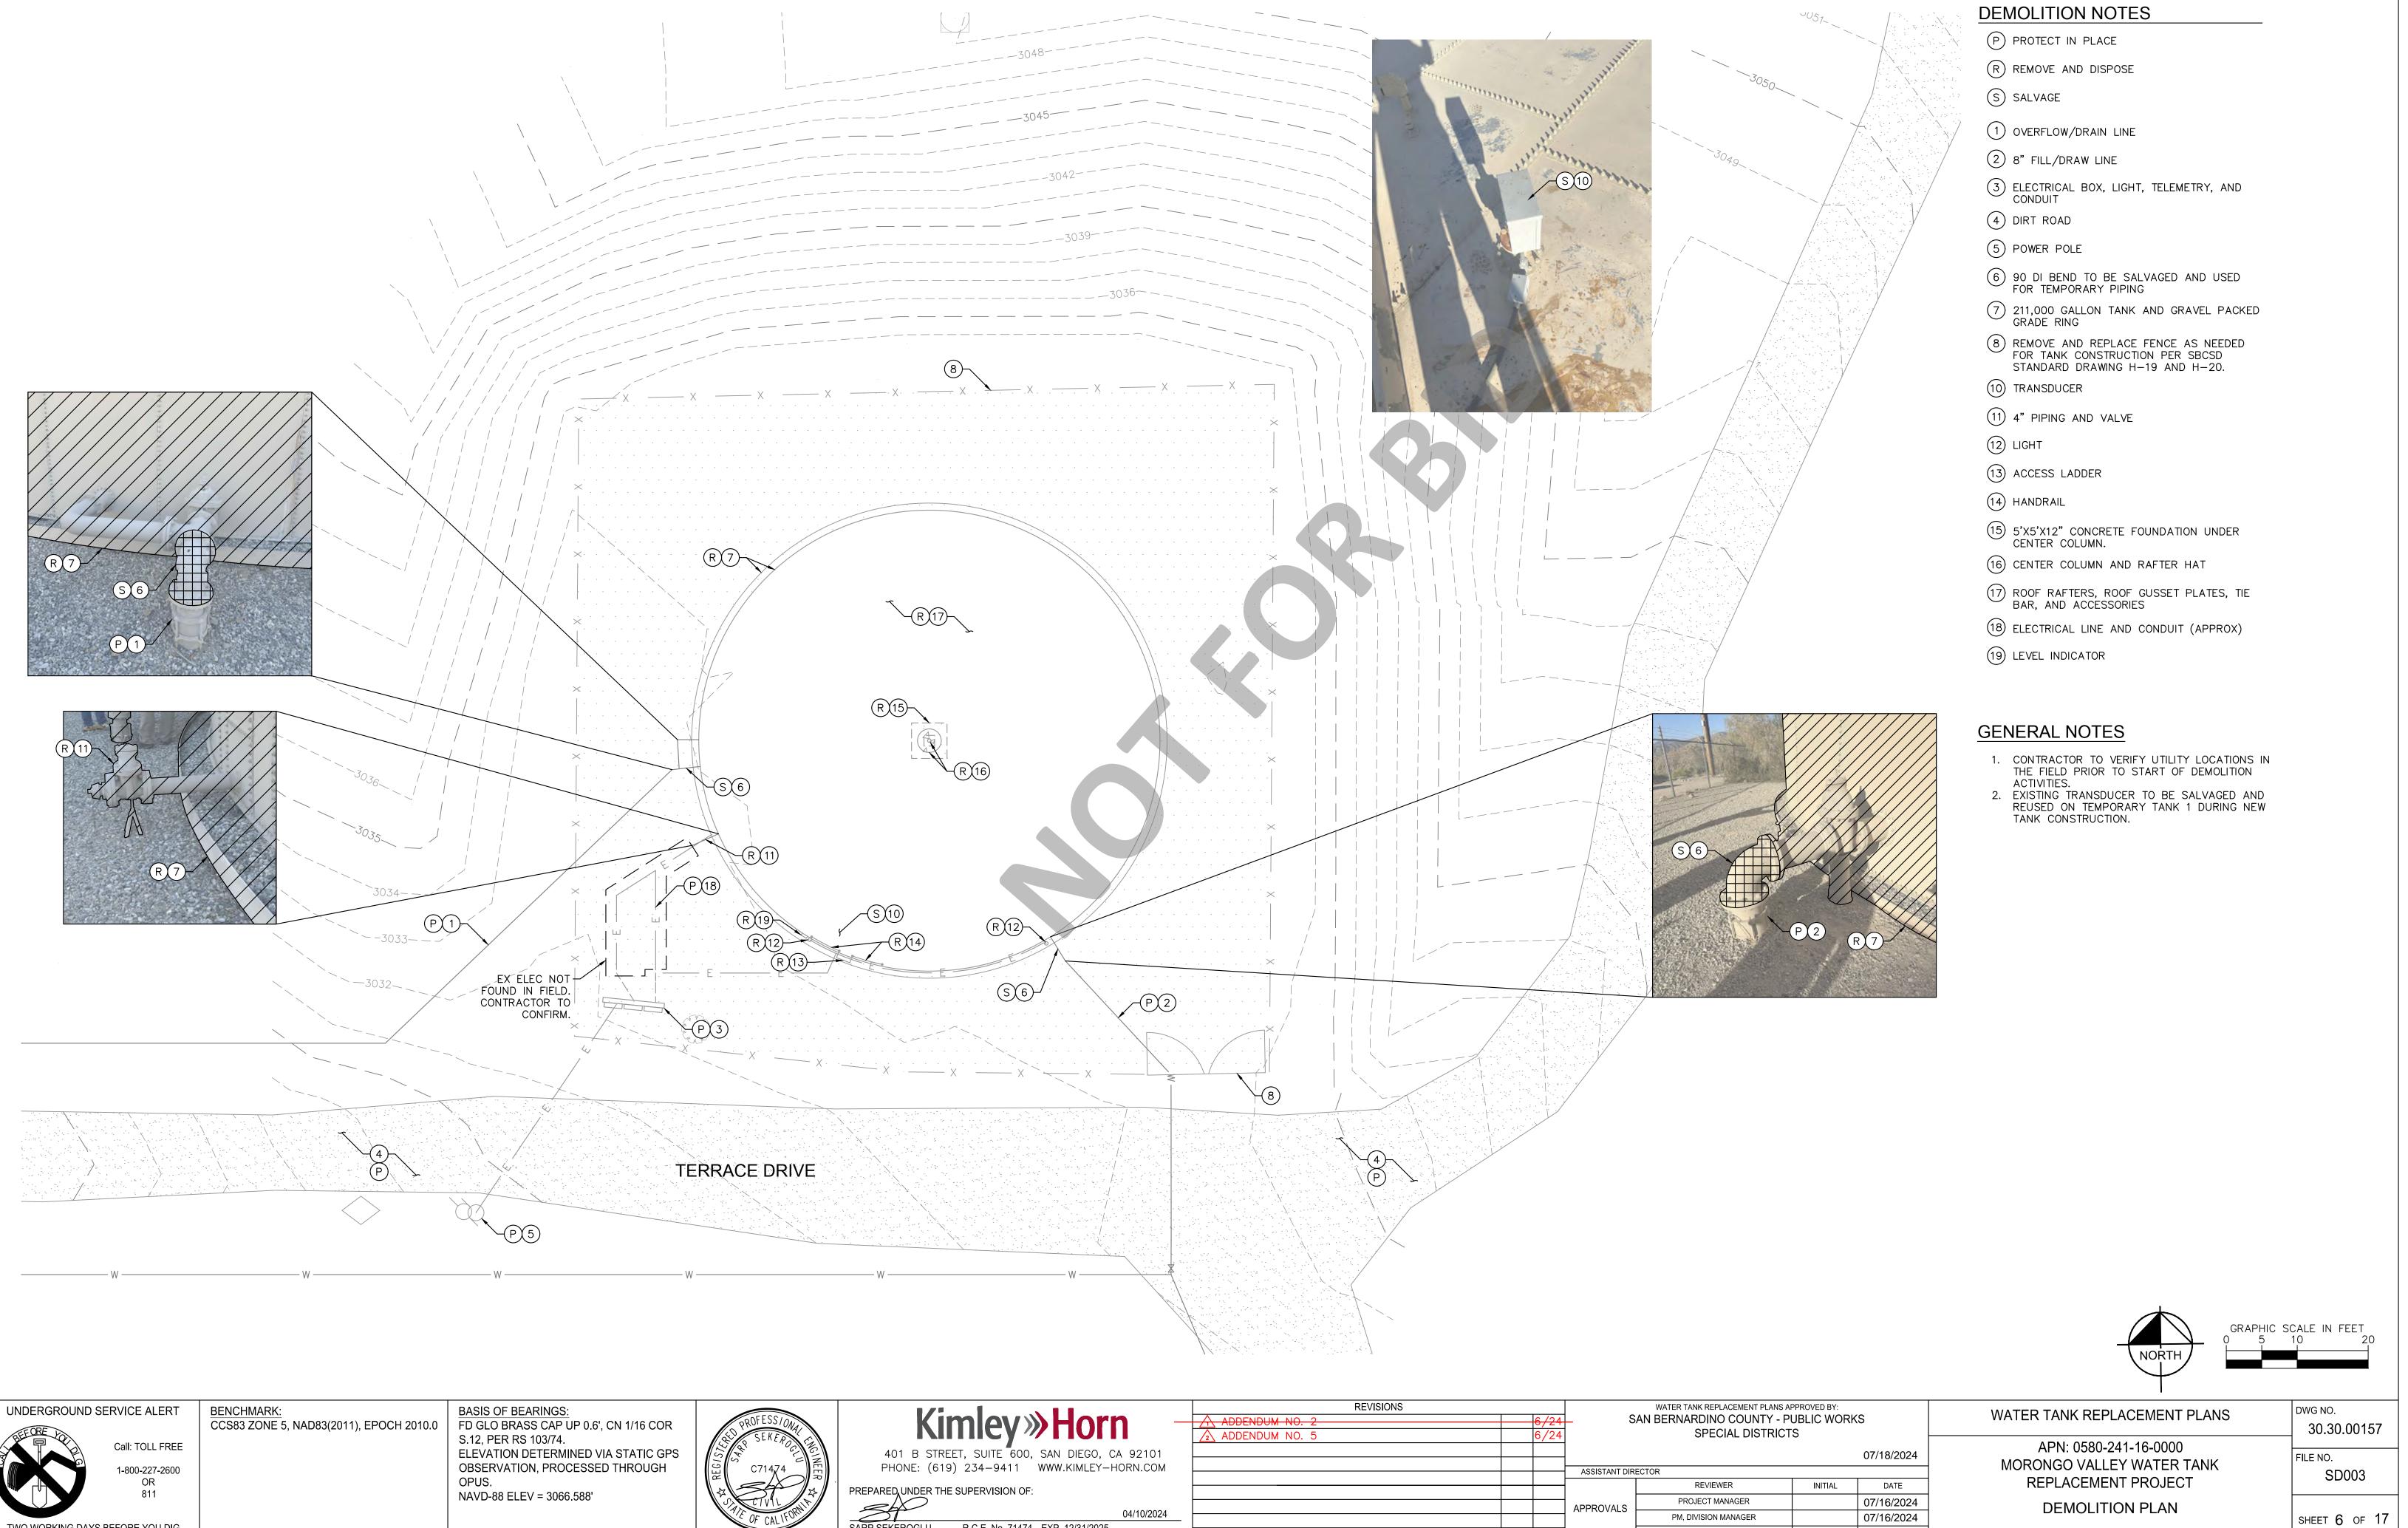
APPR. DATE

07/17/2024

R.C.E. No. 71474 EXP. 12/31/2025


TWO WORKING DAYS BEFORE YOU DIG

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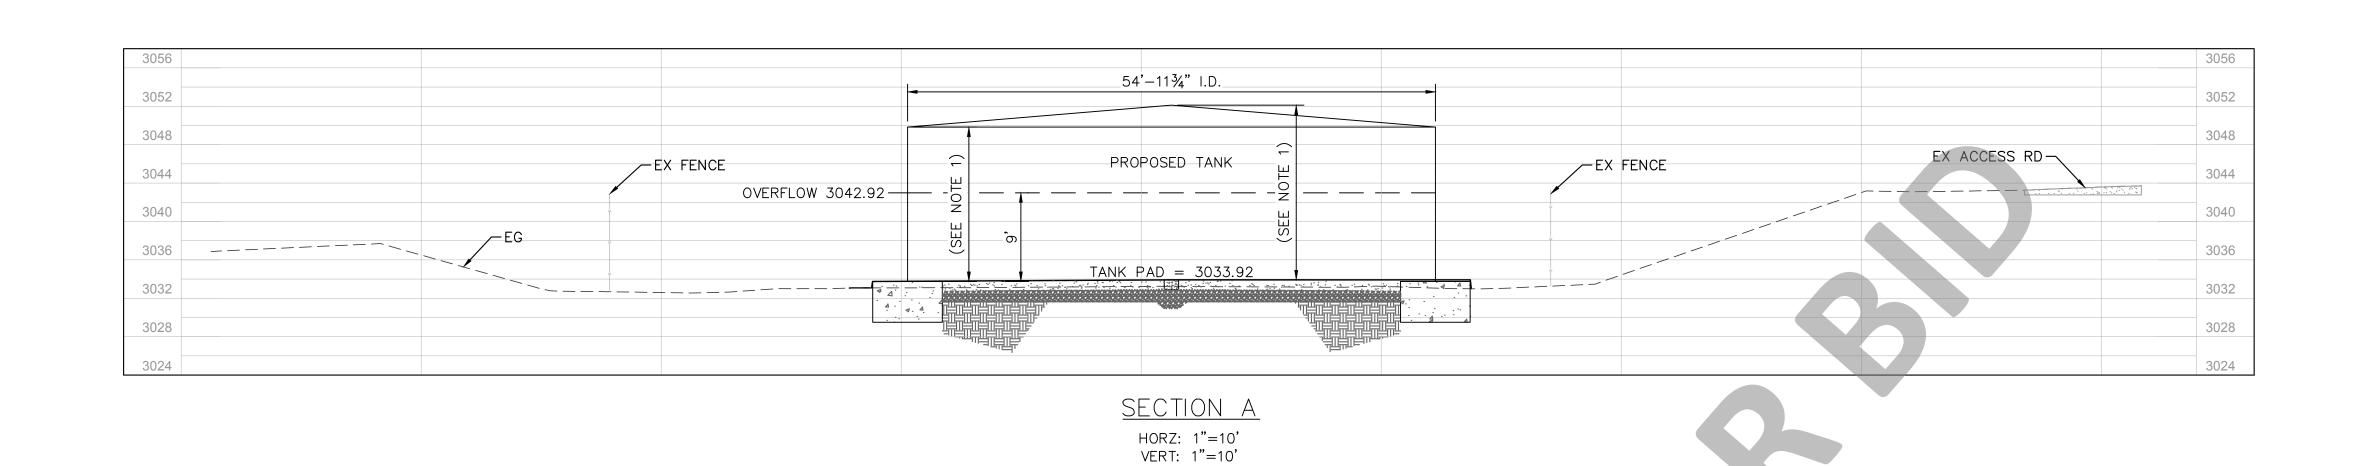
**GRADING NOTES** 

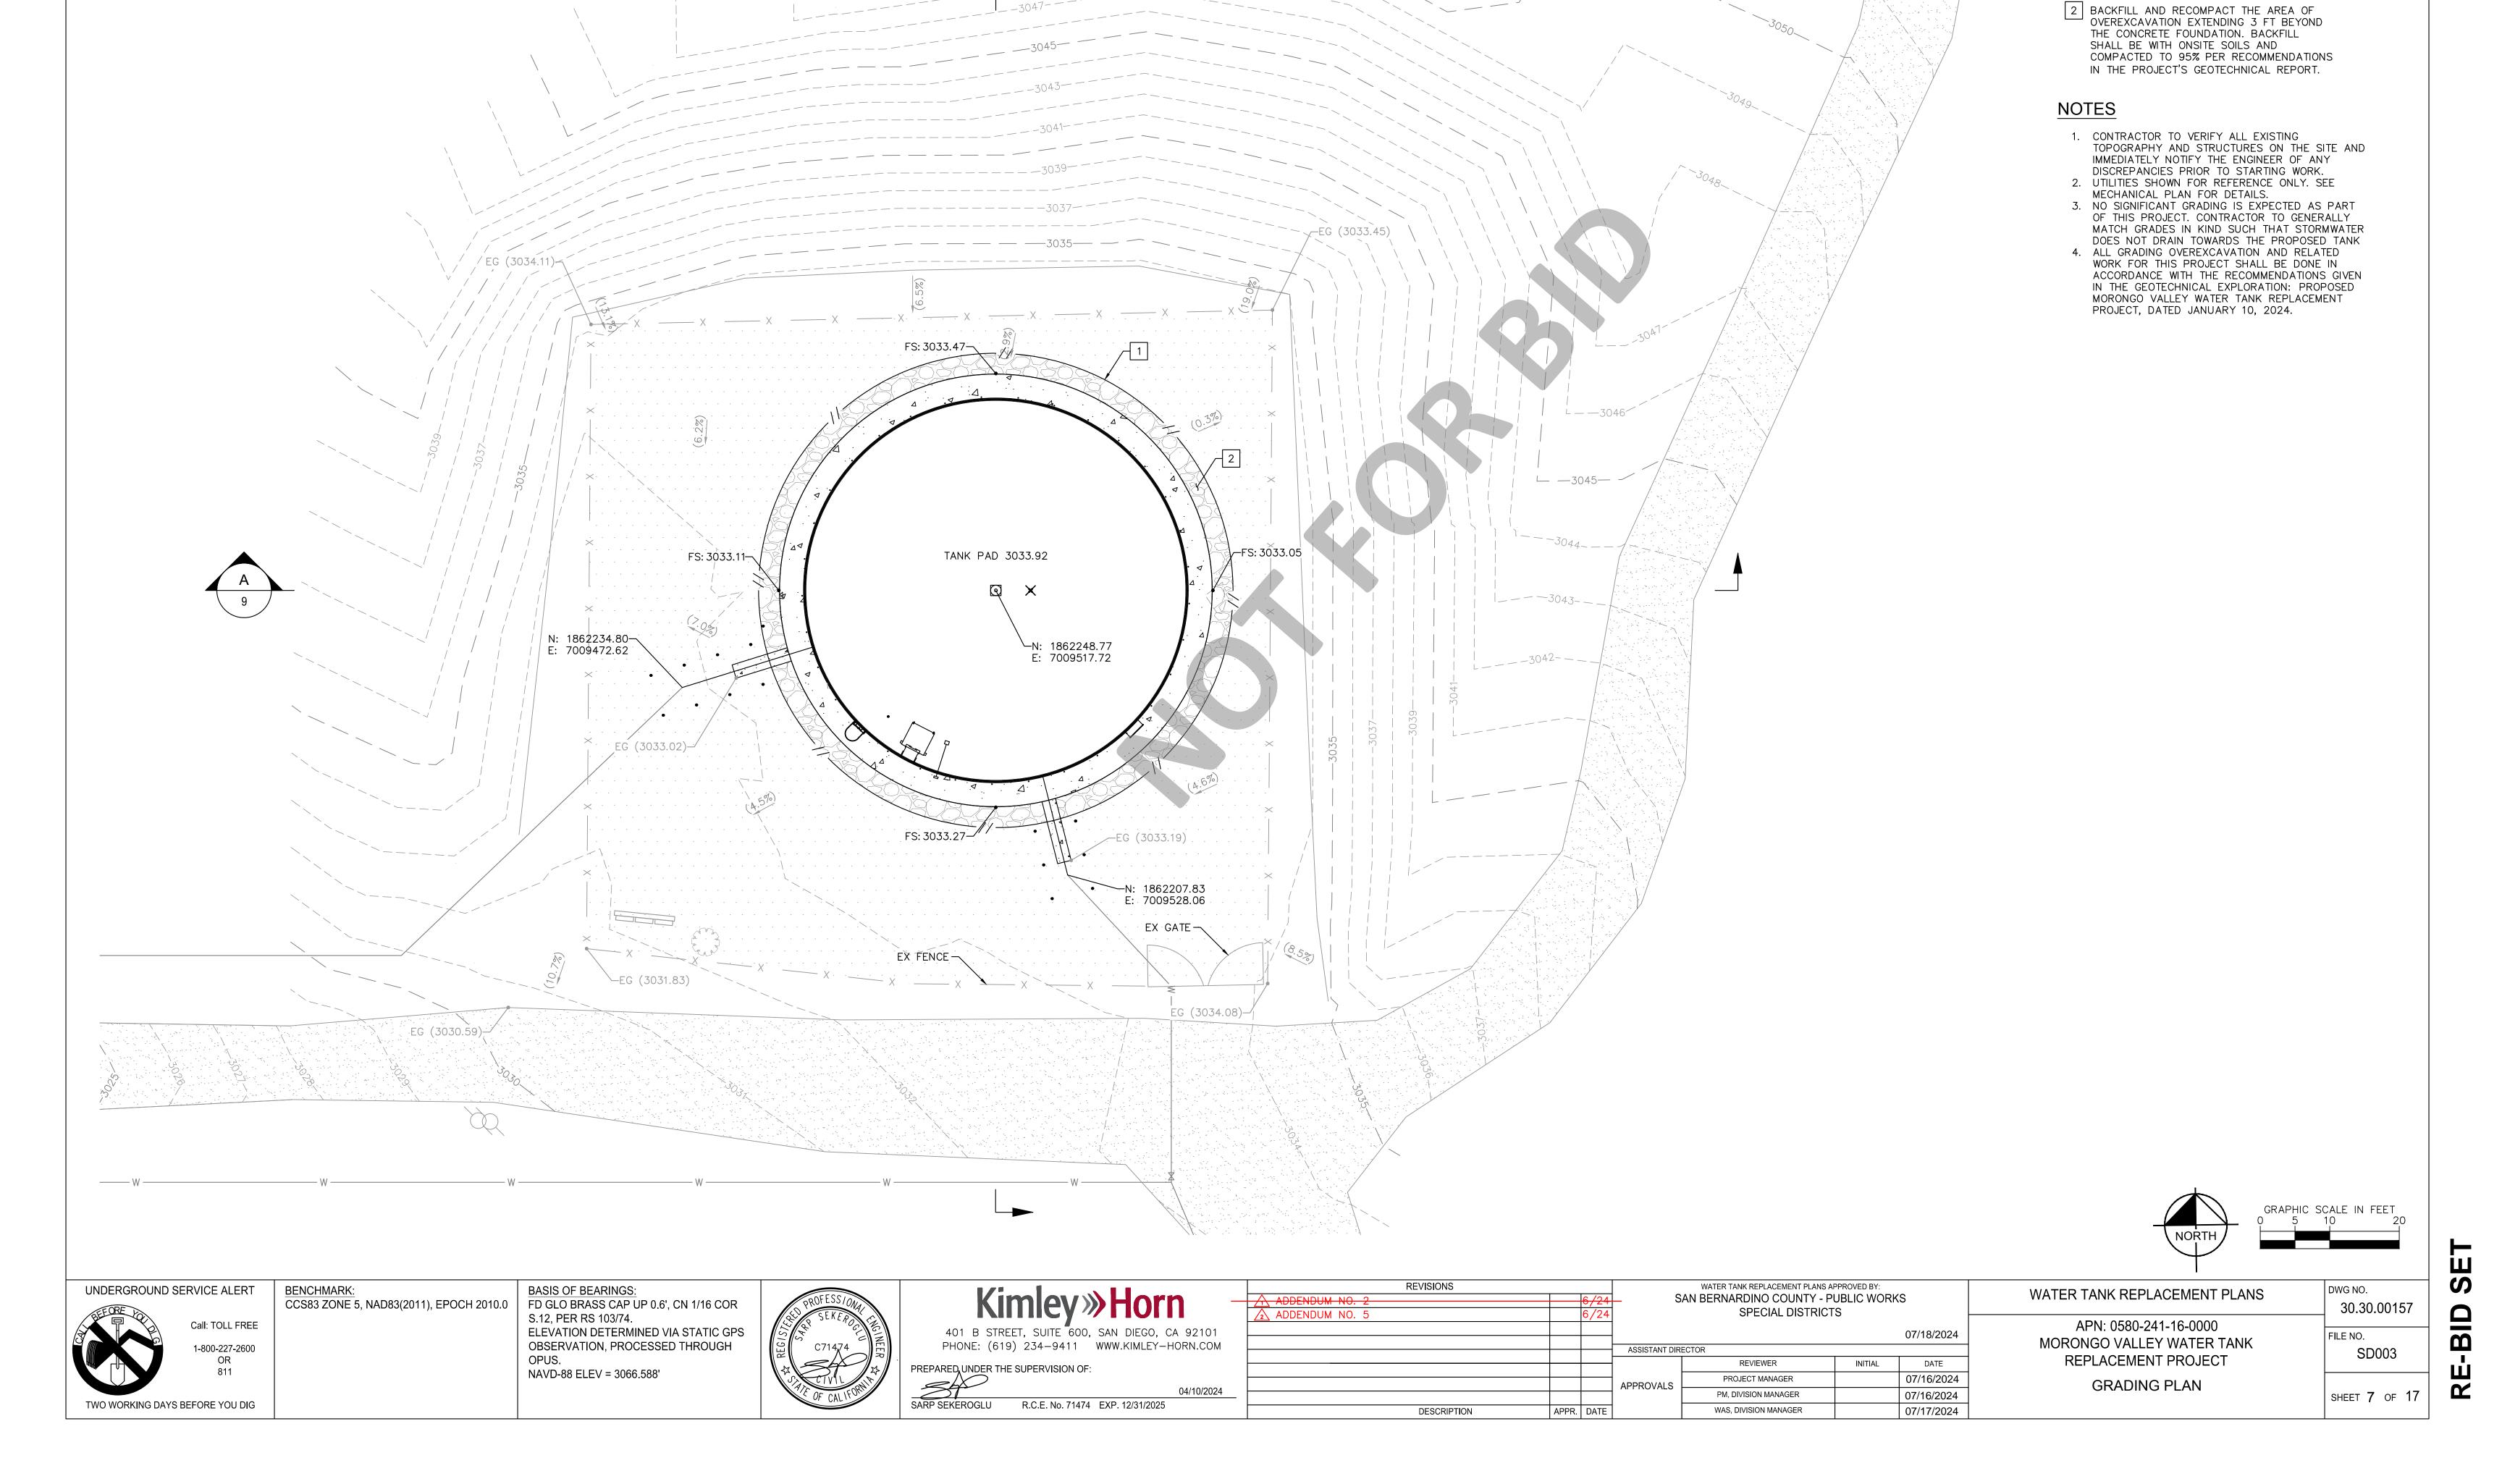
1 MATCH EXISTING GRADES AFTER EXCAVATION AND INSTALLATION OF TANK FOUNDATION




# 1. TANK HEIGHT SHALL BE CONFIRMED BY TANK SUPPLIER PRIOR TO FABRICATION. TANK HEIGHT IS SUBJECT TO CHANGE BASED ON SITE SPECIFIC SEISMIC DESIGN PARAMETERS TO BE DETERMINED BY TANK SUPPLIER
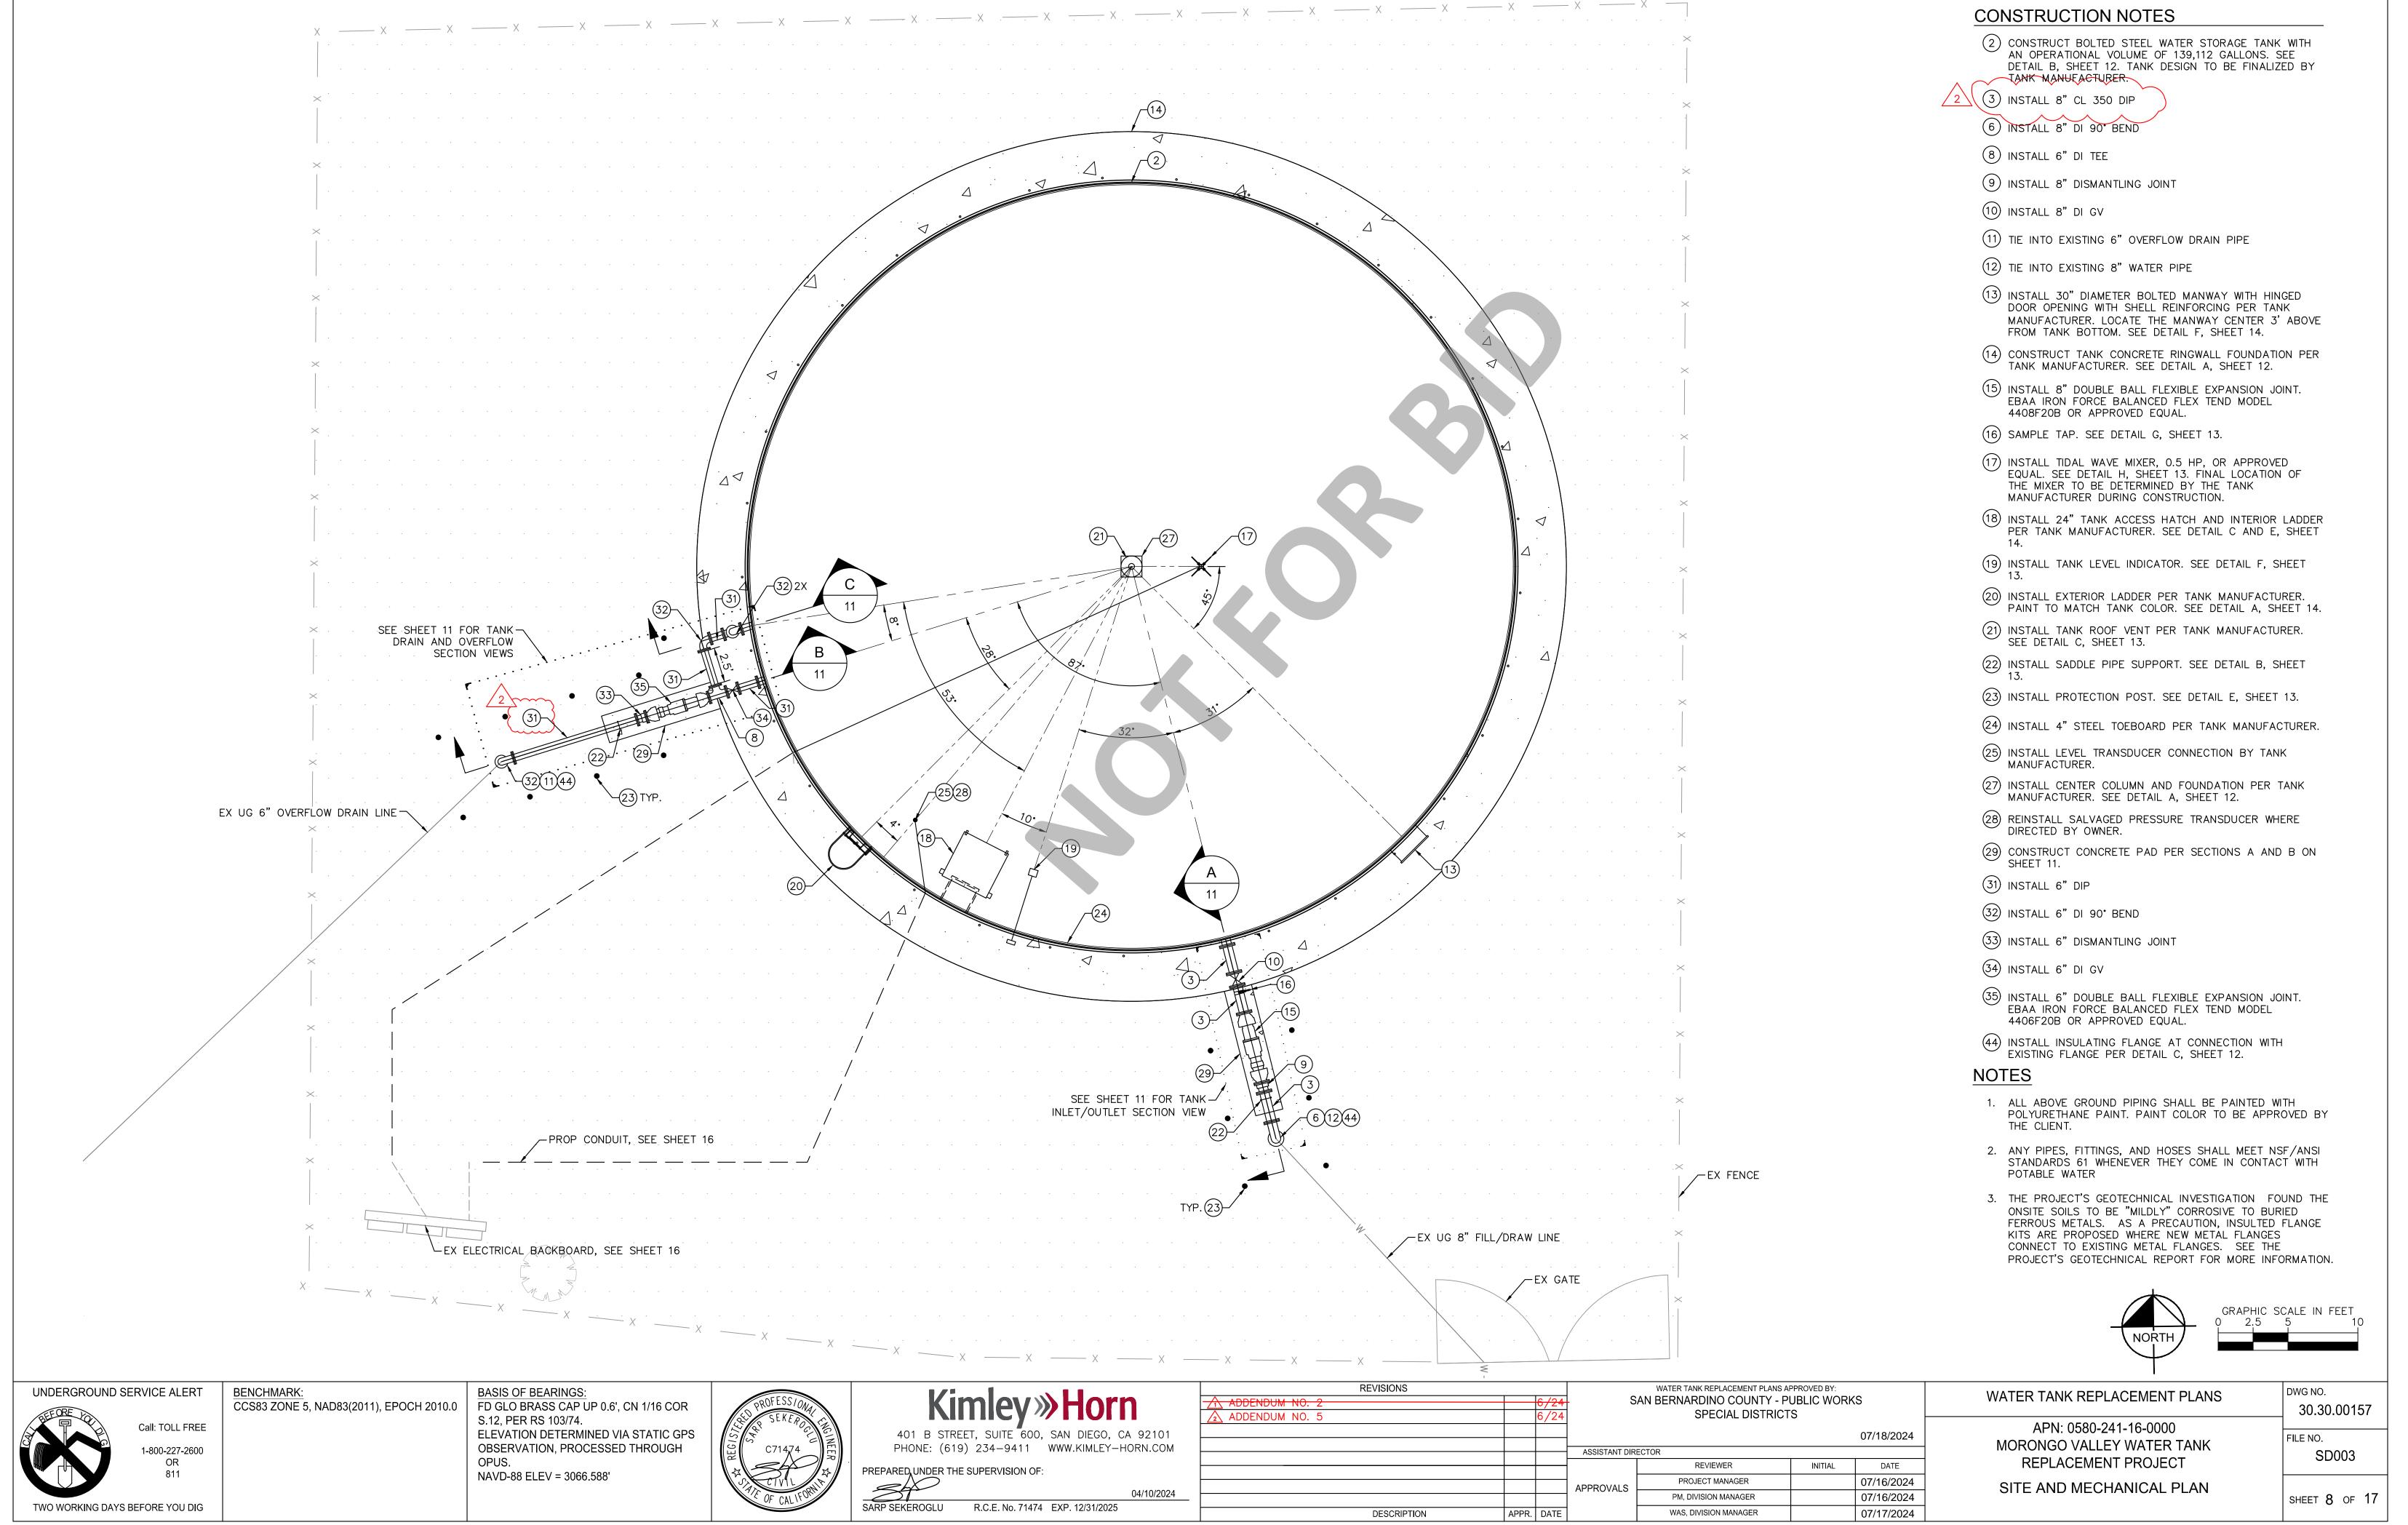
<u>NOTES</u>



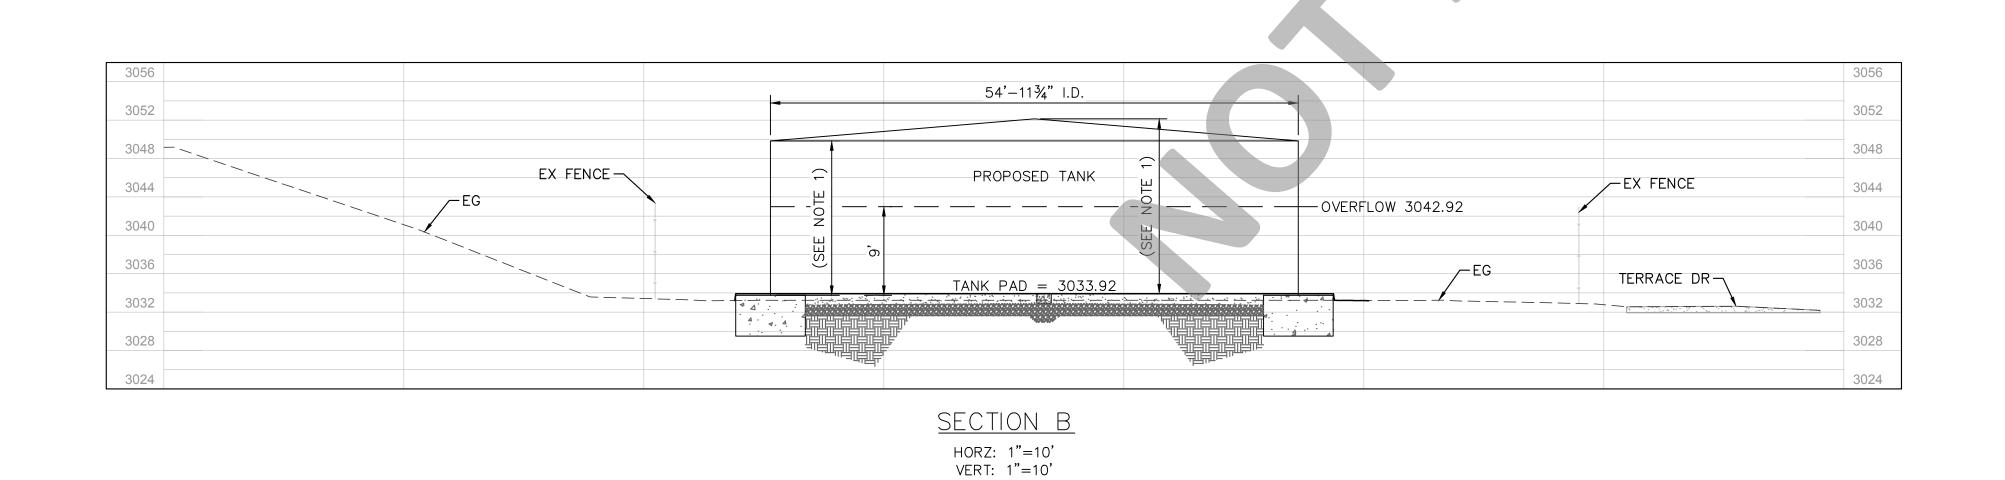

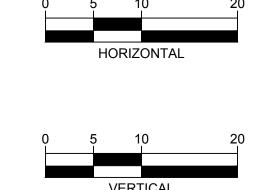

GRAPHIC SCALE IN FEET

UNDERGROUND	SERVICE ALERT
S S S S S S S S S S S S S S S S S S S	Call: TOLL FREE  1-800-227-2600  OR  811

TWO WORKING DAYS BEFORE YOU DIG

BENCHMARK: CCS83 ZONE 5, NAD83(2011), EPOCH 2010.0

BASIS OF BEARINGS:
FD GLO BRASS CAP UP 0.6', CN 1/16 COR
S.12, PER RS 103/74.
ELEVATION DETERMINED VIA STATIC GPS
OBSERVATION, PROCESSED THROUGH
OPUS.
NAVD-88 ELEV = 3066.588'




Kimley	<b>»Horn</b>
•	00, SAN DIEGO, CA 92101 WWW.KIMLEY-HORN.COM
REPARED UNDER THE SUPERVISION (	OF: 04/10/2024
ARP SEKEROGIU R C E No. 714	174 FXP 12/31/2025

			REVISIONS
- S <i>i</i>	6/24		ADDENDUM NO. 2
	6/24		ADDENDUM NO. 5
ASSISTANT DIRE			
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APPROVALS -			
	DATE	APPR.	DESCRIPTION
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S	AN BERNARDINO COUNTY - PI SPECIAL DISTRICT		<b>KS</b>	
			07/18/2024	
T DIR	ECTOR			
	REVIEWER	INITIAL	DATE	
LS -	PROJECT MANAGER		07/16/2024	
	PM, DIVISION MANAGER		07/16/2024	
	WAS, DIVISION MANAGER		07/17/2024	

WATER TANK REPLACEMENT PLANS APPROVED BY:

WATER TANK REPLACEMENT PLANS	DWG NO. 30.30.00157	
APN: 0580-241-16-0000 MORONGO VALLEY WATER TANK REPLACEMENT PROJECT	FILE NO. SD003	
TANK SECTIONS	SHEET 9 OF 17	

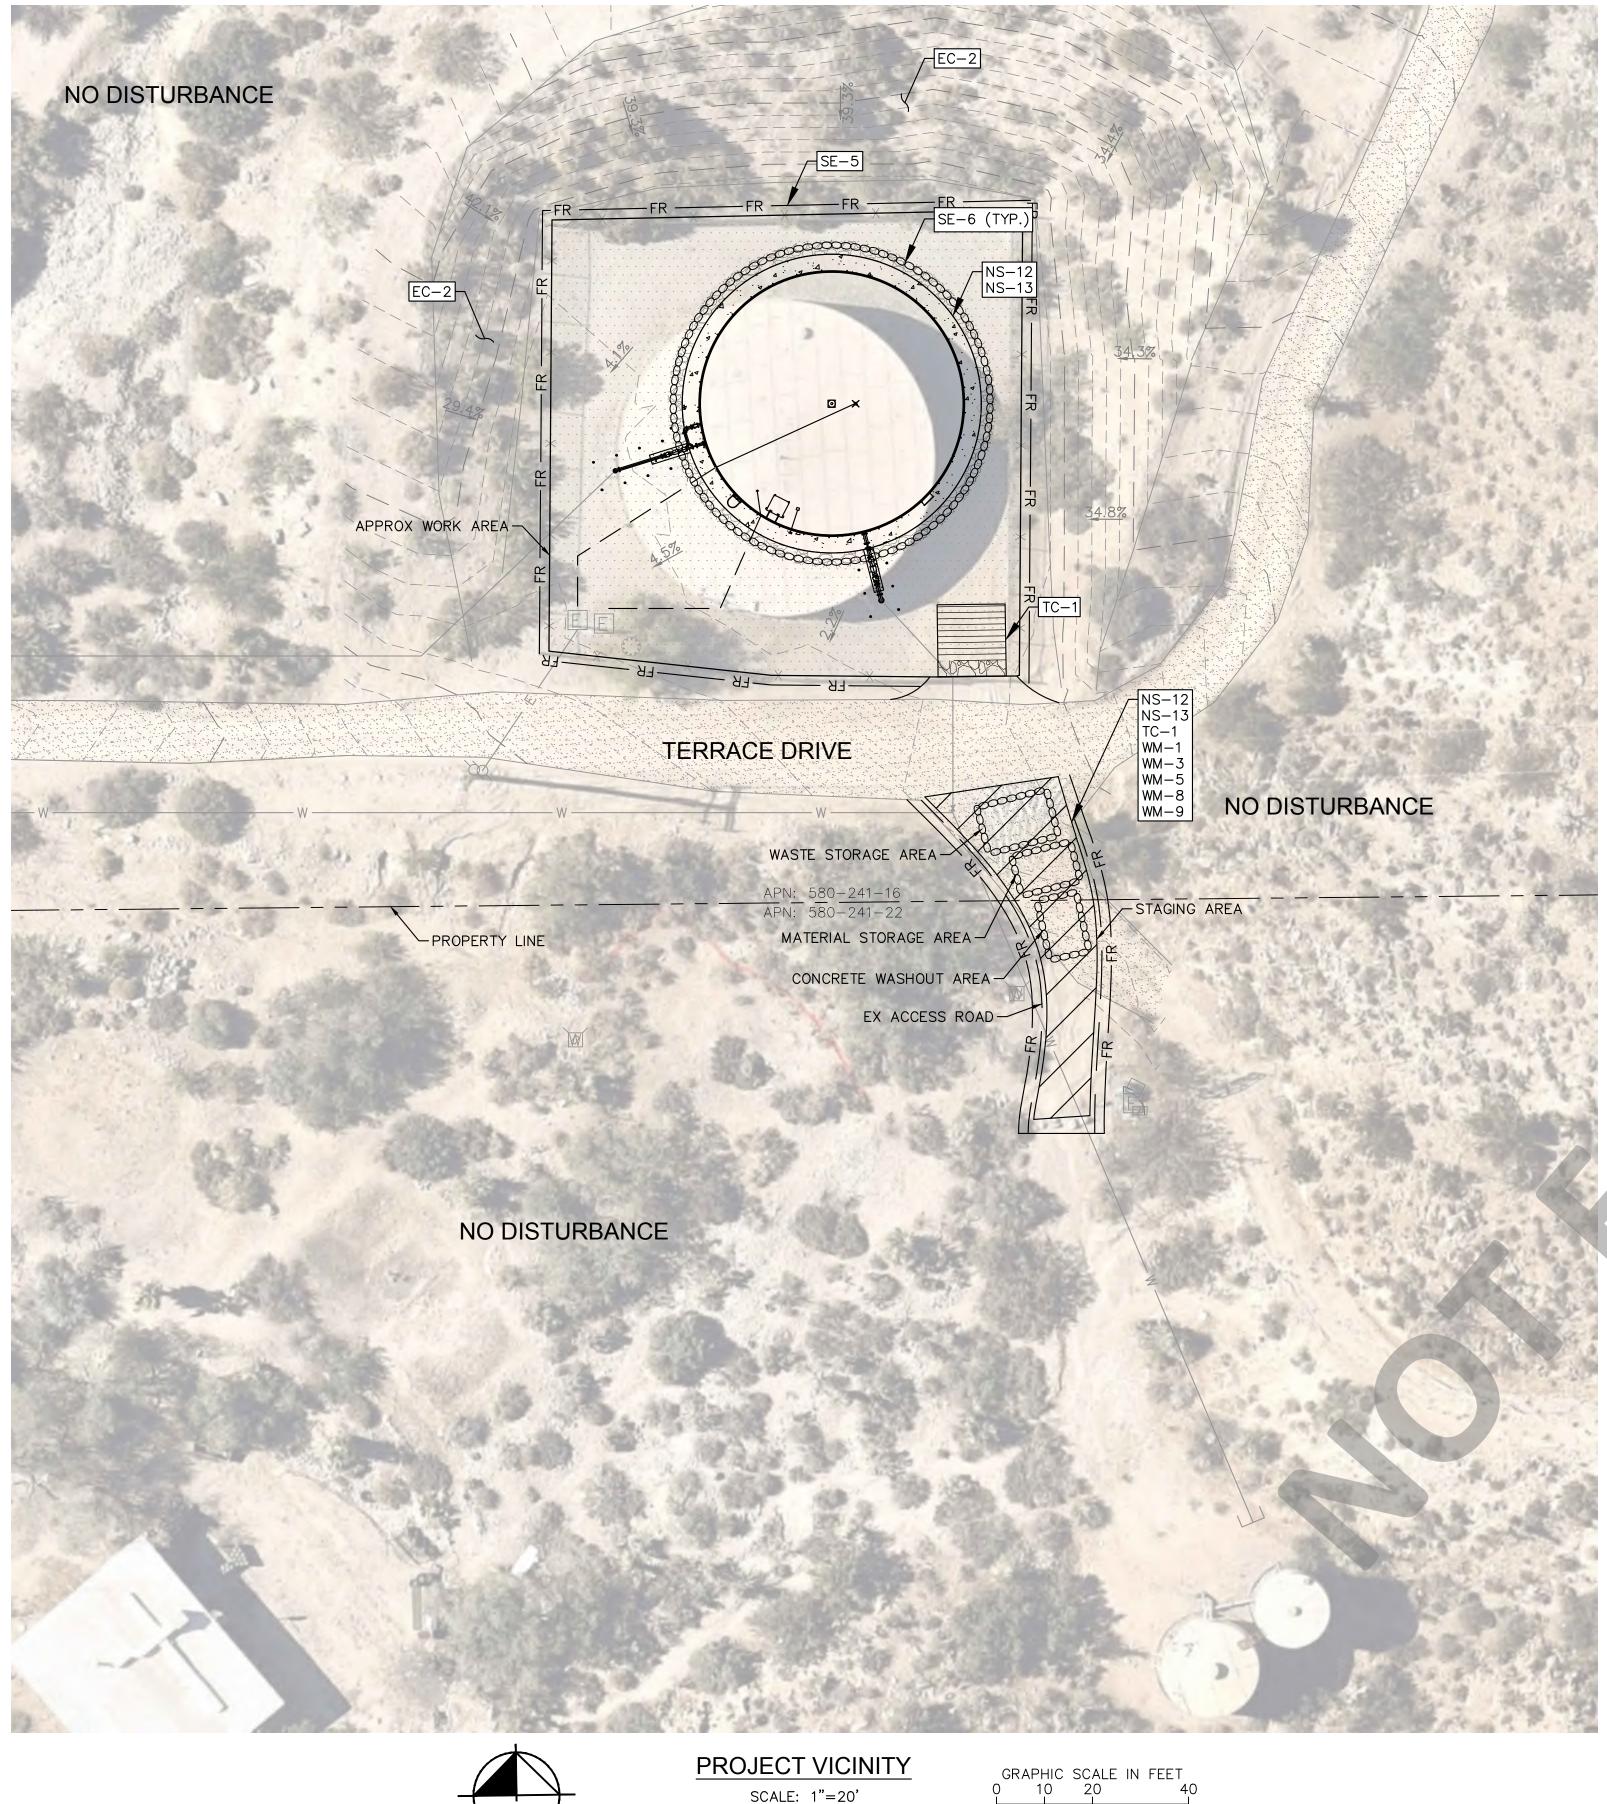

#### **EROSION CONTROL NOTES**

- 1. THE EROSION CONTROL SYSTEMS REQUIRE CERTIFICATION BY THE ENGINEER OF RECORD. SUCH CERTIFIED SYSTEMS SHALL BE COMPLETED, INSPECTED, AND IN PLACE NO LATER THAN OCTOBER 15. ALL EROSION CONTROL SYSTEMS SHALL REMAIN IN PLACE AT ALL TIMES FOR ALL AREAS IN WHICH CONSTRUCTION IS NOT SCHEDULED TO COMMENCE WITHIN THE NEXT SEVEN (7) DAYS. ALL EROSION CONTROL SYSTEMS SHALL REMAIN IN PLACE UNTIL (APRIL 15).
- 2. THE CONTRACTOR, PERMITEE, OR OWNER SHALL BE RESPONSIBLE FOR THE INSPECTION, MODIFICATION, AND PROPER MAINTENANCE OF THE EROSION CONTROL DEVICES NECESSARY. IN THE EVENT OF FAILURE OR REFUSAL TO PROPERLY MAINTAIN SAID DEVICES, THE CITY ENGINEER MAY CAUSE EMERGENCY MAINTENANCE WORK TO BE DONE TO PROTECT ADJACENT PRIVATE AND PUBLIC PROPERTY, THE COST (INCLUDING AN INITIAL MOBILIZATION AMOUNT) OF WHICH SHALL BE CHARGED
- 3. ALL EROSION CONTROL MEASURES REQUIRED TO RETAIN SEDIMENT ON-SITE AND TO SAFELY DISCHARGE ANY ACCELERATED RUNOFF GENERATED BY THE PROJECT SHALL BE INSTALLED DURING THE INITIAL CONSTRUCTION PHASE OF THE PROJECT.
- 4. TEMPORARY EROSION CONTROL DEVICES SHOWN ON THE EROSION CONTROL PLAN WHICH INTERFERE WITH THE WORK SHALL BE RELOCATED OR MODIFIED AS THE WORK PROGRESSES AS RECOMMENDED BY THE ENGINEER OF WORK AND AS APPROVED BY THE COUNTY ENGINEER.
- 5. ALL REMOVABLE PROTECTION DEVICES SHOWN SHALL BE IN PLACE AT THE END OF EACH WORKING DAY WHEN THE 5-DAY RAIN PROBABILITY FORECAST EXCEEDS 40-PERCENT.
- 6. EROSION CONTROL SYSTEMS SHALL BE SERVICED AND MAINTAINED TO PROVIDE CONTINUOUS CAPACITY AND ADEQUACY TO FUNCTION AS DESIGNED. AFTER PRECIPITATION EXCEEDING ONE QUARTER  $(\frac{1}{4})$  INCH IN ANY 12—HOUR PERIOD, OR UPON DIRECTION OF THE COUNTY ENGINEER, SILT AND DEBRIS SHALL BE REMOVED FROM CHECK DAMS AND DESILTING BASINS AND THE BASINS PUMPED DRY AND OTHERWISE RESTORED TO THE ORIGINAL DESIGN CONDITION.
- 7. PAVED STREETS, SIDEWALKS, AND OTHER IMPROVEMENTS SHALL BE MAINTAINED IN A NEAT AND CLEAN CONDITION, FREE OF LOOSE SOIL, CONSTRUCTION DEBRIS, AND TRASH. STREET SWEEPING OR OTHER EQUALLY EFFECTIVE MEANS SHALL BE USED ON A REGULAR BASIS TO CONTROL EROSION. WATERING SHALL NOT BE USED TO CLEAN STREETS EXCEPT FOR THE REMOVAL OF FINE MATERIAL NOT OTHERWISE REMOVED BY WEEPING OR OTHER MECHANICAL MEANS.
- 8. STAND-BY CREWS SHALL BE ALERTED BY THE CONTRACTOR, PERMITTEE, OR OWNER FOR EMERGENCY WORK DURING RAINSTORMS.
- 9. GRAVEL BAGS AND NECESSARY MATERIALS IN ACCORDANCE WITH THE APPROVED PLANS, SHALL BE AVAILABLE ONSITE AND STOCKPILED AT CONVENIENT LOCATIONS TO FACILITATE RAPID CONSTRUCTION OF TEMPORARY DEVICES OR TO REPAIR ANY DAMAGED EROSION CONTROL MEASURES WHEN RAIN IS IMMINENT. A STAND-BY CREW SHALL BE MADE AVAILABLE AT ALL TIMES DURING THE RAINY SEASON.
- 10. ALL UTILITY TRENCHES SHALL BE BACKFILLED WITHIN 24 HOURS AND MUST BE BACKFILLED BEFORE THE END OF THE WORKDAY IF A 40-PERCENT CHANCE OF RAIN IS PREDICTED.
- 11. A GRAVEL BAG SILT BASIN OR TRAP SHALL BE PROVIDED AT EVERY STORM DRAIN INLET TO PREVENT SEDIMENT FROM ENTERING THE STORM DRAIN SYSTEM.
- 12. ALL EROSION CONTROL PLANS MUST PROVIDE A 24-HOUR TELEPHONE NUMBER AND THE NAME(S) OF THE PERSON(S) RESPONSIBLE FOR EMERGENCY WORK. A TELEPHONE ANSWERING MACHINE OR ANSWERING SERVICE IS UNACCEPTABLE.

#### **EROSION CONTROL LEGEND**

BMP FACT SHEET*	NAME	SYMBOL
SE-5	TYPE 1 TEMPORARY FIBER ROLLS	——FR ——
SE-6	TEMPORARY GRAVEL BAGS	.00000000000000000000000000000000000000
[WM-1]	MATERIALS STORAGE AND STAGING AREA	
N/A	APPROX ACCESS AND BUILDING ENVELOPE LINE	
N/A	DIRECTION OF FLOW	57.67%
N/A	CONSTRUCTION ACCESS/EXIT	
N/A	PROPERTY LINE	

#### RELEVANT BMP FACT SHEETS

THE FOLLOWING BMPS AS OUTLINED IN, BUT NOT LIMITED TO, THE CASQA STORMWATER BMP HANDBOOK DATED JANUARY 2019, OR THE LATEST REVISED EDITION, MAY APPLY DURING THE CONSTRUCTION OF THE PROJECT. ADDITIONAL MEASURES MAY BE REQUIRED AS NEEDED.

CASQA ID BMP DESCRIPTION SCHEDULING

PRESERVATION OF EXISTING VEGETATION

NS-12 CONCRETE CURING

NS-13 CONCRETE FINISHING

FIBER ROLLS

GRAVEL BAG BERM

TC-1 STABILIZED CONSTRUCTION ENTRANCE/EXIT

1. CONTRACTOR TO FIT CONSTRUCTION ENTRANCE LENGTH AND CORRUGATED STEEL SHAKER PLATE(S)

AS NEEDED

WIND EROSION CONTROL


MATERIAL DELIVERY AND STORAGE

STOCKPILE MANAGEMENT AREA

SOLID WASTE MANAGEMENT

CONCRETE WASTE MANAGEMENT

SANITARY/SEPTIC WASTE MANAGEMENT

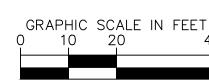

## UNDERGROUND SERVICE ALERT

TWO WORKING DAYS BEFORE YOU DIG

Call: TOLL FREE 800-227-2600

**BENCHMARK:** CCS83 ZONE 5, NAD83(2011), EPOCH 2010.0

BASIS OF BEARINGS: FD GLO BRASS CAP UP 0.6', CN 1/16 COR S.12, PER RS 103/74. **ELEVATION DETERMINED VIA STATIC GPS** OBSERVATION, PROCESSED THROUGH


NAVD-88 ELEV = 3066.588'

ONAL	Kimley» Horn
GLU	401 B STREET, SUITE 600, SAN DIEGO, CA 92101 PHONE: (619) 234-9411 WWW.KIMLEY-HORN.COM
	PREPARED UNDER THE SUPERVISION OF: 04/10/2024
	SARP SEKEROGLU R.C.E. No. 71474 EXP. 12/31/2025

REVISIONS		WATER TANK REPLACEMENT PLAN		
ADDENDUM NO. 2	SAN BERNARDINO COUNTY			
ADDENDUM NO. 5		6/24		SPECIAL DISTR
			ASSISTANT DIR	ECTOR
				REVIEWER
			APPROVALS	PROJECT MANAGER
			AFFILOVALS	PM, DIVISION MANAGER
DESCRIPTION	APPR.	DATE		WAS, DIVISION MANAGER

REVISIONS  ENDUM NO. 2  ENDUM NO. 5			S/	WATER TANK REPLACEMENT PLANS A AN BERNARDINO COUNTY - F SPECIAL DISTRIC	PUBLIC WOR	KS	WATER TANK REPLACEMENT PLANS	DWG NO. 30.30.00157
ENDUM NO. 5		0/24	ASSISTANT DIRE			07/18/2024	APN: 0580-241-16-0000 MORONGO VALLEY WATER TANK	FILE NO.
				REVIEWER	INITIAL	DATE	REPLACEMENT PROJECT	SD003
			APPROVALS	PROJECT MANAGER		07/16/2024	EROSION CONTROL PLAN	
			ALLINOVALO	PM, DIVISION MANAGER		07/16/2024	LICOION CONTROL I LAN	SHEET 10 OF 17
DESCRIPTION	APP	R. DATE		WAS, DIVISION MANAGER		07/17/2024		




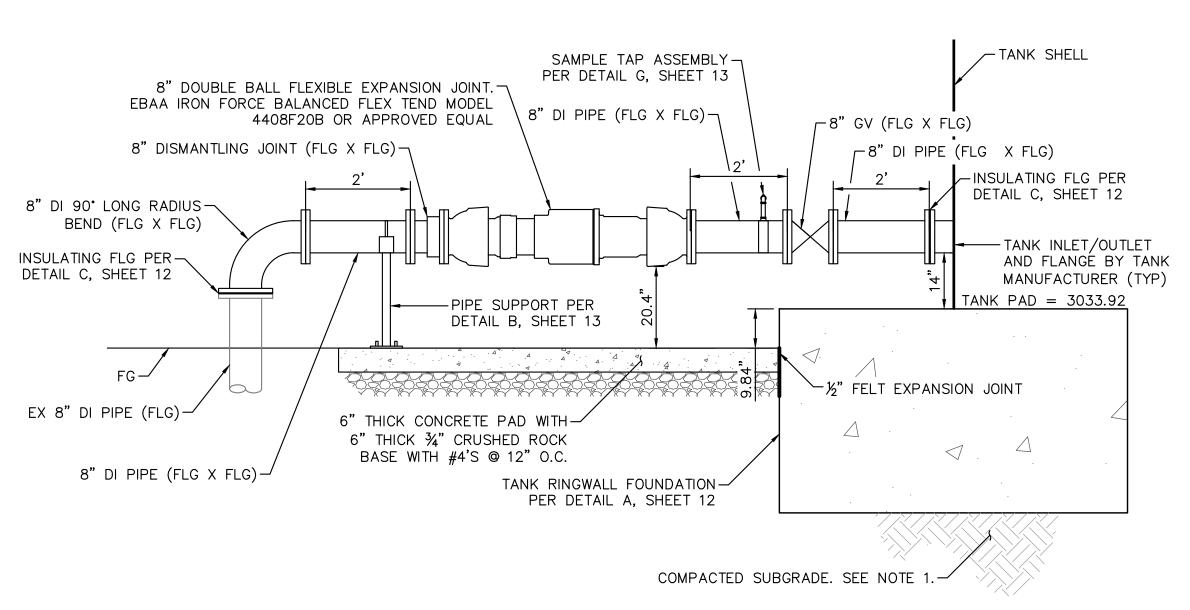


#### NOTES:

- 1. PREPARE SUBGRADE PER REPORT TITLED "GEOTECHNICAL EXPLORATION PROPOSED MORONGO VALLEY
- WATER TANK REPLACEMENT PROJECT: DATED JANUARY 10, 2024 BY LEIGHTON CONSULTING INC.


  2. INSTALLATION OF THE FORCE BALANCED DOUBLE BALL FLEXIBLE EXPANSION JOINT SHALL BE IN STRICT CONFORMANCE TO THE REQUIREMENTS OF THE MANUFACTURER.

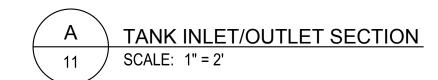

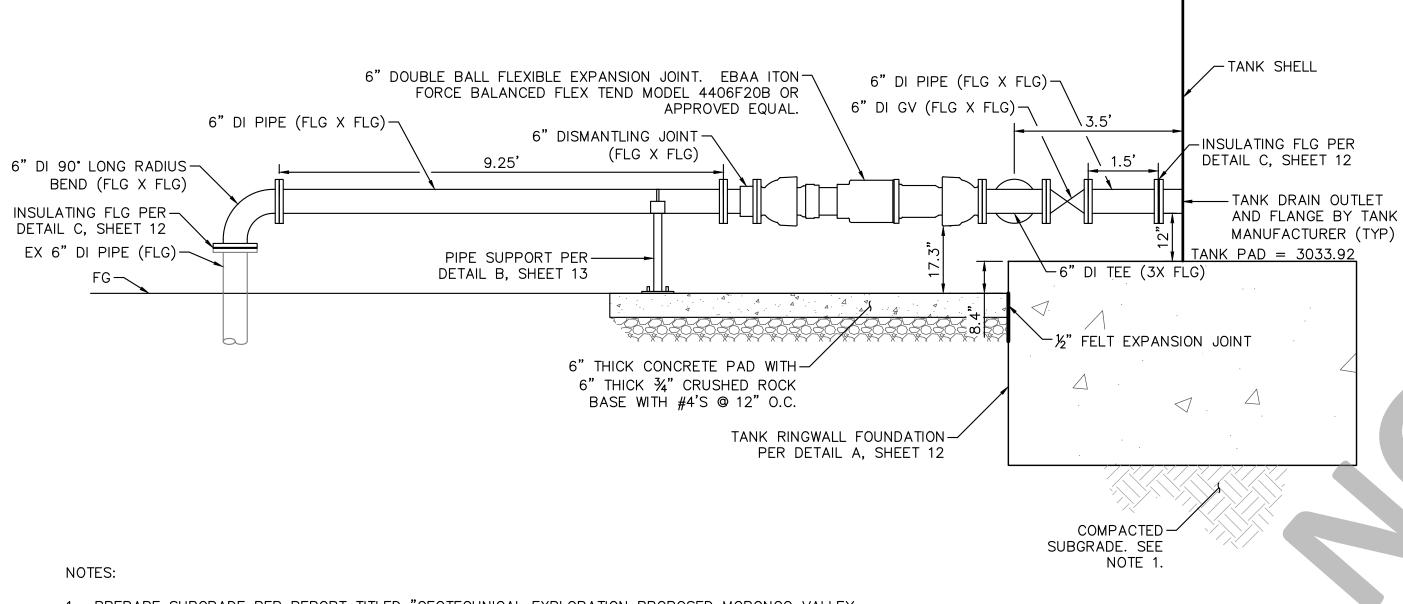


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- WATER TANK REPLACEMENT PROJECT: DATED JANUARY 10, 2024 BY LEIGHTON CONSULTING INC.


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REVISIONS WATER TANK REPLACEMENT PLANS APPROVED BY: DWG NO. UNDERGROUND SERVICE ALERT **BENCHMARK:** BASIS OF BEARINGS: WATER TANK REPLACEMENT PLANS SAN BERNARDINO COUNTY - PUBLIC WORKS ADDENDUM NO. 2 CCS83 ZONE 5, NAD83(2011), EPOCH 2010.0 FD GLO BRASS CAP UP 0.6', CN 1/16 COR 30.30.00157 SPECIAL DISTRICTS 🔪 ADDENDUM NO. 5 S.12, PER RS 103/74. Call: TOLL FREE APN: 0580-241-16-0000 ELEVATION DETERMINED VIA STATIC GPS 401 B STREET, SUITE 600, SAN DIEGO, CA 92101 07/18/2024 FILE NO. MORONGO VALLEY WATER TANK OBSERVATION, PROCESSED THROUGH PHONE: (619) 234-9411 WWW.KIMLEY-HORN.COM 1-800-227-2600 ASSISTANT DIRECTOR SD003 REPLACEMENT PROJECT OPUS. OR INITIAL DATE REVIEWER PREPARED, UNDER THE SUPERVISION OF: 811 NAVD-88 ELEV = 3066.588' PROJECT MANAGER 07/16/2024 **DETAILS** APPROVALS 04/10/2024 SARP SEKEROGLU SHEET 11 OF 17 PM, DIVISION MANAGER 07/16/2024 TWO WORKING DAYS BEFORE YOU DIG R.C.E. No. 71474 EXP. 12/31/2025 WAS, DIVISION MANAGER 07/17/2024 APPR. DATE DESCRIPTION

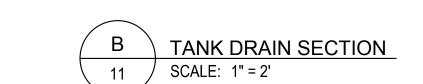

TANK WALL HEIGHT TO BE

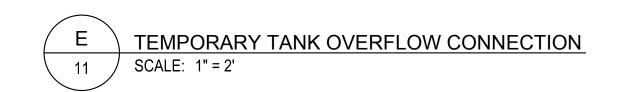DETERMINED BY SUPPLIER.

OVERFLOW INV = 3042.92

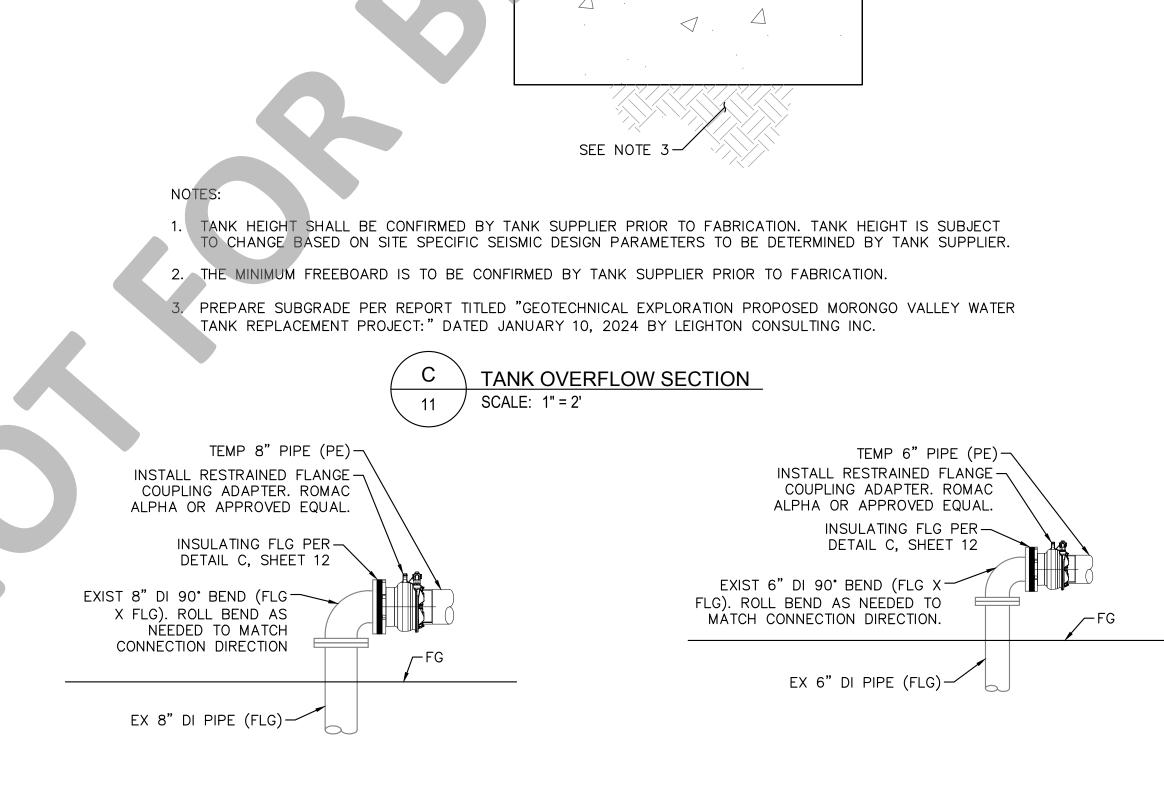6" OVERFLOW BY TANK

INSULATING FLANGE KIT PER-

6" DI 90° BEND -

FG=3033.08 TYP

DETAIL C, SHEET 12

MANUFACTURER

6" 90° BEND ─

(SEE NOTE 1)

-TANK ROOF

-OVERFLOW PIPING/BRACING/SUPPORTS

TANK PAD = 3033.92


BY TANK MANUFACTURER (TYP)


TANK SHELL BY MANUFACTURER

REEBOARD HEIGH (SEE NOTE 2)

RFLOW (SEE

-6" DI 90° BEND

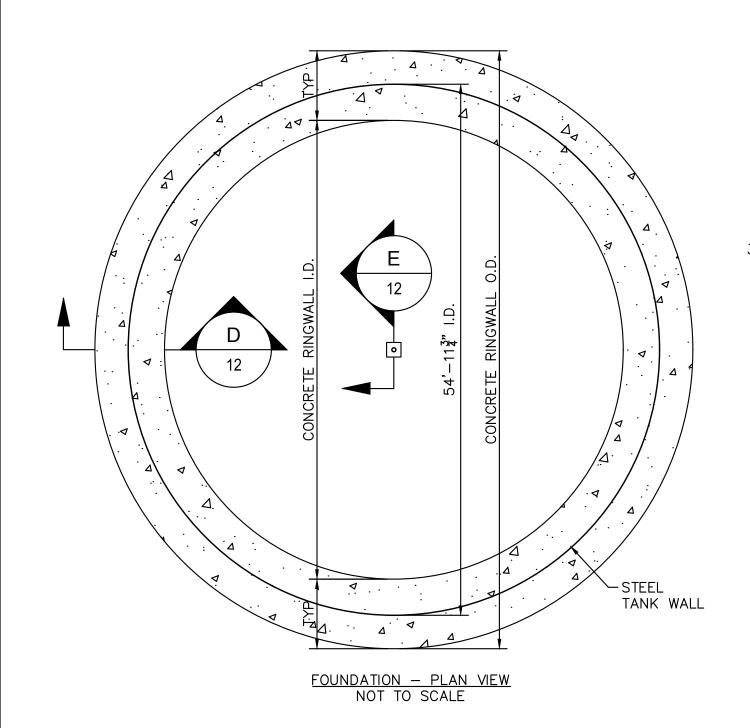


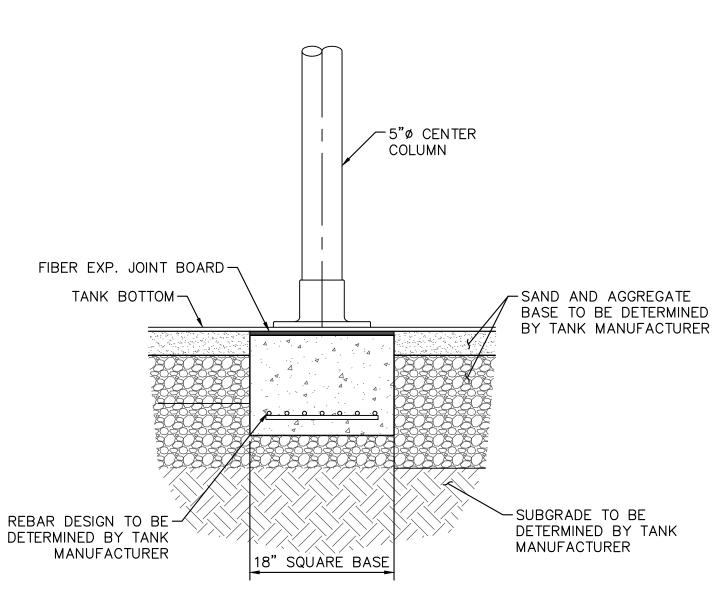

CENTER COLUMN FOUNDATION SCALE: NTS

CENTER COLUMN FOUNDATION IS SHOWN FOR REFERENCE ONLY. CENTER COLUMN FOUNDATION WILL BE INSTALLED PER TANK MANUFACTURER'S SHOP DRAWINGS.



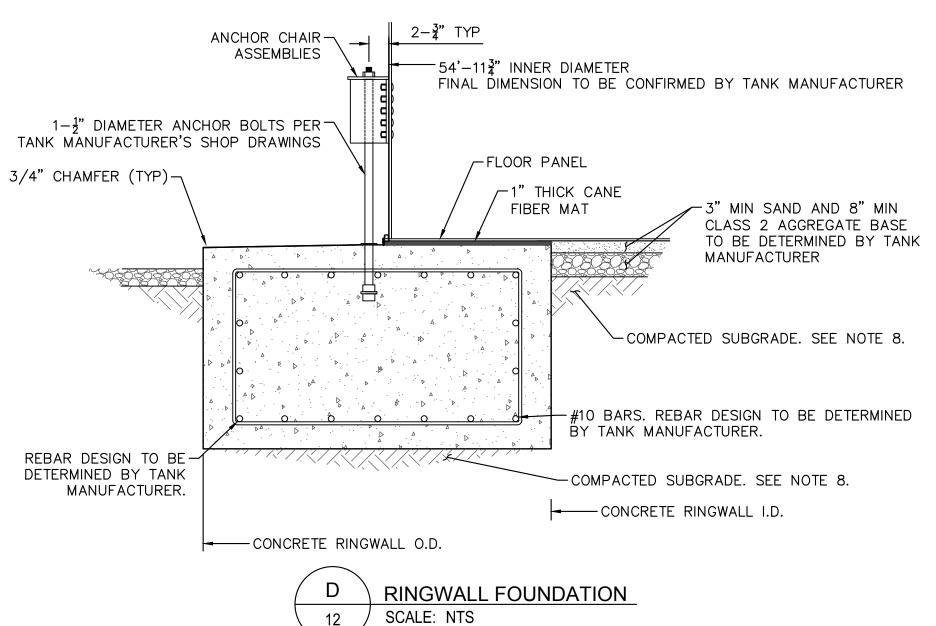

NOTES:
TANK FOUNDATION IS SHOWN FOR REFERENCE ONLY. FOUNDATION DESIGN WILL BE DESIGNED BY TANK MANUFACTURER'S SHOP DRAWINGS.

I. TANK MANUFACTURER: SUPERIOR TANKS OR APPROVED EQUAL.

CONCRETE DIMENSIONS SHOWN ARE APPROXIMATE.

CONCRETE RINGWALL FOUNDATION TO BE DESIGNED BY TANK MANUFACTURER'S STRUCTURAL ENGINEER AFTER SELECTION.

4. REBAR SIZE AND SPACING TO BE DETERMINED BY TANK MANUFACTURER. 5. ALL COSTS ASSOCIATED WITH THE STRUCTURAL DESIGN OF THE CONCRETE RINGWALL FOUNDATION SHALL BE INCLUDED IN THE COST OF THE STORAGE TANK.

6. TANK FOUNDATION PREPARATION SHALL BE INSPECTED AND APPROVED BY A

GEOTECHNICAL ENGINEER.

7. TANK FOUNDATION SHALL BE INSPECTED BY A STRUCTURAL ENGINEER AND GEOTECHNICAL ENGINEER.

8. PREPARE SUBGRADE PER REPORT TITLED "GEOTECHNICAL EXPORATION PROPOSED MORONGO VALLEY WATER TANK REPLACEMENT PROJECT" DATED JANUARY 10, 2024 BY LEIGHTON CONSULTING INC.

9. FOR AN AREA EXTENDING 3 FEET OUT RADIALLY (HORIZONTALLY) FROM THE TANK FOUNDATION EXTERIOR PERIMETER, OVEREXCAVATE 3 FEET BELOW BOTTOM OF THE RING WALL FOUNDATION, OR AT LEAST 5 FEET BELOW EXISTING GRADE, WHICHEVER IS DEEPER. AFTER OVEREXCAVATION IS COMPLETED, THE EXPOSED SUBGRADE SHOULD BE SCARIFIED, MOISTURE-CONDITIONED AND COMPACTED.

10. CONCRETE DESIGN TO BE PROVIDED BY TANK MANUFACTURER.

11. REINFORCING STEEL GRADE SHALL BE DETERMINED BY TANK MANUFACTURER. 12. THE FINAL TANK DIAMETER WILL BE CONFIRMED BY TANK MANUFACTURER.

WELD HAND RAIL TO WALKWAY RAILING ROOF VENT PER HAND RAIL-DETAIL C, SHEET 13-BOLTED STEEL GROUND STORAGE TANK-ROOF ACCESS HATCH PER DETAIL E, SHEET 14--EXTERIOR LADDER PER DETAIL A, SHEET 14 139,112 GALLON OPERATIONAL VOLUME 54'-11¾" I.D. (SEE NOTE 1) SHELL MANHOLE -INTERIOR LADDER PROPOSED FINISHED-GRADE TANK PAD NOTES:

> 1. TANK HEIGHT SHALL BE CONFIRMED BY TANK SUPPLIER PRIOR TO FABRICATION. TANK HEIGHT IS SUBJECT TO CHANGE BASED ON SITE SPECIFIC SEISMIC DESIGN PARAMETERS TO BE DETERMINED BY TANK SUPPLIER. 2. PLATES AND SHEETS USED IN THE CONSTRUCTION OF THE TANK SHELL, TANK FLOOR AND TANK ROOF, SHALL

COMPLY WITH THE MINIMUM STANDARDS OF AWWA D103, LATEST EDITION

WATER TANK REPLACEMENT PLANS APPROVED BY:


07/18/2024

DATE

07/16/2024 07/16/2024

07/17/2024

BOLTED STEEL WATER STORAGE TANK SCALE: NTS

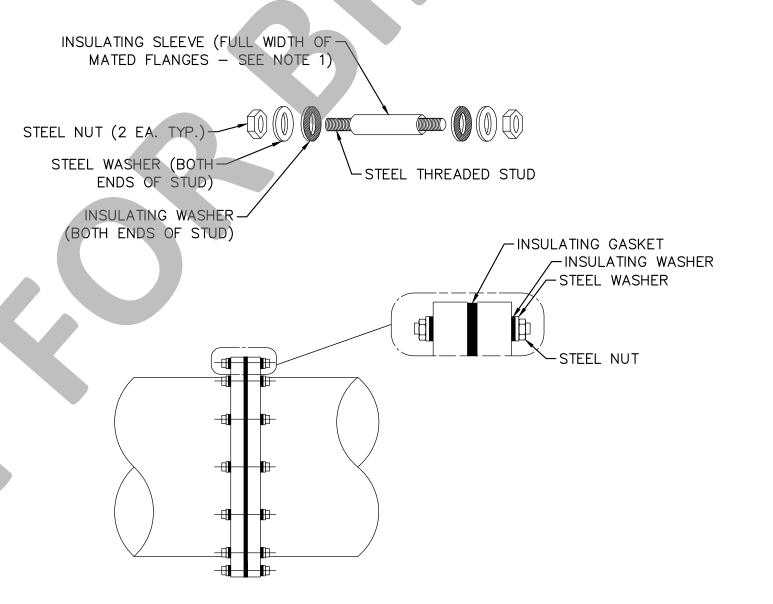

USE HALF WIDTH SLEEVES AT THREADED FLANGE BOLTS.

2. INSULATING MATERIALS: 2.1. GASKET- 12" AND GREATER -TYPE "E" FULLFACED NEOPRENE WITH RECTANGULAR NITRILE OR VITON

O-RING SEAL. (PSI LINEBACKER OR EQUAL).

2.2. 12" OR LESS-TYPE "E" FULLFACED NEOPRENE FACED PHENOLIC. 2.3. SLEEVE- 1/32-INCH THICK, FULL LENGTH TUBE, LAMINATED G-10 GLASS

2.4. WASHER- 1/8-INCH THICK LAMINATED G-10 GLASS.

3. ALIGN FLANGE PROPERLY AND FOLLOW GASKET MANUFACTURER BOLT TIGHTENING SEQUENCE INSTRUCTIONS.

4. DO NOT PAINT OUTER SURFACE OF FLANGE WITH METALLIC PIGMENTED OR CONDUCTIVE PAINTS. 5. TEST MATED FLANGE WITH GAS ELECTRONICS MODEL 601 INSULATION CHECKER (OR EQUIVALENT). PRIOR TO ACCEPTANCE.

> ABOVE-GRADE INSULATING FLANGE SCALE: NTS

> > REVISIONS


UNDERGROUND	SERVICE ALER
	Call: TOLL FRE 1-800-227-260 OR 811

TWO WORKING DAYS BEFORE YOU DIG

BENCHMARK: CCS83 ZONE 5, NAD83(2011), EPOCH 2010.0

BASIS OF BEARINGS: FD GLO BRASS CAP UP 0.6', CN 1/16 COR S.12, PER RS 103/74. ELEVATION DETERMINED VIA STATIC GPS OBSERVATION, PROCESSED THROUGH

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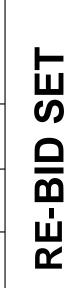
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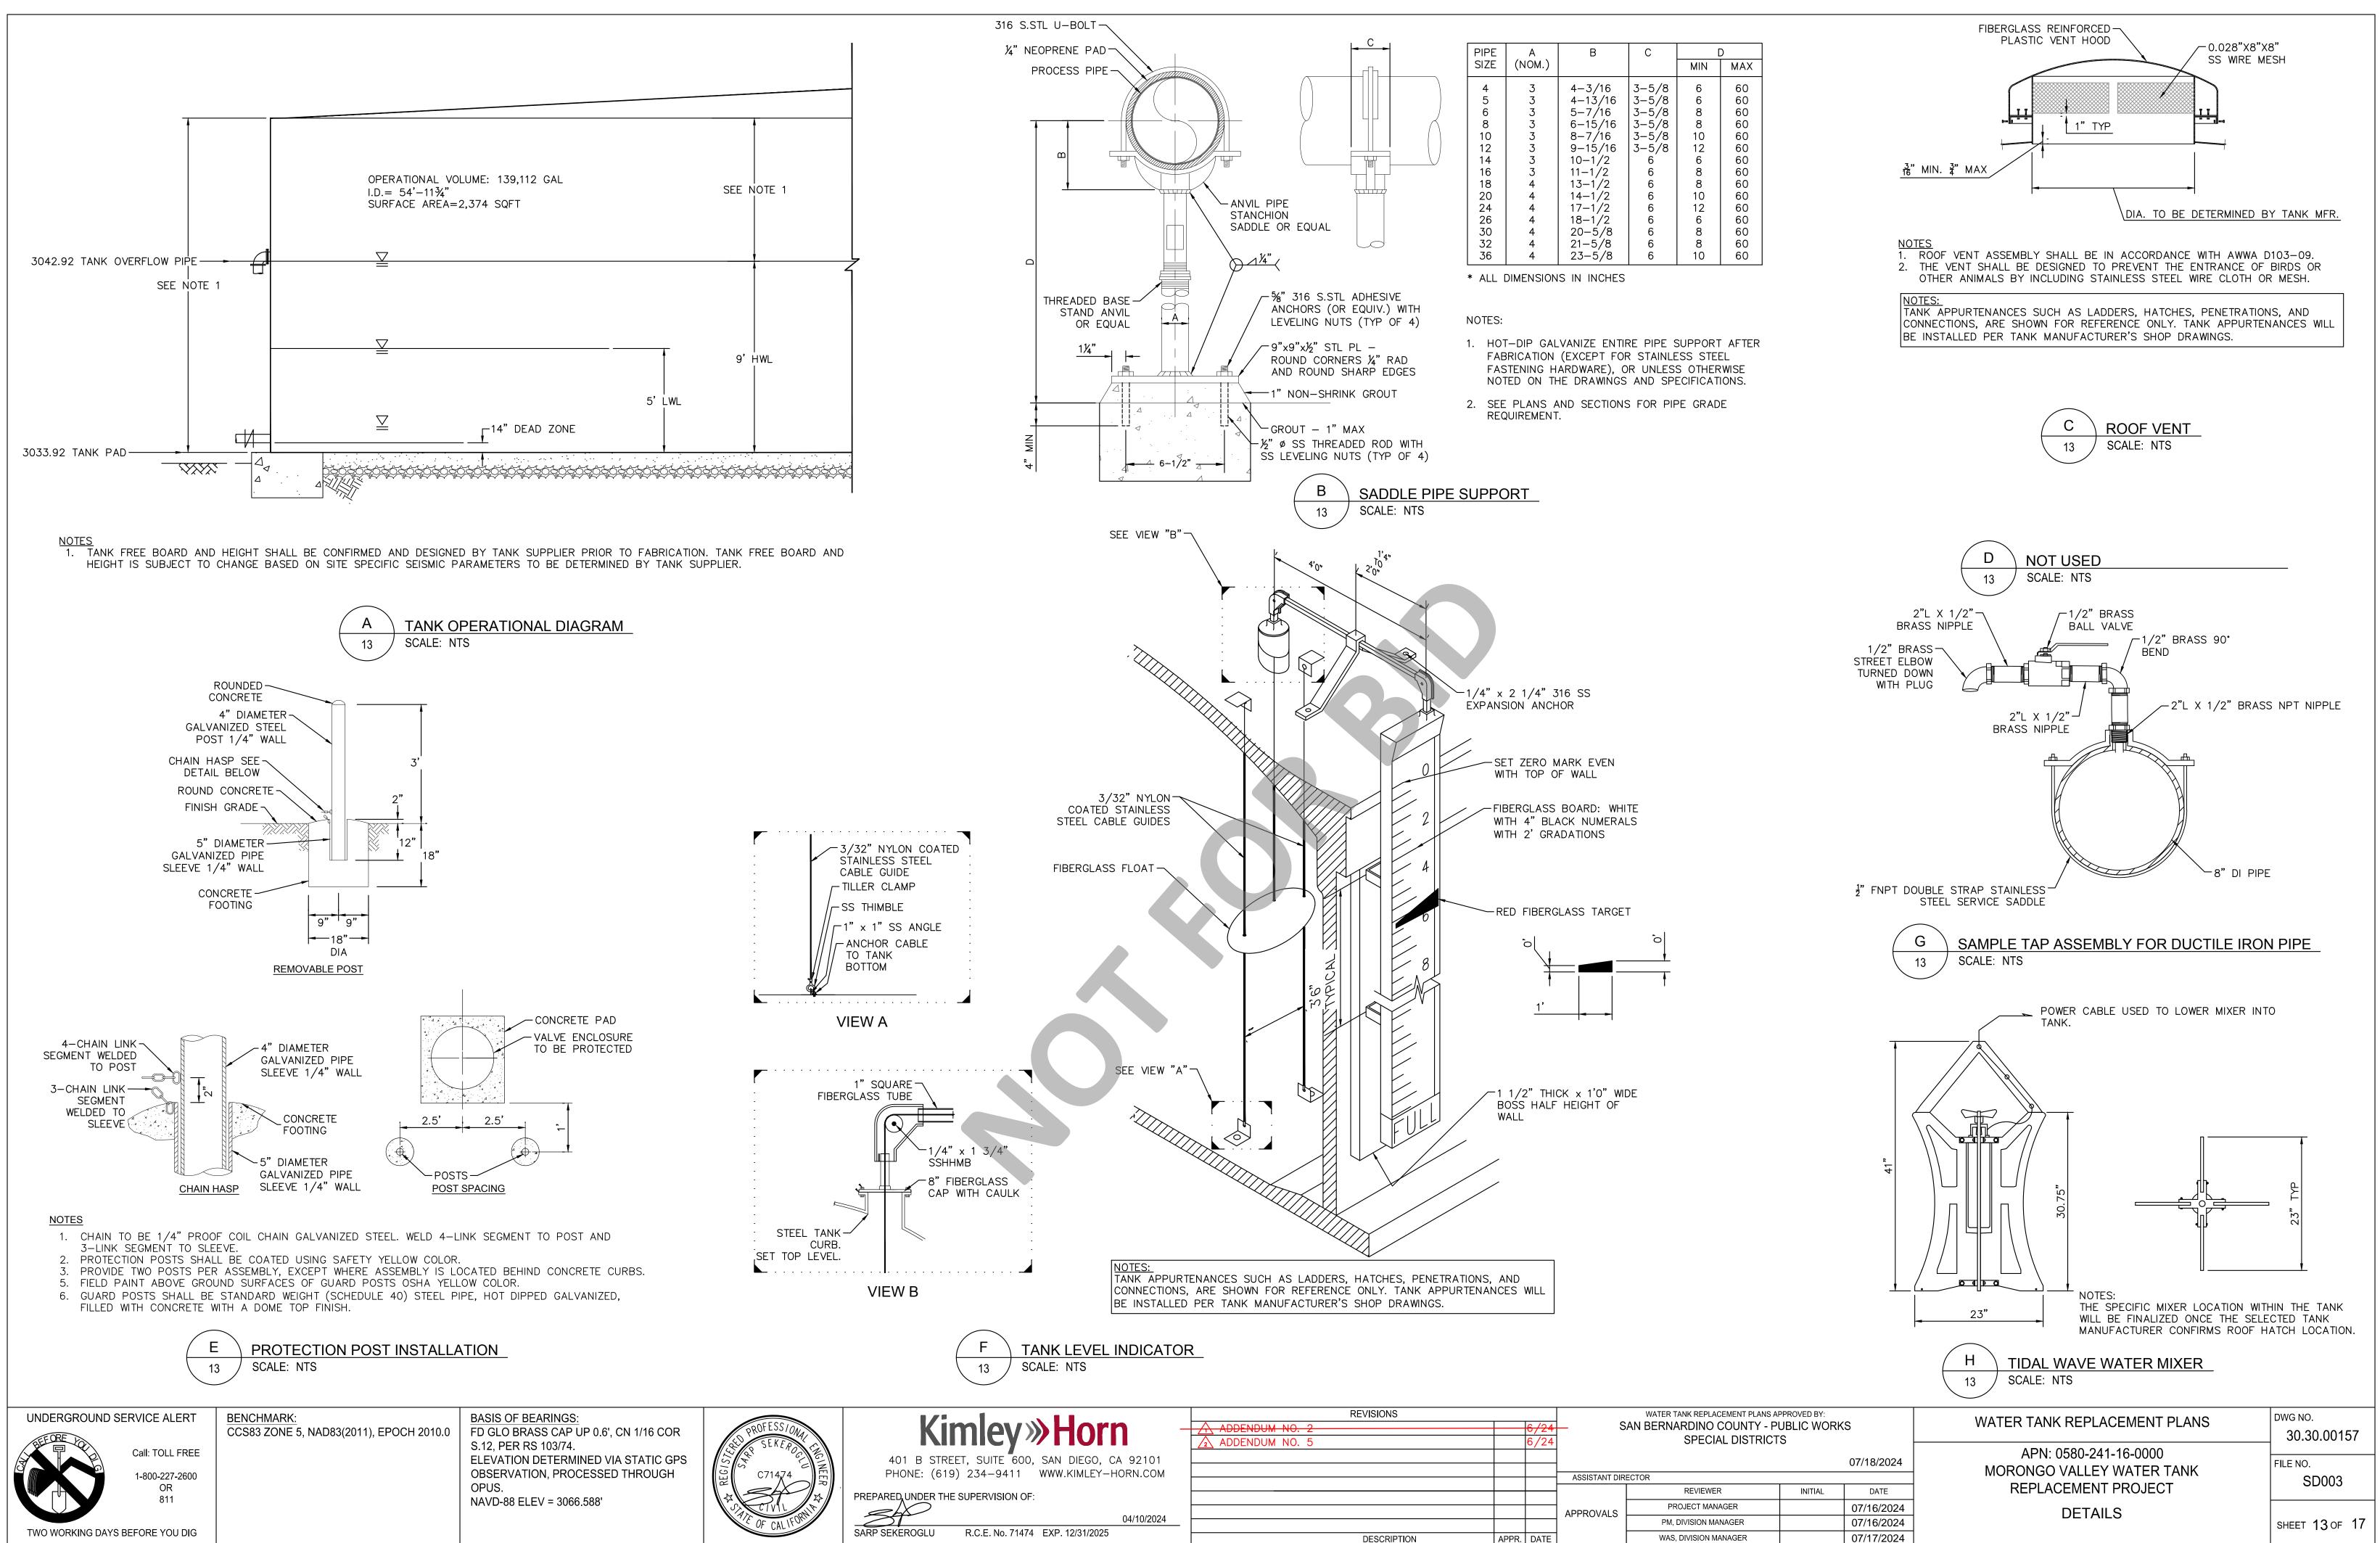
R.C.E. No. 71474 EXP. 12/31/2025

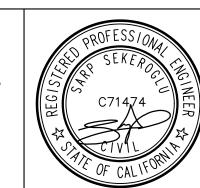SARP SEKEROGLU

DENDUM NO. 2		6/24	of the Delivity to the control of th					
DENDUM NO. 5		6/24						
						07		
			ASSISTANT DIR	ECTOR				
				REVIEWER	INITIAL			
			ADDDOVAL C	PROJECT MANAGER		07		
			APPROVALS	PM, DIVISION MANAGER		07.		
DESCRIPTION	APPR.	DATE		WAS, DIVISION MANAGER		07		

WATER TANK REPLACEMENT PLANS	DWG NO. 30.30.00157
APN: 0580-241-16-0000 MORONGO VALLEY WATER TANK REPLACEMENT PROJECT	FILE NO. SD003
DETAILS	SHEET 12 OF 17







DESCRIPTION

APPR. DATE




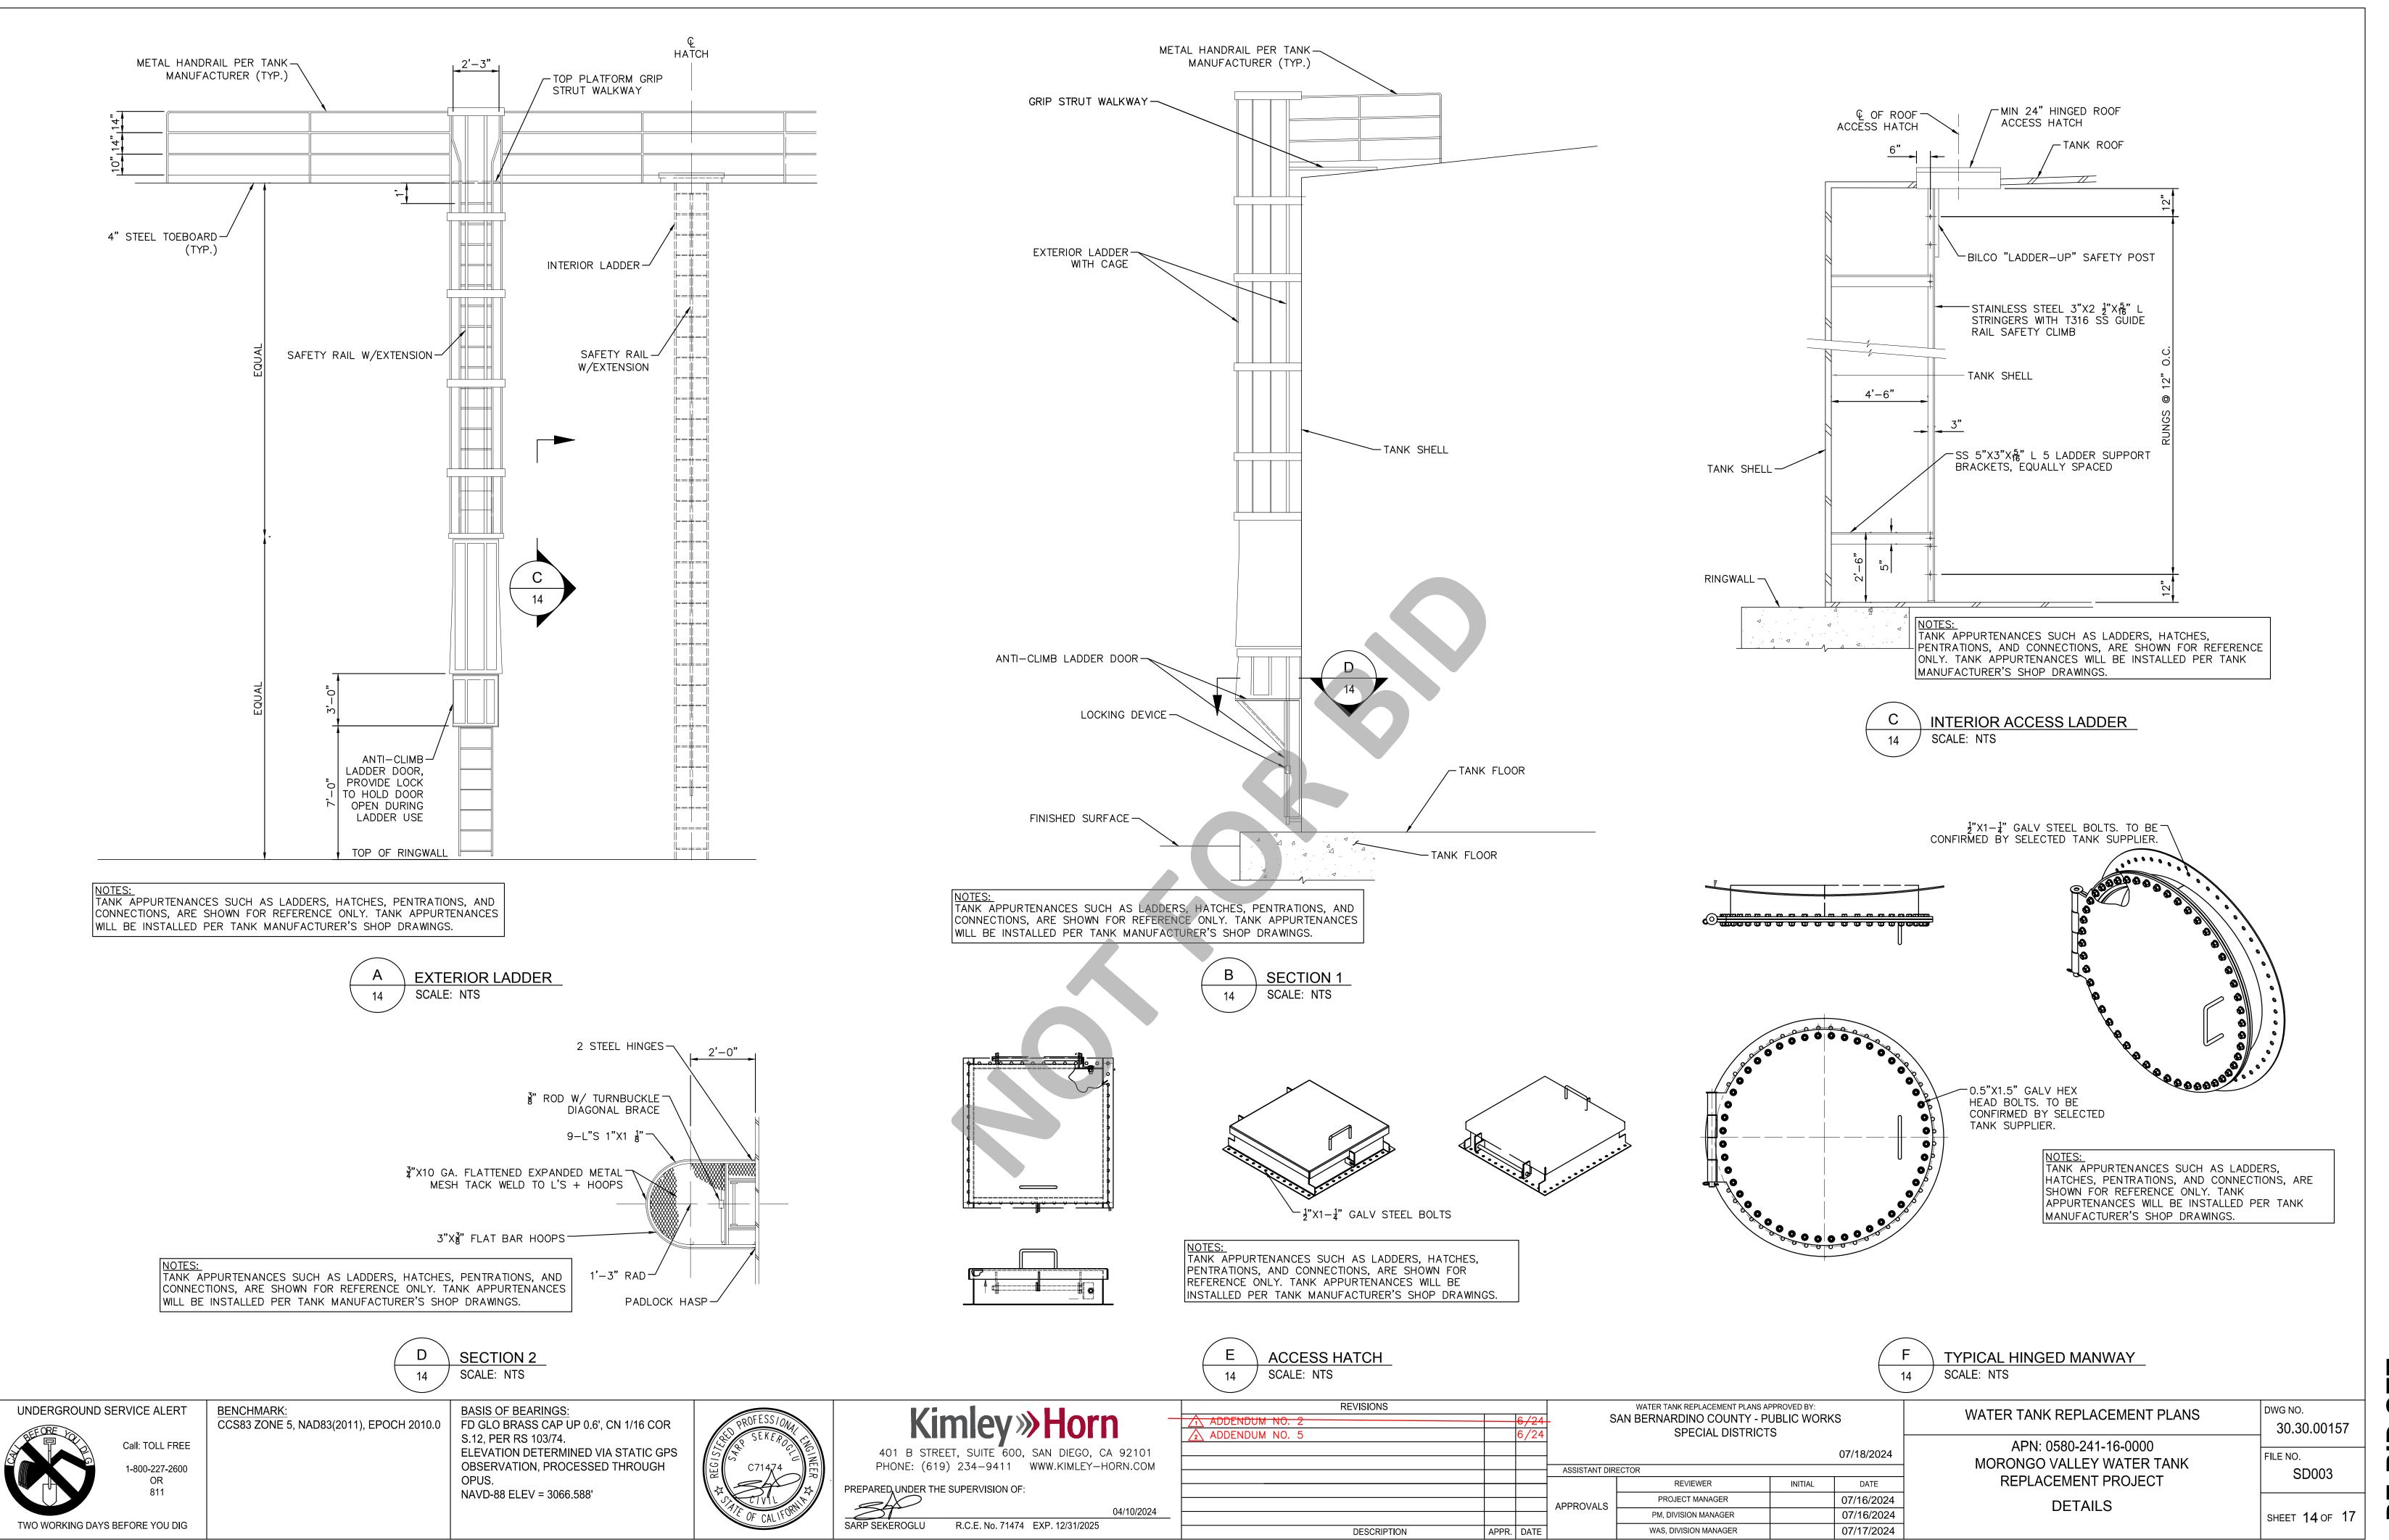

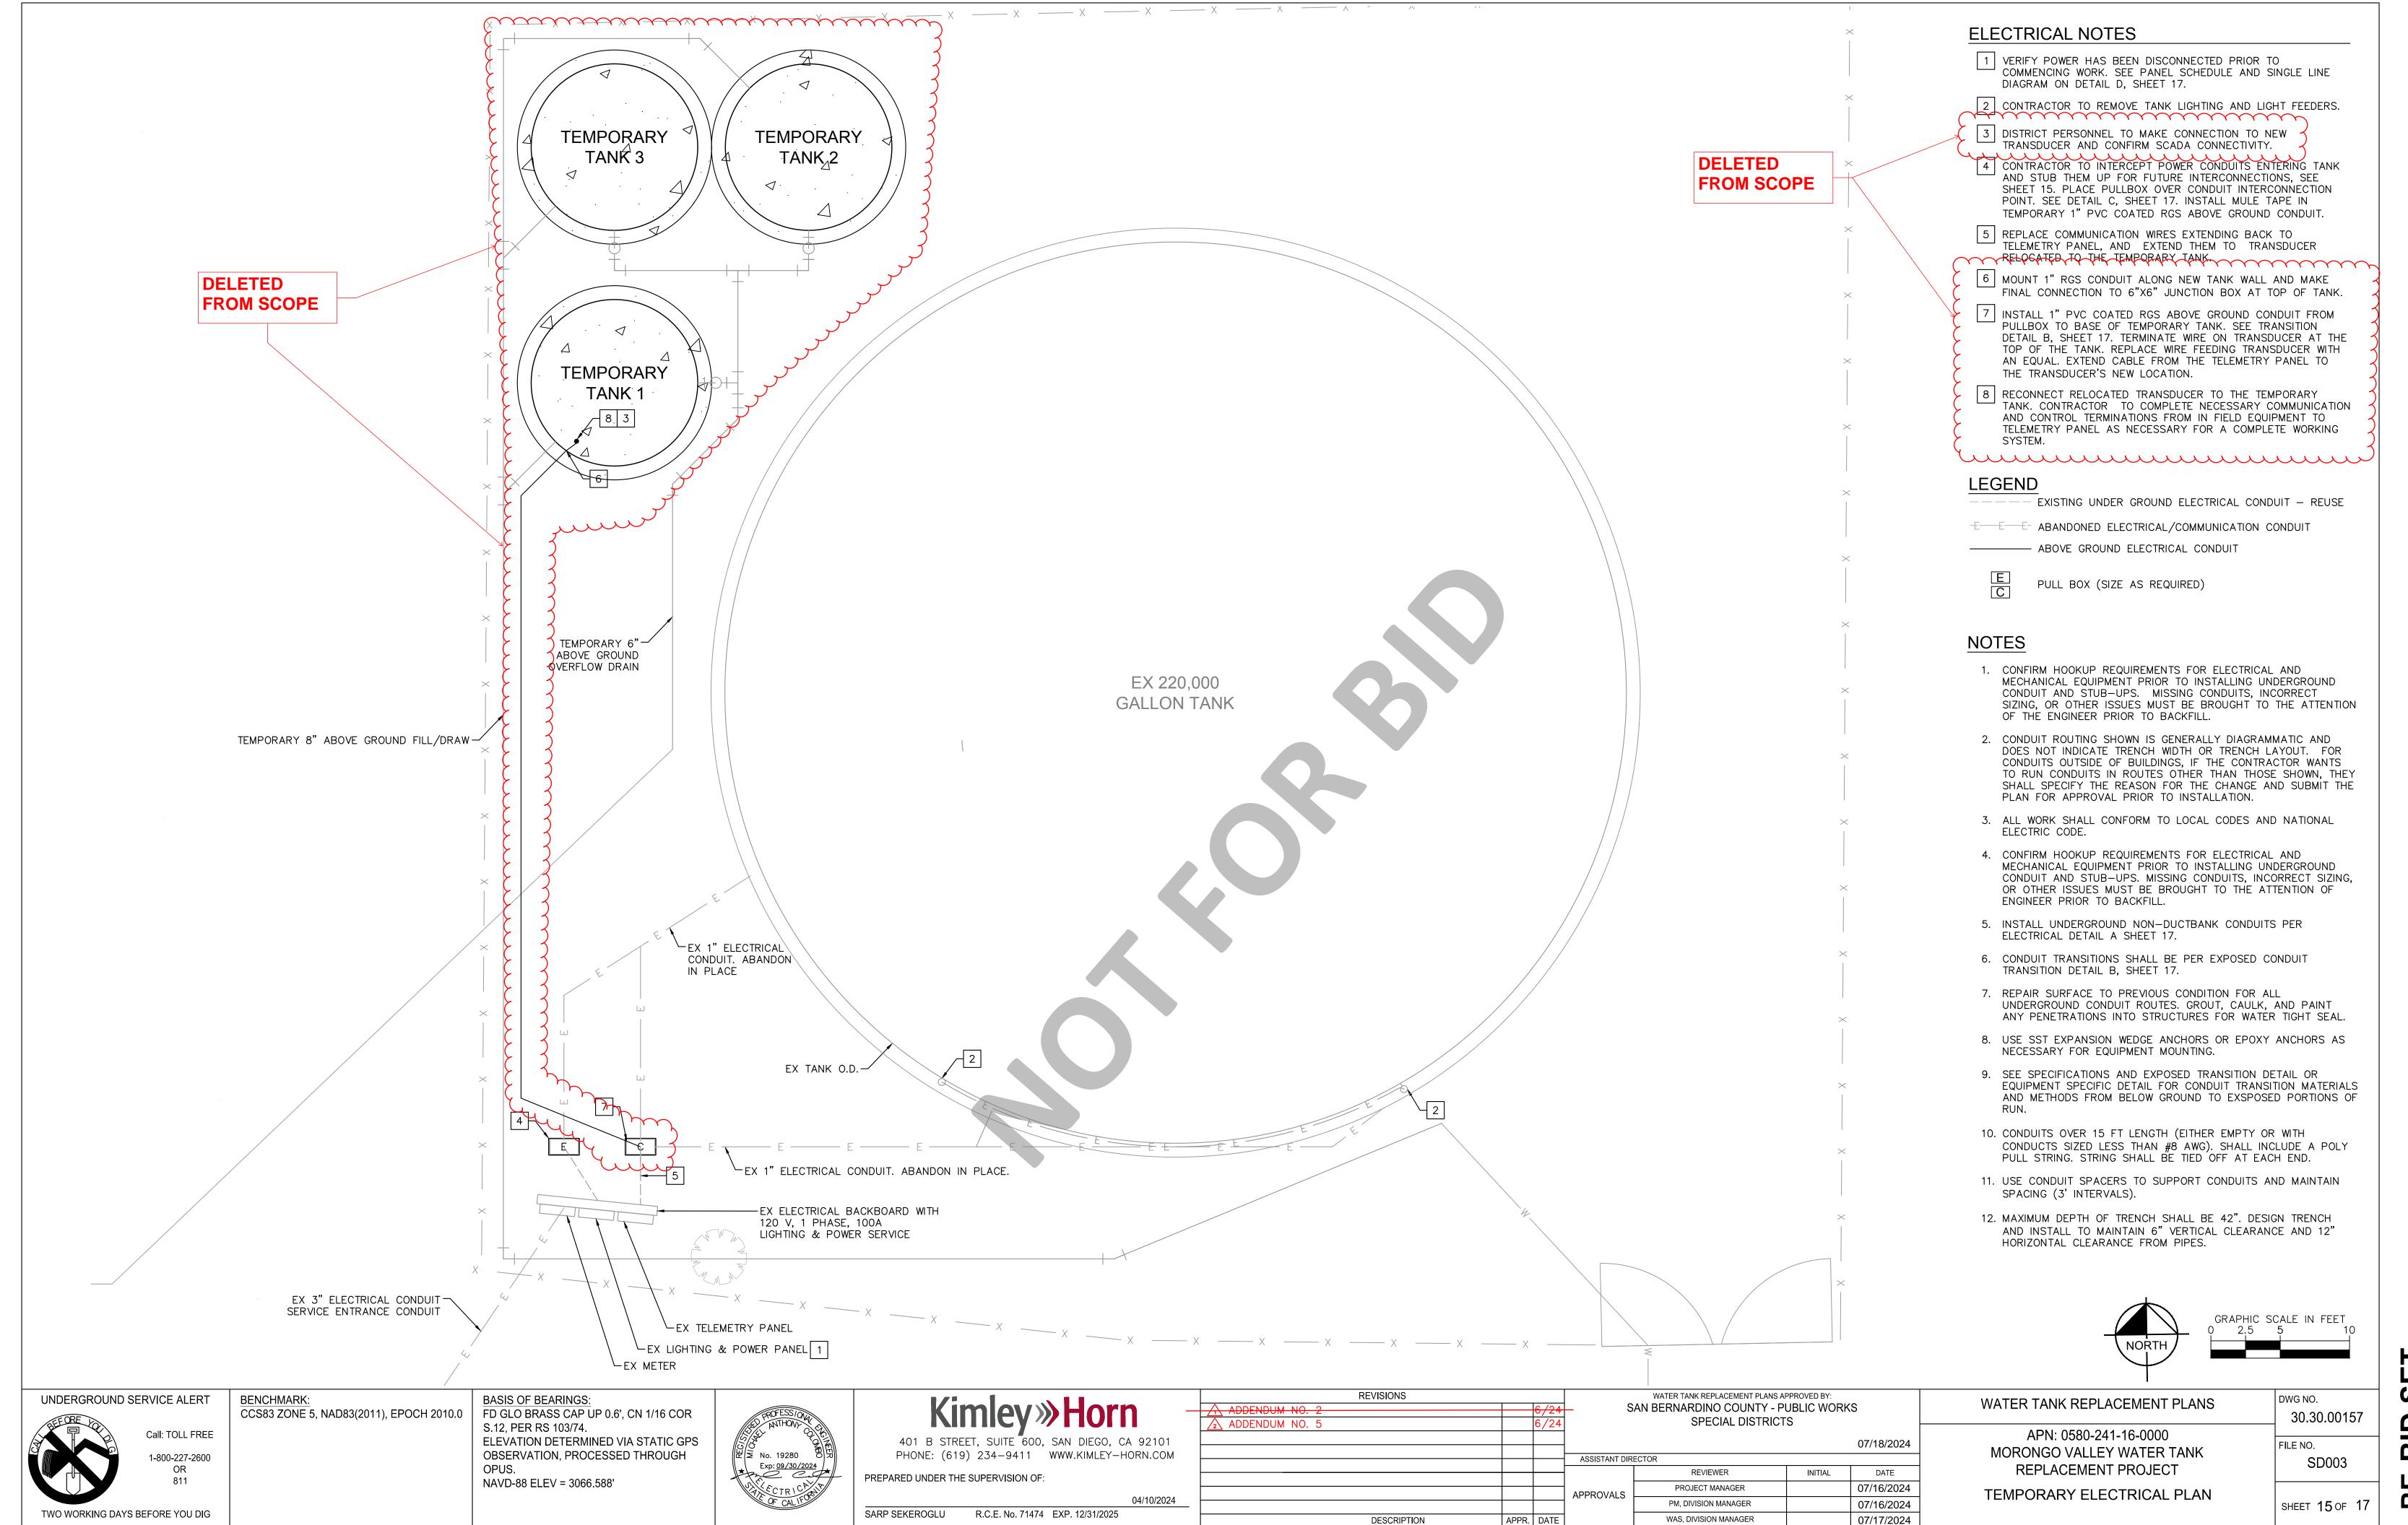

DESCRIPTION

APPR. DATE

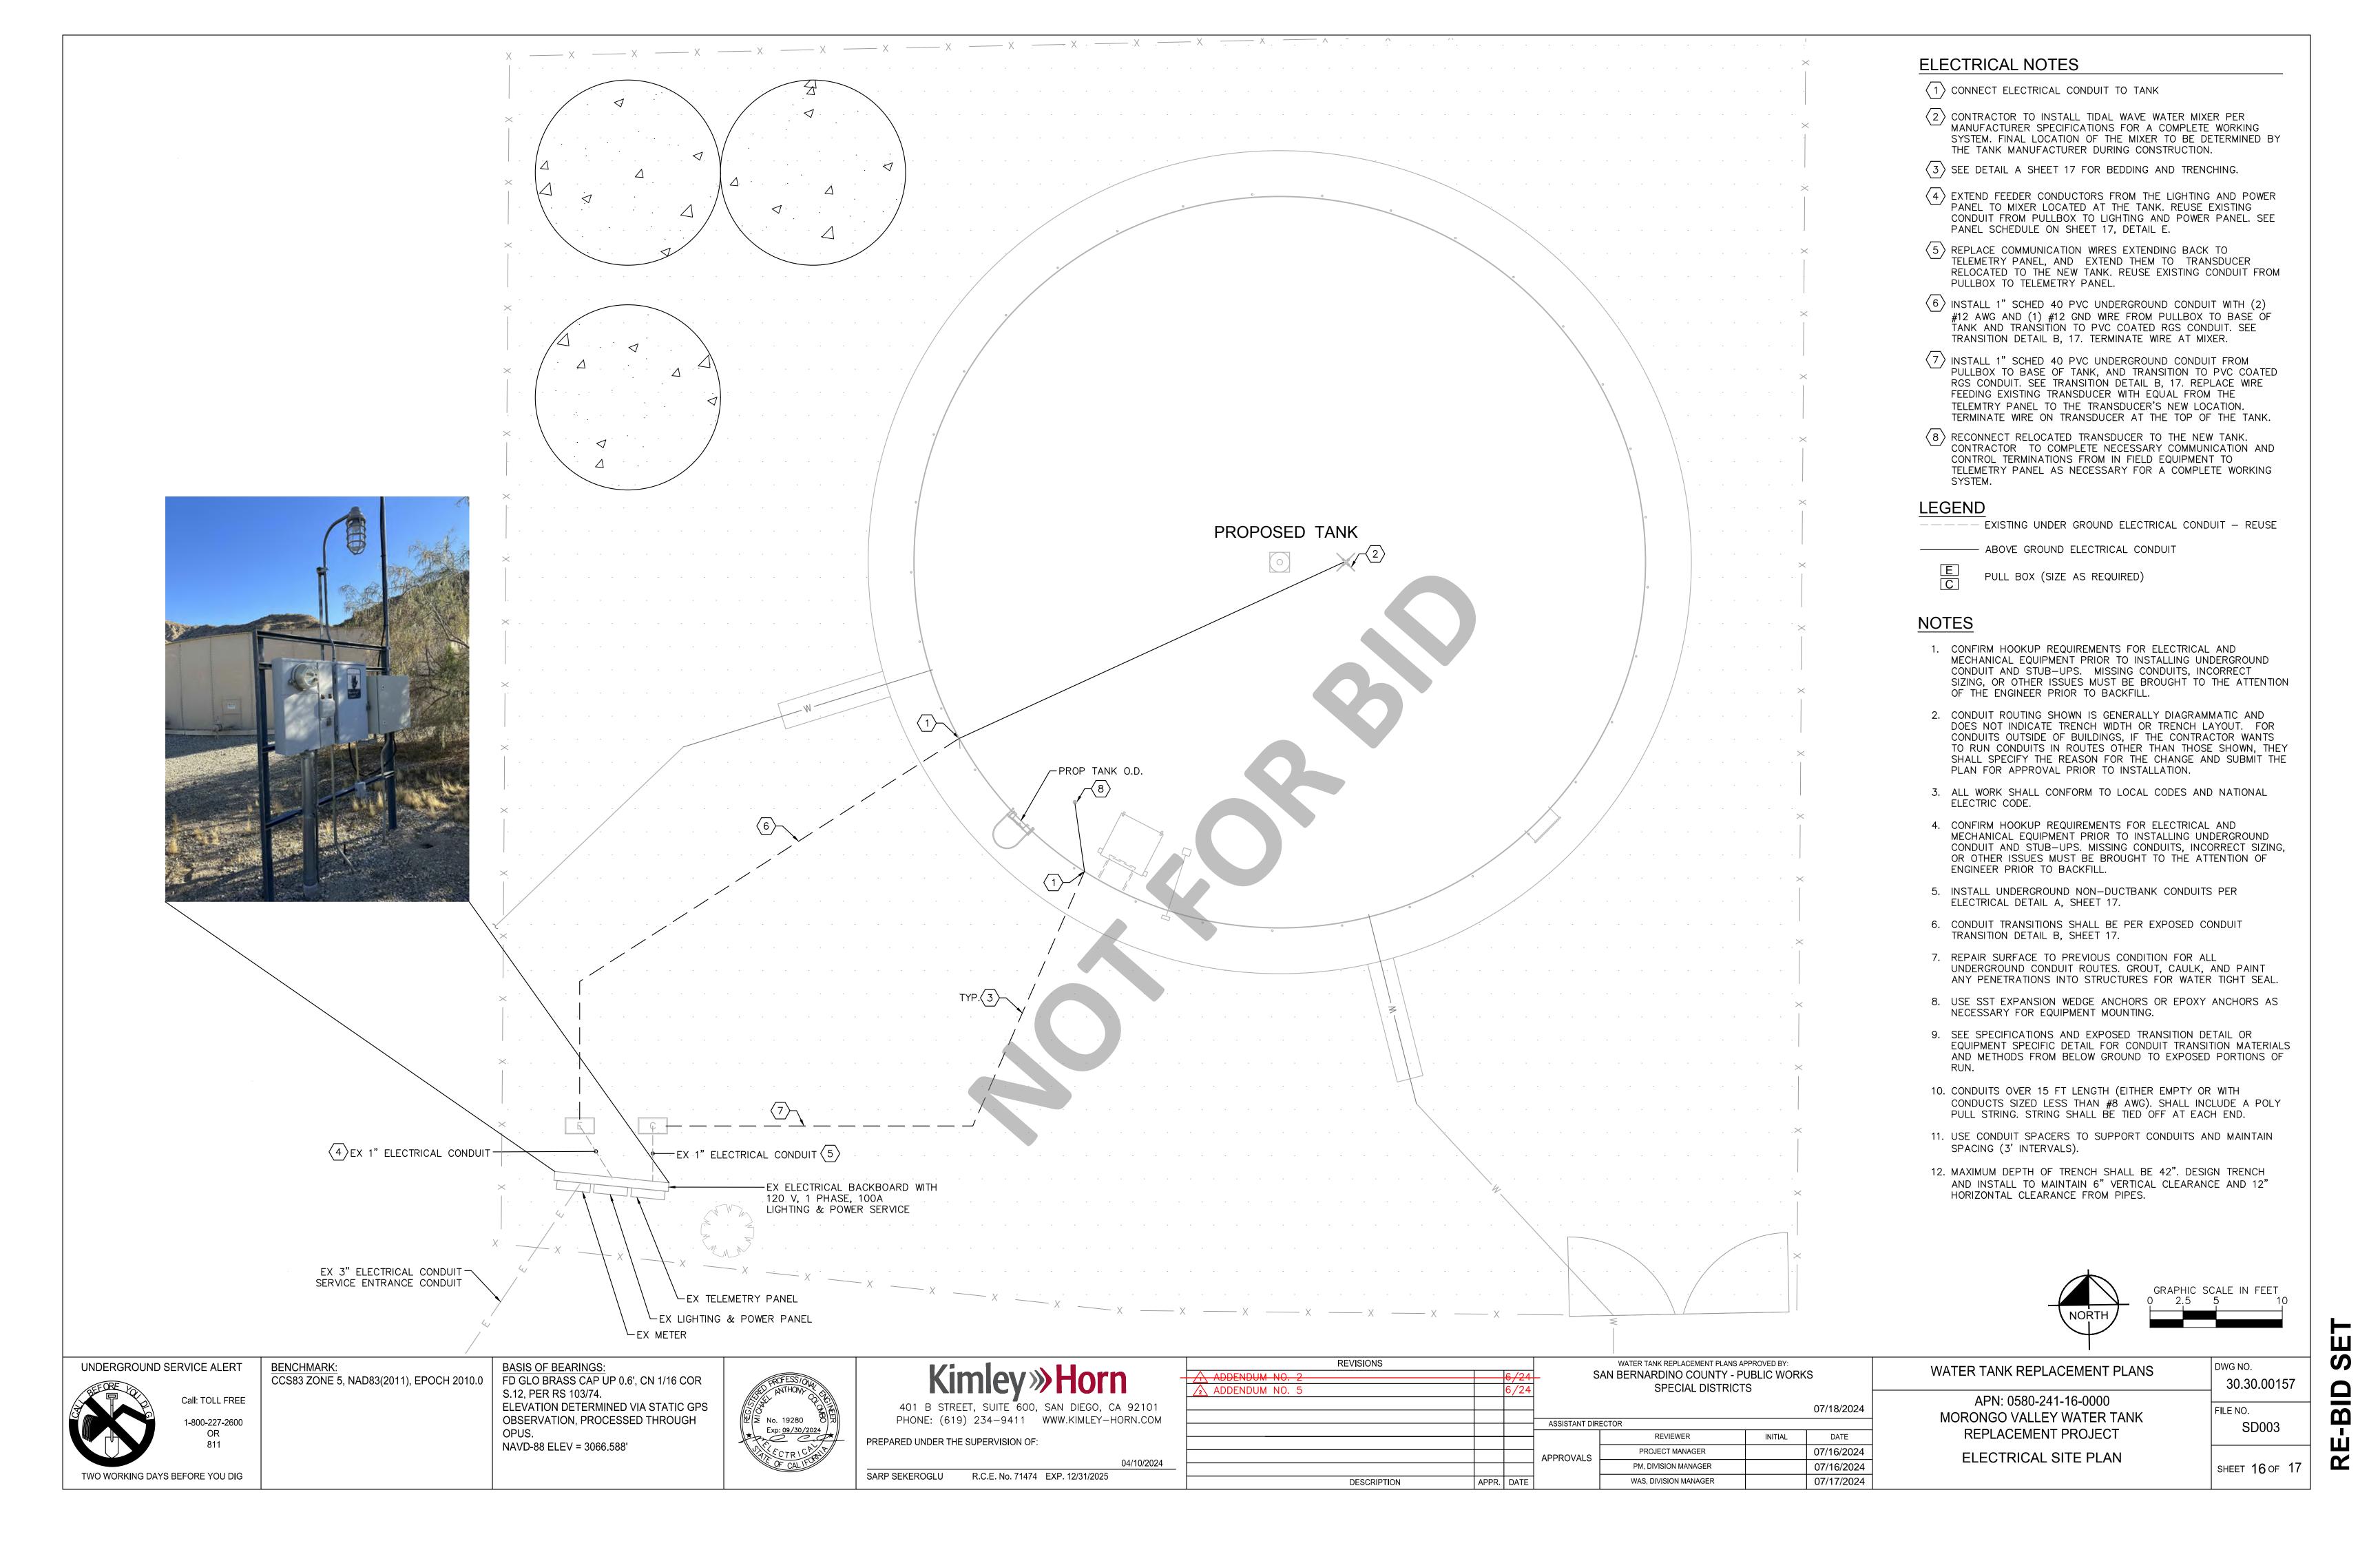



DWG NO.


FILE NO.

30.30.00157

SHEET 17 OF 17

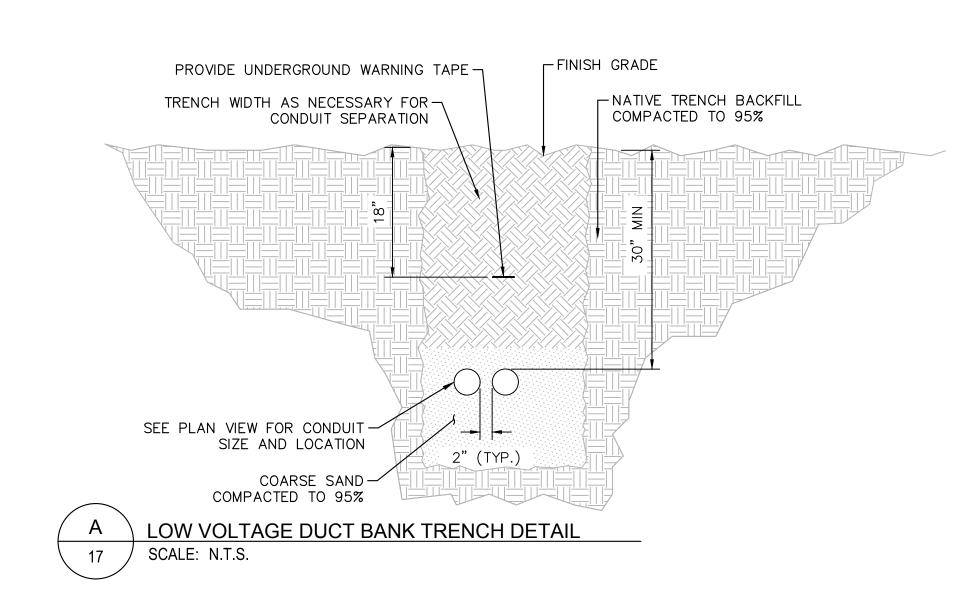

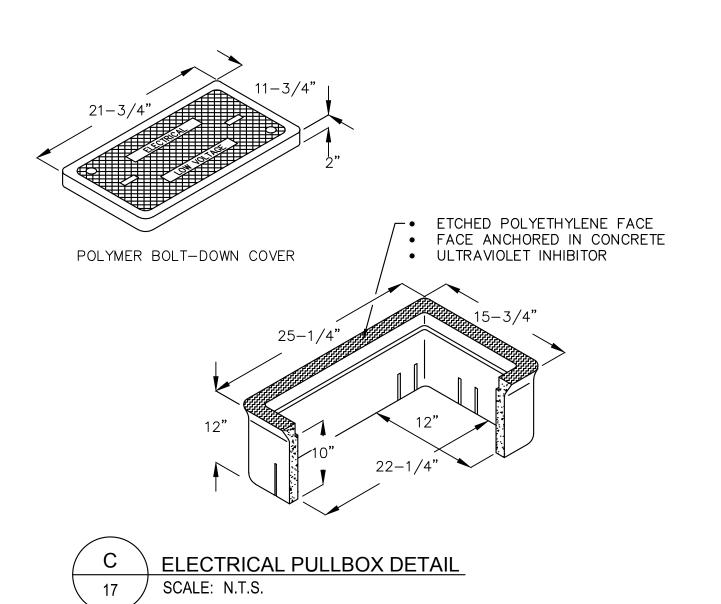

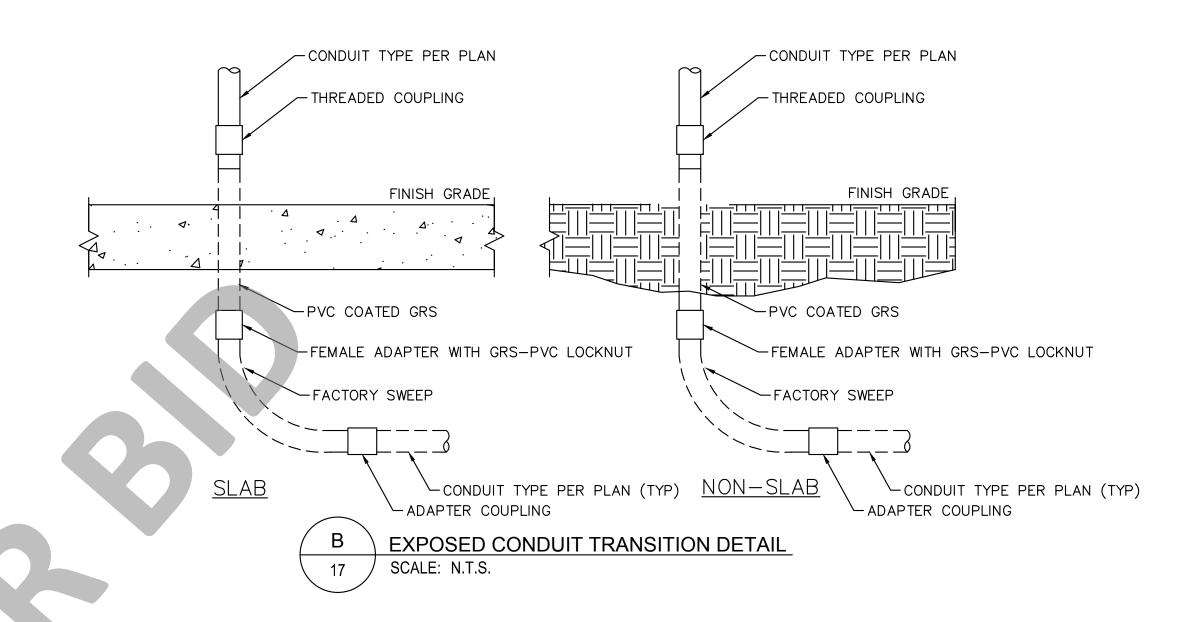

			F	ANEL	o ky h	*** ¥ \$			
VOLTAGE: 120/240			PANE	L BUS:	100	AMPS			
PHASE, WIRES: 1ø, 3W				MAIN:	100	BREAK	ER		
SCCR (AMPS): 10,000									
SOURCE: SES									
DESCRIPTION	VA	CB	СКТ	Α	8	СКТ	CB	VA	DESCRIPTION
SPACE			1	0.0		2			SPACE
EXISTING	1920	20/1	3		216	4	20/1	670	MIXER
SPARE		20/1	5	16.0		6	20/1	1920	OUTLET
TELEMETRY POWER	1920	20/1	7		16.0	- 8			SPACE
SPACE			9	0.0		10			SPARE
SPACE			11		0,0	12			SPARE
SPACE			13	ÖÖ		1/4			SPARE
SPACE			15		0.0	16			SPARE
SPACE			17	0.0		18			SPACE
SPACE			19		0.0	50			SPACE
0.70				16.0	37.6	AMPS	•		



UNDERGROUND SERVICE ALERT	BENCHMARK: CCS83 ZONE 5, NAD83(2011), EPOCH 2010.0	· ·	PROFESSION OF THE PROPERTY OF	Kimley»Horn –	REVISIONS  ADDENDUM NO. 2  ADDENDUM NO. 5	6/24	WATER TANK REPLACEMENT PLAN SAN BERNARDINO COUNTY SPECIAL DISTRI	- PUBLIC WORKS	WATER TANK REPLACEMENT PLANS
Call: TOLL FREE 1-800-227-2600		S.12, PER RS 103/74. ELEVATION DETERMINED VIA STATIC GPS OBSERVATION, PROCESSED THROUGH	No. 19280 8 5 7 1 1 1 1 1 1 1 1 1 1 1 1 1 1 1 1 1 1	401 B STREET, SUITE 600, SAN DIEGO, CA 92101 PHONE: (619) 234-9411 WWW.KIMLEY-HORN.COM	Z2 ADDENDOM NO. 3	ASS	SISTANT DIRECTOR	07/18/2024	APN: 0580-241-16-0000 MORONGO VALLEY WATER TANK
OR 811		OPUS. NAVD-88 ELEV = 3066.588'	Exp: 09/30/2024  EXP: OF CALLED	PREPARED UNDER THE SUPERVISION OF: 04/10/2024		APPI	REVIEWER PROJECT MANAGER PM, DIVISION MANAGER	INITIAL DATE 07/16/2024 07/16/2024	REPLACEMENT PROJECT ELECTRICAL DETAILS
TWO WORKING DAYS BEFORE YOU DIG				SARP SEKEROGLU R.C.E. No. 71474 EXP. 12/31/2025	DESCRIPTION	APPR. DATE	WAS, DIVISION MANAGER	07/17/2024	