

WARNING: ALL INDIVIDUALS INTERESTED IN BIDDING ON THIS PROJECT MUST OBTAIN THE FINAL PLANS AND SPECIFICATIONS FROM THE DEPARTMENT MANAGING THE PROJECT OR AS OTHERWISE STATED IN THE ADVERTISEMENT FOR BIDS FOR THE PROJECT. DO NOT USE THE PLANS AND SPECIFICATIONS POSTED ON THE CLERK OF THE BOARD'S WEBSITE FOR BIDDING ON THIS PROJECT.

Diagram illustrating various architectural symbols and their corresponding labels:

- DETAIL NUMBER**: Symbol showing 'X' over 'YY' inside a circle.
- SHEET NUMBER WHERE DRAWN**: Symbol showing 'X' over 'YY' inside a circle, with a dashed circle below it.
- SECTION NUMBER**: Symbol showing 'X' over 'YY' inside a triangle.
- SHEET NUMBER WHERE DRAWN**: Symbol showing 'X' over 'YY' inside a triangle.
- EXTERIOR ELEVATION NUMBER**: Symbol showing 'X' over 'YY' inside a house-shaped outline.
- SHEET NUMBER WHERE DRAWN**: Symbol showing 'X' over 'YY' inside a house-shaped outline.
- DOOR NUMBER (DOOR SCHEDULE)**: Symbol showing a door icon with a circled 'X'.
- WINDOW NUMBER/LETTER (WINDOW SCHEDULE)**: Symbol showing a window icon with a circled 'X'.
- SPOT FINISH ELEVATION**: Symbol showing a spot finish icon with a circled 'Z'.
- KEYNOTE**: Symbol showing a circle with the letter 'I' inside.

INSTALLED INSULATING MATERIAL SHALL HAVE BEEN CERTIFIED BY THE MANUFACTURER TO COMPLY WITH THE CALIFORNIA QUALITY STANDARDS FOR INSULATING MATERIAL.

ALL INSULATING MATERIALS SHALL BE INSTALLED IN COMPLIANCE WITH THE FLAME SPREAD RATING AND SMOKE DENSITY REQUIREMENTS OF SECTION 2602 AND 707 OF THE CBC.

ALL EXTERIOR JOINTS AND OPENINGS IN THE BUILDING ENVELOPE THAT ARE OBSERVABLE SOURCES OF AIR LEAKAGE SHALL BE CALKED, GASKETED, OR WEATHERSTRIPPED.

SITE CONSTRUCTED DOORS, WINDOWS AND SKYLIGHTS SHALL BE CALKED BETWEEN THE JUNT AND THE BUILDING, AND SHALL BE WEATHER STRIPPED (EXCEPT FOR UNFRAMED GLASS DOORS AND FIRE DOORS)

MANUFACTURED DOORS AND WINDOWS INSTALLED SHALL HAVE AIR INFILTRATION RATES CERTIFIED BY THE MANUFACTURER PER 2-5366960L AFTER JULY 1, 1993, MANUFACTURED PENETRATION PRODUCTS MUST BE LABELED FOR U-VALUE ACCORDING TO NFRC AND MUST HAVE ALL OVERHEAD DOORS OF APPLICABLE TYPE PROVIDE CERTIFICATES OF COMPLIANCE FOR DOORS, WINDOWS & INSULATION.

THE COUNTY OF SAN BERNARDINO WISHES TO CONSTRUCT A NEW FIRE STATION ON 1920 DEL ROSA AVE. N, SAN BERNARDINO, CA, 92404. THE NEW FIRE STATION IS 8,952 SF, WHICH INCLUDES TWO APPARATUS BAYS W/ LOCKER ROOM, 8 SLEEPING QUARTERS, 4 BATHROOMS, 1 OFFICE, KITCHEN, DAYROOM, LAUNDRY, FITNESS, ETC. THE EXTERIOR INCLUDES A 20X20 STORAGE BUILDING, DIESEL FUEL TANK, EMERGENCY GENERATOR, HOSE DRYING RAMP, CMU SITE WALLS, ETC.


PRE-CONSTRUCTION CONFERENCE WITH THE GEOTECHNICAL ENGINEER SHALL BE HELD AT THE SITE PRIOR TO THE INITIATION OF SITE GRADING TO ASSURE A COMPLETE UNDERSTANDING OF THE REQUIREMENTS PRESENTED IN THIS REPORT AS THEY APPLY TO THE ACTUAL GRADING PERFORMED.

THE FOLLOWING SHALL BE INSPECTED BY THE GEOTECHNICAL ENGINEER:

- BUILDING PAD - WHEN OVER EXCAVATION WORK HAS REACHED BOTTOM.
- BUILDING PAD - WHEN OVER EXCAVATION MATERIAL IS BEING PLACED, TESTS SHOULD BE TAKEN • 2'-0" VERTICAL INTERVALS.
- MATERIAL IMPORT - WHEN PLACEMENT OF IMPORT MATERIAL, TESTS SHOULD BE TAKEN • 2'-0" VERTICAL INTERVALS.
- CONCRETE - PRIOR TO ANY BUILDING OR SITE CONCRETE PLACEMENT, (NON-RETAINING CMU WALLS DO NOT REQUIRE TESTING)
- CONCRETE - PRIOR TO THE PLACEMENT OF BASE, STEEL, & CONCRETE, THE COMPACTION SUB-GRADE SHOULD BE TESTED, THIS INCLUDES ALL CONCRETE SLABWORK.
- SITE UTILITY TRENCHES - ALL SITE UTILITY TRENCHES MUST BE TESTED FOR PROPER COMPACTION.
- SITE LIGHTING ELECTRICAL TRENCHES - ALL TRENCHES MUST BE TESTED FOR PROPER COMPACTION.
- LANDSCAPE SLEEVES - ALL TRENCHES FOR LANDSCAPE SLEEVES MUST BE TESTED FOR PROPER COMPACTION.

NOTE: THE GENERAL CONTRACTOR SHOULD BECOME FAMILIAR W/ THE SOLS REPORT PROVIDED AS PART OF THE SPECIFICATIONS.

SAN BERNARDINO COUNTY
FIRE STATION #226
PROJECT # 10.10.1032

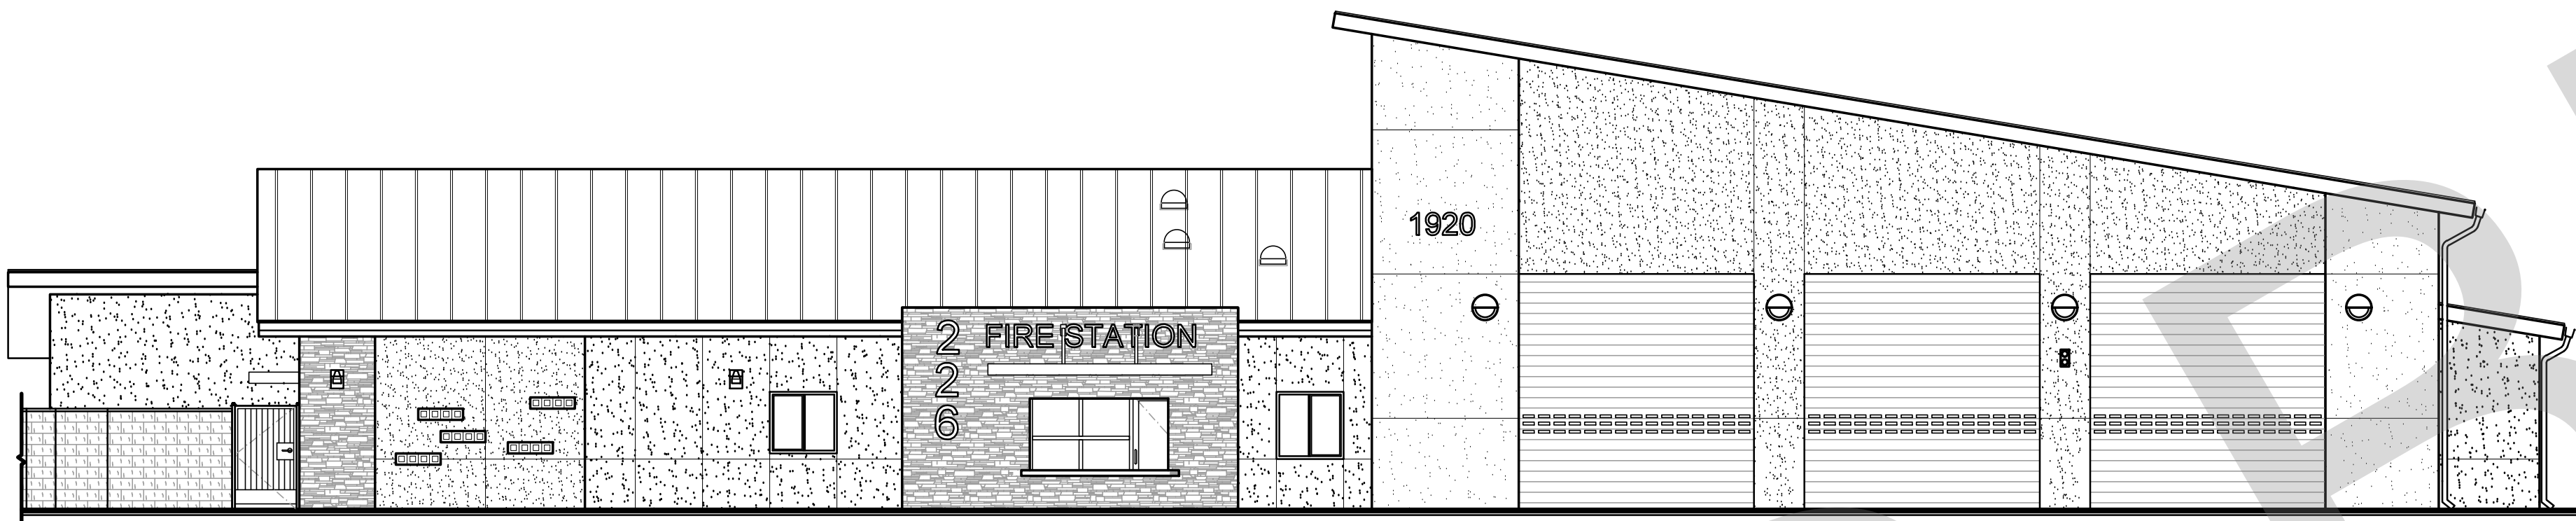

1920 DEL ROSA AVE. N.,
SAN BERNARDINO, CA. 92404

THE GENERAL BUILDING CONTRACTOR SHALL SUBMIT TO THE COUNTY OF SAN BERNARDINO PROJECT MANAGEMENT DIVISION THE FOLLOWING DOCUMENTS FOR REVIEW AND APPROVAL PRIOR TO COMMENCEMENT OF WORK:

1. THE SPRINKLER SYSTEM SHALL BE DESIGNED, ENGINEERED AND BUILT BY DESIGN CONTRACTOR & FIRE SPRINKLER SUB-CONTRACTOR. GENERAL CONTRACTOR TO GENERAL THE SYSTEM TO MEET NFPA 10B IN THE LIVING AREA AND NFPA 13 LIGHT HAZARD IN THE KITCHEN/BATH AREA. THE SYSTEM SHALL BE INSTALLED AS REQUIRED BY THE FIRE PREVENTION BUREAU UNDER A SEPARATE PERMIT (CSC 106.33). CONTRACTOR SHALL PROVIDE A COMPLETE AND FUNCTIONING SYSTEM INCLUDING ANY REQUIRED ELECT, WORKS, TRENCHING, ETC. TO THE OWNER AT NO ADDED COST.
2. IF C.B.C. SECTION 708 REQUIRES PROTECTION DURING CONSTRUCTION,
3. GENERAL CONTRACTOR TO PROVIDE ALL BACKING/DRAWING AS NECESSARY FOR LIGHTS, GRAB RAILS, PLASTER REVEALS, SIGNS, ETC. WITH NO ADDED COST TO THE OWNER.

D. DEFERRED SUBMITTAL / SEPARATE PERMITS

THE FOLLOWING ARE UNDER DEFERRED SUBMITTAL/SEPARATE PERMITS TO BE OBTAINED BY THE GENERAL CONTRACTOR:

- STRUCTURAL - GENERATOR (AND APPROVAL REQUIRED)
- FLAGPOLES - ABOVE GROUND FUEL TANK (FIRE DEPT. & SAN BERNARDINO COUNTY ENVIRONMENTAL HEALTH APPROVAL REQUIRED).
- SIGNS - UNDERGROUND FIRE LINE FROM STREET MAIN TO BUILDING
- FIRE SPRINKLER SYSTEM - FIRE ALARM
- TRUSSES - FIRE ALARM

SUBMITTAL DOCUMENTS (PLANS & CALCULATIONS) FOR DEFERRED ITEMS SHALL BE SUBMITTED TO THE BUILDING OFFICE (ENGINEER) FOR REVIEW. THEY MUST BE FORWARDED THEM TO THE BUILDING OFFICE WITH A NOTATION INDICATING THAT THE DEFERRED DOCUMENTS HAVE BEEN REVIEWED AND THAT THEY HAVE BEEN FOUND TO BE IN GENERAL CONFORMANCE WITH THE DESIGN OF THE BUILDING. THE DEFERRED ITEMS WILL BE REVIEWED AFTER THE DESIGN AND SUBMITTAL DOCUMENTS HAVE BEEN APPROVED BY THE BUILDING OFFICIAL.

CLEANOUTS INSTALLED UNDER CONCRETE OR ASPHALT PAVING SHALL BE ACCESSIBLE BY YARD BOXES, EXTENDED FLUSH WITH SURFACE WITH A BRASS CAP & COVER. IT SHALL BE MAINTAINED WHEN MATERIAL, WHEN USED FOR TRAFFIC. (TMCC 5.0.4(4P))

ELECTRICAL CODEBOOKS IN COMMERCIAL BUILDINGS TO BE BURIED 6' BELOW CONCRETE SLAB (TMCC 5.0.4(5)(C))

VERTICAL GLAZING SHALL HAVE UP-FLOWERS FOR TEMPERATURE 90-DSB OR DEFAULT VALUES PER UFGC (SECTION 7) OR ACM MANUAL (EXCEPTION TO IBC) 2.

F. REQUIRED SPECIAL INSPECTIONS

THE FOLLOWING SPECIAL INSPECTIONS PER 2019 C.B.C. ARE REQUIRED:

- SOLLS COMPLIANCE PRIOR TO FOUNDATION INSPECTIONS.
- STRUCTURAL CONCRETE OVER 2500 PSI
- FIELD WELDING
- HIGH-STRENGTH BOLTS.
- EXPANSION EPOXY ANCHORS.

PROVIDE STRUCTURAL SPECIAL INSPECTIONS, SEE SHEET SOI.

STRUCTURAL OBSERVATION BY THE ENGINEER/ARCHITECT SHALL BE PERFORMED. A STATEMENT IN WRITING SHALL BE GIVEN TO THE BUILDING OFFICIAL, STATING THAT THE SITE VISIT HAVE BEEN MADE AND WHETHER OR NOT ANY OBSERVED DEFICIENCIES HAVE BEEN CORRECTED TO CONFORM TO THE APPROVED PLANS AND SPECIFICATIONS. SECTION 10J.

WHEN SERVING MORE THAN 100 SPRINKLER HEADS, AUTOMATIC SPRINKLER SYSTEMS SHALL BE SUPERVISED BY AN APPROVED CENTRAL, PROPRIETARY OR REMOTE, STATION SERVICE OR SHALL BE PROVIDED A LOCAL ALARM WHICH WILL GIVE AN AUDIBLE SIGNAL AT A CONSTANTLY ATTENDED LOCATION. THE STATION SERVICE OR LOCAL CONTRACTOR SHALL PROVIDE FIRE ALARM AS REQUIRED BY THE FIRE DEPARTMENT. CONTRACTOR SHALL PROVIDE A COMPLETE AND FUNCTIONING SYSTEM, INCLUDING ANY REQUIRED ELECT., WORKS, TRENCHING, ETC. TO THE OWNER AT NO ADDED COST.

NO HAZARDOUS MATERIALS ARE TO BE STORED OR USED WITHIN THE BUILDING WHICH EXCEED THE QUANTITIES IN U.B.C. TABLES 3-D & 3-E.

PROVIDE CABLE/WIRE/CONDUIT FOR CATV SYSTEM PER ELEC'T.

PAINT CONC. CURB NEED & PROVIDE "BLUE" REFLECTOR IN THE STREET PER THE COUNTY OF SAN BERNARDINO FIRE DEPARTMENT REQUIREMENTS AT NO ADDED COST.

THE UNDERGROUND FIRE LINE IS NOT TO BE CONSTRUCTED UNTIL THE ABOVEGROUND FIRE SPRINKLER SYSTEM PLANS HAVE BEEN APPROVED BY THE COUNTY OF SAN BERNARDINO FIRE DEPARTMENT AND DISTRIBUTED TO ALL PARTIES (ARCHITECT AND OWNER).

GENERAL CONTRACTOR TO COORDINATE / PROVIDE A "COFFER-WIRE" PHONE LINE FROM TELEPHONE COMPANY TO TELEPHONE BACK BOARD.

PROVIDE A CONSTRUCTION WASTE MANAGEMENT PLAN AND DOCUMENTATION WHICH COMPLES WITH CGSB §406.2. REDUCE CONSTRUCTION WASTE BY RECYCLING OR REUSE MATERIALS OR BOTH BUILDING AND REMOVAL OPERATION. CONSTRUCTION WASTE DEBRIS, OR MEET LOCAL CONSTRUCTION AND DEMOLITION WASTE MANAGEMENT ORDINANCE, WHICHEVER IS MORE STRINGENT. CGSB §406.3

G. PROTECT PHASING

EXISTING FIRE STATION BUILDING SHALL REMAIN FULLY FUNCTIONAL AND OCCUPIED DURING THE DURATION OF THE CONSTRUCTION OF THE NEW FIRE STATION. THE GENERAL CONTRACTOR SHALL PROVIDE ANY TEMPORARY UTILITIES AND/OR ACCESS PATHWAYS/CORRWAYS THAT MAY BE REQUIRED FOR TRUCKS OR BOTH BUILDING AND REMOVAL OPERATION. CONSTRUCTION SHALL BE INCLUDED IN THE CONTRACTORS BID AND SHALL NOT INCUR ADDITIONAL COST TO THE OWNER.

H. PHASE II

- DEMOLISH AND SITE PREP ALL THAT IS REQUIRED WEST OF THE EXISTING FIRE STATION.
- CONSTRUCT ALL IMPROVEMENTS POSSIBLE TO THE WEST OF AND AROUND THE EXISTING FIRE STATION STRUCTURE WHILE KEEPING THE EXISTING FIRE STATION OPERATIONAL.
- MOVE THE NEW FIRE STATION BUILDING AND REMOVAL OPERATION. CONSTRUCTION IS GRANTED BY THE BUILDING OFFICIAL. THE OCCUPANTS OF THE EXISTING FIRE STATION MAY MOVE INTO THE NEW STATION.

I. PHASE III

- DEMOLISH THE EXISTING / OLD FIRE STATION AND ALL THE OLD IMPROVEMENTS EAST OF THE EXISTING STATION.
- CONSTRUCT THE BALANCE OF IMPROVEMENTS REQUIRED EAST OF THE NEW FIRE STATION.

GENERAL CONTRACTOR SHALL SUBMIT WRITTEN PLANS AND SCHEDULE THAT ADDRESSES ALL OF ABOVE IN MORE DETAIL PRIOR TO BEGINNING AND ON SITE CONSTRUCTION WORK.

OWNER

SAN BERNARDINO COUNTY
PROJECT & FACILITIES MANAGEMENT DEPARTMENT
BEVILLE LLOYD, PROJECT MANAGER
385 N. ARROWHEAD AVE.
SAN BERNARDINO, CA 92415
PHONE- (909) 387-5000

ARCHITECT

STK ARCHITECTURE, INC.
TONY PINALDI, ARCHITECT
42095 ZEVO DRIVE, STE. A-5
TEMECULA, CA 92590
951-296-980 / Tpinaldi@stkinc.com

STRUCTURAL ENGINEER

INNOVATIVE STRUCTURAL ENGINEERING
SHAWN LOTIROP, P.E., S.E. / CEO
27369 VIA INDUSTRIA
TEMECULA, CA 92590
951-600-0032 / Shawn@assgnhairs.com

M/E ENGINEER

SALAS O'BRIEN
ED DAVID, P.E.
3220 EXECUTIVE RIDGE, STE. 20
VISTA, CA 92081
(760)-950-0100 / ed.david@salasobrien.com

CIVIL ENGINEER

ERSC REDLANDS LOCATION
MATT BRUDIN, P.E. / PRINCIPAL
1861 W REDLANDS BLVD.
REDLANDS, CA 92373
909-890-1255 / Matt@erscinc.com

LANDSCAPE ARCHITECT

ALHAMBRA GROUP
VINCE DI DONATO
41635 ENTERPRISE CIRCLE N. STE. C
TEMECULA, CA 92590
951-296-6802 / Vince@alhambragroup.net

FOOTMILL FWY

210

E DATE ST.

PUMALO ST. E

E HIGHLAND AVE

PACIFIC ST.

DIA ROSA AVE N

PROJECT SITE

N.T.S.

ASSESSOR'S PARCEL NUMBER: 0273 - 011 - 22

FIRE STATION

OCCUPANCY GROUP = B, R2
TYPE OF CONSTRUCTION = V-B
SPRINKLERED (YES/NO) = YES
STORIES = 1
HEIGHT (ALLOWABLE 40'-0") = 20'-3"
BASIC ALLOWABLE FLOOR AREA = 25,000 SF.
ACTUAL WORK/SLEEP FLOOR AREA = 4,803 SF, < 28,000 SF. (OK)

APPARATUS BAY

OCCUPANCY GROUP = S2
TYPE OF CONSTRUCTION = V-B
SPRINKLERED (YES/NO) = YES
STORIES = 1
HEIGHT (ALLOWABLE 60'-0") = 26'-8"
BASIC ALLOWABLE FLOOR AREA = 54,000 SF.
ACTUAL APPARATUS BAY FLOOR AREA = 5,064 SF, < 54,000 F.S. (OK)

TOTAL FLOOR AREA R-2 PLUS S-2 = **9,867 SF.**
(FIRE STATION & APPARATUS)

STORAGE BUILDING

OCCUPANCY GROUP = S1
TYPE OF CONSTRUCTION = V-B
SPRINKLERED (YES/NO) = NO
STORIES = 1
HEIGHT = 14'-0"
BASIC ALLOWABLE FLOOR AREA = 9,000 SF.
ACTUAL STORAGE BLDG. FLOOR AREA = 400 SF, < 9,000 SF. (OK)

ALL WORK SHALL COMPLY WITH CURRENTLY ADOPTED:

2019 CALIFORNIA BUILDING CODE (CBC), PART 2, TITLE 24 C.C.R.
(2018 INTERNATIONAL BUILDING CODE)

2019 CALIFORNIA ELECTRICAL CODE (CEC), PART 3, TITLE 24 C.C.R.
(2018 NATIONAL ELECTRICAL CODE)

2019 CALIFORNIA MECHANICAL CODE (CMC) PART 4, TITLE 24 C.C.R.
(2018 UNIFORM MECHANICAL CODE)

2019 CALIFORNIA PLUMBING CODE (CPC), PART 5, TITLE 24 C.C.R.
(2018 UNIFORM PLUMBING CODE)

2019 CALIFORNIA GREEN BUILDING STANDARDS CODE

2019 CALIFORNIA ENERGY CODE

AMERICANS WITH DISABILITIES ACT 1990 WITH 2010 ADA STANDARDS FOR ACCESSIBLE
DESIGN AND 2010 REVISIONS TO TITLE II

LEGAL DESCRIPTION/CODE ANALYSIS

TU	-	TITLE SHEET
T12	-	CAL GREEN
<u>CIVIL</u>		
C1	-	TITLE SHEET
C21	-	PRECISE GRADING
C31	-	UTILITY PLAN
C41	-	EROSION CONTROL
C51	-	WOMP PLAN
C61	-	PRE-HYDROLOGY MAP
C71	-	POST-HYDROLOGY MAP
<u>LANDSCAPING</u>		
L-1	-	PLANTING PLAN
L-2	-	IRRIGATION PLAN
L-2	-	PLANTING & IRRIGATION DETAILS
<u>ARCHITECTURAL</u>		
A10	-	DEMOLITION PLAN
A11	-	SITE PLAN
A12	-	SITE DETAILS
A13	-	SITE DETAILS
A14	-	SITE DETAILS
A15	-	CAR PARK CANOPY DETAILS
A15J	-	CANOPY SECTIONS/ ELEVATIONS
A20	-	DIMENSION FLOOR PLAN
A21	-	REFERENCE FLOOR PLAN
A22	-	CLERESTORY FLOOR PLAN
A23	-	SCHEDULES
A24	-	DOOR & WINDOW DETAILS
A25	-	REFLECTED CEILING PLAN & DETAILS
A26	-	ROOF PLAN & DETAILS
A27	-	FINISH FLOOR PLAN
A31	-	BUILDING SECTIONS & DETAILS
A32	-	EXTERIOR ELEVATIONS
A42	-	INTERIOR ELEVATIONS
A51	-	INTERIOR ELEVATIONS
A52	-	INTERIOR ELEVATIONS
A61	-	MISCELLANEOUS DETAILS
A62	-	MISCELLANEOUS DETAILS

S0S	-	STRUCTURAL COVER SHEET
S01	-	STRUCTURAL NOTES
S02	-	STRUCTURAL NOTES
S1	-	FOUNDATION PLAN
S2	-	LOW ROOF FRAMING PLAN
S3	-	HIGH/ CLERESTORY ROOF FRAMING PLAN
S4	-	SITE STRUCTURES, STORAGE BUILDING & TRASH ENCLOSURE- ROOF FRAMING & FOUNDATION PLANS.
S5	-	SITE STRUCTURES, FUEL GENERATOR/ TANK CANOPY - ROOF FRAMING & FOUNDATION PLANS
S01	-	FOUNDATION DETAILS
S01	-	SITE & RETAINING WALL DETAILS
S02	-	GENERAL WOOD FRAMING DETAILS
S03	-	ROOF FRAMING DETAILS
S03/I	-	AWNING FRAMING DETAILS
S04	-	SITE STRUCTURES -ADDITIONAL DETAILS

M0.1	- MECHANICAL LEGEND AND GENERAL NOTES
M0.2	- MECHANICAL SCHEDULES
M0.3	- TITLE 24
M0.4	- TITLE 24
M2.1	- MECHANICAL FLOOR PLAN
M5.1	- MECHANICAL DETAILS
M5.2	- MECHANICAL DETAILS

P01	- PLUMBING LEGEND AND GENERAL NOTES
P02	- PLUMBING SCHEDULES & CALCULATIONS
P03	- PLUMBING SCHEDULES
P04	- PLUMBING SITE PLAN
P21	- PLUMBING FLOOR PLAN SEWER & VENT
P22	- PLUMBING FLOOR PLAN DOMESTIC WATER
P23	- PLUMBING FLOOR PLAN
P41	- PLUMBING RISER DIAGRAM
P42	- PLUMBING RISER DIAGRAM
P51	- PLUMBING DETAILS
P52	- PLUMBING DETAILS

E0J1	- ELECTRICAL LEGEND AND GENERAL NOTES
E0J2	- ELECTRICAL SCHEDULES
E0J3	- EXTERIOR TITLE 24
E0J4	- INTERIOR TITLE 24
E1J1	- ELECTRICAL SITE PLAN
E2J1	- LIGHTING FLOOR PLAN
E2JEM	- LIGHTING PHOTOMETRIC EMERGENCY
E2JPH	- LIGHTING PHOTOMETRIC
E2J2	- POWER FLOOR PLAN
E2J3	- ELECTRICAL FLOOR PLAN
E4J1	- SINGLE LINE DIAGRAM AND LOAD SUMMARY
E4J2	- PANEL SCHEDULES
E5J1	- ELECTRICAL DETAILS

DATA21 - DATA PLAN
DATA22 - FIRE ALERT SYSTEM



PROJECT ADMINISTERED BY:
SAN BERNARDINO COUNTY
PROJECT & FACILITIES
MANAGEMENT DEPARTMENT

385 N. ARROWHEAD AVE.
SAN BERNARDINO, CA 92415

PROJECT NAME:
SAN BERNARDINO
COUNTY FIRE
DEPARTMENT:
FIRE STATION 226

PROJECT # 10.10.1032

CIP #21-037

CAFM # SABI98

APN # 0273-011-22

1920 DEL ROSA AVE N
SAN BERNARDINO,
CA 92404

ISSUE INFORMATION:	
DATE:	INFORMATION:
04-11-2022	20% CD SET
04-28-2022	50% CD SET
06-15-2022	95% CD SET
09-16-2022	95% CD- 3rd BA
10-03-2022	PLAN CHECK

SHEET INFORMATION

STK PROJECT NO.: 374-154-
SCALE: AS NOTED
DATE: JANUARY 20
PLOT DATE:
DRAWING NAME:

SEAL:



SHEET TITLE

TITLE SHEET

SHEET NO.:

T1.1

CA GREEN BUILDING CODE REQUIREMENTS

- STORM WATER POLLUTION PREVENTION: New construction projects and additions less than one acre of land shall prevent the pollution of storm water runoff from the construction activities through Local ordinances - SWPPP. The SWPPP shall be designed conforming to the State Storm Water NPDES Construction Permit and be specific to the site. CGBC Section 5.106.1
2. BICYCLE PARKING: Shall comply with the requirements of CGBC 5.106.4.1 and 5.106.4.2. Provide for short term and long term bicycle parking.
- 3.1 DESIGNATED PARKING for CLEAN AIR VEHICLES: Provide designated parking for low-emitting, fuel-efficient and carpool/van pool vehicles per CGBC Table 5.106.5.2, and mark CLEAN AIR VEHICLE. CGBC 5.106.5.2
- 3.2 ELECTRIC VEHICLE CHARGING: Provide charging space requirements, amount of spaces and identification per CGBC 5.106.5.3.1-4
4. LIGHT POLLUTION REDUCTION: Design interior and exterior lighting such that zero direct-beam illumination leaves the building site. CGBC 5.106.8
5. GRADING and PAVING: The site shall be planned and developed to keep surface water from entering building. CGBC 5.106.10
6. ENERGY EFFICIENCY: California Energy Code (DSA-SS). For the purposes of mandatory energy efficiency standards in this code, the California Energy Commission will continue to adopt mandatory building standards. CGBC 5.20.1
7. WATER CONSERVING FIXTURES: Plumbing fixtures and fittings shall meet the Standards Referenced in table 5.303.3. Reduce potable water use by at least 20 percent. CGBC 5.303.2
8. OUTDOOR WATER USE: The provisions of Section 5.304, Outdoor Water Use reference the mandatory Model Water Efficiency Landscape Ordinance (MWELO) contained within Chapter 2.7, Division 2, Title 23, California Code of Regulations.
9. OUTDOOR WATER USE- REHABILITATED LANDSCAPE PROJECTS EQUAL TO OR GREATER THAN 2,500 SQUARE FEET. Rehabilitated landscape project with an aggregate landscape area equal to or greater than 2,500 square feet requiring a building or landscape permit, plan check, or design review shall comply with CGBC 5.304.2, Item 1 or 2.
10. OUTDOOR WATER USE: Areas equal to or greater than 500 SF. When water is used for outdoor irrigation for new construction projects with an aggregate landscape area equal to or greater than 500 square feet requiring a building or landscape permit, plan check or design review, one of the following shall apply: A local water efficient landscape ordinance that is, based on evidence in the record, at least as effective in conserving water as the updated model ordinance adopted by the Department of Water Resources (DWR) per Government Code Section 65595(c). The California Department of Water Resources Model Water Efficient Landscape Ordinance (MWELO) commencing with Section 490 of Chapter 2.7, Division 2, Title 23, California Code of Regulations. CGBC 5.304.2
11. OUTDOOR WATER USE IN LANDSCAPE AREAS 2,500 SF and Less: Any project with an aggregate area of 2,500 square feet or less may comply with the performance requirements of MWELO or conform to the prescriptive compliance measures contained in MWELO's Appendix D. CGBC 5.304.4
12. Automatic irrigation controllers that are weather- or soil moisture-based shall be installed at the time of final inspection. CGBC 5.304.3.1
13. SPRINKLERS: Sprinklers shall be designed to prevent spray on structures CGBC 5.407.2.1
14. ENTRIES AND OPENINGS: Exterior entries and openings shall be designed to prevent water intrusion into buildings. CGBC 5.407.2.2.1 Install flashing integrated with a drainage plane. CGBC 5.407.2.2.2
15. CONSTRUCTION WASTE REDUCTION: Reduce construction waste by recycling or salvaging for re-use a minimum of 65 percent of the nonhazardous construction and demolition debris, or meet the local construction and demolition waste management ordinance, whichever is more stringent. CGBC 5.408.3
16. CONSTRUCTION WASTE REDUCTION: A construction waste management plan shall be provided prior to start of construction. CGBC 5.408.1.1
17. CONSTRUCTION WASTE REDUCTION: Provide a construction waste management plan and documentation which complies with CGBC 5.408.1.1
18. EXCAVATED SOIL and LAND CLEARING DEBRIS: 100% of trees, stumps, rocks, and associated vegetation and soils resulting primarily from land clearing shall be reused or recycled. CGBC 5.408.4
19. RECYCLING BY OCCUPANTS: Readily accessible areas for recycling paper, corrugated cardboard, glass, plastics and metals shall be provided to serve the entire building CGBC 5.410.1
20. Provide commissioning requirements as listed. Include owner's project requirement, basis of design, commissioning plan, and all other requirements per CGBC 5.410.2.1-2
21. POLLUTANT CONTROL: All duct openings and other air distribution component openings shall be protected during storage on the construction site until final start-up with tape, plastic, sheet metal, or other acceptable methods to reduce the amount of dust and debris which may collect in the system. CGBC 5.504.3
22. FINISH MATERIAL POLLUTANT CONTROL: Adhesives, adhesive bonding primers, adhesive primers, sealants, sealant primers, and caulks shall comply with local or regional air pollution control or air quality management district rules where applicable, or SCAQMD Rule 1168 VOC limits and prohibition on the use of certain toxic chemicals, except per subsection 2. CGBC 5.504.4.1, subsection 1
23. ADHESIVES, SEALANTS AND CAULKS: Aerosol adhesives, smaller unit sizes of adhesives, and sealant or caulking compounds (in units of product, less packing, which do not weigh more than 1 pound and do not consist of more than 16 fluid ounces) shall comply with statewide VOC standards and other requirements, including prohibitions on the use of certain toxic compounds, of CCR, Title 17, commencing with Section 94507. CGBC 5.504.4.1, subsection 2
24. PAINTS AND COATINGS: VOC Content Limits for Architectural Coatings (Architectural Paints) shall comply with CGBC Table 5.504.4.3, unless more stringent local limits apply. CGBC 5.504.4.3
25. PAINTS AND COATINGS: Aerosol paints and coatings shall meet the requirements of Sections 94522(a)(3), 94522(c)(2), and (d)(2) of California Code of Regulations, Title 17 commencing with Section 94520. CGBC 5.504.4.3.1
26. CARPET SYSTEMS: Carpets shall meet one of the following: 1. Carpet and Rug Institute's Green Label Plus Program. 2. California Department of Public Health Standard Practice for the testing of VOCs (Specification 01350). 3. NSF/ANSI 140 at the Gold Level. 4. Scientific Certifications Systems Indoor Advantage™ Gold. CGBC 5.504.4.4
27. CARPET SYSTEMS: Carpet cushion shall meet the requirements of the Carpet and Rug Institute Green Label Program; carpet adhesive shall meet the requirements of Table 5.504.4.1 CGBC 5.504.4.4.1, 5.504.4.4.2
28. COMPOSITE WOOD PRODUCTS: Hardwood plywood, particleboard, and medium density fiberboard composite wood products shall meet the requirements for Formaldehyde Limits in Table 5.504.4.5, and as specified AN ARBs Air Toxics Control Measure for Composite Wood. GBC 5.504.4.5
29. RESILIENT FLOORING SYSTEMS: At least 80 percent of the floor area shall comply with VOC emission limits defined in the 2009 Collaborative for High Performance Schools (CHPS) Low-emitting Materials List or certified under the Resilient Floor Covering Institute (RFCI) FloorScore program. CGBC 5.504.4.7
30. DOCUMENTATION/VERIFICATION OF COMPLIANCE: Pollutant control documentation shall be provided to indicate compliance with Section 5.504 and shall include at least one of the following: Product certifications and specifications, chain of custody certifications, or other methods acceptable to the enforcing agency. CGBC 5.504.4.5.2
31. FILTERS: Provide filters with a Minimum Efficiency Reporting Value (MERV) of at least 8 for outside and return air in regularly occupied areas of mechanically ventilated buildings. CGBC 5.504.5.3
32. ENVIRONMENTAL TOBACCO SMOKE: Where outdoor areas are provided for smoking, prohibit smoking within 25 feet of building entries, outdoor air intakes, and operable windows and in buildings. Meet additional and more stringent requirements in applicable ordinances, regulations, and policies. CGBC 5.504.7
33. INDOOR MOISTURE CONTROL: buildings shall comply with CBC Section 1203 (Ventilation) and Chapter 14 (Exterior Walls). CGBC 5.505 Also refer to the requirements of CGBC 5.407 that reference CBC Section 1403.2 (Weather Protection), CEC section 150 (Mandatory Features and Devices), and text indicating the proper design of sprinklers and building openings shall help assure water remains outside the building. CGBC 5.505.1 31. For indoor air quality, meet the requirements of the CEC for outside air delivery and carbon dioxide monitoring. CGBC 5.506
34. HVAC, refrigeration, and fire-suppression equipment shall not contain CFCs or Halon. CGBC 5.508
35. Provide an operation and maintenance manual with content per 5.410.4.5 (when new construction is over 10,000SF) and in a format acceptable to the Enforcing Agency - shall be placed in the building at the time of Final Inspection. CGBC 5.410.4.5
36. ENVIRONMENTAL COMFORT: Roof and wall assemblies exposed to noise sources shall have an STC rating of at least 50, with exterior windows having a minimum of 40 in the following locations, per CGBC 5.507.4 (or as directed by the Building Official):
- a) Within the 65 CNEL Noise Contour of a freeway, railroad or industrial source, as determined by the jurisdiction's Noise Element of the General Plan.
- b) Within the 65 CNEL contour of an airport.
37. OUTDOOR AIR QUALITY: Ozone Depletion and Greenhouse Gas Reductions. Installations of HVAC, Refrigeration and Fire Suppression Equipment shall comply with SECTIONS 5.508.1.1 AND 5.508.1.2
38. 5.508.1.1 CHLOROFLUOROCARBONS (CFCs). INSTALL HVAC, REFRIGERATION AND FIRE SUPPRESSION EQUIPMENT THAT DO NOT CONTAIN CFCs.
39. 5.508.1.2 HALONS. INSTALL HVAC, REFRIGERATION AND FIRE SUPPRESSION EQUIPMENT THAT DO NOT CONTAIN HALONS.



CONSULTANT:

PROJECT ADMINISTERED BY:
SAN BERNARDINO COUNTY
PROJECT & FACILITIES
MANAGEMENT DEPARTMENT

385 N. ARROWHEAD AVE.
SAN BERNARDINO, CA 92415

PROJECT NAME:

SAN BERNARDINO
COUNTY FIRE
DEPARTMENT:
FIRE STATION 226

PROJECT # 10.10.1032

CIP #21-037

CAFM # SABI98

APN #: 0273-011-22

1920 DEL ROSA AVE N
SAN BERNARDINO,
CA 92404

ISSUE INFORMATION:

DATE:	INFORMATION:
04-11-2022	20% CD SET
04-28-2022	50% CD SET
06-15-2022	95% CD SET
09-16-2022	95% CD- 3rd BA
10-03-2022	PLAN CHECK

SHEET INFORMATION

STK PROJECT NO.: 374-154-
SCALE: AS NOTED
DATE: JANUARY 20
PLOT DATE:
DRAWING NAME:

SEAL:



SHEET TITLE

CAL GREEN

SHEET NO.

T1.2

SAN BERNARDINO COUNTY

FIRE STATION NO.226

GRADING NOTES:

1. ALL GRADING SHALL CONFORM TO THE LATEST CALIFORNIA BUILDING CODE (CBC) CHAPTERS 17, 18, APPENDIX-J AND ALL APPLICABLE SECTIONS.
2. A GRADING PERMIT SHALL BE OBTAINED PRIOR TO COMMENCEMENT OF ANY WORK ON THE SITE.
3. ISSUANCE OF A GRADING PERMIT DOES NOT ELIMINATE THE NEED FOR PERMITS FROM OTHER REGULATORY AGENCIES WITH REGULATORY RESPONSIBILITIES FOR CONSTRUCTION ACTIVITIES ASSOCIATED WITH THE WORK AUTHORIZED IN THIS PLAN.
4. ALL WORK UNDER THIS PERMIT SHALL BE LIMITED TO WORK WITHIN THE PROPERTY LINES. A SEPARATE CONSTRUCTION, EXCAVATION OR ENCROACHMENT PERMIT FROM THE DEPARTMENT OF PUBLIC WORKS MAY BE REQUIRED FOR ANY WORK WITHIN THE COUNTY RIGHT-OF-WAY.
5. APPROVAL OF THESE PLANS DOES NOT AUTHORIZE ANY WORK OR GRADING TO BE PERFORMED UNTIL THE EFFECTIVE PROPERTY OWNER'S PERMISSION HAS BEEN OBTAINED AND VALID GRADING PERMIT HAS BEEN ISSUED.
6. THIS PLAN IS FOR GRADING PURPOSES ONLY AND IS NOT TO BE USED FOR THE PURPOSE OF CONSTRUCTING ONSITE OR OFFSITE IMPROVEMENTS. ISSUANCE OF A PERMIT BASED ON THIS PLAN DOES NOT CONSTITUTE APPROVAL OF DRIVEWAY LOCATIONS OR SIZES, PARKING LOT STRUCTURAL SECTIONS OR LAYOUT, ADA-RELATED REQUIREMENTS, BUILDING LOCATIONS OR FOUNDATIONS, WALLS, CURBING, OFFSITE DRAINAGE FACILITIES OR OTHER ITEMS NOT RELATED DIRECTLY TO THE BASIC GRADING OPERATION. ONSITE IMPROVEMENTS SHALL BE CONSTRUCTED IN ACCORDANCE TO THE APPROVED BUILDING PERMIT PLANS. OFFSITE IMPROVEMENTS SHALL BE CONSTRUCTED IN ACCORDANCE TO PLANS APPROVED FOR THIS PURPOSE BY THE PUBLIC WORKS DEPARTMENT.
7. MAXIMUM CUT AND FILL SLOPE = 2:1 (HORIZONTAL TO VERTICAL) AND MAXIMUM VERTICAL HEIGHT = 30 FEET, UNLESS AN APPROVED GEOTECHNICAL REPORT CAN JUSTIFY A STEEPER AND TALLER SLOPE.
8. NO FILL SHALL BE PLACED ON EXISTING GROUND UNTIL THE GROUND HAS BEEN CLEARED OF WEEDS, DEBRIS, TOPSOIL AND OTHER DELETERIOUS MATERIAL.
9. FILL SLOPES SHALL NOT HAVE LESS THAN 90% RELATIVE COMPACTION, OR AS RECOMMENDED ON THE APPROVED GEOTECHNICAL REPORT.
10. IT IS THE GRADING CONTRACTOR'S RESPONSIBILITY TO ENSURE THAT ADEQUATE COMPACTION HAS BEEN ATTAINED ON THE ENTIRE GRADING SITE, INCLUDING FILL AREAS OUTSIDE THE BUILDING PADS AND ON ALL FILL SLOPES.
11. UNLESS OTHERWISE RECOMMENDED IN AN APPROVED GEOTECHNICAL REPORT, OVER-EXCAVATION SHALL BE AT LEAST 24 INCHES MINIMUM BELOW THE BOTTOM OF FOOTINGS OR TO COMPETENT NATIVE SOIL OR BEDROCK MATERIALS, WHICHEVER IS DEEPER, AS APPROVED BY THE PROJECT'S GEOTECHNICAL ENGINEER OR GEOLOGIST.
12. EARTHWORK VOLUMES:
CUT = 887.0 CY, FILL = 2,863.0 CY, TOTAL DISTURBED AREA = 20,049.0 (SF)
13. EARTHWORK QUANTITIES ARE SHOWN FOR GRADING PERMIT PURPOSES ONLY, AND SAN BERNARDINO COUNTY IS NOT RESPONSIBLE FOR THEIR ACCURACY.
14. A COPY OF THE GRADING PERMIT AND APPROVED GRADING PLANS MUST BE IN THE POSSESSION OF A RESPONSIBLE PERSON AND AVAILABLE AT THE SITE AT ALL TIMES.
15. ANY ONSITE RETAINING WALLS SHOWN ON THE GRADING PLANS THAT ARE OVER 4' IN HEIGHT, MEASURED FROM TOP OF WALL TO BOTTOM OF FOOTING, ARE FOR REFERENCE ONLY. RETAINING WALLS OVER 4' IN HEIGHT ARE NOT CHECKED, PERMITTED, OR INSPECTED PER THE GRADING PERMIT. A SEPARATE RETAINING WALL PERMIT IS REQUIRED FOR ALL RETAINING WALLS OVER 4' IN HEIGHT.
16. ANY WALLS, FENCES, STRUCTURES AND/OR APPURTENANCES ADJACENT TO THIS PROJECT ARE TO BE PROTECTED IN PLACE. IF GRADING OPERATIONS DAMAGE OR ADVERSELY AFFECT SAID ITEMS IN ANY WAY, THE CONTRACTOR AND/OR DEVELOPER IS RESPONSIBLE FOR WORKING OUT AN ACCEPTABLE SOLUTION TO THE SATISFACTION OF THE AFFECTED PROPERTY OWNER(S).
17. FOR SITES WITH PROTECTED SPECIES OR TREES, THE PROPOSED GRADING MAY BE SUBJECT TO A SEPARATE PERMIT.
18. ADEQUATE FIRE ACCESS AROUND BUILDINGS (INCLUDING GARAGES) SHOULD BE PROVIDED AS APPROVED BY COUNTY FIRE.
19. EXISTING DRAINAGE COURSES SHALL NOT BE OBSTRUCTED, ALTERED, OR DIVERTED WITHOUT PRIOR APPROVAL FROM THE COUNTY OF SAN BERNARDINO, LAND DEVELOPMENT DIVISION. A STREAMBED ALTERATION AGREEMENT MAY ALSO BE REQUIRED FROM THE CALIFORNIA DEPARTMENT OF FISH AND WILDLIFE.
20. DRAINAGE EASEMENTS SHALL NOT BE OBSTRUCTED, ALTERED OR DIVERTED WITHOUT PRIOR APPROVAL OF THE COUNTY OF SAN BERNARDINO, LAND DEVELOPMENT DIVISION.
21. SETBACKS AND BUILDING LOCATIONS SHOWN ON THIS PLAN ARE FOR REFERENCE ONLY AND MUST BE REVIEWED AND APPROVED UNDER A SEPARATE BUILDING PERMIT.
22. UTILITY AND SEPTIC IMPROVEMENTS SHOWN ON THIS PLAN ARE FOR REFERENCE ONLY AND MUST BE REVIEWED AND APPROVED UNDER A SEPARATE BUILDING PERMIT.
23. ON PROJECTS DISTURBING ONE ACRE OR MORE, THE FOLLOWING NOTE MUST BE ADDED: A NOTICE OF INTENT (NOI) HAS BEEN, OR WILL BE FILED WITH THE STATE WATER RESOURCES CONTROL BOARD (SWRCB) AND A STORM WATER POLLUTION PREVENTION PLAN (SWPPP) HAS BEEN OR WILL BE PREPARED IN ACCORDANCE WITH THE REQUIREMENTS OF CALIFORNIA GENERAL PERMIT FOR STORM WATER DISCHARGES ASSOCIATED WITH CONSTRUCTION ACTIVITY (PERMIT NO. CAS000002) FOR ALL OPERATIONS ASSOCIATED WITH THESE PLANS. THE PERMITTEE SHALL KEEP A COPY OF THE SWPPP ON SITE AND AVAILABLE FOR REVIEW BY COUNTY.
24. IN CONJUNCTION WITH THE CALIFORNIA GENERAL PERMIT FOR PROPOSED DISTURBANCE OVER ONE ACRE, AN ACTIVE WASTEWATER DISCHARGE ID # (WDOI) MUST BE INCLUDED ON THE FINAL GRADING PLAN.
25. FOR ENGINEERED GRADING, A FINAL GRADING CERTIFICATION WILL BE COLLECTED BY THE BUILDING INSPECTOR AT THE FINAL BUILDING INSPECTION OR PRIOR A GRADING FINAL STATUS ON THE PERMIT. THE FINAL GRADING CERTIFICATION IS TO BE COMPLETED BY THE ENGINEER OF RECORD ON THE APPROVED GRADING PLANS.
26. ALL FLOOD ZONE REQUIREMENTS MUST BE REFLECTED OR ACCOUNTED FOR ON THE GRADING PLANS. ELEVATIONS OR CONSTRUCTION NOTES MUST BE INCLUDED IN THE PLANS TO ENSURE COMPLIANCE WITH ALL APPLICABLE FIRST FLOOR ELEVATION REQUIREMENTS PER FEMA AND SAN BERNARDINO COUNTY DEVELOPMENT CODE GUIDELINES.
27. FOR NONRESIDENTIAL PROJECTS, PROVIDE FOLLOWING NOTE ON PLANS:
CALIFORNIA GREEN BUILDING STANDARDS CODE
5.408.3 EXCAVATED SOIL AND LAND CLEARING DEBRIS.
100 PERCENT OF TREES, STUMPS, ROCKS AND ASSOCIATED VEGETATION AND SOILS RESULTING PRIMARILY FROM LAND CLEARING SHALL BE REUSED OR RECYCLED. FOR A PHASED PROJECT, SUCH MATERIAL MAY BE STOCKPILED ON SITE UNTIL THE STORAGE SITE IS DEVELOPED.
EXCEPTION: REUSE, EITHER ON-OR OFF-SITE, OF VEGETATION OR SOIL CONTAMINATED BY DISEASE OR PEST INFESTATION.

EROSION CONTROL NOTES:

1. IN CASE OF EMERGENCY, CALL [RESPONSIBLE PERSON] AT [24-HOUR TELEPHONE].
2. POLLUTION AND EROSION PREVENTION MEASURES, ALSO KNOWN AS BEST MANAGEMENT PRACTICES (BMPs), MUST BE INSTALLED PRIOR TO GRADING. THESE MEASURES, INCLUDING THE PREVENTION OF SEDIMENTATION OR FLOOD DAMAGE, TO OFFSITE PROPERTY SHALL BE ADEQUATE WHETHER OR NOT AN EROSION CONTROL PERMIT IS REQUIRED.
3. ERODED SEDIMENTS AND OTHER POLLUTANTS MUST BE RETAINED ONSITE AND MAY NOT BE TRANSPORTED FROM THE SITE VIA SHEET FLOW, SWALES, AREA DRAINS, NATURAL DRAINAGE COURSES, OR WIND.
4. EROSION CONTROL DEVICES SHALL BE FUNCTIONING AT ALL TIMES. IN CASE OF FAILURE, RAPID CONSTRUCTION OF EMERGENCY DEVICES SHALL BE IMPLEMENTED.
5. STOCKPILES OF EARTH AND OTHER CONSTRUCTION-RELATED MATERIALS MUST BE PROTECTED FROM BEING TRANSPORTED FROM THE SITE BY THE FORCES OF WIND OR WATER.
6. FUELS, OILS, SOLVENTS, AND OTHER TOXIC MATERIALS MUST BE STORED IN ACCORDANCE WITH THEIR LISTING AND ARE NOT TO CONTAMINATE THE SOILS AND SURFACE WATERS. ALL APPROVED STORAGE CONTAINERS ARE TO BE PROTECTED FROM THE WEATHER. SPILLS MUST BE CLEANED UP IMMEDIATELY AND DISPOSED OF IN A PROPER MANNER. SPILLS MAY NOT BE WASHED INTO THE DRAINAGE SYSTEM.
7. EXCESS OR WASTE CONCRETE MUST BE CONTAINED ONSITE. PROVISIONS SHALL BE MADE TO RETAIN CONCRETE WASTES ONSITE UNTIL THEY CAN BE DISPOSED OF AS SOLID WASTE.
8. DEVELOPERS/CONTRACTORS ARE RESPONSIBLE TO ENSURE ALL EROSION CONTROL DEVICES AND BMPs ARE INSTALLED AND FUNCTIONING PROPERLY PER PLAN. PROPER PRECAUTION SHALL BE CONSIDERED WHEN 50% OR GREATER PROBABILITY OF PREDICTED PRECIPITATION, AND AFTER ACTUAL PRECIPITATION. A CONSTRUCTION SITE INSPECTION CHECKLIST AND INSPECTION LOG SHALL BE MAINTAINED AT THE PROJECT SITE AT ALL TIMES AND AVAILABLE FOR REVIEW BY THE BUILDING OFFICIAL.
9. TRASH AND CONSTRUCTION-RELATED SOLID WASTES MUST BE DEPOSITED INTO A COVERED RECEPTACLE TO PREVENT CONTAMINATION OF RAINWATER AND DISPERSAL BY WIND.
10. SEDIMENTS AND OTHER MATERIALS MAY NOT BE TRACKED FROM THE SITE BY VEHICLE TRAFFIC. THE CONSTRUCTION ENTRANCE ROADWAYS MUST BE STABILIZED SO AS TO INHIBIT SEDIMENTS FROM BEING DEPOSITED INTO THE PUBLIC WAY. ACCIDENTAL DEPOSITIONS MUST BE SWEEPED UP IMMEDIATELY AND MAY NOT BE WASHED DOWN BY RAIN OR OTHER MEANS.
11. ANY SLOPES WITH DISTURBED SOILS OR DENuded OF VEGETATION MUST BE STABILIZED SO AS TO INHIBIT EROSION BY WIND AND WATER.
12. ALL SILT AND DEBRIS SHALL BE REMOVED FROM ALL DEVICES WITHIN 24 HOURS AFTER EACH RAINSTORM AND BE DISPOSED OF PROPERLY.
13. ALL STORM WATER CAPTURE DEVICES SHALL BE PROTECTED AT ALL TIMES.

CIVIL ENGINEER'S STATEMENT:

"I CERTIFY THAT I WILL BE RESPONSIBLE FOR THIS GRADING IN ACCORDANCE WITH SECTION 7014(C) OF THE BUILDING CODE TO INCLUDE INCORPORATING ALL RECOMMENDATIONS OF THE SOILS ENGINEER, REPORT AND BE RESPONSIBLE FOR PROFESSIONAL INSPECTION AND APPROVAL OF THE GRADING. THIS SHALL INCLUDE, BUT NOT BE LIMITED TO, INSPECTION AND APPROVAL AS TO THE ESTABLISHMENT OF LINE, GRADE AND DRAINAGE OF DEVELOPMENT AREA. I WILL ALSO BE RESPONSIBLE FOR THE PREPARATION OF REVISED PLANS AND THE SUBMISSION OF 'AS GRADED' GRADING PLANS UPON THE COMPLETION OF THE WORK."

SUPERVISING CIVIL ENGINEER R.C.E. NUMBER DATE


SOILS ENGINEER'S STATEMENT:

"I SHALL PROVIDE PROFESSIONAL INSPECTION AND APPROVAL CONCERNING THE PREPARATION OF GROUND TO RECEIVE FILLS, TESTING FOR REQUIRED COMPACTION STABILITY OF ALL FINISHED SLOPES AND INCORPORATING THE DATE SUPPLIED BY THE ENGINEERING GEOLOGIST AND THE PREPARATION OF THE SOILS GRADING REPORT."

SUPERVISING CIVIL ENGINEER R.C.E. NUMBER DATE
(TO BE SIGNED PRIOR TO ISSUANCE OF GRADING PERMIT BY SOILS ENGINEER OF RECORD)

NO GRADING IN EXCESS OF 5000 CU. YDS. SHALL BE STARTED WITHOUT FIRST NOTIFYING THE ENGINEER. A PRE-GRADING MEETING AT THE SITE IS REQUIRED BEFORE START OF GRADING WITH THE FOLLOWING PEOPLE PRESENT: OWNER, GRADING CONTRACTOR, SUPERVISING CIVIL ENGINEER, SOILS ENGINEER AND/OR GEOLOGIST, CITY CONSTRUCTION INSPECTORS OR THEIR REPRESENTATIVES.

THE PERMITTEE OR HIS AGENT SHALL NOTIFY THE CITY OF SAN BERNARDINO WHEN THE GRADING OPERATION (EXCEEDING 5000 CU. YDS.) IS READY FOR REQUIRED INSPECTIONS AS SHOWN IN THE TESTING AND INSPECTION REQUIREMENTS OF DIVISION V.

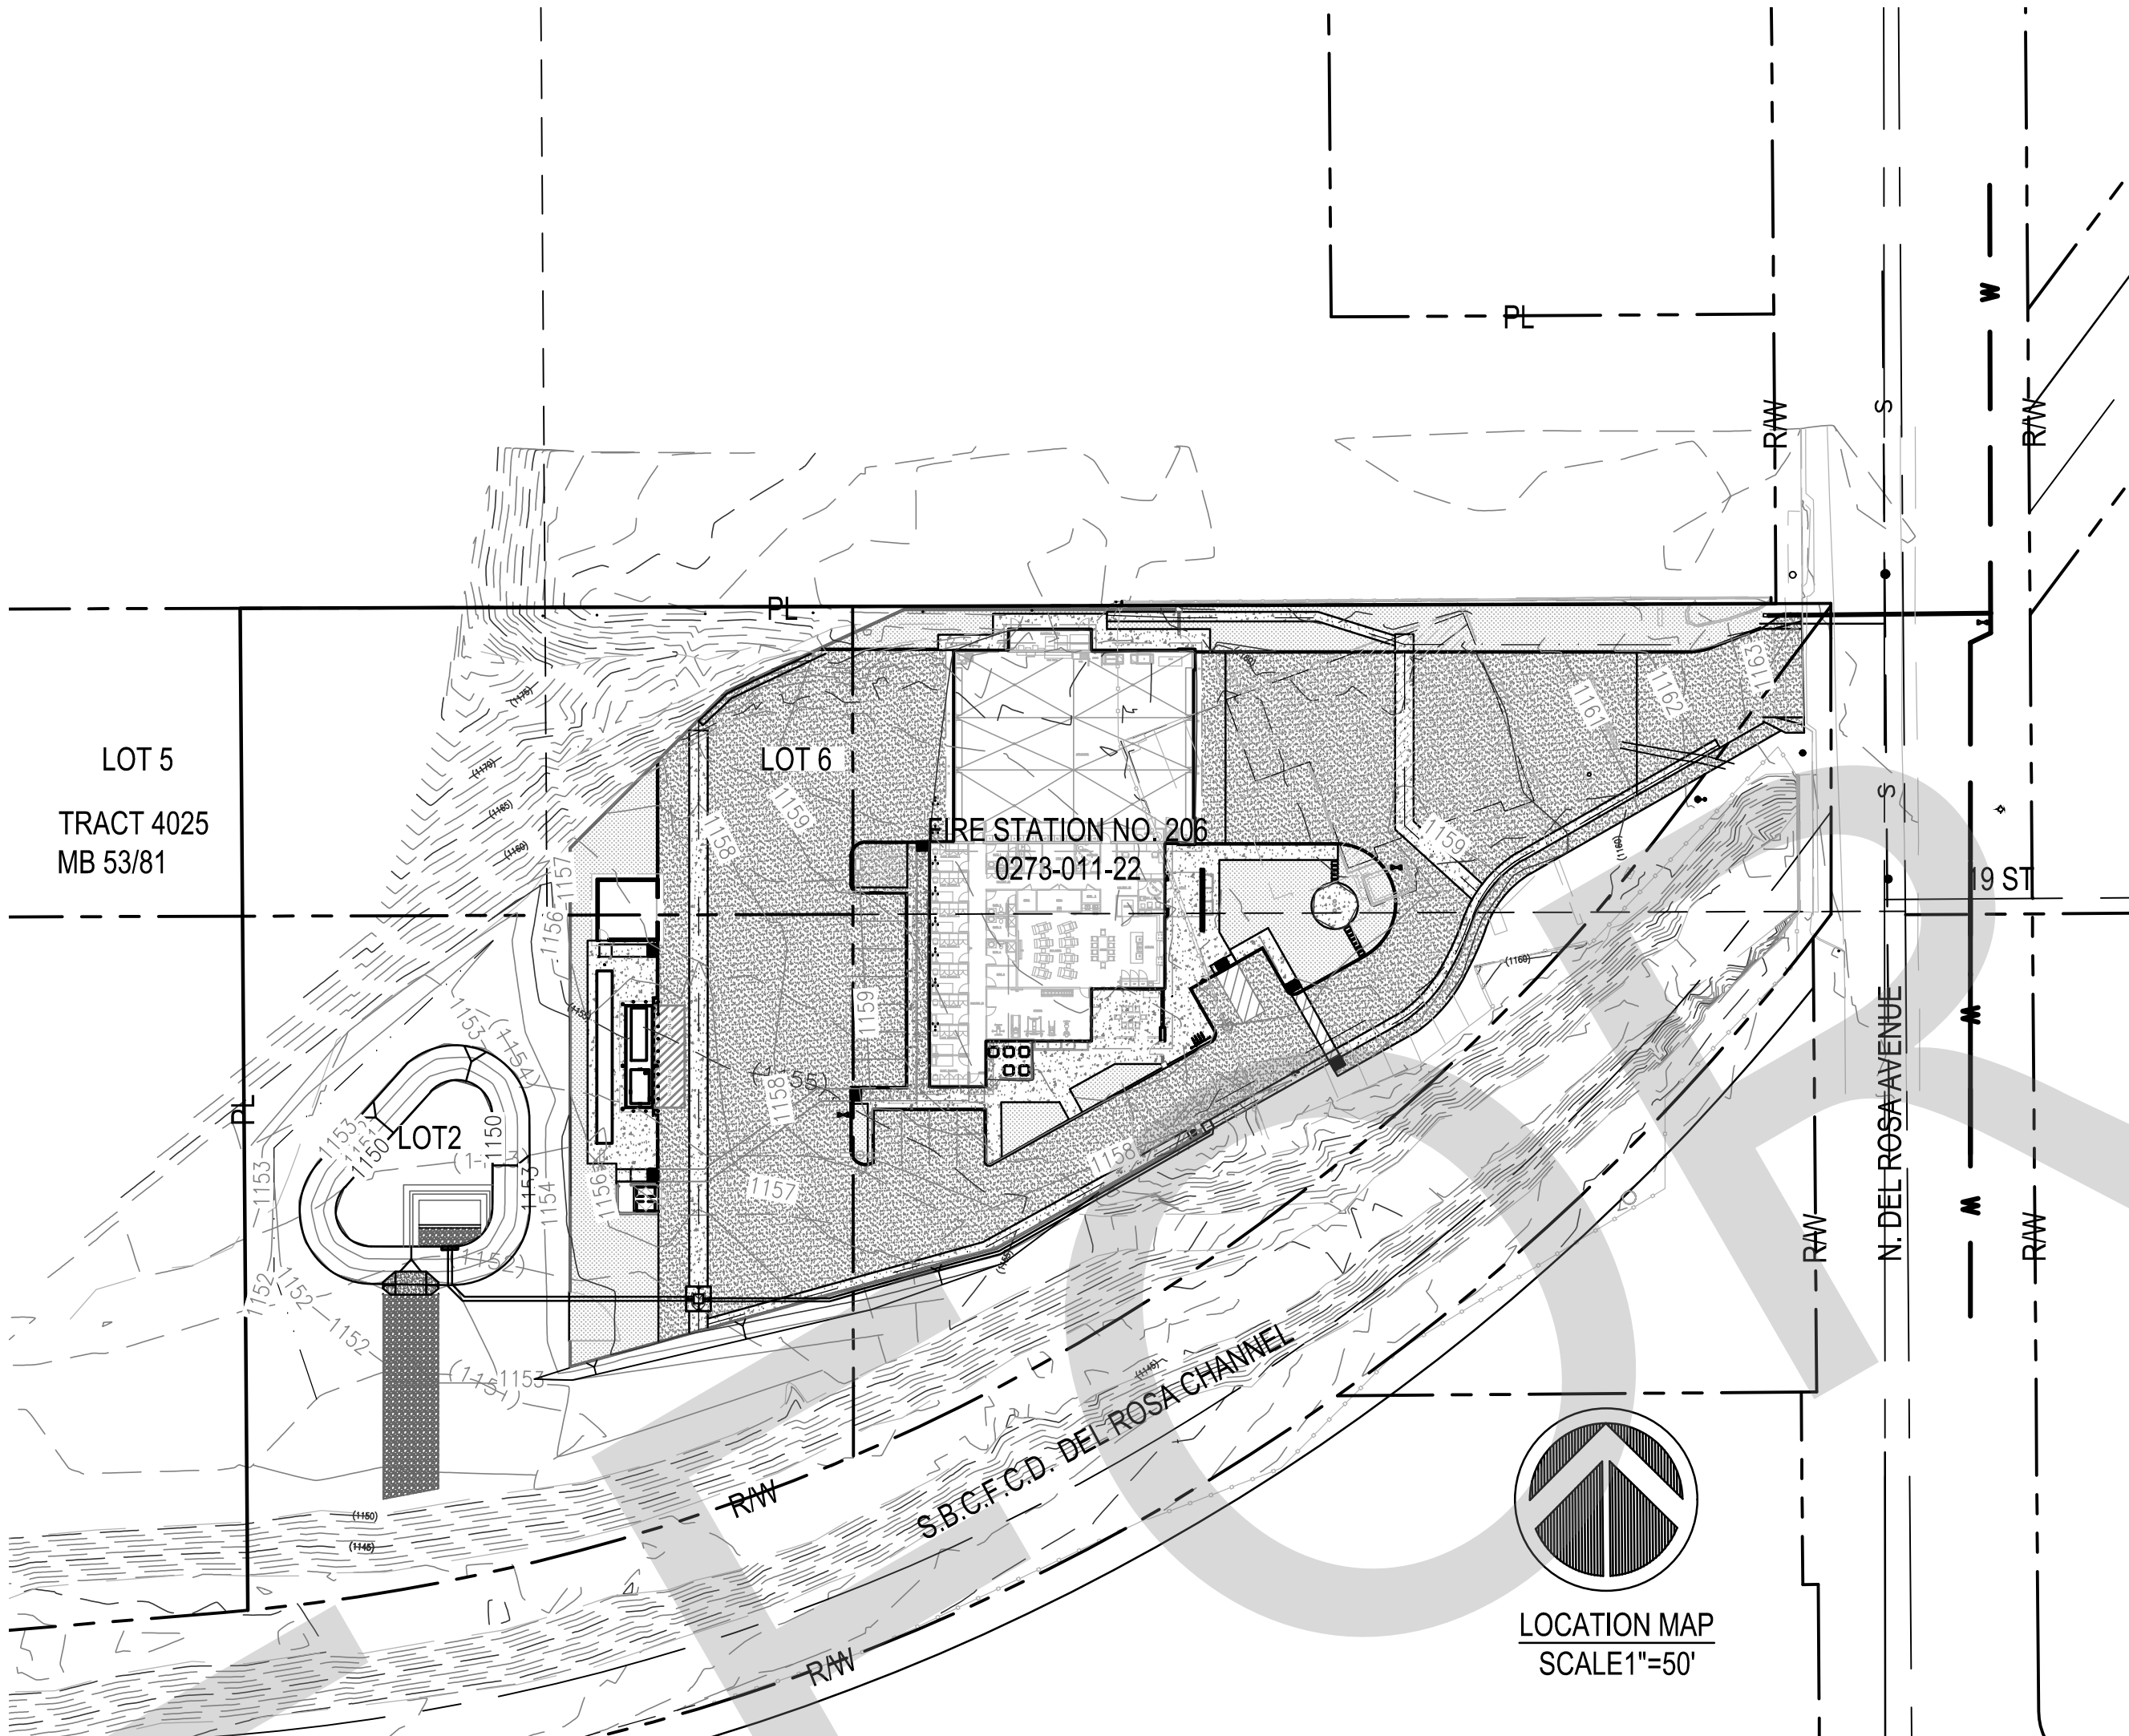

LEGEND:

PROPOSED RIGHT OF WAY	---	R/W
PROPOSED IMPROVEMENTS	---	
PROPOSED FLOW LINE	---	
EXISTING IMPROVEMENTS	---	
EXISTING OVERHEAD LINE	---	OHD
EXISTING GAS LINE	---	G
EXISTING SEWER LINE	---	S
EXISTING STORM DRAIN LINE	---	SD
EXISTING TELECOMM.	---	FO
EXISTING WATER LINE	---	W
℄/CENTER LINE	---	
CONSTRUCT RIP-RAP	---	
CONSTRUCT PCC IMPROVEMENTS	---	

POWER POLE	---
STREET LIGHT	---
FIRE HYDRANT	---
UTILITY VALVE	---
PALM TREE	---
TREE	---
EXISTING SIGN	---
UTILITY PULL BOX	---
STORM DRAIN MANHOLE	---
TELEPHONE MANHOLE	---
ELECTRICAL MANHOLE	---
SEWER MANHOLE	---
WATER MANHOLE	---
WATER METER	---
ELECTRICAL PULLBOX	---
BENCH MARK	---
SPOT ELEVATION	---
FENCE	---

EARTHWORK QUANTITIES

CUT = 887.0 C.Y.
FILL = 2,863.0 C.Y.
TOTAL IMPORT = 2,551 C.Y.

TOPOGRAPHY SOURCE

ERSC, INC.
1810 W. REDLANDS AVE., REDLANDS, CALIFORNIA 92373
(909) 890-1255

SITE ADDRESS

1920 N. DEL ROSA AVENUE, CITY OF SAN BERNARDINO, CALIFORNIA.

BENCH MARK

VERTICAL CONTROL FOR THIS SURVEY IS A NGS: BENCHMARK G-523 RESET


DESCRIPTION: "G-523 RESET" DESCRIBED BY SAN BERNARDINO COUNTY CALIFORNIA 1959 AT SAN BERNARDINO, 0.85 MILES SOUTH ALONG STERLING AVENUE FROM THE AQUINAS CATHOLIC SCHOOL FOR BOYS, AT THE INTERSECTION OF PACIFIC AVENUE, IN THE TOP OF THE NORTHWEST CORNER OF A CONCRETE CLEANOUT STRUCTURE AT THE SOUTHEAST CORNER OF THE INTERSECTION.

ELEVATION: 1138.4' (NAVD88)

TOTAL DISTURBED AREA
1.60 ACRES

ASSESSOR PARCEL NUMBER
0273-011-22

GEOTECHNICAL ENGINEER'S
INLAND FOUNDATION ENGINEERING, INC. 10391 1310 S. SANTA FE AVENUE, SAN JACINTO, CALIFORNIA 92581
(951) 654-1555

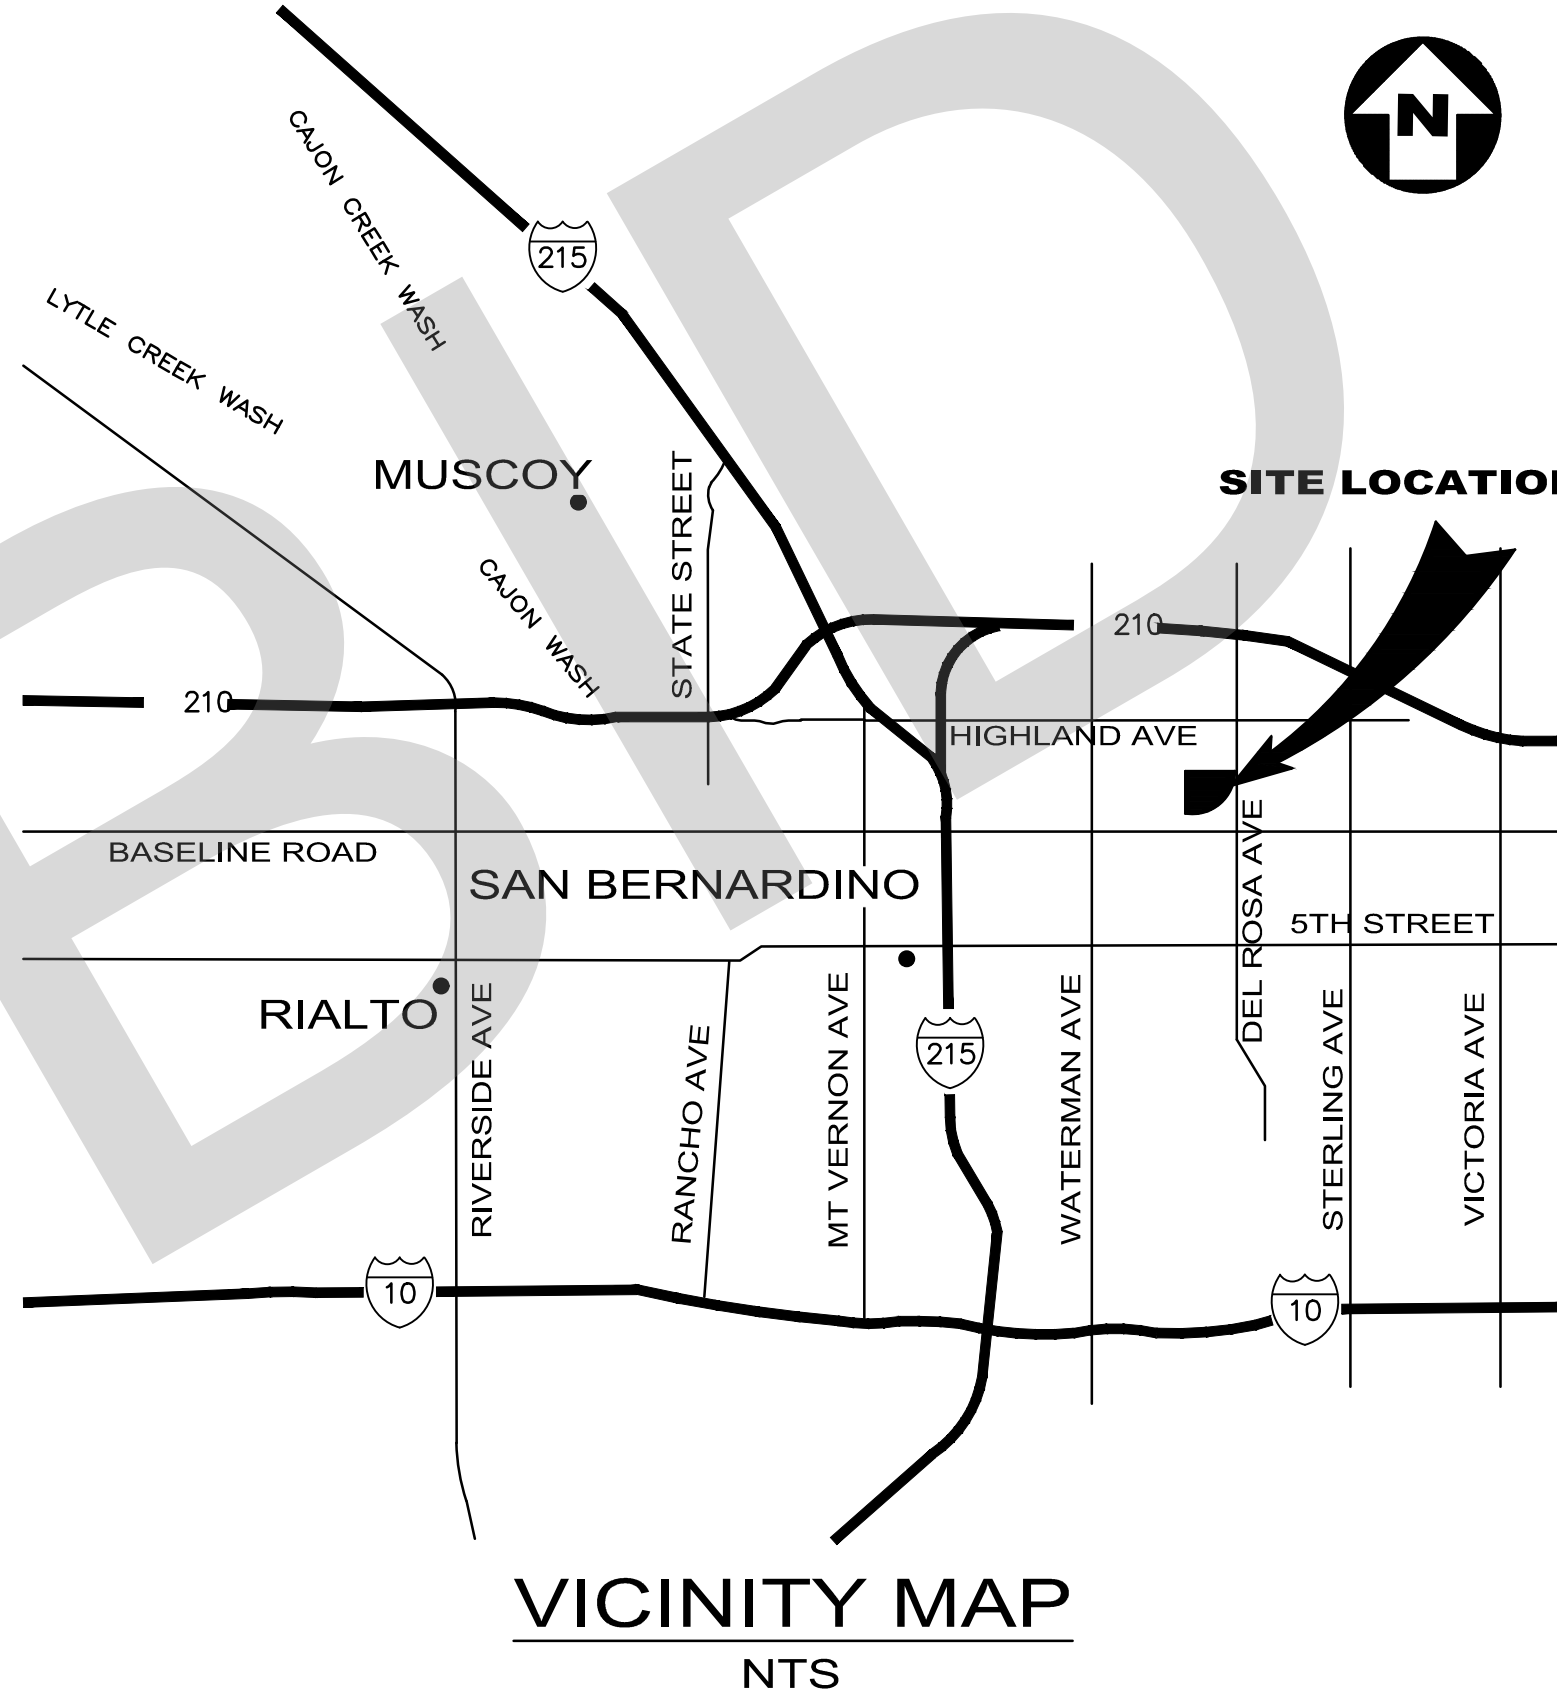

SHEET NO.

C1.1
C2.1
C3.1
C4.1

DESCRIPTION

TITLE SHEET
PRECISE GRADING PLAN
UTILITY PLAN
EROSION CONTROL PLAN


ISSUE INFORMATION:

DATE:	INFORMATION:
04-11-2022	20% CD SET
04-28-2022	50% CD SET
06-15-2022	95% CD SET
09-16-2022	95% CD- 3rd BAY
10-03-2022	PLAN CHECK

SHEET INFORMATION:

STK PROJECT NO.: 374-154-21
SCALE: AS NOTED
DATE: JANUARY 2021
PLOT DATE: -
DRAWING NAME:

SEAL:

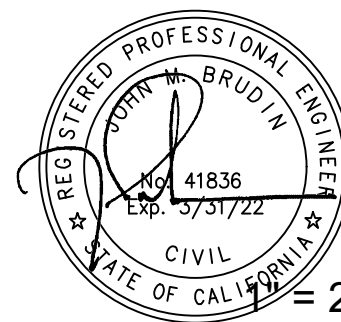

Issue Date

SHEET TITLE:

TITLE SHEET

SHEET NO.:

C1.1

GRADING CONSTRUCTION NOTES

1

CONSTRUCT 12-INCH PCC-4500 PSI PAVEMENT OVER 6-INCH OF CLASS 2 AGGREGATE BASE COMPACTED 95% RELATIVE COMPACTION.

2

CONSTRUCT 9-INCH PCC-4500 PSI PAVEMENT OVER 6-INCH OF CLASS 2 AGGREGATE BASE COMPACTED 95% RELATIVE COMPACTION.

3

CONSTRUCT COMMERCIAL DRIVEWAY APPROACH TYPE 1 PLAN PER CITY OF SAN BERNARDINO STD. 204.

4

CONSTRUCT 36-INCH CROSS GUTTER PER CITY OF SAN BERNARDINO STD. 201.

5

CONSTRUCT 72-INCH CROSS GUTTER PER CITY OF SAN BERNARDINO STD. 201.

6

CONSTRUCT 6-INCH TYPE "A" PCC CURB PER CITY OF SAN BERNARDINO STD. 200.

7

CONSTRUCT 4-INCH ROLLED CURB PER CITY OF SAN BERNARDINO STD. 200.

8

CONSTRUCT "D" CURB FACE.

9

CONSTRUCT 5-INCH CONCRETE WHEEL STOP PER DETAIL.

10

CONSTRUCT CMU PERIMETER WALL. SEE ARCHITECTURE PLAN A2.0

11

CONSTRUCT RETAINING WALL PER SEPARATE PERMIT.

12

CONSTRUCT 4-INCH THICK CONCRETE SLAB ON-GRADE W/ #4 BARS @ 18" O.C. OVER BOTH WAYS OVER 12" COMPACTED SUBGRADE.

QUANTITIES

1,000

SQ. FT.

33,210

SQ. FT.

1

EA.

95

LF.

190

LF.

550

LF.

350

LF.

380

LF.

1

EA.

1


SL.

1

SL.

6330

SQ. FT.

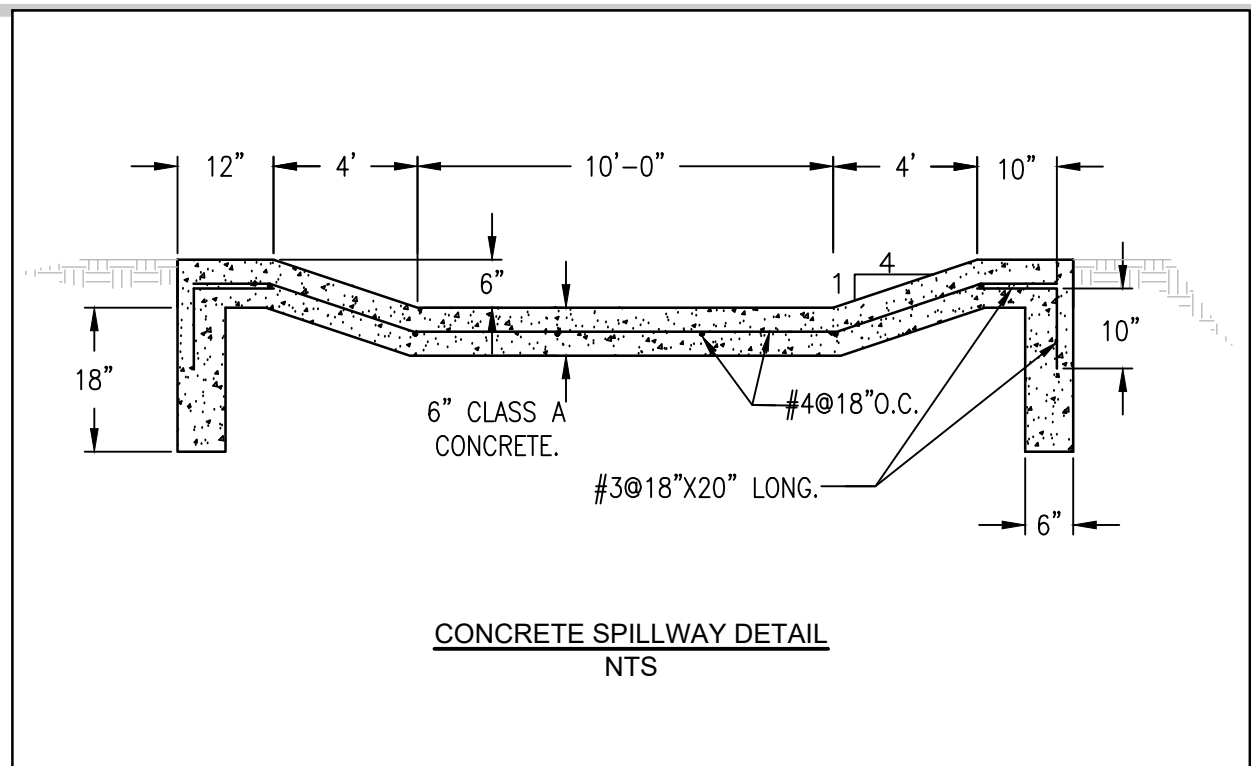

DRAINAGE CONSTRUCTION NOTES

1

CONSTRUCT 36"x36" JENSEN CATCH BASIN MODEL 3636 CB.

2

CONSTRUCT HEADWALL SINGLE PIPE PER JENSEN STD. 601-4.

3

CONSTRUCT 10" SCH. 40 PVC PIPE.

4

CONSTRUCT 16" SCH. 40 PVC PIPE.

5

CONSTRUCT BACKING#2 PER DETAIL.

6

CONSTRUCT 6" THICK CONCRETE SPILLWAY PER DETAIL.

2

EA.

1

EA.

181

LF.

109

LF.

11

CY.

1

EA.

STRIPPING CONSTRUCTION NOTES

1

CONSTRUCT 4-INCH WHITE THERMOPLASTIC PARKING STRIPE.

2

ADA STRIPPING SYMBOLS AND SIGN PER ARCHITECTURE PLAN, SEE SHEET A1.3.

3

ACCESSIBLE ROUTE HATCHED LINES PAINTED BLUE PER CBC SECTION 11B-501.

270


LF.

1





SL.

1

SL.

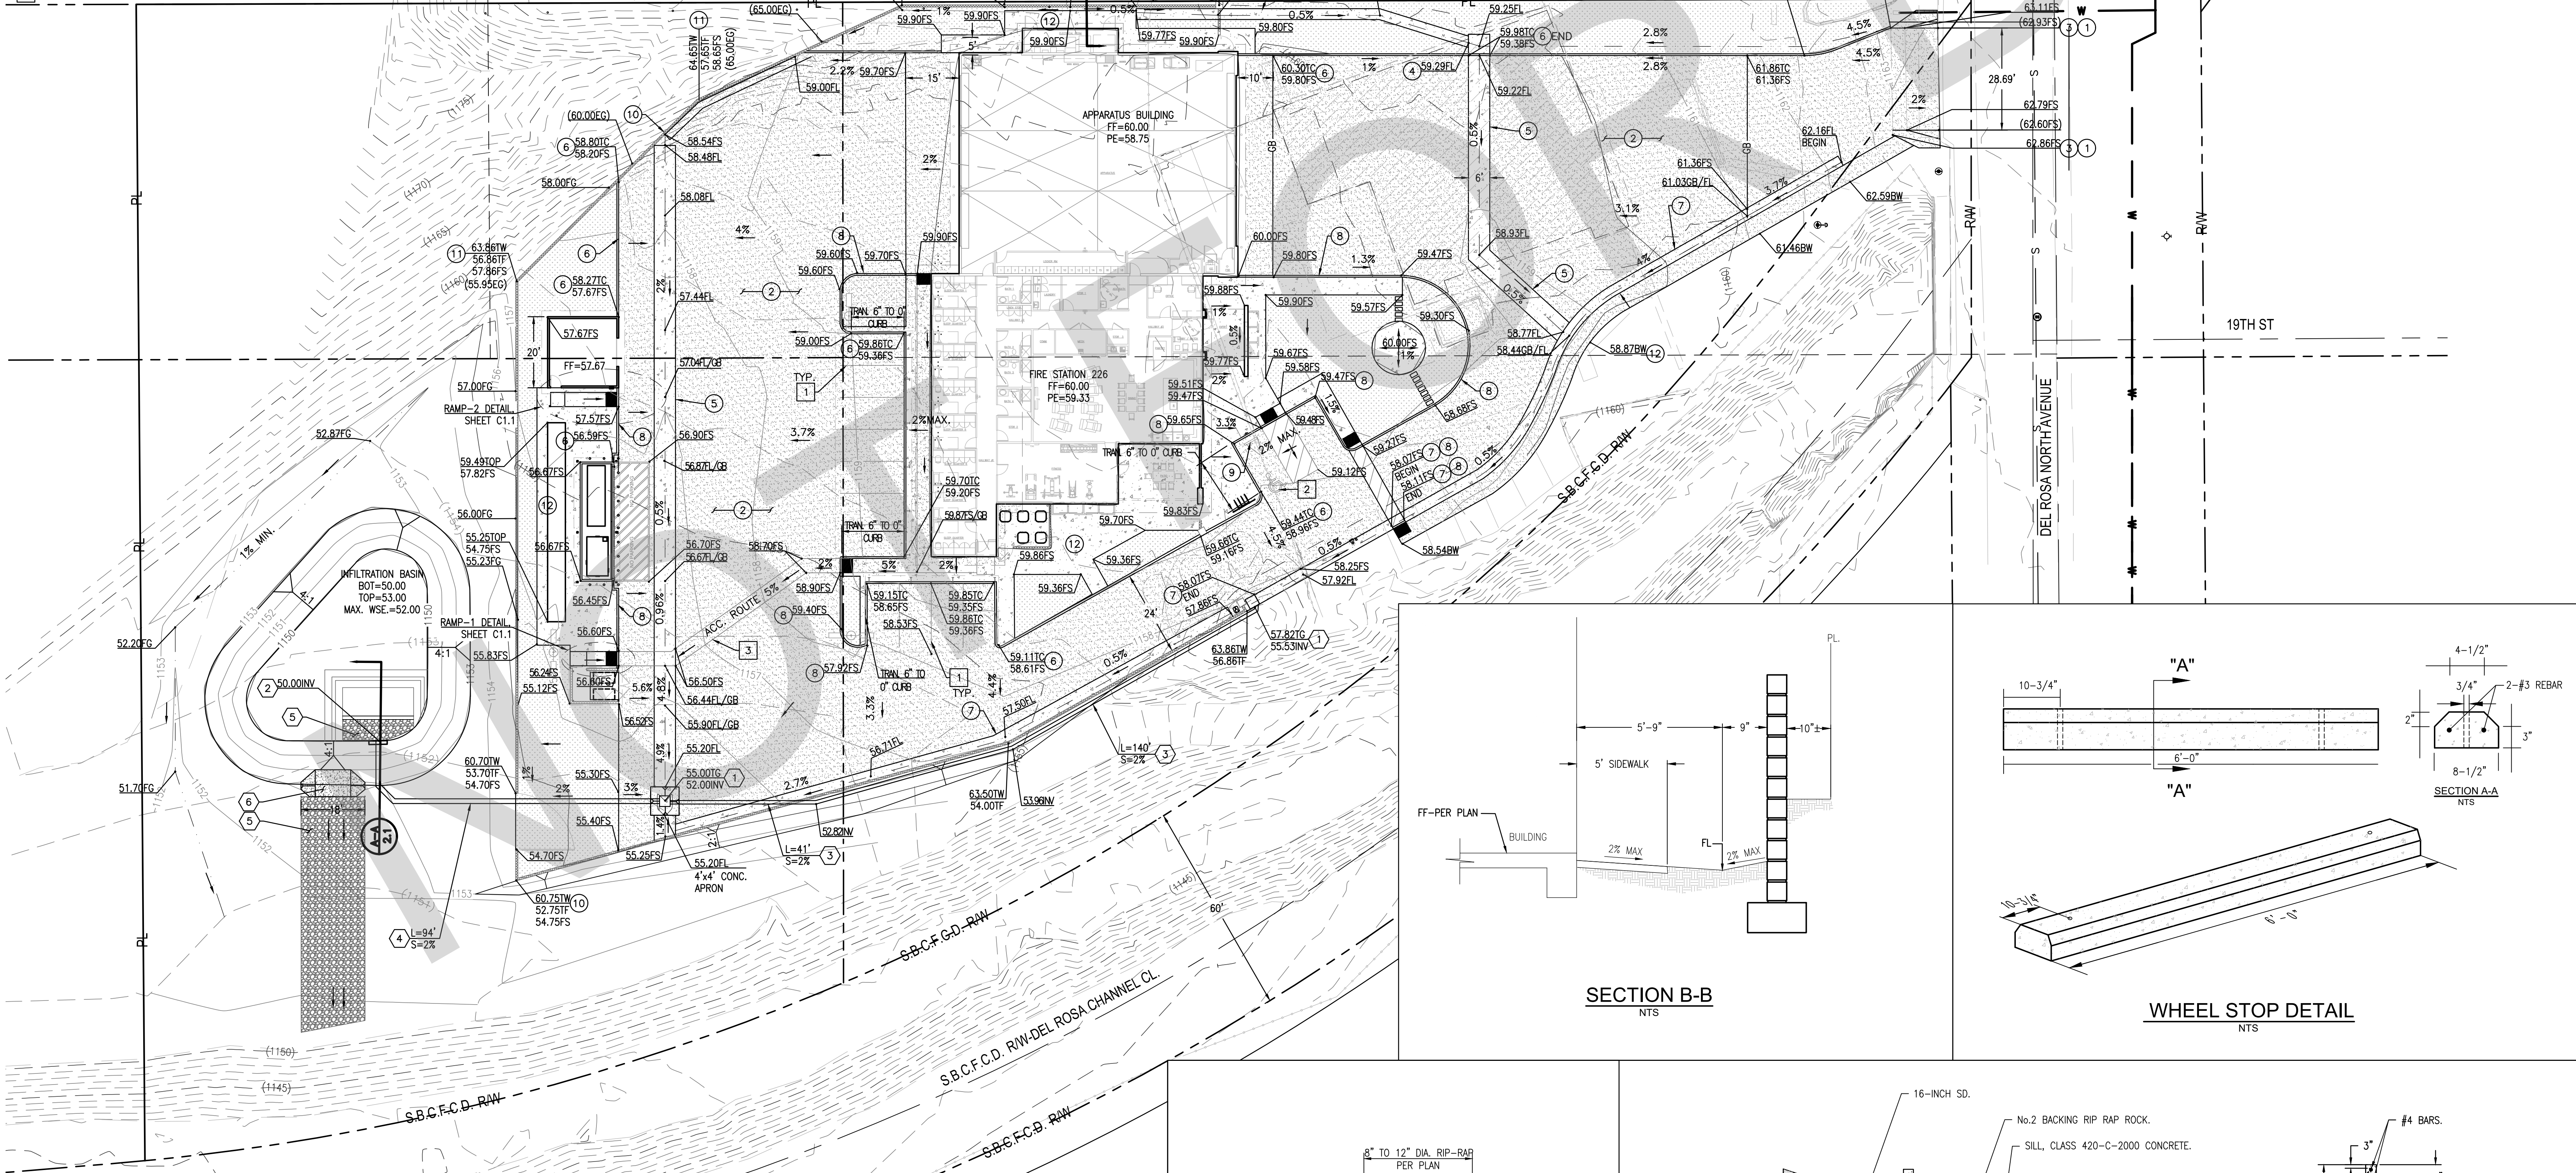

BENCHMARK:
VERTICAL CONTROL FOR THIS SURVEY IS A NGS: BENCHMARK 6-523 RESET
DESCRIPTION: "6-523 RESET" DESCRIBED BY SAN BERNARDINO COUNTY CALIFORNIA 1959 AT SAN BERNARDINO, 0.25 MILES SOUTH ALONG STERLING AVENUE FROM THE AQUINAS CATHOLIC SCHOOL FOR BOYS, AT THE INTERSECTION OF PACIFIC AVENUE, IN THE TOP OF THE NORTHWEST CORNER OF A CONCRETE CLEANOUT STRUCTURE AT THE SOUTHEAST CORNER OF THE INTERSECTION.
ELEVATION: 1138.4' (NAVD88)

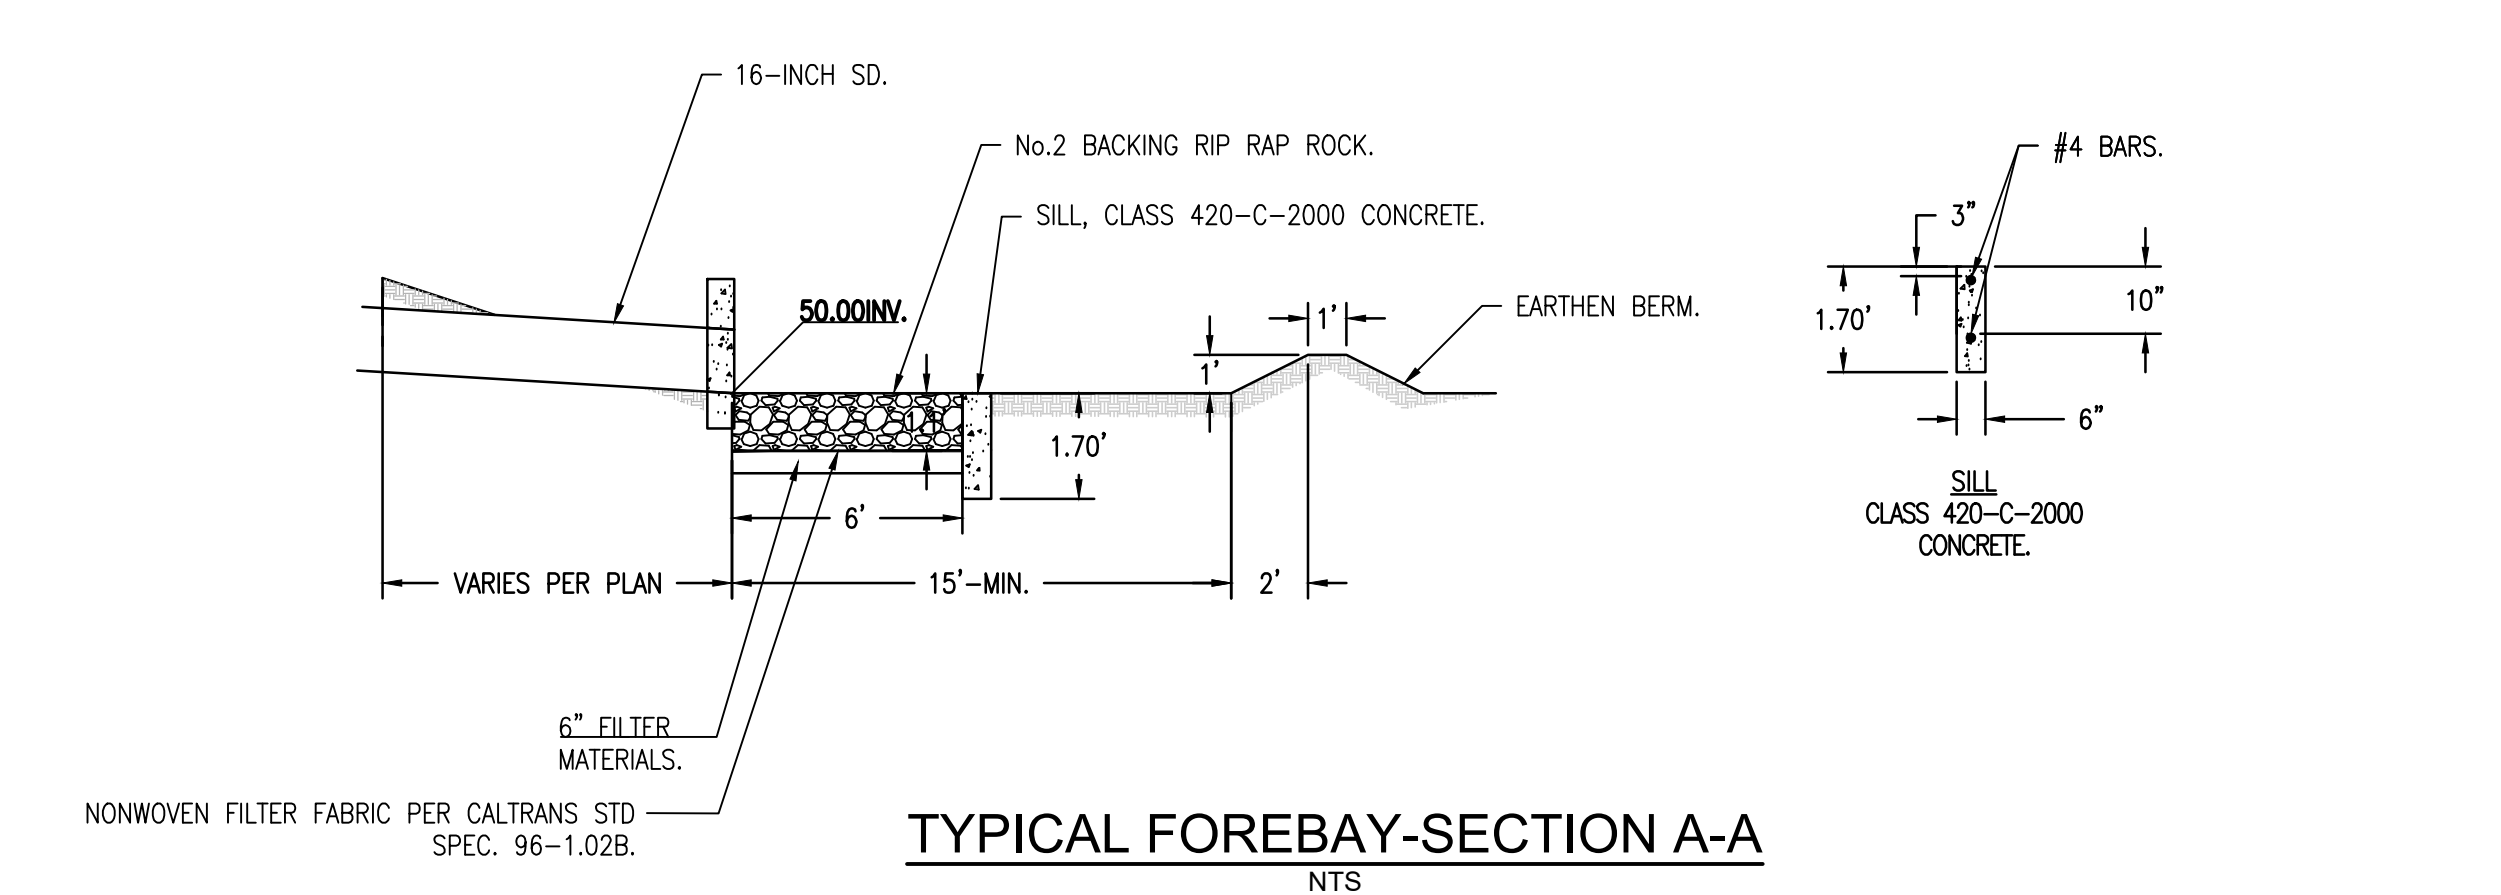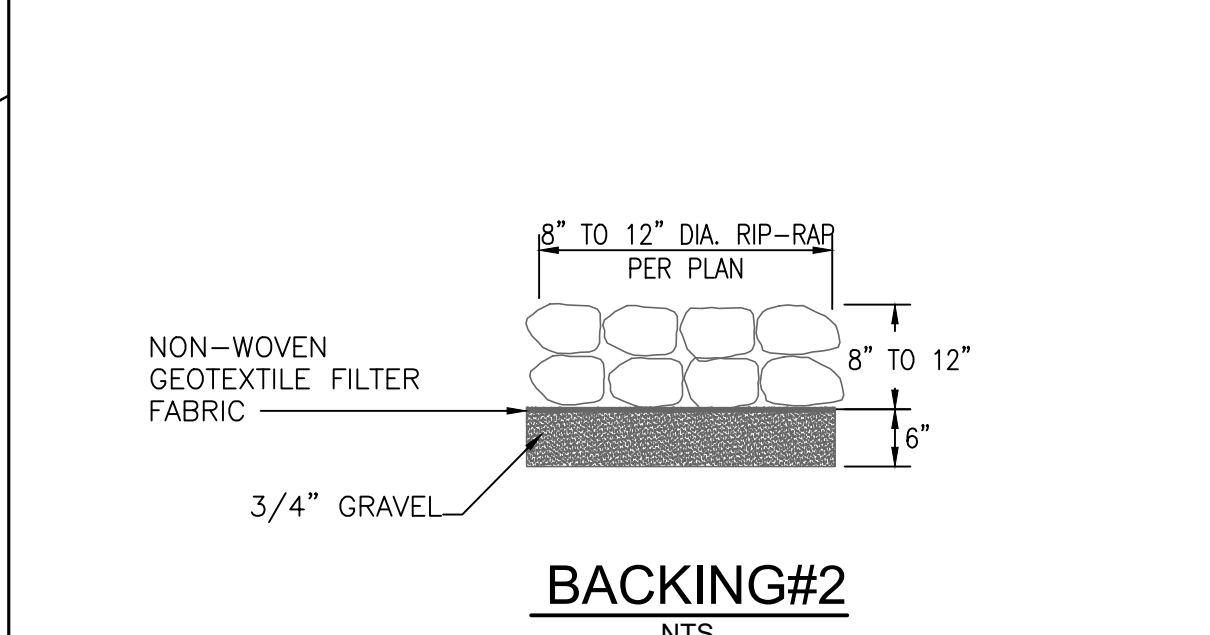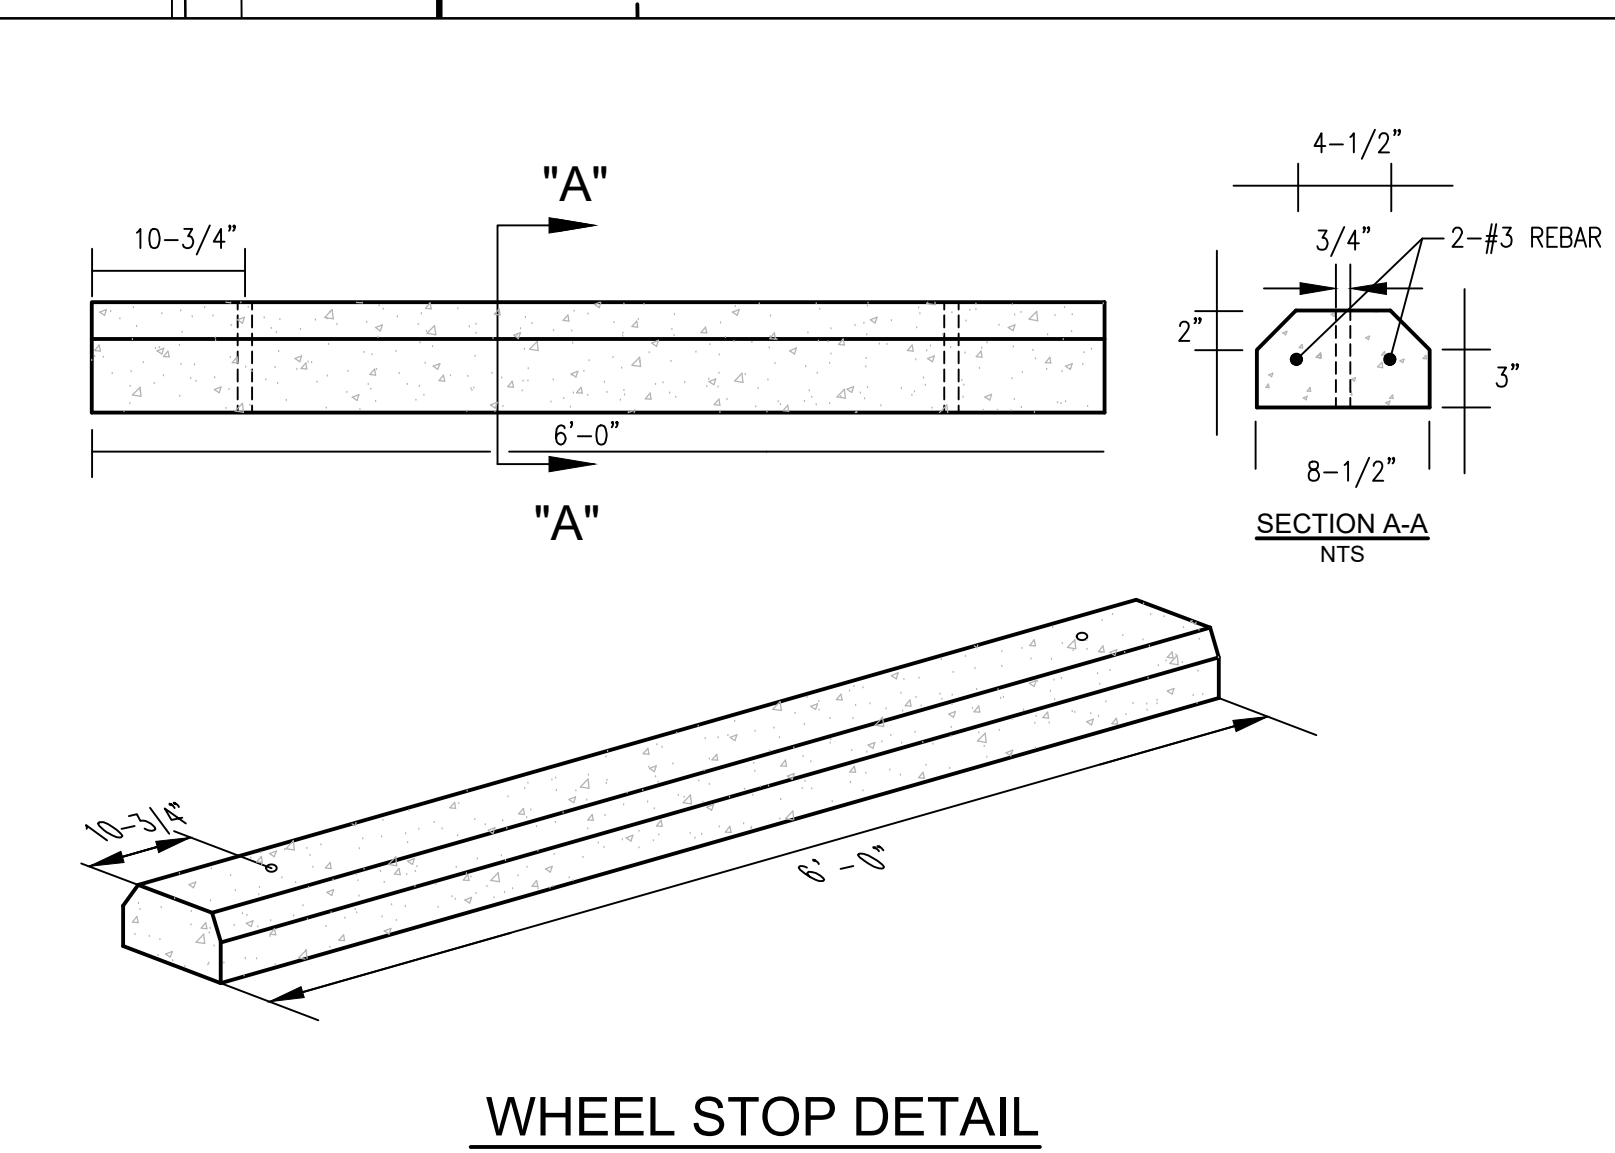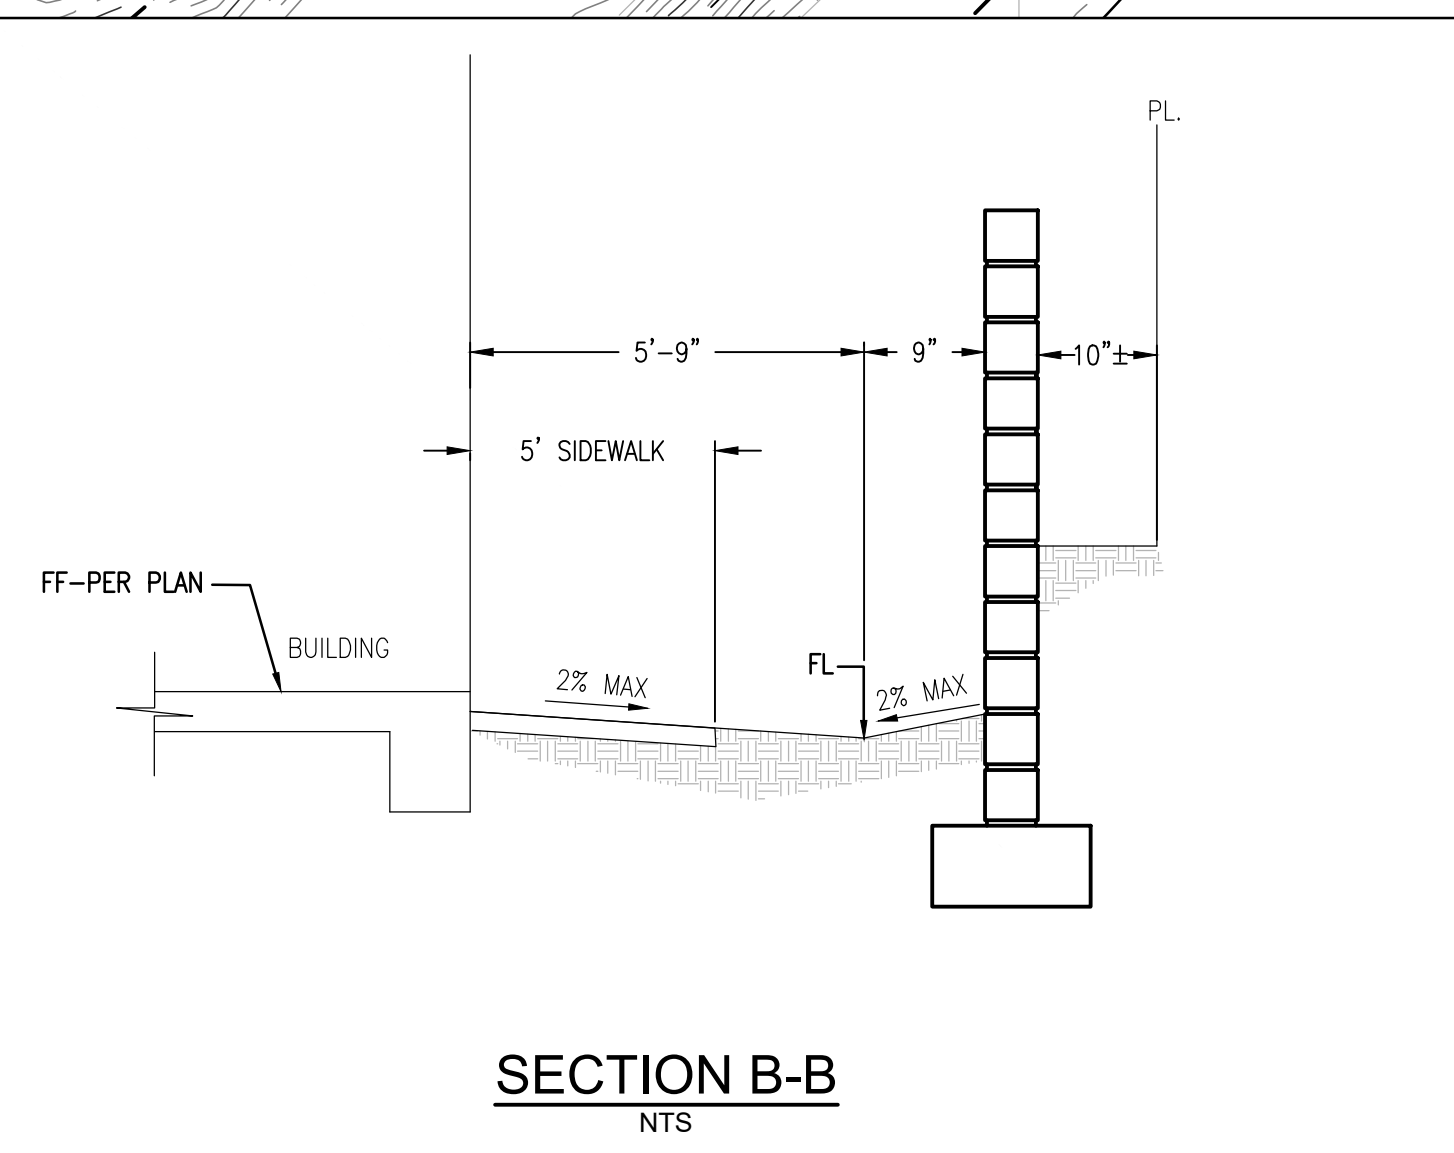

PROJECT ADMINISTERED BY:
SAN BERNARDINO COUNTY
PROJECT & FACILITIES
MANAGEMENT DEPARTMENT

385 N. ARROWHEAD AVE.
SAN BERNARDINO, CA 92415

PROJECT NAME:
SAN BERNARDINO
COUNTY FIRE
DEPARTMENT:
FIRE STATION 226

PROJECT # 10.10.1032
CIP #21-037
CAFM # SAB198
APN # 0273-011-22

1920 DEL ROSA AVE N.
SAN BERNARDINO,
CA 92404

ISSUE INFORMATION:	
DATE:	INFORMATION:
04-11-2022	20% CD SET
04-28-2022	50% CD SET
06-15-2022	95% CD SET
09-16-2022	95% CD- 3rd BAY
10-03-2022	PLAN CHECK

SHEET INFORMATION:
STK PROJECT NO.: 374-154-21
SCALE: AS NOTED
DATE: JANUARY 2021
PLOT DATE:
DRAWING NAME:

SEAL:

20'-0" Issue Date
SHEET TITLE:

PRECISE
GRADING
SHEET NO.:
C2.1

DOMESTIC WATER

- 3-INCH SCH. 40 STEEL PIPE.
- 3-INCH DUCTILE IRON PIPE (D.I.P.), P.E. x P.E.
- INSTALL 3-INCH SCH. 40, 90° ELBOW.
- INSTALL 3-INCH R.S.G.V.
- INSTALL STAINLESS STEEL TAPPING SLEEVE ON MAIN WATER PER EMD DWG. W-104.
- 3-INCH REDUCED PRESSURE PRINCIPAL BACKFLOW PREVENTION ASSEMBLY (RPP) PER EMD STD. DWG. W-114.
- INSTALL 3-INCH WATER METER PER EMD STD. DWG. W-102.
- INSTALL 3/4" PRE-FABRIC VAULT AND LID.
- 2-INCH SCH. 40 STEEL PIPE.
- INSTALL 2-INCH SCH. 40, 90° ELBOW.
- INSTALL STAINLESS VALVE BOX PER EMD DWG. W-119.
- INSTALL 3-INCH SCH. 40, 45° ELBOW.
- INSTALL 3-INCH SCH. 40, 22.5° ELBOW.

FIRE PROTECTION

- INSTALL STAINLESS STEEL TAPPING SLEEVE ON MAIN WATER PER EMD DWG. W-104.
- INSTALL 8-INCH D.I.P. PIPE.
- INSTALL 8-INCH C900, PVC PIPE.
- INSTALL 8-INCH GATE VALVE FLG.M.J.
- INSTALL MEGALUG RESTRAIN
- INSTALL LOW PROFILE DOUBLE DETECTOR CHECK ASSEMBLY (N-SHAPE) PER EMD STD. DWG. W-110.
- INSTALL 8x8/8-INCH TEE.
- INSTALL 6-INCH, WET BARREL FIRE HYDRANT PER CITY OF SAN BERNARDINO STD. DWG. W-103B.
- INSTALL 8-INCH 90° ELBOW
- INSTALL RESTRAIN JOINTS PER EMD SPECIFICATIONS.
- INSTALL 8-INCH 22.5° FITTING.
- INSTALL 8-INCH 45° ELBOW.
- INSTALL 8-INCH X 6-INCH REDUCTION
- INSTALL 6-INCH C900, PVC PIPE.
- CONNECT FIRE LINE PER IN-BUILDING RISER DETAIL
- INSTALL BOLLARDS PER EMD STD. DWG. W-111.
- INSTALL 6-INCH 90° ELBOW

DOMESTIC SEWER

- INSTALL 6-INCH PVC PIPE, SDR35.
- INSTALL PIPE CLEANOUT PER EMD STD. DWG. S-107.
- INSTALL 750 GALLON OIL INTERCEPTOR PER PLUMBING PLAN, SEE SHEET P5.1.
- INSTALL SEWER LATERAL TYPICAL HOUSE CONNECTION PER EMD STD. DWG. S-101.

QUANTITIES

- | |
|---------|
| 399 LF. |
| 100 LF. |
| 2 EA. |
| 1 EA. |
| 1 EA. |
| 1 EA. |
| 1 EA. |
| 1 EA. |
| 176 LF. |
| 2 EA. |
| 2 EA. |
| 3 EA. |
| 2 EA. |

LEGEND

- | | |
|----------------------------------|---------------------|
| TAPPING SADDLE | POINT OF CONNECTION |
| DETECTOR DETECTOR CHECK ASSEMBLY | CLEAN OUT |
| POST INDICATOR VALVE | F.D.C. |
| GATE VALVE | WATER METER |
| FIRE HYDRANT | |
| REDUCED PRESSURE PRINCIPAL | |

DOMESTIC WATER


Line #	Length	Direction
D1	32.83	N90° 00' 00.00"W
D2	69.19	S0° 00' 00.00"E
D3	69.99	S45° 00' 00.00"W
D4	34.85	S67° 30' 00.00"W
D5	20.55	N90° 00' 00.00"W
D6	37.24	S45° 00' 00.00"E
D7	46.70	N0° 00' 00.00"W
D8	14.22	N90° 00' 00.00"W
D9	74.43	N90° 00' 00.00"E
D10	51.55	N90° 00' 00.00"E
D11	51.44	N90° 00' 00.00"E

FIRE PROTECTION

Line #	Length	Direction
F1	122.55	N90° 00' 00.00"W
F2	83.40	S0° 00' 00.00"E
F3	50.00	S45° 00' 00.00"W
F4	36.52	S67° 30' 00.00"W
F5	22.39	N90° 00' 00.00"W
F5A	08.30	S45° 00' 00.00"E
F6	31.44	S45° 00' 00.00"E
F7	34.50	N0° 00' 00.00"E
F8	9.22	N90° 00' 00.00"E
F9	16.44	S45° 00' 00.00"W
F10	71.64	S67° 30' 00.00"W
F11	79.18	S89° 59' 13.33"W
F12	6.00	N0° 07' 43.89"W
F13	8.99	N90° 00' 00.00"E
F14	54.33	N90° 00' 00.00"E
F15	45.63	S45° 00' 00.00"E
F16	18.51	N89° 59' 53.30"E

DOMESTIC SEWER

Line #	Length	Direction
S1	98.36	N90° 00' 00"W
S2	67.78	S00° 00' 00"E
S3	34.33	S45° 00' 00.00"W
S4	53.29	S67° 30' 00.00"W
S5	36.87	N45° 00' 00.00"W
S6	53.41	N0° 00' 00.00"E

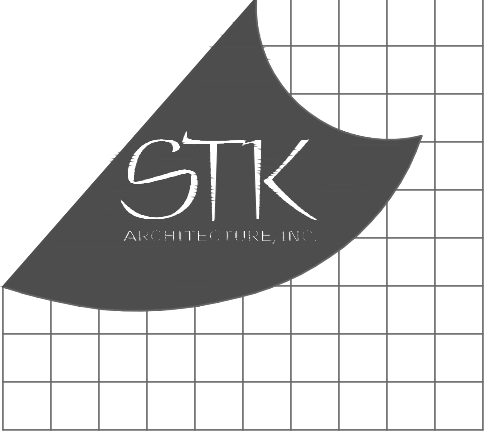

42095 ZEVO DR. TEMECULA, CALIFORNIA 92590-3780
Phone: 951.298.9110 Fax: 951.298.9079 Email: stk@stk.com

CONSULTANT:



1861 W. Redlands Blvd, Bldg 7B
Redlands, Ca. 92373
P: (909) 890-1255
F: (909) 890-0995

PROJECT ADMINISTERED BY:
SAN BERNARDINO COUNTY
PROJECT & FACILITIES
MANAGEMENT DEPARTMENT

385 N. ARROWHEAD AVE.
SAN BERNARDINO, CA 92415

PROJECT NAME:
SAN BERNARDINO
COUNTY FIRE
DEPARTMENT:
FIRE STATION 226

PROJECT # 10.10.1032

CIP #21-037

CAFM # SAB198

APN # 0273-011-22


1920 DEL ROSA AVE N.
SAN BERNARDINO,
CA 92404

ISSUE INFORMATION:

DATE:	INFORMATION:
04-11-2022	20% CD SET
04-28-2022	50% CD SET
06-15-2022	95% CD SET
09-16-2022	95% CD- 3rd BAY
10-03-2022	PLAN CHECK

SHEET INFORMATION:

STK PROJECT NO.: 374-154-21
SCALE: AS NOTED
DATE: JANUARY 2021
PLOT DATE:
DRAWING NAME:
SEAL:

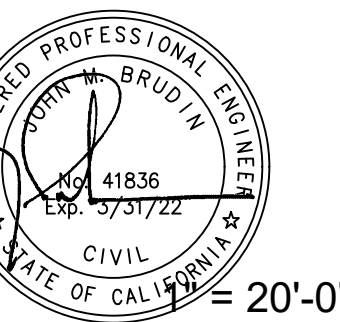


SHEET TITLE:

UTILITY PLAN

SHEET NO.:

C3.1

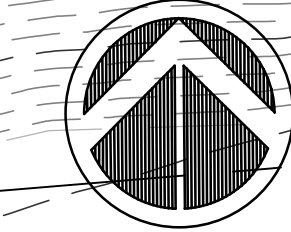

0 10 20 Feet

EROSION CONTROL CONSTRUCTION NOTES

1

SILT FENCE (SC-1).

2

STABILIZED CONSTRUCTION ENTRANCE/EXIT (TC-1) WITH RUMBLE RACKS (10'x24" MIN.).

3

GRAVEL BAG BERM (SC-6).

4

MATERIAL DELIVERY AND STORAGE (WM-01).

5

VEHICLE STORAGE.

6

SOLID WASTE MANAGEMENT AREA (WM-05).

7

VEHICLE AND EQUIPMENT MAINTENANCE AREA (NS-10).

8

STORM DRAIN INLET PROTECTION TYPE 2. (SE-10).

LEGEND

GRAVEL BAGS

SILT FENCE

FLOW PATH

STABILIZED CONSTRUCTION ENTRANCE

MATERIAL DELIVERY/STORAGE AREA

VEHICLE STORAGE AND MAINTENANCE AREA

VEHICLE WASHING AREA

WASTE STORAGE AREA

MAXIMUM SLOPE LENGTH IS 200'.
SILT FENCE
TURN LAST 6' OF FENCE UP-SLOPE.
MAX WIDTH=500'.

MAXIMUM TRIANGULAR AREA 25 ACRES/100 FT OF FENCE.
SILT FENCE CONSTRUCTED ALONG LEVEL CONTOUR.
FILTER FABRIC.
POST@10' O.C.(MAX).
COMPACTED BACKFILL.
6" MIN.
12"
6" MIN.

1

SILT FENCE
N.T.S.

50' MIN.
12" MIN.

2

STABILIZED CONSTRUCTION ENTRANCE
N.T.S.

50' MIN.
12" MIN.
PUBLIC RIGHT OF WAY

PROVIDE APPROPRIATE TRANSITION BETWEEN STABILIZED CONSTRUCTION ENTRANCE AND PUBLIC RIGHT OF WAY.

3

SAND BAGS
N.T.S.

WIRE MESH (1/2" OPENINGS) WITH FILTER FABRIC ON TOP.
3/4"-3" GRAVEL (12" MIN DEPTH).
18" MIN.
18" MIN.
SAND BAG

STK

42095 ZEVIO DR. TEMECULA, CALIFORNIA 92590-3780
Phone: 951.296.9110 Fax: 951.296.8079 Email: stk@stkeinc.com

CONSULTANT:

ERSC

Engineering Resources of Southern California

1861 W. Redlands Blvd, Bldg 7B
Redlands, Ca. 92373
P: (909) 890-1255
F: (909) 890-0995

PROJECT ADMINISTERED BY:
SAN BERNARDINO COUNTY
PROJECT & FACILITIES
MANAGEMENT DEPARTMENT

385 N. ARROWHEAD AVE.
SAN BERNARDINO, CA 92415

PROJECT NAME:
SAN BERNARDINO
COUNTY FIRE
DEPARTMENT:
FIRE STATION 226

PROJECT # 10.10.1032
CIP #21-037
CAFM # SAB198
APN # 0273-011-22

1920 DEL ROSA AVE N.
SAN BERNARDINO,
CA 92404

ISSUE INFORMATION:	
DATE:	INFORMATION:
04-11-2022	20% CD SET
04-28-2022	50% CD SET
06-15-2022	95% CD SET
09-16-2022	95% CD- 3rd BAY
10-03-2022	PLAN CHECK

SHEET INFORMATION:
STK PROJECT NO.: 374-154-21
SCALE: AS NOTED
DATE: JANUARY 2021
PLOT DATE:
DRAWING NAME:
SEAL:

REGISTERED PROFESSIONAL ENGINEER
41836
CIVIL
STATE OF CALIFORNIA

20'-0"
Issue Date


SHEET TITLE:

EROSION
CONTROL


SHEET NO.:

C4.1

T:\Projects\1000000066 - Fire Station No. 226\ERSC\CD\F226-3rd Bay.dwg
09/20/2022 9:54AM

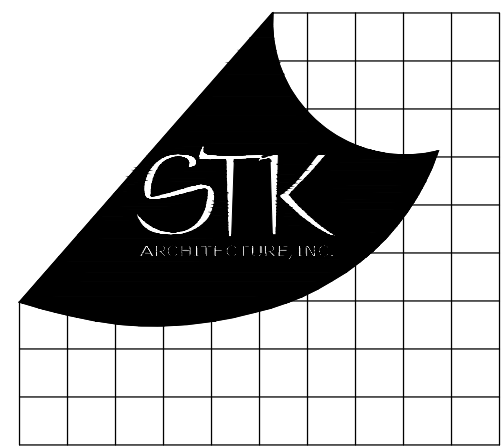

CONSULTANT:

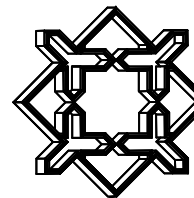

ALHAMBRA GROUP
LANDSCAPE ARCHITECTURE
CALIFORNIA LICENSE #2017
RECREATION FACILITIES PLANNING
41635 ENTERPRISE CIRCLE NORTH, SUITE C
TEMECULA, CA 92590 (951) 296-6802

PROJECT ADMINISTERED BY:
SAN BERNARDINO COUNTY
REAL ESTATE SERVICES
DEPARTMENT -
PROJECT MANAGEMENT
DIVISION

385 N. ARROWHEAD AVE.
SAN BERNARDINO, CA 92415

PROJECT NAME:
**SAN BERNARDINO
COUNTY FIRE
DEPARTMENT:
FIRE STATION 226**

PROJECT # 10.10.1032

CIP # _____

CAFM # _____

1920 DEL ROSA AVE N.
SAN BERNARDINO,
CA 92404


ISSUE INFORMATION:

DATE:	INFORMATION:
04-11-2022	20% CD SET
04-28-2022	50% CD SET
06-15-2022	95% CD SET
09-16-2022	95%CD SET-3rd Bay
10-03-2022	PLAN CHECK

SHEET INFORMATION:

STK PROJECT NO.: 374-154-21
SCALE: AS NOTED
DATE: SEPTEMBER 2022
PLOT DATE: _____
DRAWING NAME: _____

SEAL:

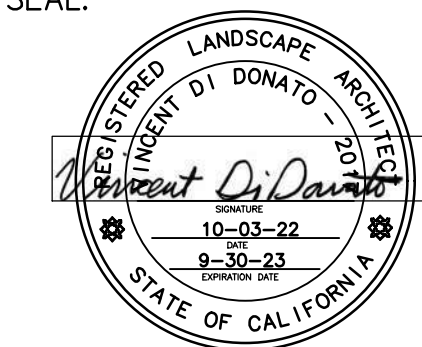


SHEET TITLE:

**PLANTING
PLAN**

SHEET NO.:

**L-1
OF 3**

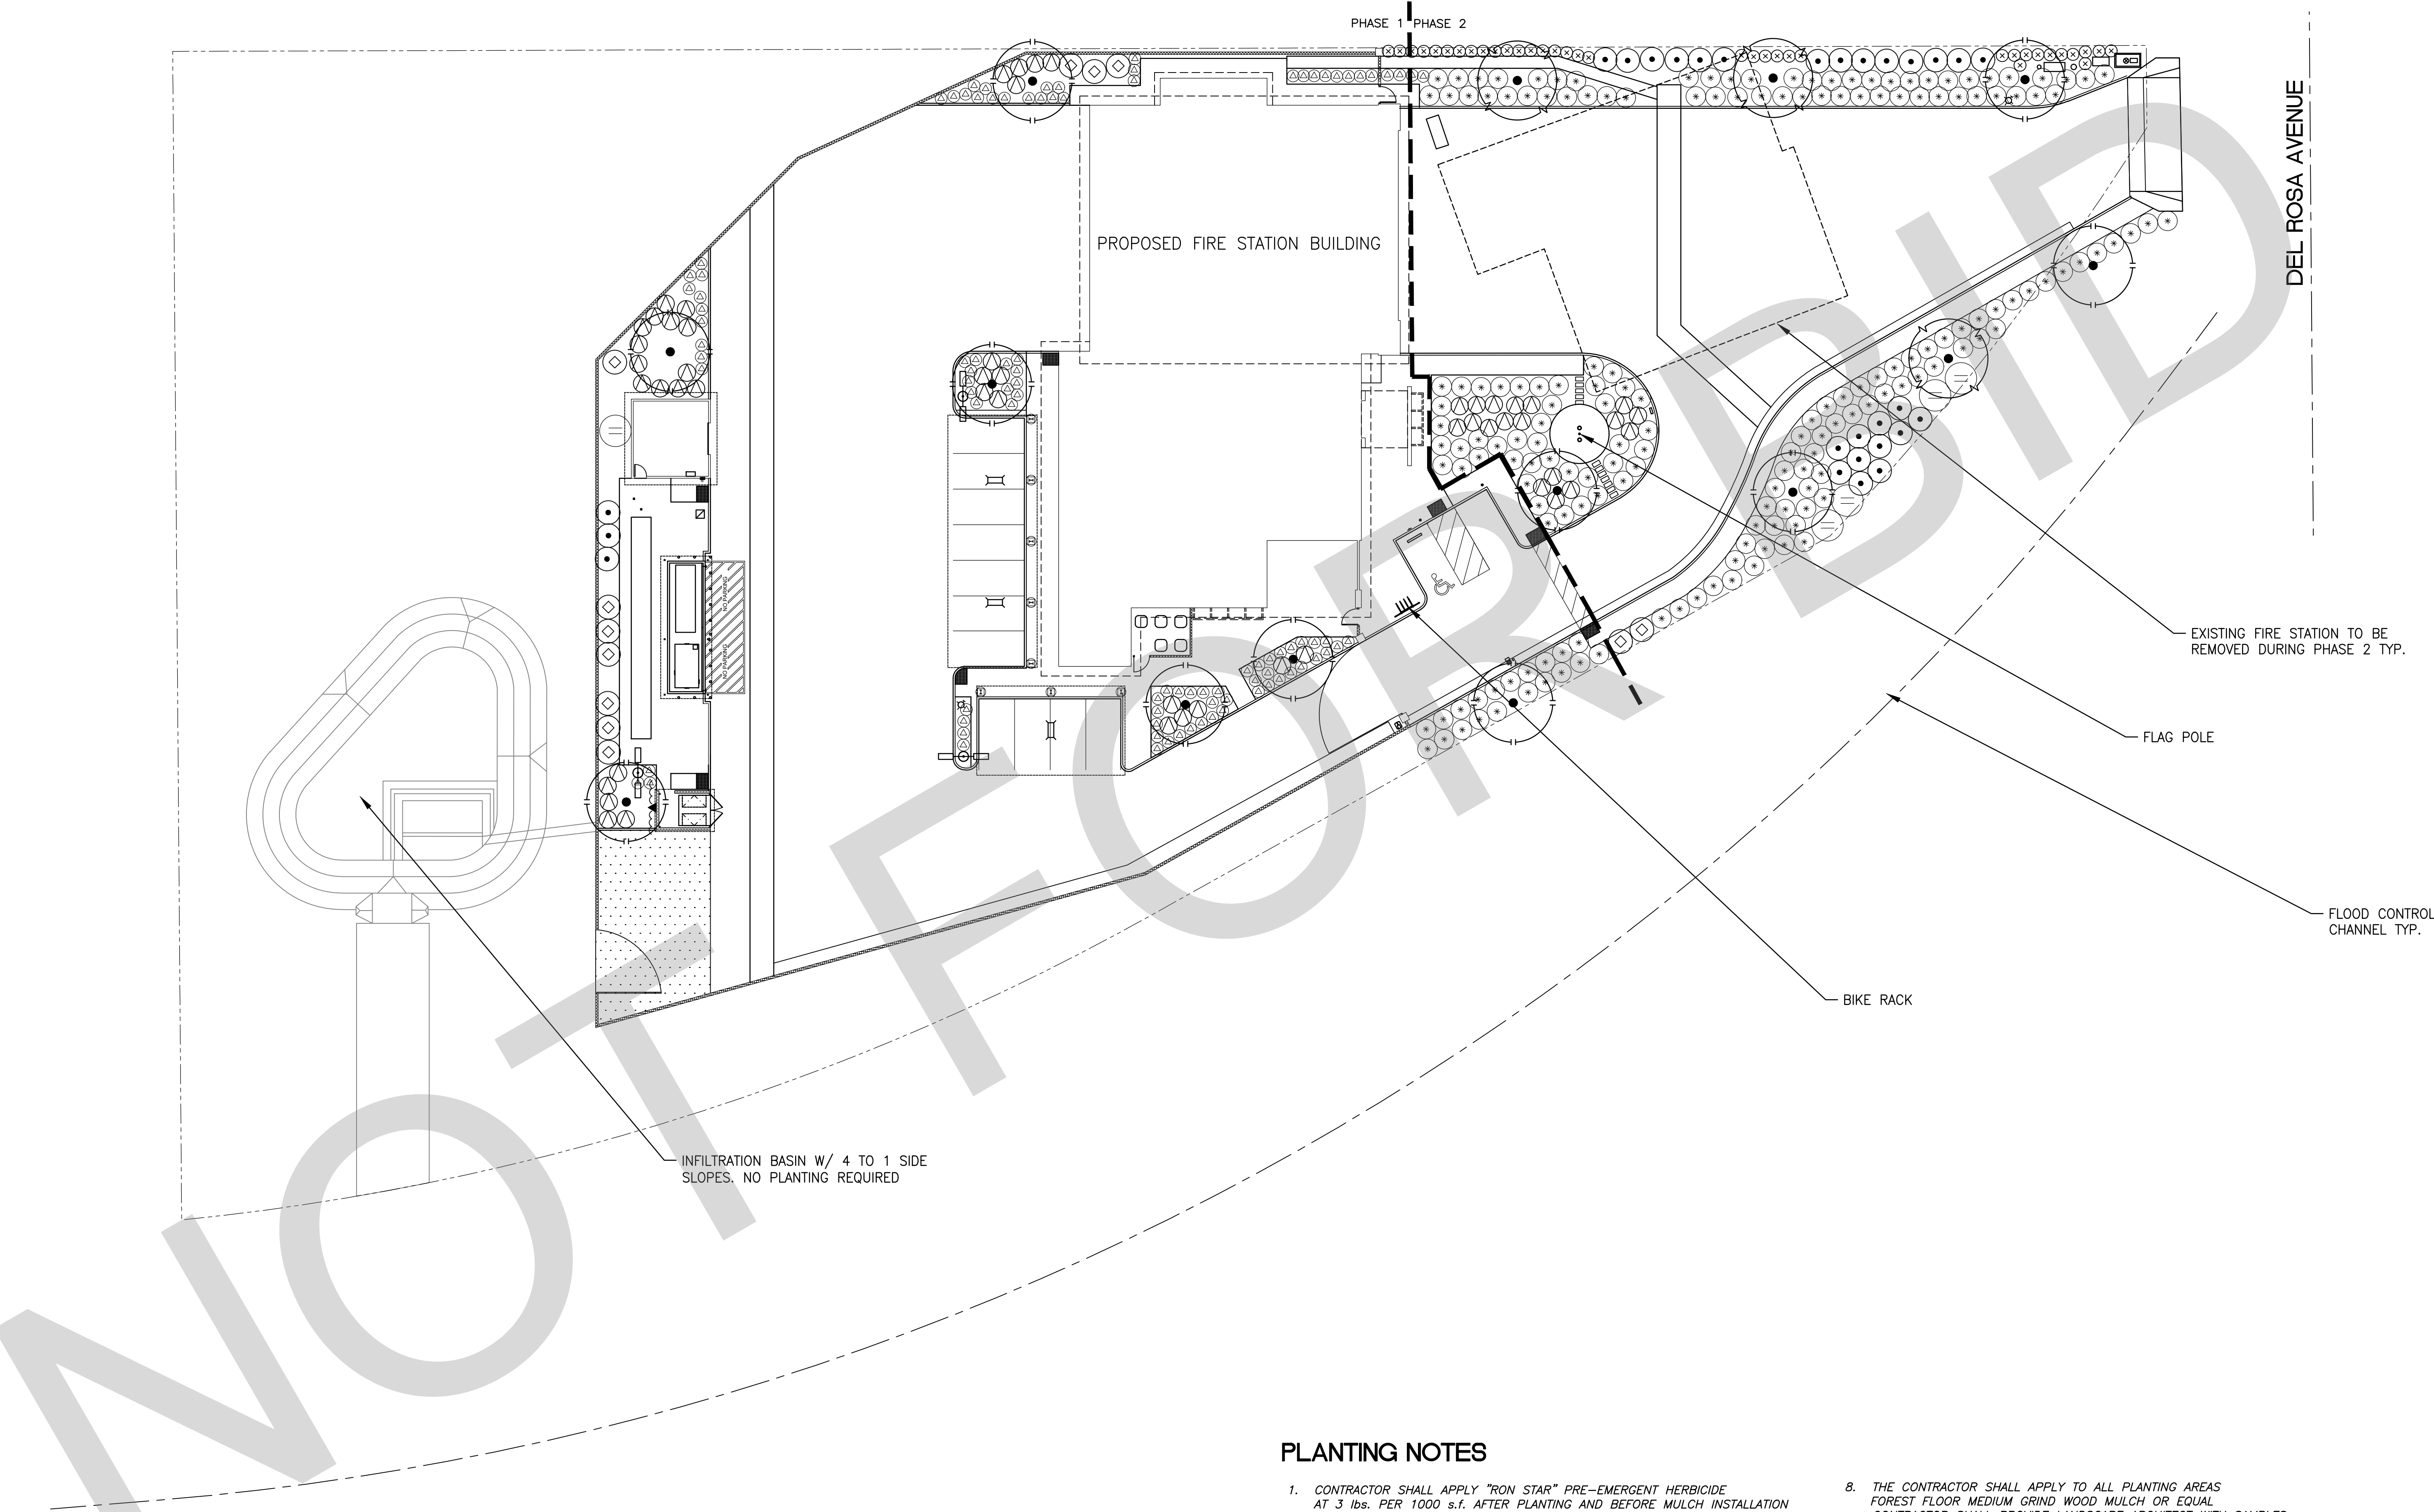


PLANTING NOTES


- CONTRACTOR SHALL APPLY "RON STAR" PRE-EMERGENT HERBICIDE AT 3 lbs. PER 1000 s.f. AFTER PLANTING AND BEFORE MULCH INSTALLATION PER MANUFACTURER'S RECOMMENDATIONS.(ONLY ON NON-SEEDED AREAS)
- ALL PLANTING SHALL CONFORM TO THE COUNTY OF SAN BERNARDINO DEVELOPMENT CODES AND STANDARDS.
- SOIL TESTING: CONTRACTOR SHALL PROVIDE A HORTICULTURAL SOILS ANALYSIS PERFORMED BY A LABORATORY OF THE CALIFORNIA ASSOC. OF AGRICULTURAL LABORATORIES. SOIL ANALYSIS SUBMITTED TO THE CITY SHALL INCLUDE THE FOLLOWING: SOIL TEXTURE, PERCENTAGE OF ORGANIC MATTER, SOIL INFILTRATION RATE (DERIVED FROM SOIL TEXTURE/ INFILTRATION RATE TABLES), PH AND TOTAL SOLUBLE SALTS. CONTRACTOR SHALL SPECIFICALLY REQUEST THE SOILS LAB TO PROVIDE AMENDMENT RECOMMENDATIONS.
- CONTRACTOR SHALL ENSURE POSITIVE DRAINAGE OF ALL PLANTING AREAS ON SITE AND SUBSURFACE DRAINAGE FOR ENCLOSED PLANTING AREAS.
- THE CONTRACTOR SHALL CAREFULLY INSPECT THE SITE AND VERIFY ALL THE CONDITIONS AND DIMENSIONS PRIOR TO PROCEEDING WITH ANY WORK. NOTIFY LANDSCAPE ARCHITECT AND OWNER IF ANY INCONSISTENCIES OCCUR.
- THE CONTRACTOR SHALL REMOVE ALL WEEDS, ROCKS, DEBRIS AND OTHER EXTRANEANUS MATERIALS FROM THE JOB SITE PRIOR TO PROCEEDING WITH ANY WORK.
- ALL PLANT MATERIALS SHALL BE HANDLED OR STORED SO THAT THEY ARE ADEQUATELY PROTECTED FROM DRYING OUT, FROM SUN OR WIND BURN, OR FROM ANY OTHER INJURY.
- THE CONTRACTOR SHALL APPLY TO ALL PLANTING AREAS FOREST FLOOR MEDIUM GRIND WOOD MULCH OR EQUAL. CONTRACTOR SHALL PROVIDE LANDSCAPE ARCHITECT WITH SAMPLES FOR APPROVAL PRIOR TO INSTALLATION.
- CONTRACTOR TO VERIFY ALL PLANT QUANTITIES SHOWN ON PLANS.
- SEE SHEET L-3 FOR DETAILS & SPECIFICATIONS.
- ALL ABOVE GROUND UTILITIES SHALL BE SCREENED W/ PLANTING. CONTACT CITY LANDSCAPE ARCHITECT REGARDING LOCATIONS.
- ALL PLANTING SHALL NOT INTERFERE W/ TRAFFIC SITE LINES.
- CONTRACTOR SHALL TURN OVER SOIL AMENDMENT VERIFICATION TICKETS TO THE CITY INSPECTOR.
- INSTALL CENTURY PRODUCTS .0060" SIZE NON-PANELED ROOT BARRIERS ADJACENT TO HARDSCAPE WHEN TREES ARE PLANTED 5' FROM THE HARDSCAPE TYP. SEE DETAILS & SPECIFICATIONS.
- CONTACT THE COUNTY REPRESENTATIVE FOR FINAL INSPECTION WHEN ALL WORK IS COMPLETED.
- TREES & SHRUBS SHALL BE PLACED A MINIMUM OF 5' AWAY FROM WATER METER, GAS METER, OR SEWER LATERALS; A MINIMUM OF 10' AWAY FROM UTILITY POLES; & A MINIMUM OF 8' AWAY FROM FIRE HYDRANTS & FIRE DEPARTMENT SPRINKLER & STANDPIPE CONNECTIONS.

PLANTING LEGEND

SYMBOL	BOTANICAL NAME	COMMON NAME	SIZE	NUMBER	REMARKS	WUCOLS IV
TREES:						
●	LAURUS NOBILIS 'SARATOGA'	BAY LAUREL	24" BOX	3	DOUBLE STAKE / HEIGHT 8-10' , SPREAD 3'-4' MIN.	L
●	CERCIDUM 'DESERT MUSEUM'	DESERT MUSEUM PALO VERDE	24" BOX	11	DOUBLE STAKE / HEIGHT 8-10' , SPREAD 3'-4' MIN.	L
SHRUBS:						
●	BACCHARIS PILULARIS 'PIGEON POINT'	PROSTRATE COYOTE BUSH	1 GAL	179	TRIANGULAR SPACING @ 5' O.C.	L
●	HESPERALOE PARVIFLORA	RED YUCCA	5 GAL	52	FULL & BUSHY @ 4' O.C.	L
●	CALLISTEMON VIMINALIS 'LITTLE JOHN'	LITTLE JOHN BOTTLEBRUSH	5 GAL	36	FULL & BUSHY @ 3' O.C.	L
●	DIANELLA 'LITTLE REV'	LITTLE REV FLAX	5 GAL	96	FULL & BUSHY @ 3' O.C.	L
●	ACACIA REDOLENS 'DESERT CARPET'	PROSTRATE ACACIA	1 GAL	5	TRIANGULAR SPACING @ 8' O.C.	L
●	LEUCOPHYLLUM FRUTESCENS 'GREEN CLOUD'	GREEN TEXAS RANGER	5 GAL	28	FULL & BUSHY @ 6' O.C.	L
●	CAESALPINIA PULCHERRIMA	MEXICAN BIRD OF PARADISE	5 GAL	12	FULL & BUSHY @ 6' O.C.	L
VINES:						
●	MACFADYENA UNGUIS-CATI	CAT'S CLAW	5 GAL	1	ATTACH TO WALLS	L
MULCH :						
●	MEDIUM GRIND WOOD MULCH	SHREDDED WOOD MULCH	3" MIN.	AS REQ'D.	3" DEEP - INSTALL TO ALL PLANTING AREAS	

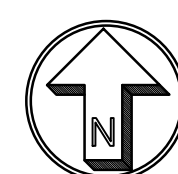

SCALE:
1"=20'-0"

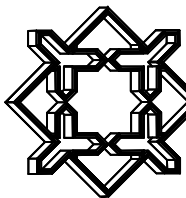


ISSUE INFORMATION:

DATE:	INFORMATION:
04-11-2022	20% CD SET
04-28-2022	50% CD SET
06-15-2022	95% CD SET
09-16-2022	95%CD SET-3rd Bay
10-03-2022	PLAN CHECK

SHEET INFORMATION:

STK PROJECT NO.: 374-154-21
SCALE: AS NOTED
DATE: SEPTEMBER 2022
PLOT DATE: _____
DRAWING NAME: _____

SEAL:

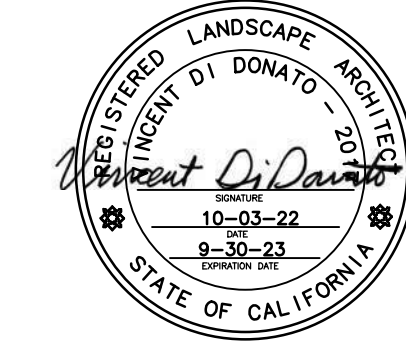


SHEET TITLE:

IRRIGATION
PLAN

SHEET NO.:

L-2
OF 3

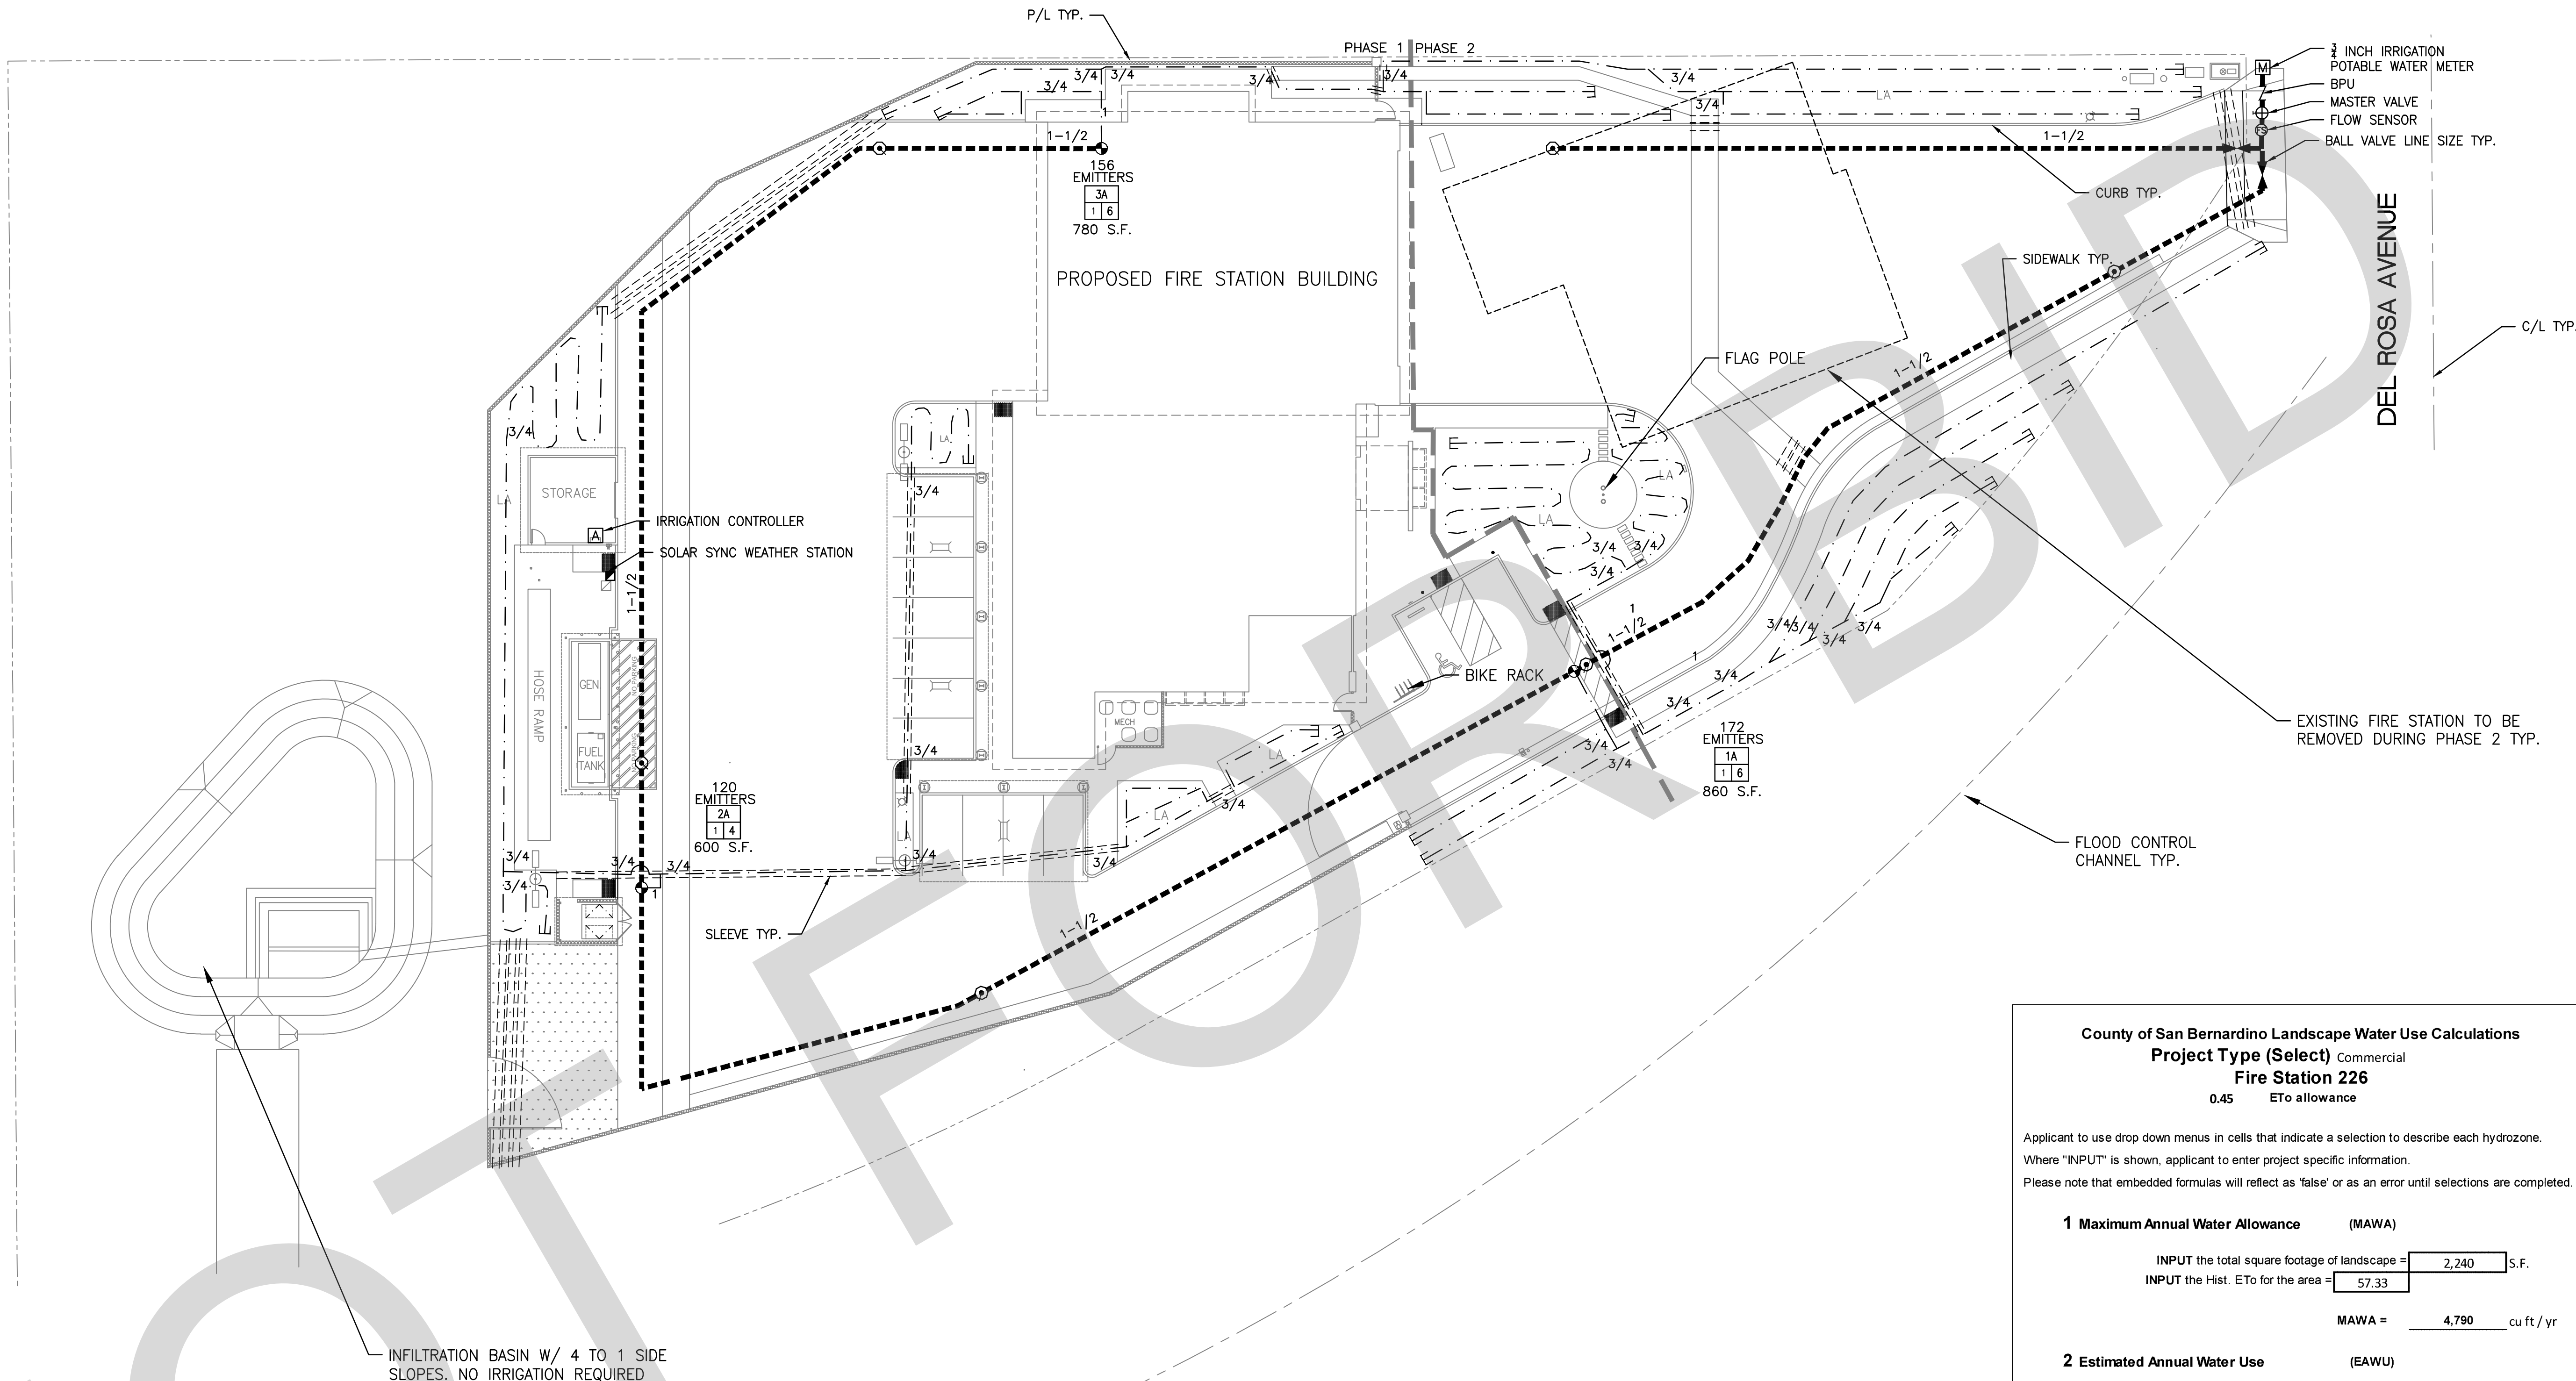

BLU-LOCK SPECIFICATIONS

- HIGH DENSITY POLYETHYLENE PIPE AND FITTINGS:
- A. ALL PIPE SHALL BE CONSTRUCTED OF VIRGIN HIGH DENSITY POLYETHYLENE (HDPE) RESIN WITH THE CELL CLASSIFICATION OF 345464C PER ASTM D 2239 OR ASTM D 2737. THE MATERIAL SHALL CONTAIN 2% CARBON BLACK AS A UV INHIBITOR TO ACCOMMODATE OUTSIDE STORAGE.
- B. ALL PIPE FITTINGS SHALL BE CONSTRUCTED FOR QUICK COUPLE PUSH-ON INSTALLATION WITHOUT THE USE OF GLUE OR CLAMPS ONTO 1/2" SWING, OR 3/4", OR 1", HDPE 3408 SDR 15 LATERAL PIPE.
- C. FITTINGS SHALL BE BUILT OF ABS MATERIAL WITH A STAINLESS STEEL RETAINING RING AND EPDM SEAL MATERIAL.
- D. FITTINGS SHALL BE FOR OUTDOOR USE ONLY ON COLD WATER, NOT FOR USE ON CONSTANT PRESSURE, DESIGNED FOR USE ON LATERALS ONLY OR FOR USE ON ALL SYSTEM LINES FROM THE MASTER VALVE OUT.
- TYPE: HYDRO-RAIN BLU LOCK OR APPROVED EQUAL

IRRIGATION NOTES

- IRRIGATION SYSTEM IS SHOWN DIAGMATICALLY. LOCATE ALL PIPE AND EQUIPMENT WITHIN PLANTING AREAS WHEREVER POSSIBLE.
- LOCATE PRESSURE LINES WITHIN 18" OF EDGE OF HARDSCAPE IN PLANTING AREAS.
- TREE LOCATIONS TAKE PRECEDENCE OVER IRRIGATION PIPING & DRIP LINE. STAKE TREE LOCATIONS PRIOR TO TRENCHING PIPE.
- CONTRACTOR SHALL ARRANGE AND PAY FOR ALL NECESSARY CONNECTIONS FOR 120V A.C. ELECTRICAL SERVICE TO IRRIGATION CONTROLLER.
- CONTRACTOR SHALL INSPECT THE SITE AND VERIFY ALL CONDITIONS PRIOR TO PROCEEDING WITH ANY WORK. TO ALLOW FOR ADEQUATE IRRIGATION COVERAGE AS SHOWN ON PLAN, ADJUST DRIP LINE & EMITTERS TO COMPENSATE FOR ANY CHANGES IN AREA.
- TO ENSURE PROPER LOCATION OF IRRIGATION SLEEVE, INSTALLATION COORDINATE LOCATION OF MAINLINE, DRIP LINES AND CONTROL WIRES WITH ALL OTHER RELATED TRADES AS REQ.
- ALL BRASS FITTINGS TO BE RED BRASS TYPICAL.
- USE 3/4" TEFLON TAPE ON ALL THREADED CONNECTIONS.
- IRRIGATION SYSTEMS DESIGNED FROM A STATIC WATER PRESSURE OF 60.0 P.S.I. CONTRACTOR SHALL VERIFY WATER PRESSURE AT WORST CONDITION AND CONTACT LANDSCAPE ARCHITECT IF ANY INCONSISTENCIES OCCUR.
- CONTROL WIRE SCHEDULE: (MAX. LENGTH OF RUNS)

CONTROL/COMMON NO.	NO. 14	NO. 12	NO. 10	NO. 8
NO. 14	1700'	2000'	2400'	2700'
NO. 12		2700'	3300'	3800'
NO. 10			4300'	5200'
NO. 8				6700'
- ABOVE WIRING SCHEDULE IS BASED ON THE USE OF A 24 VOLT AUTOMATIC IRRIGATION CONTROLLER & WIRE SIZE IS BASED ON OPERATING ONE VALVE AT A TIME.
- ALL IRRIGATION SHALL CONFORM TO THE COUNTY OF SAN BERNARDINO STANDARDS AND SPECIFICATIONS.

IRRIGATION LEGEND

SYMBOL	MANUFACTURER	MODEL NO.	REMARKS - SEE SHEET L-3 FOR DETAILS AND SPECIFICATIONS
[A]	HUNTER	ACC-600	6 STATION AUTOMATIC CONTROLLER W/6 STN MODULE IN A METAL CABINET AND WALL MOUNT NEAR A 120V A.C.
[Z]	FEBCO	825-YA	3/4" REDUCED PRESSURE B.P.U.
[7]	HUNTER	SOLAR SYNC	ET MODULE AND WEATHER STATION, INSTALL ON BUILDING UNOBSTRUCTED BY TREES AND OVERHANGS.
[8]	RAINBIRD	XCZ-100-PRB-COM	1" REMOTE CONTROL VALVE KIT (INCLUDING FILTER W/ 30 P.S.I. REGULATOR)
[9]	HUNTER	IOV-151G	1-1/2" MASTER CONTROL VALVE
[10]	HUNTER	HFS/FC-100	HUNTER FLOW SENSOR WITH 1" FLOW SENSOR BODY, INSTALL PER MANUFACTURER'S RECOMMENDATION
[Q]	RAINBIRD	33DLPC	QUICK COUPLING VALVE - WITH LOCKABLE COVER
[R]	BOWSMITH	SB-20	NON-STOP DRIP EMITTER (2 GPH), 3 PER LOW WATER USE TREE, 1 PER LOW WATER USE SHRUB
[S]	FLO-CONTROL	1520-10/1012-10	LINE SIZE SWING/SPRING CHECK VALVE. SWING TYPE FOR UPHILL & SPRING TYPE FOR DOWNHILL.
[T]	NIBCO	UB SERIES	PLASTIC BALL VALVE (THREADED) LINE SIZE - TYPICAL
[U]	PAC. PLASTICS	SCHEDULE 40	PVC PRESSURE TYPE MAINLINE - INSTALL WITH 18" MINIMUM COVER
[V]	PAC. PLASTICS	315	NON-PRESSURE TYPE SLEEVE
[W]	HYDRO-RAIN	"BLU-LOCK"	NON-PRESSURE LATERAL LINE-INSTALL 2" BELOW GRADE EXCEPT UNDER HARDSCAPE, SEE DETAILS.
[X]	HYDRO-RAIN	POLY	MICRO (SPAGHETTI) POLYTUBE WITH STAKES
[Y]	HYDRO-RAIN	MODEL 5024	AUTO DRAIN FLUSH VALVE

PRESSURE LOSS CALC'S

VALVE 2A @ 7 G.P.M.
PRESSURE AVAILABLE AT METER : 60.0 P.S.I.
REGULATED PRESSURE: 60.0 P.S.I.

EQUIPMENT	SIZE	P.S.I. LOSS
METER	1"	(1.0)
B.P.U.	1"	(11.0)
MASTER VALVE	1-1/2"	(1.5)
BALL VALVE	1-1/2"	(1.1)
R.C.V.	1"	(1.5)
MAIN LINE	1-1/2"	(0.5)
FLOW SENSOR	1"	(4.5)

P.S.I. LOSS BEFORE PRESSURE REGULATOR: (18.1 P.S.I.)

PRESSURE AVAILABLE AT REGULATOR: 41.9 P.S.I.

REGULATOR REDUCES PRESSURE TO: 40.0 P.S.I.

EQUIPMENT	SIZE	P.S.I. LOSS
LATERAL LINES	VARIES	(3.0)
EMITTERS	N/A	(25.0)
ELEVATION CHANGE	0'	(0)

P.S.I. LOSS AFTER PRESSURE REGULATOR: (28.0 P.S.I.)

TOTAL RESIDUAL PRESSURE: 12.0 P.S.I.

LOW DRIP IRRIGATION SCHEDULE

	ETO	% ETO	CU. FT.	GALLONS	DAYS	GPM	MIN	G/DAY
JANUARY	2.17	0.04	124	930.36	4.00	17.60	13	233
FEBRUARY	2.84	0.05	163	1,218.33	5.00	17.60	14	244
MARCH	4.03	0.07	231	1,727.81	7.00	17.60	14	247
APRIL	4.55	0.08	261	1,949.33	8.00	17.60	14	244
MAY	6.10	0.11	349	2,613.87	11.00	17.60	14	238
JUNE	7.65	0.13	438	3,278.42	13.00	17.60	14	252
JULY	7.86	0.14	450	3,367.02	14.00	17.60	14	241
AUGUST	7.24	0.13	415	3,101.21	13.00	17.60	14	239
SEPTEMBER	6.00	0.10	344	2,569.57	10.00	17.60	15	257
OCTOBER	4.03	0.07	231	1,727.81	7.00	17.60	14	247
NOVEMBER	2.69	0.05	154	1,151.88	5.00	17.60	13	230
DECEMBER	2.17	0.04	124	930.36	4.00	17.60	13	233
	57.33	1.00	3,284	24,565.98				

RUN EACH SYSTEM FOR THE MINUTES SHOWN EVERY DAY DURING THE ESTABLISHMENT PERIOD

County of San Bernardino Landscape Water Use Calculations
Project Type (Select) Commercial
Fire Station 226
0.45 ETo allowance

Applicant to use drop down menus in cells that indicate a selection to describe each hydrozone.
Where "INPUT" is shown, applicant to enter project specific information.
Please note that embedded formulas will reflect as 'false' or as an error until selections are completed.

1 Maximum Annual Water Allowance (MAWA)

INPUT the total square footage of landscape = 2,240 S.F.
INPUT the Hist. ETo for the area = 57.33

MAWA = 4,790 cu ft / yr


2 Estimated Annual Water Use (EAWU)

Hydrozone #	INPUT square footage of hydrozone =	Plant Factor =	Hydrozone Irrigation Efficiency =	EAWU =	Plant Type	Water Use
Hydrozone # 1	2,240	0.2	0.90	2,365	Shrubs / Groundcover	Low
Hydrozone # 2	0	0	1	0	SELECT	SELECT
Hydrozone # 3	0	0	1	0	SELECT	SELECT
Hydrozone # 4	0	0	1	0	SELECT	SELECT
Hydrozone # 5	0	0	1	0	SELECT	SELECT
Hydrozone # 6	0	0	1	0	SELECT	SELECT



SubTotal EAWU = 2,365 cu ft / yr
Input Irrigation System Operation Factor = 0.85
Total EAWU = 2,782
MAWA - EAWU = 2,008 cu ft / yr
(this number must be positive)



PERCENTAGE OF WATER SAVED RELATIVE TO MAX. ALLOWED = 42%

IRRIGATED AREA IS CALCULATED @ 5 S.F. PER DRIP EMITTER, THE WETTABLE AREA OF EACH TREE AND SHRUB

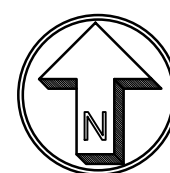

SCALE:
1"=20'-0"

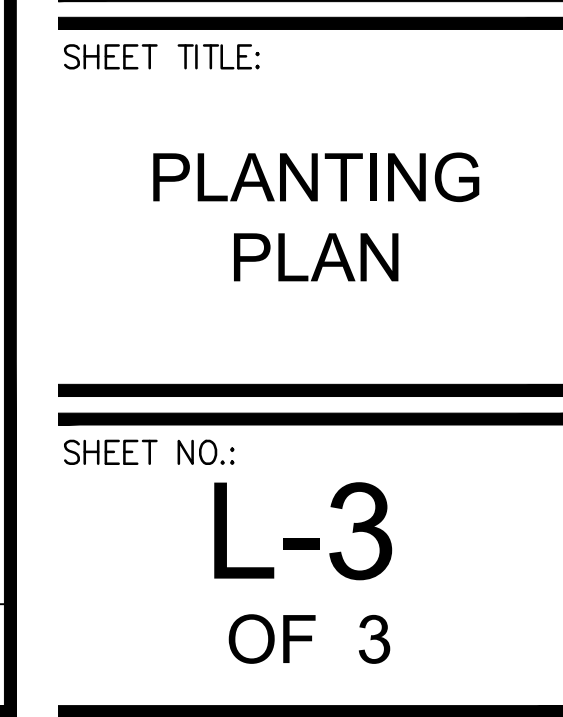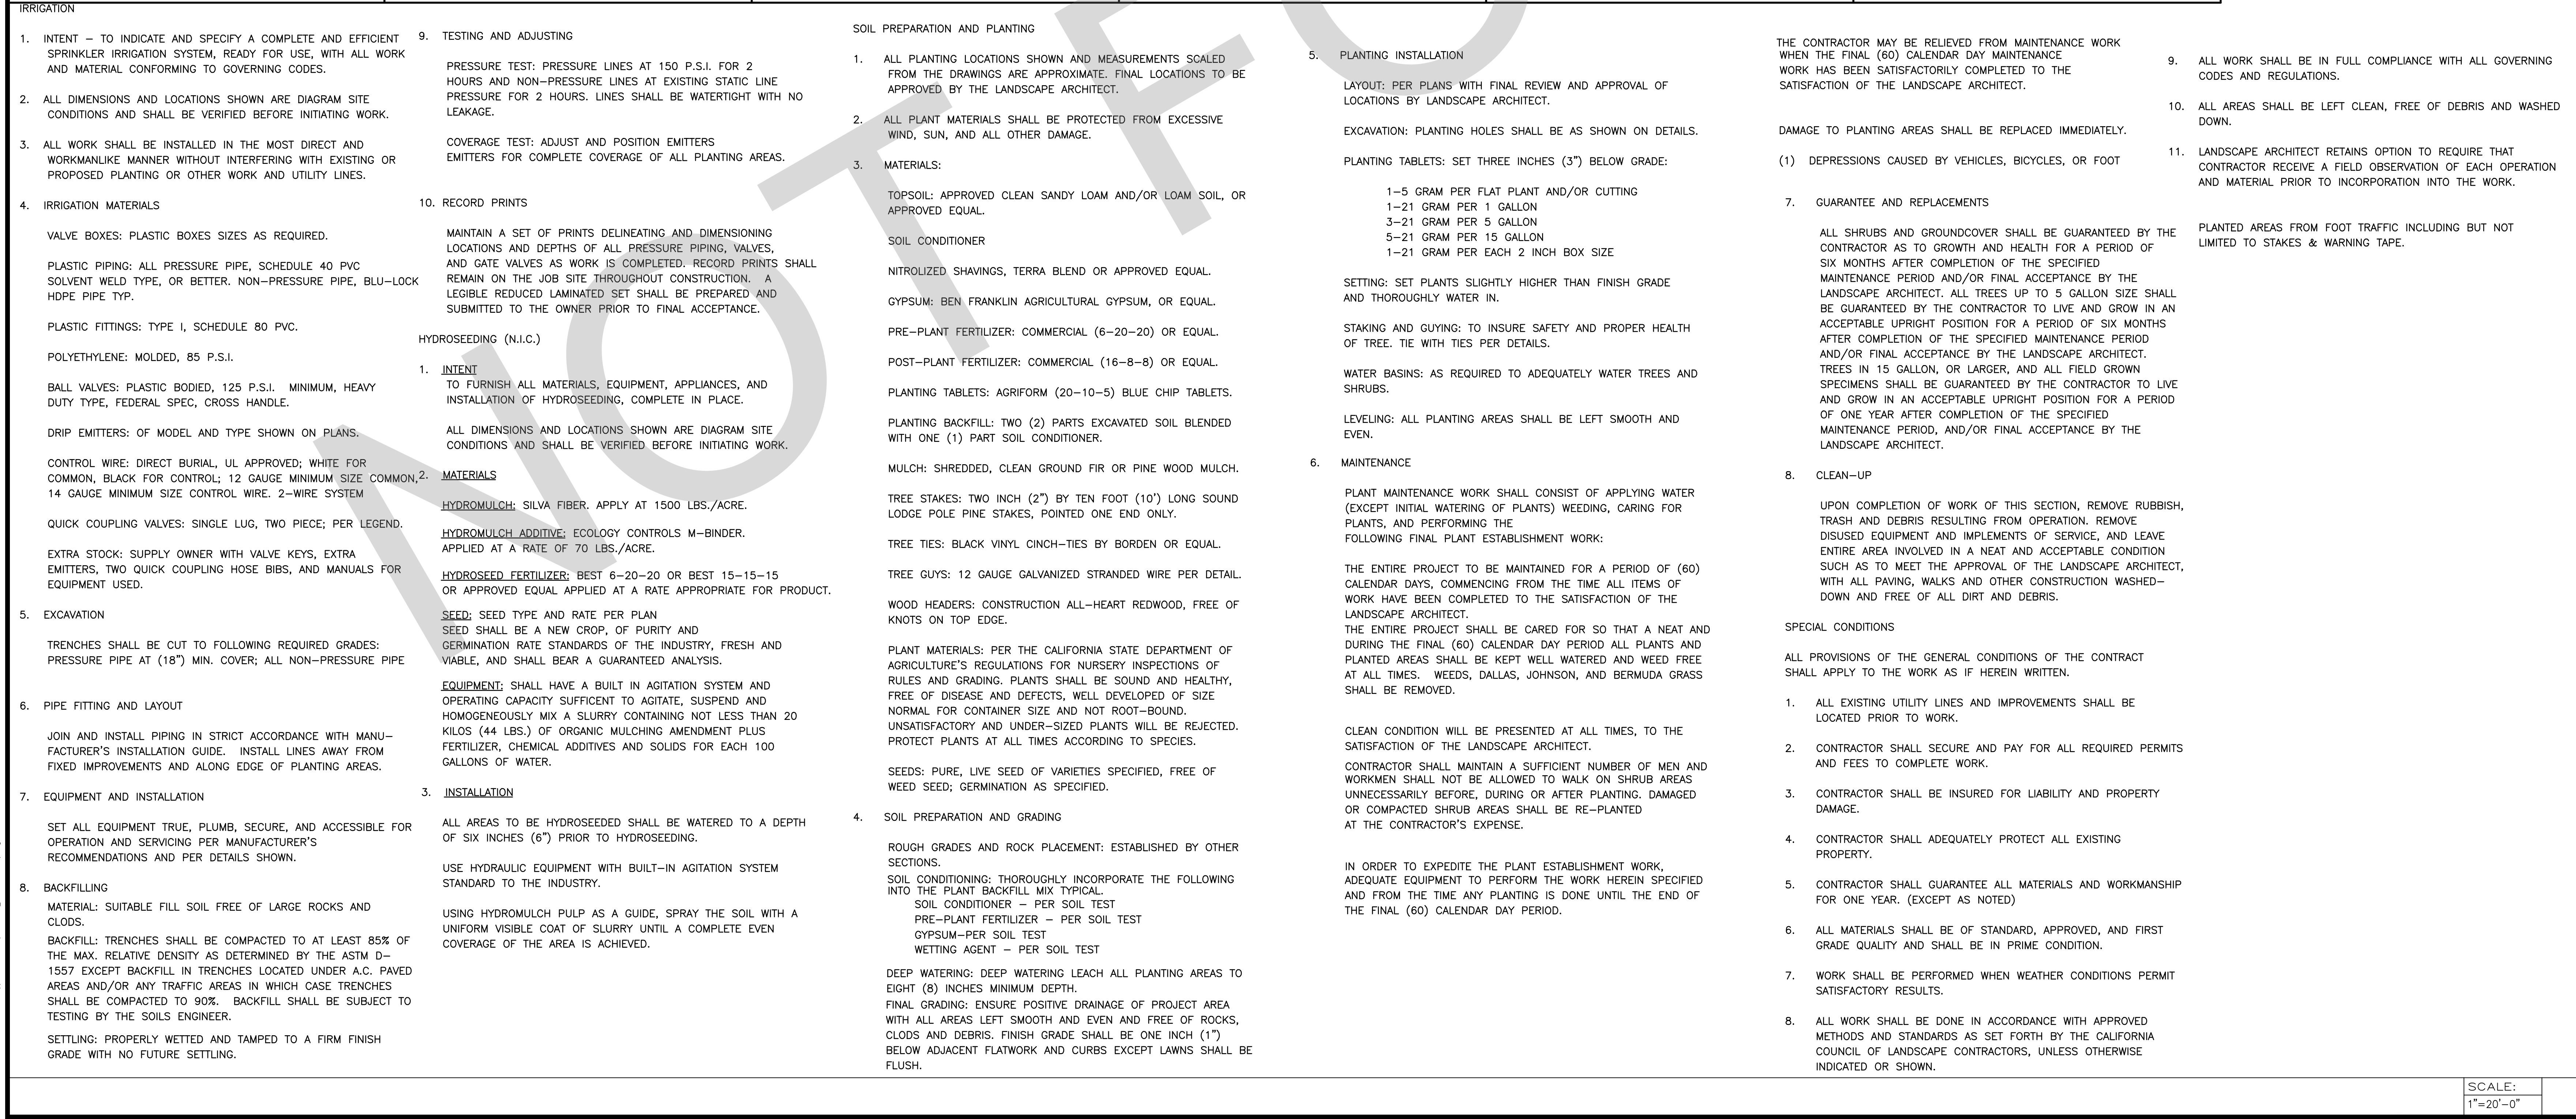

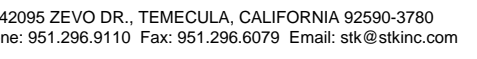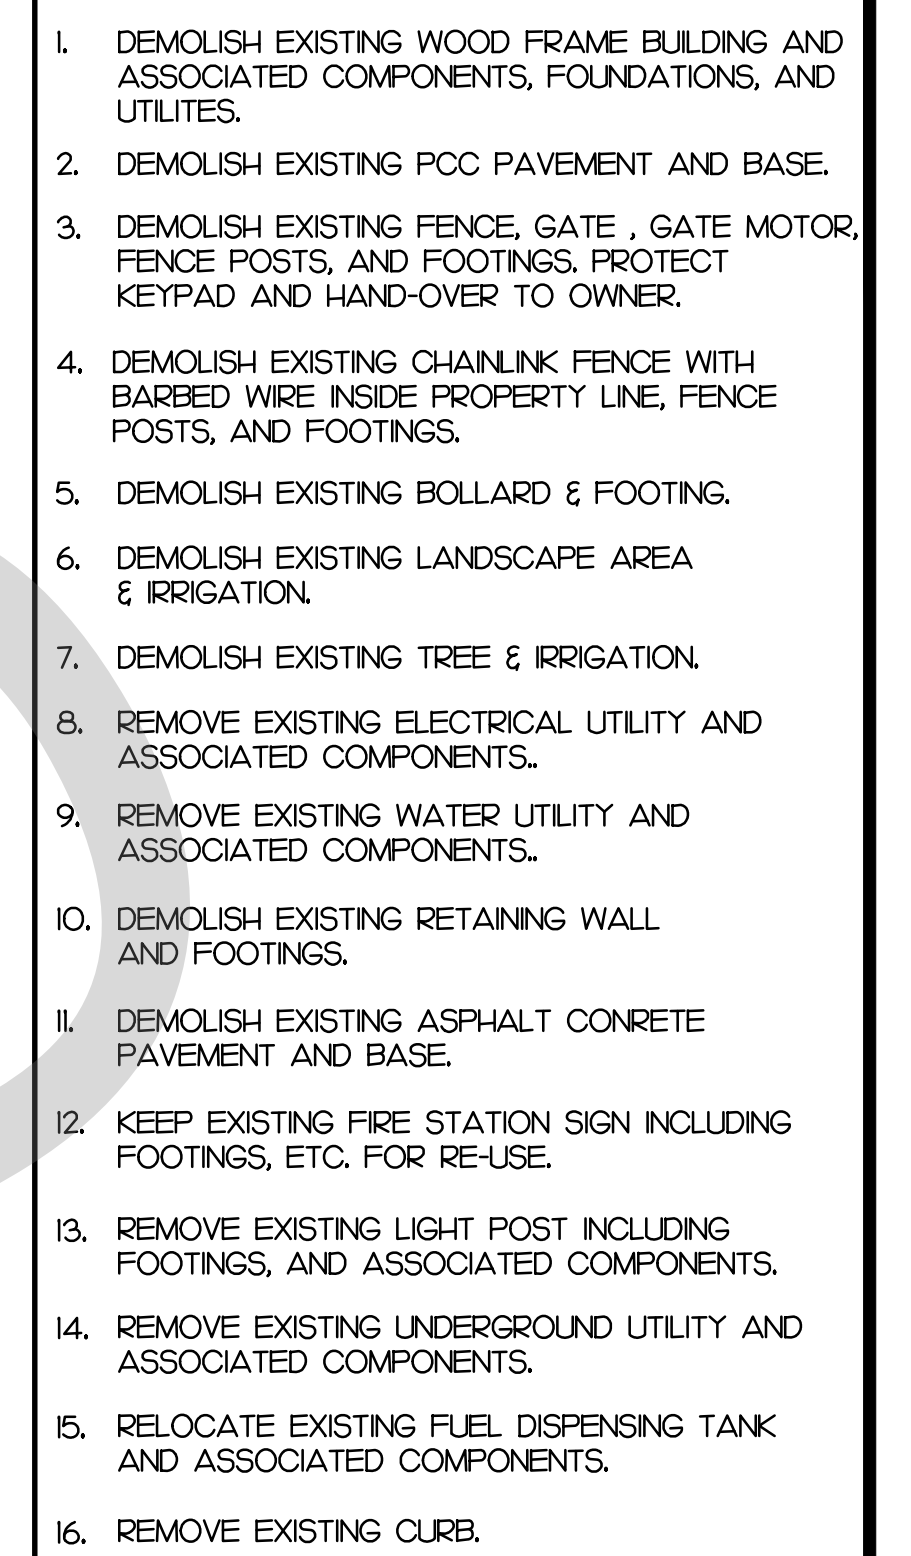

PROJECT ADMINISTERED BY:
SAN BERNARDINO COUNTY
PROJECT & FACILITIES
MANAGEMENT DEPARTMENT

SAN BERNARDINO
COUNTY FIRE
DEPARTMENT:
FIRE STATION 226


1 # 0273-011-22

TE:	INFORMATION:
-11-2022	20% CD SET
-28-2022	50% CD SET
-15-2022	95% CD SET
-16-2022	95% CD- 3rd BAY
03-2022	PLAN CHECK

K PROJECT NO.: 374-I54-21
 SALE: AS NOTED
 DATE: JANUARY 2021
 LOT DATE: -
 DRAWING NAME:

DEMOLITION PLAN

A1.0

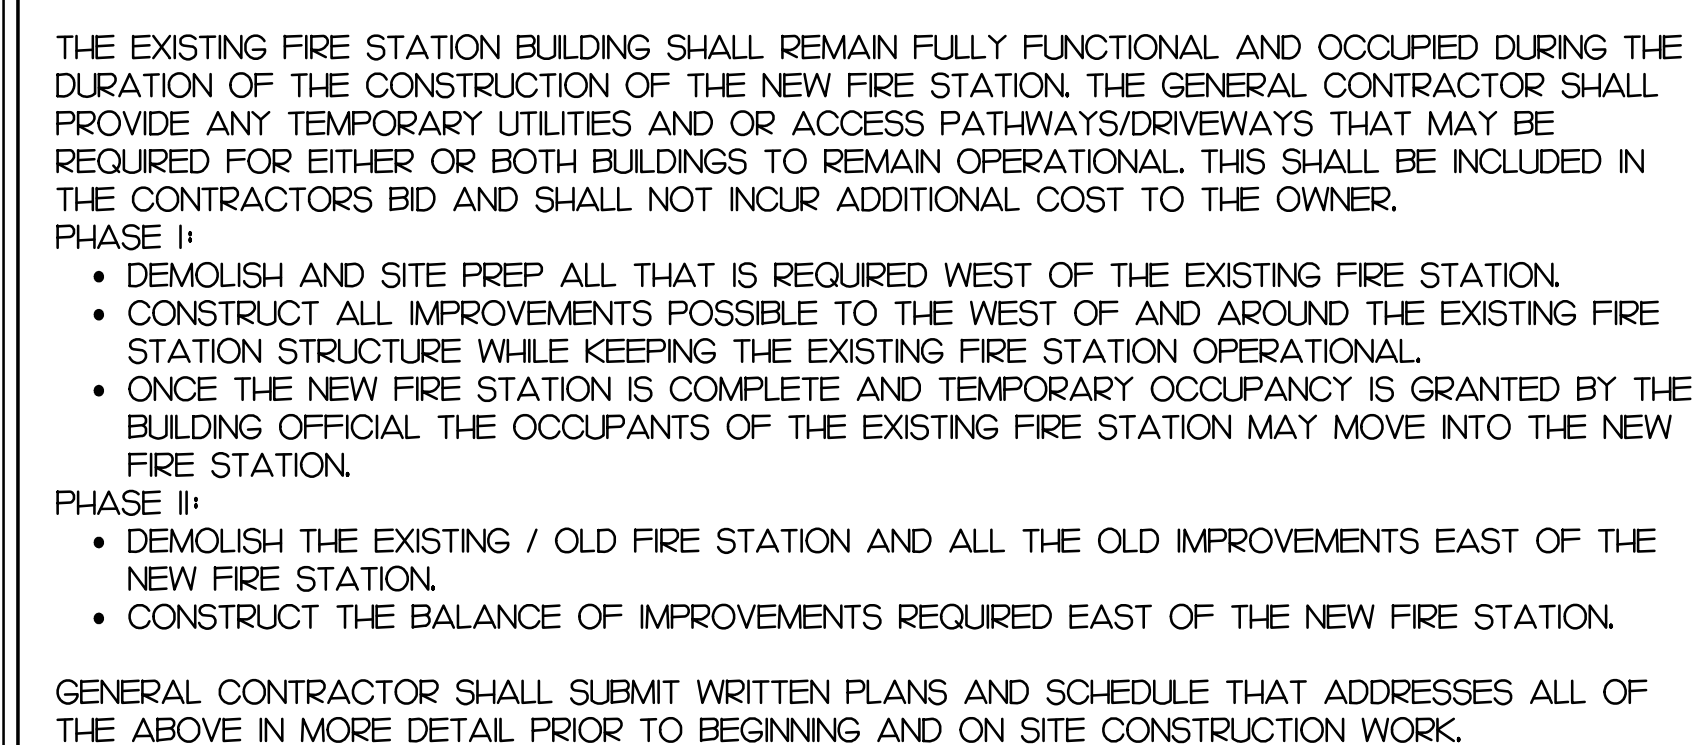

SCALE:
1"=20'-0"


1

DEMOLITION PLAN

2:17374 SAN BERNARDINO COUNTY FIRE STATION 226, 1500 DEL ROSA DRIVE, SAN BERNARDINO, CA 92404. SHEET PLAN 226

03/20/2022 10:00AM

SITE PLAN

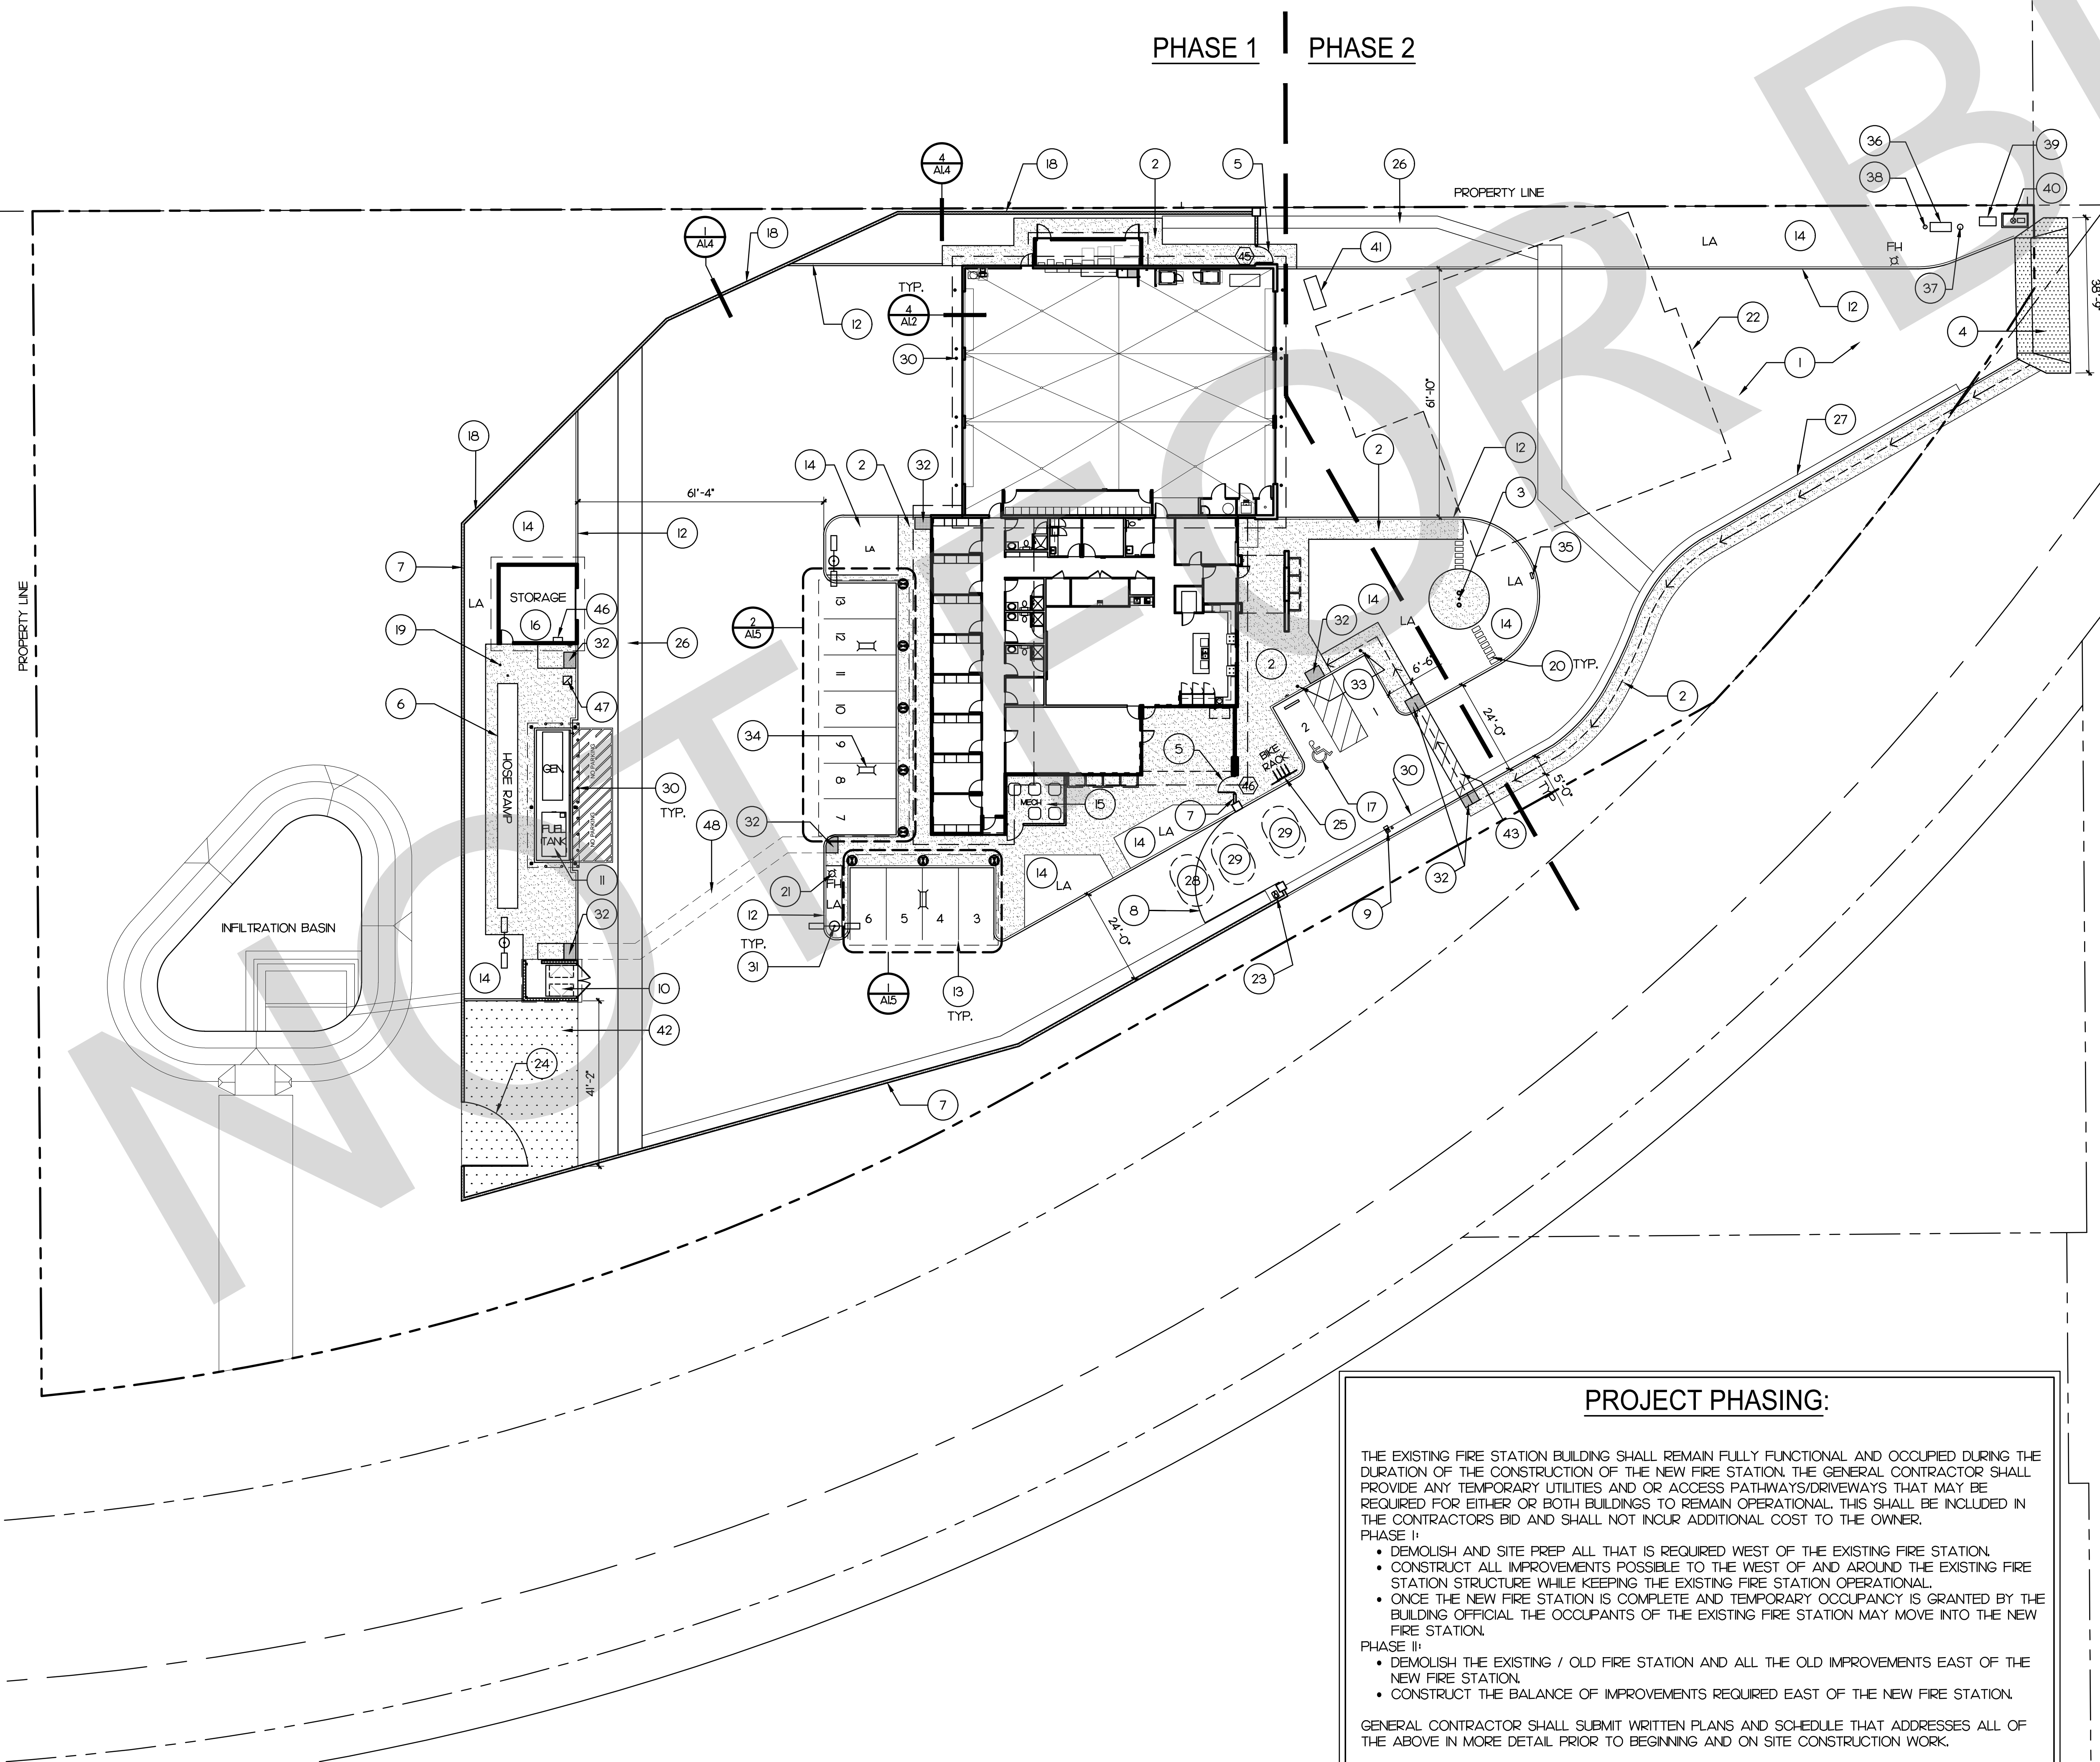

PROJECT PHASING:

THE EXISTING FIRE STATION BUILDING SHALL REMAIN FULLY FUNCTIONAL AND OCCUPIED DURING THE DURATION OF THE CONSTRUCTION OF THE NEW FIRE STATION. THE GENERAL CONTRACTOR SHALL PROVIDE ANY TEMPORARY UTILITIES AND OR ACCESS PATHWAYS/DRIVEWAYS THAT MAY BE REQUIRED FOR EITHER OR BOTH BUILDINGS TO REMAIN OPERATIONAL. THIS SHALL BE INCLUDED IN THE CONTRACTORS BID AND SHALL NOT INCUR ADDITIONAL COST TO THE OWNER.

PHASE I:

- DEMOLISH AND SITE PREP ALL THAT IS REQUIRED WEST OF THE EXISTING FIRE STATION.
- CONSTRUCT ALL IMPROVEMENTS POSSIBLE TO THE WEST OF AND AROUND THE EXISTING FIRE STATION STRUCTURE WHILE KEEPING THE EXISTING FIRE STATION OPERATIONAL.
- ONCE THE NEW FIRE STATION IS COMPLETE AND TEMPORARY OCCUPANCY IS GRANTED BY THE BUILDING OFFICIAL THE OCCUPANTS OF THE EXISTING FIRE STATION MAY MOVE INTO THE NEW FIRE STATION.

PHASE II:

- DEMOLISH THE EXISTING / OLD FIRE STATION AND ALL THE OLD IMPROVEMENTS EAST OF THE NEW FIRE STATION.
- CONSTRUCT THE BALANCE OF IMPROVEMENTS REQUIRED EAST OF THE NEW FIRE STATION.

GENERAL CONTRACTOR SHALL SUBMIT WRITTEN PLANS AND SCHEDULE THAT ADDRESSES ALL OF THE ABOVE IN MORE DETAIL PRIOR TO BEGINNING AND ON SITE CONSTRUCTION WORK.

KEY NOTE

1. 9" CONCRETE PAVING (4500 PSI) W/ #4'S AT 24" O.C. EACH WAY AT MID-SLAB OVER 6" CLASS 2 BASE. PROVIDE SAWCUT CONTROL JOINTS (CJ) AT 10'-0" O.C. & EXPANSION JOINTS (EJ) AT 60' O.C. SEE 4/A12.

2. CONCRETE SIDEWALK W/ EXPANSION JOINTS AT 15'-0" O.C. & CONTROL JOINTS AT 5'-0" O.C. (TYP.)

3. FLAGPOLE WITH UPLIGHTS. SEE 5/A12.

4. 12" CONCRETE PAVING (4500 PSI) W/ #4'S AT 18" O.C. EACH WAY AT MID-SLAB OVER 6" CLASS 2 BASE. PROVIDE CONTROL JOINTS (CJ) AT 10'-0" O.C. AND EXPANSION JOINTS (EJ) AT 20'-0" O.C. SEE 4/A12.

5. PERSONNEL GATE- TYP. OF 2. PROVIDE LEVEL LANDING OF 60'x60" AND 24" CLEAR AT GATE STRIKE SIDE (PULL SIDE). SEE 2/A12.

6. HOSE DRYING RAMP. SEE 1/A12.

7. 6' HIGH CMU WALL TOPPED WITH ANTI-CLIMB CURVED FENCE PANELS. SEE 8/A12.

8. MOTORIZED SWINGING GATE. SEE 9/A12.

9. MOTORIZED GATE KEYPAD ON PEDESTAL & PIPE BOLLARD AT 30' AWAY FROM FACE OF GATE. MOUNT KEYPAD AT +40'; FIELD VERIFY.

10. TRASH ENCLOSURE. SEE 1/A12.

11. ABOVE GROUND FUEL TANK & GENERATOR. CONCRETE CONTAINMENT POND & CANOPY. SEE 9/A12.

12. CONCRETE CURB OR CONCRETE CURB & GUTTER.

13. PARKING LOT STRIPING.

14. LANDSCAPE.

15. MECHANICAL EQUIPMENT ENCLOSURE. SEE 2/A12.

16. STORAGE BUILDING. SEE 9/A12.

17. ACCESSIBLE PARKING SPACE. SEE 3/A12.

18. RETAINING WALL WITH CMU FENCE & ANTI-CLIMB. SEE 1/A12 & 4/A12.

19. HOSE BIBB AT 140" HIGH MECHANICALLY ANCHORED TO 4" SQ. PIPE CONC. FILLED. (PAINT - OSHA YELLOW)

20. 12x24 CONCRETE STEPPING PADS. SPACED AT 6' TYP. OF 12.

21. FIRE HYDRANT (TYP. OF 2).

22. EXISTING BUILDING TO DEMOLISHED.

23. GATE MOTOR ON 4" THICK CONCRETE PAD.

24. MANUAL SWINGING GATE. SEE 8/A12.

25. BIKE RACK WITH CONC. PAD - INSTALL PER MANUF.'S RECOMMENDATIONS.

26. CROSS GUTTER. SEE CIVIL DWGS.

27. ROLLED CURB. SEE CIVIL DWGS.

28. MOTORIZED GATE EXIT LOOP.

29. MOTORIZED GATE SAFETY LOOPS (TYP. OF 2).

30. 6" DIA. PIPE BOLLARD. SEE 7/A12.

31. LIGHT POLE (TYP. OF 3). SEE ELECTRICAL.

32. DETECTABLE WARNING SURFACE.

33. BOLLARD LIGHT FIXTURE (TYP. OF 2) SEE ELECTRICAL.

34. CAR CANOPY LIGHTING. SEE ELECTRICAL.

35. MAIL BOX.

36. DOUBLE DETECTOR CHECK ASSEMBLY. SEE CIVIL DWGS.

37. PLV.

38. FDC.

39. REDUCED PRESSURE PRINCIPAL BACKFLOW ASSEMBLY (RPP). SEE CIVIL DWGS.

40. WATER METER. SEE CIVIL DWGS.

41. CLARIFIER. SEE PLUMBING.

42. COMPACTED GRAVEL.

43. ACCESSIBLE PATH STRIPING.


44. EMERGENCY SHUT-OFF FOR ABOVE FUEL TANK. SEE 7/A12.

45. PATH OF ACCESS.

46. IRRIGATION CONTROLLER. SEE LANDSCAPE DWGS.


47. IRRIGATION SOLAR SYNC WEATHER STATION. SEE LANDSCAPE DWGS.

48. UNMARKED ADA PATH.

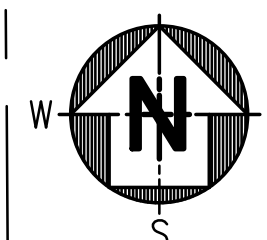

SCALE: 1"=20'-0"

1

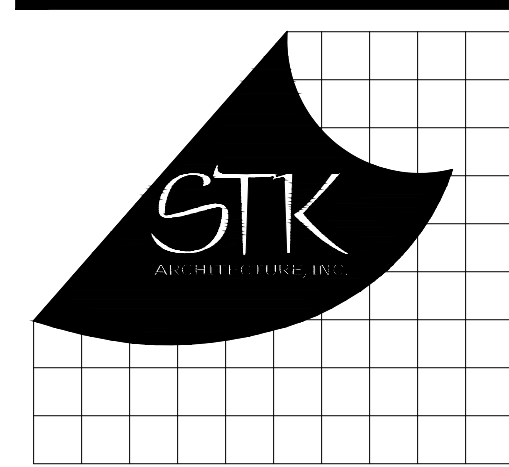

42055 ZEVIO DR., TEMECULA, CALIFORNIA 92590-3760
Phone: 951.296.8110 Fax: 951.296.6079 Email: stk@stkinc.com

CONSULTANT:

PROJECT ADMINISTERED BY:
SAN BERNARDINO COUNTY
PROJECT & FACILITIES
MANAGEMENT DEPARTMENT

385 N. ARROWHEAD AVE.
SAN BERNARDINO, CA 92415

PROJECT NAME:
SAN BERNARDINO
COUNTY FIRE
DEPARTMENT:
FIRE STATION 226

PROJECT # 10101032

CIP #21-037

CAFM # SAB198

APN # 0273-011-22

1920 DEL ROSA AVE N.
SAN BERNARDINO,
CA 92404

ISSUE INFORMATION:

DATE:	INFORMATION:
04-11-2022	20% CD SET
04-28-2022	50% CD SET
06-15-2022	95% CD SET
09-16-2022	95% CD- 3rd BAY
10-03-2022	PLAN CHECK

SHEET INFORMATION:

STK PROJECT NO.: 374-154-21
SCALE: AS NOTED
DATE: JANUARY 2021
PLOT DATE:
DRAWING NAME:

SEAL:


















SHEET TITLE:

SITE PLAN

SHEET NO.:

A1.1

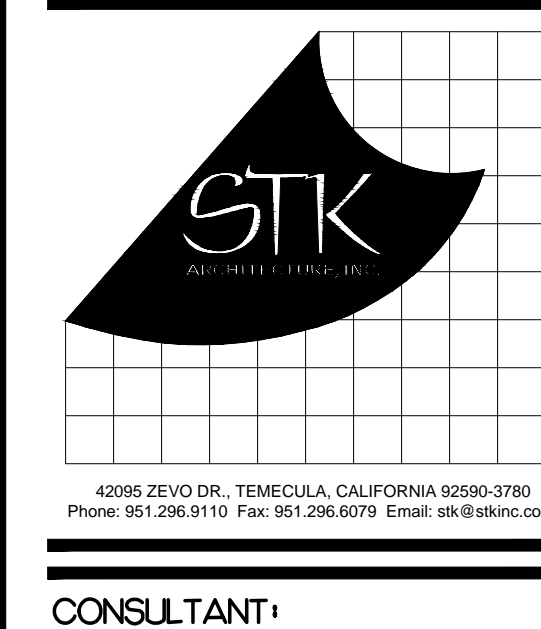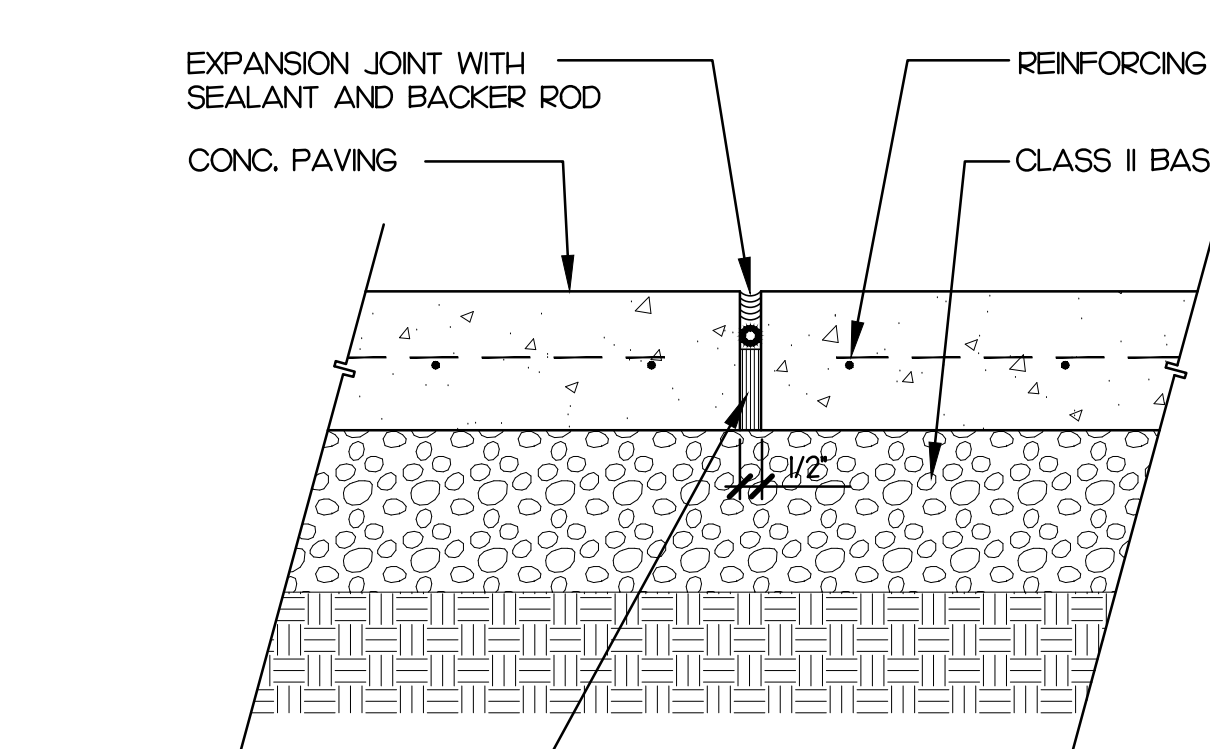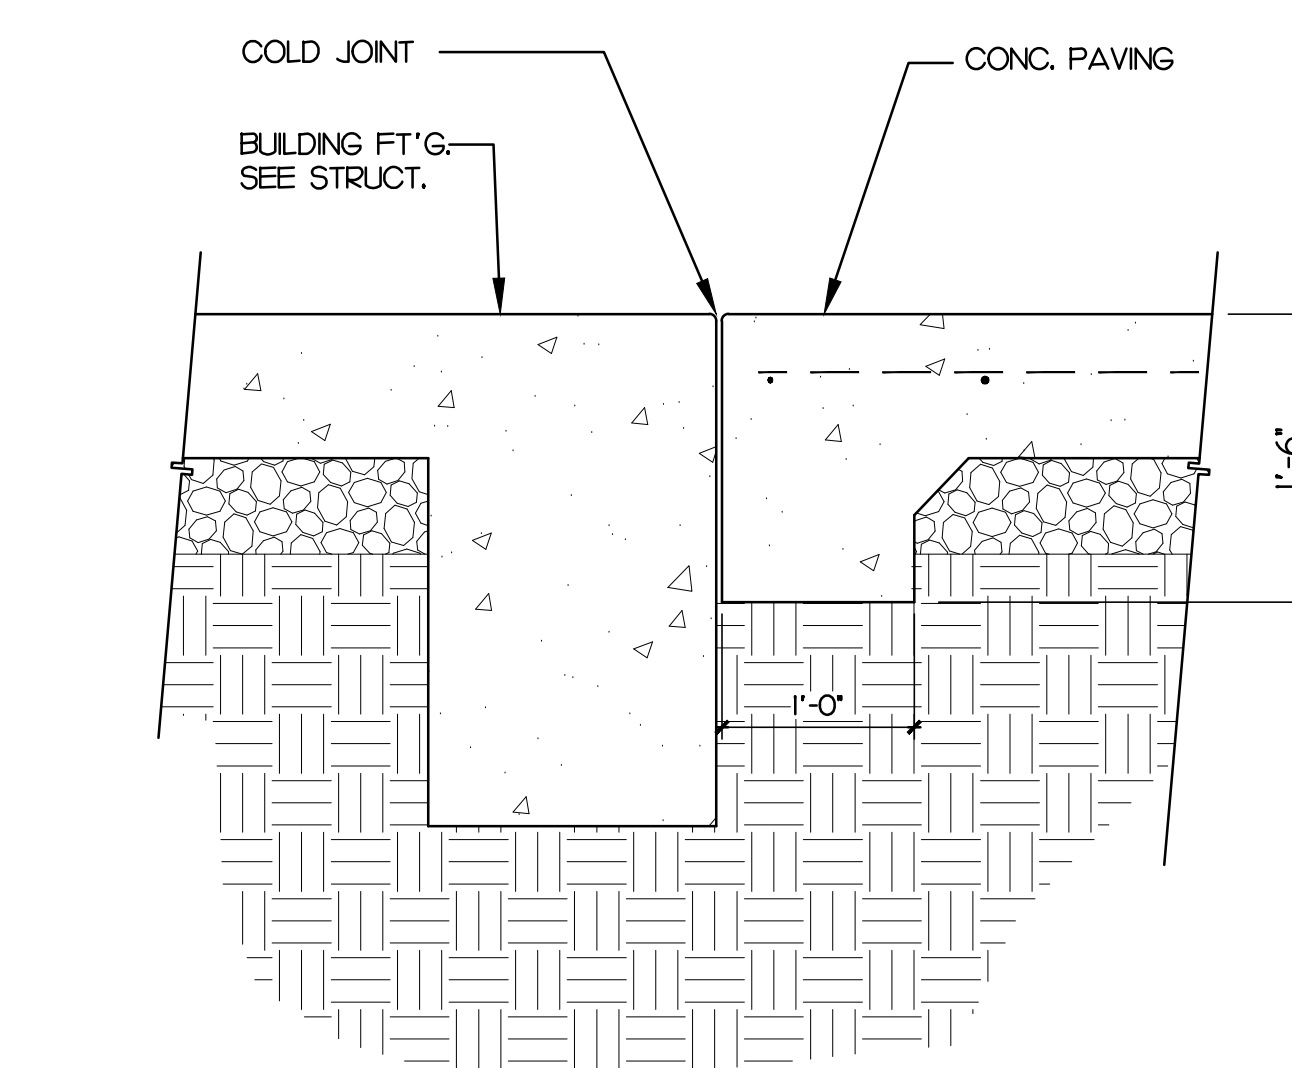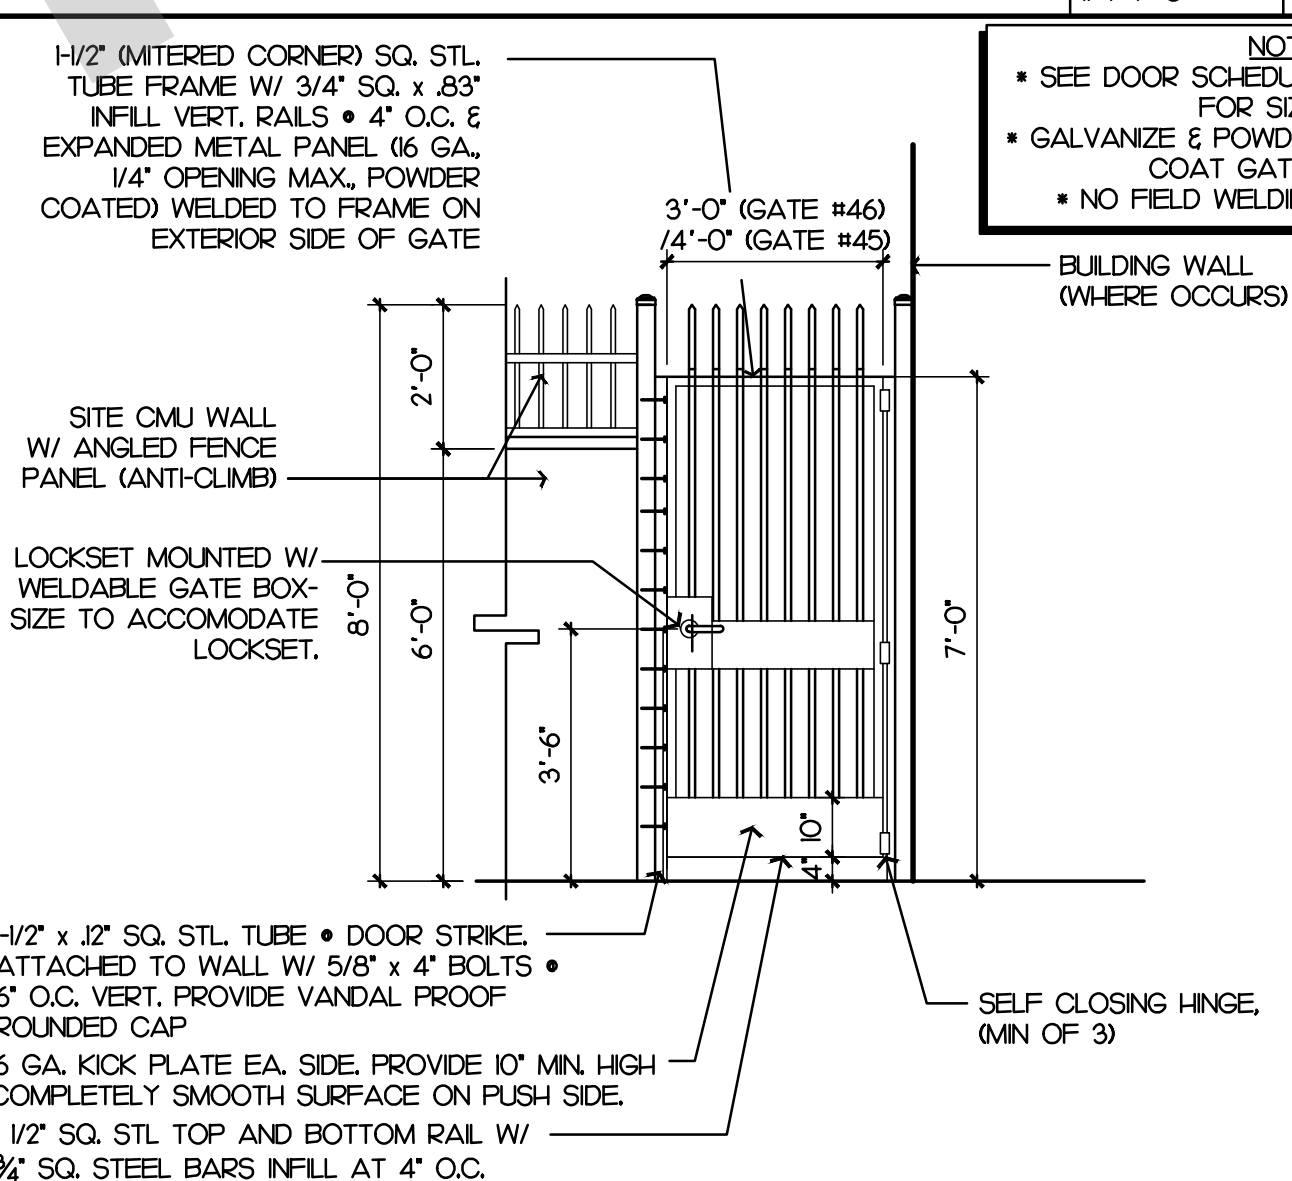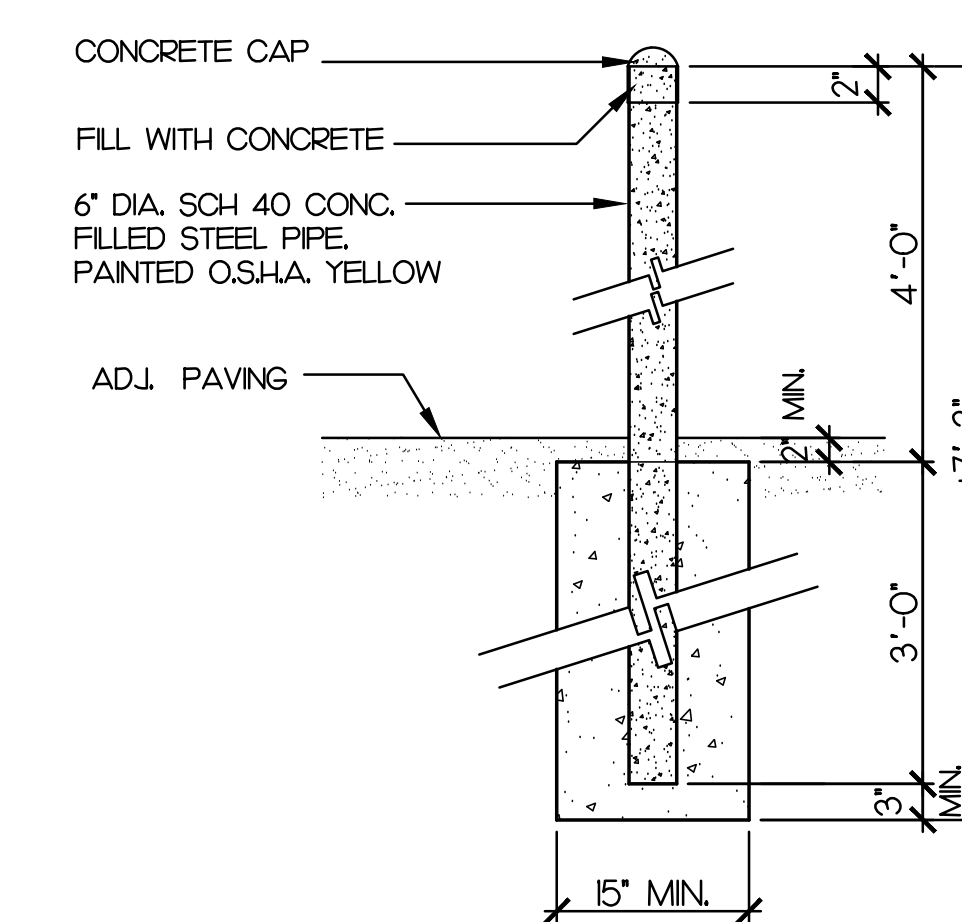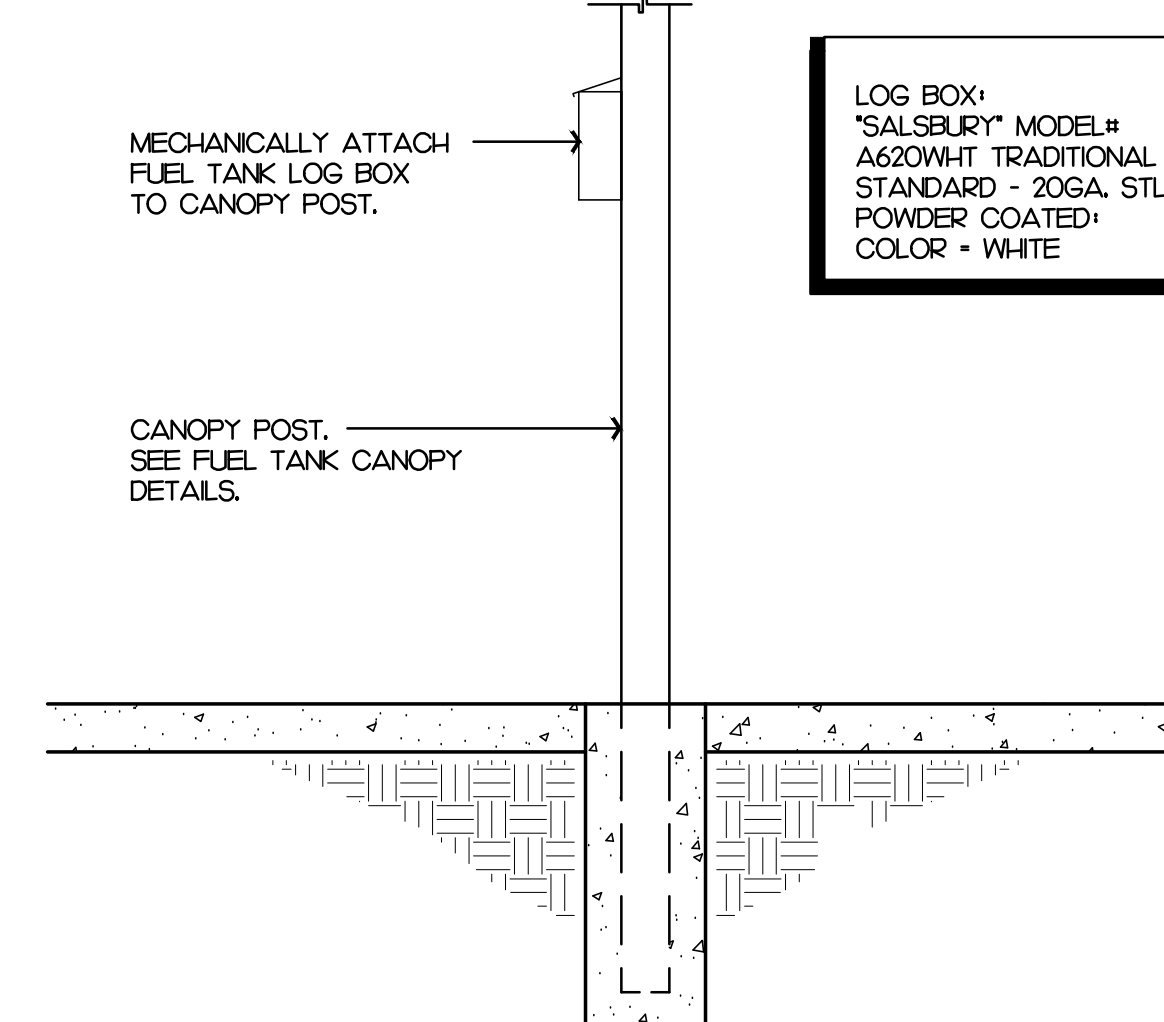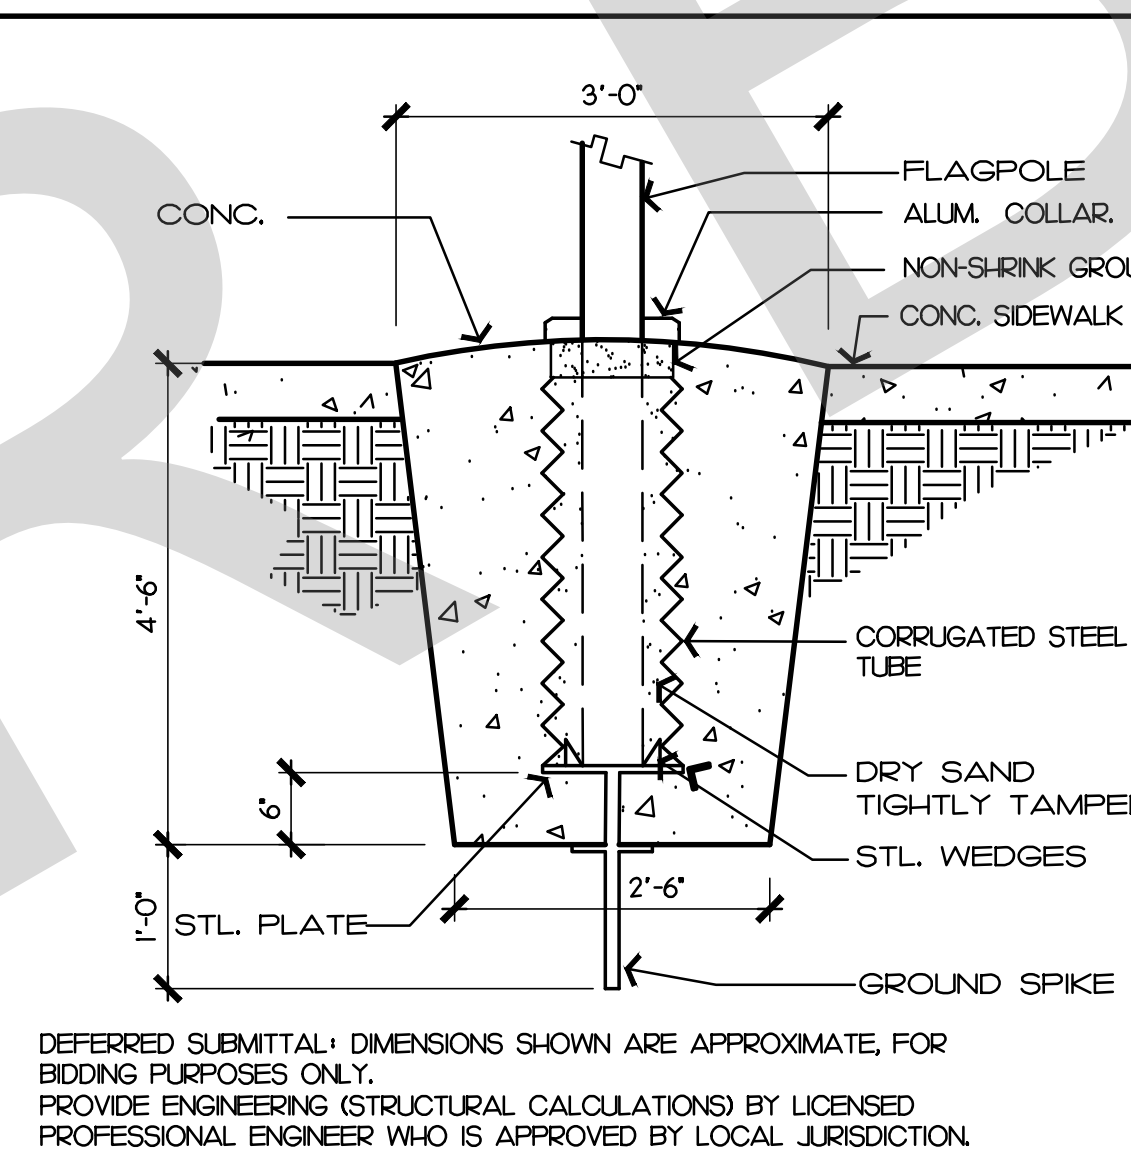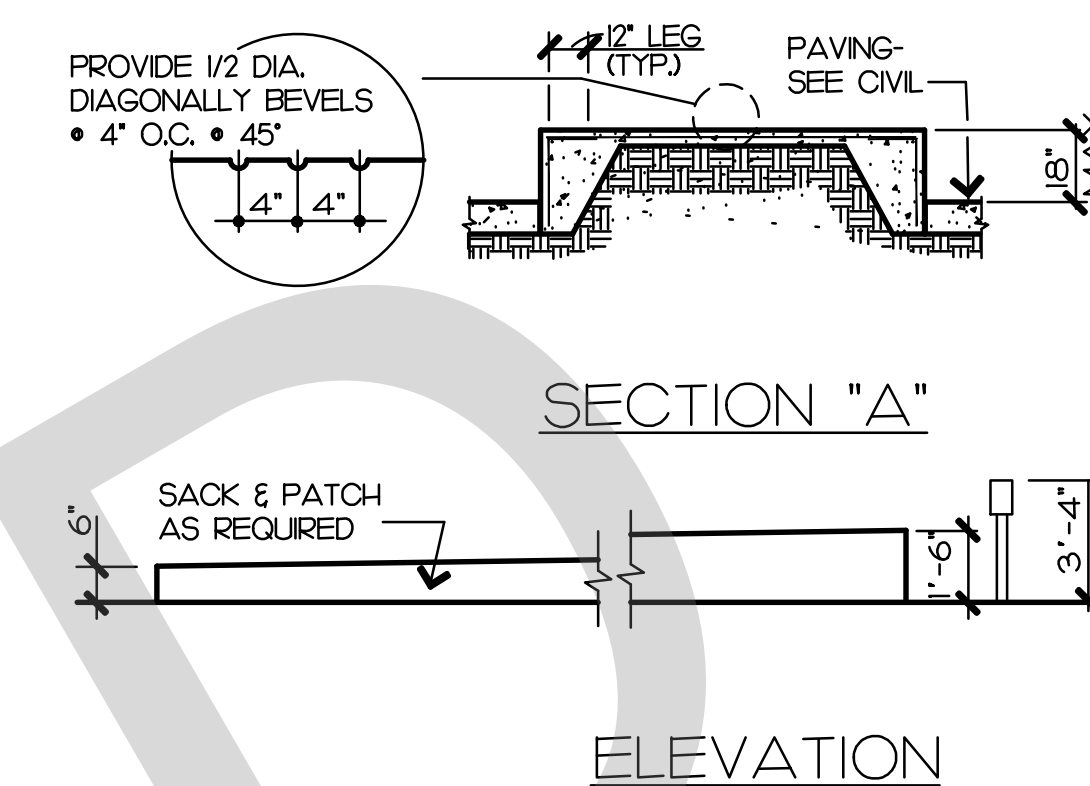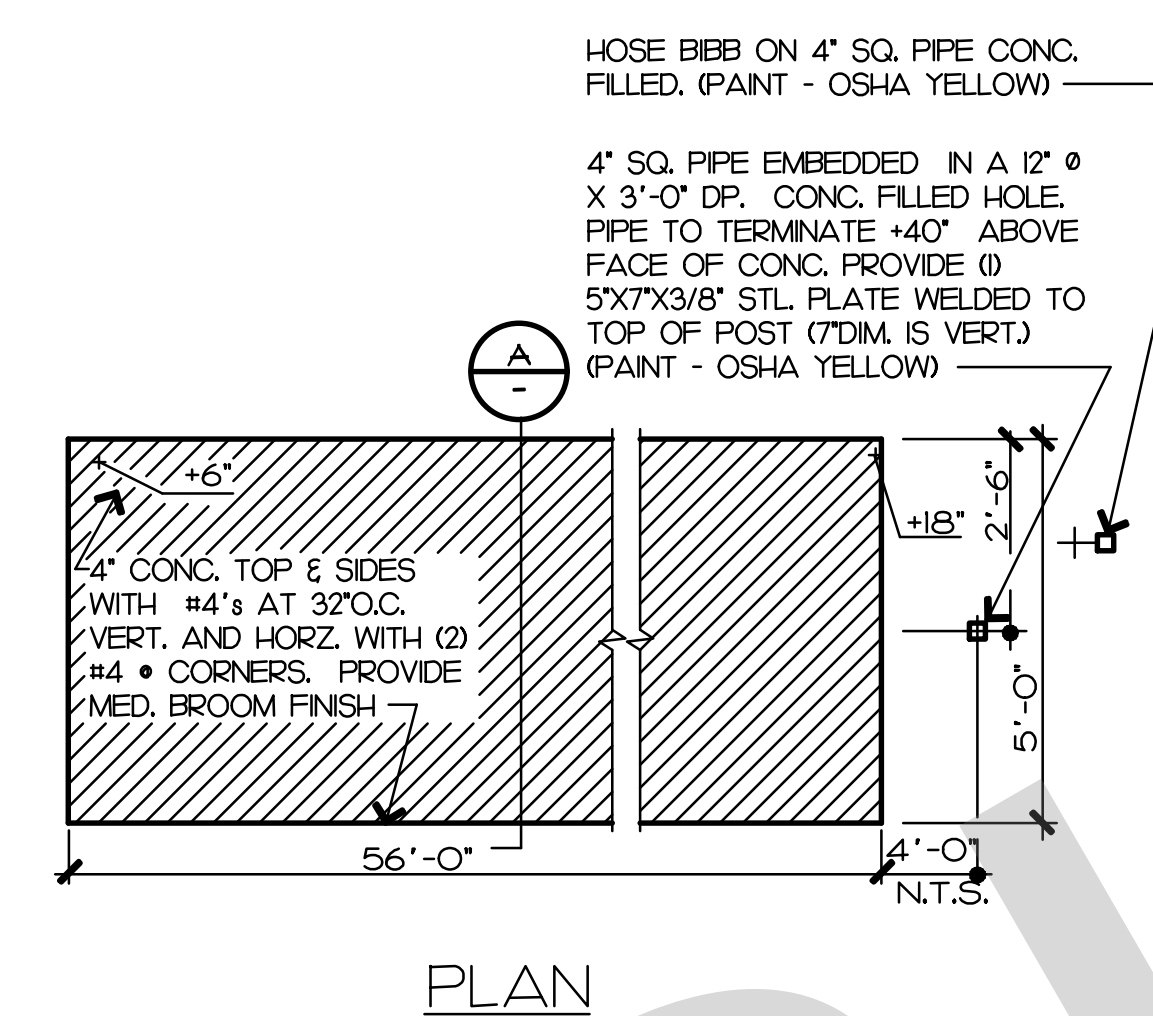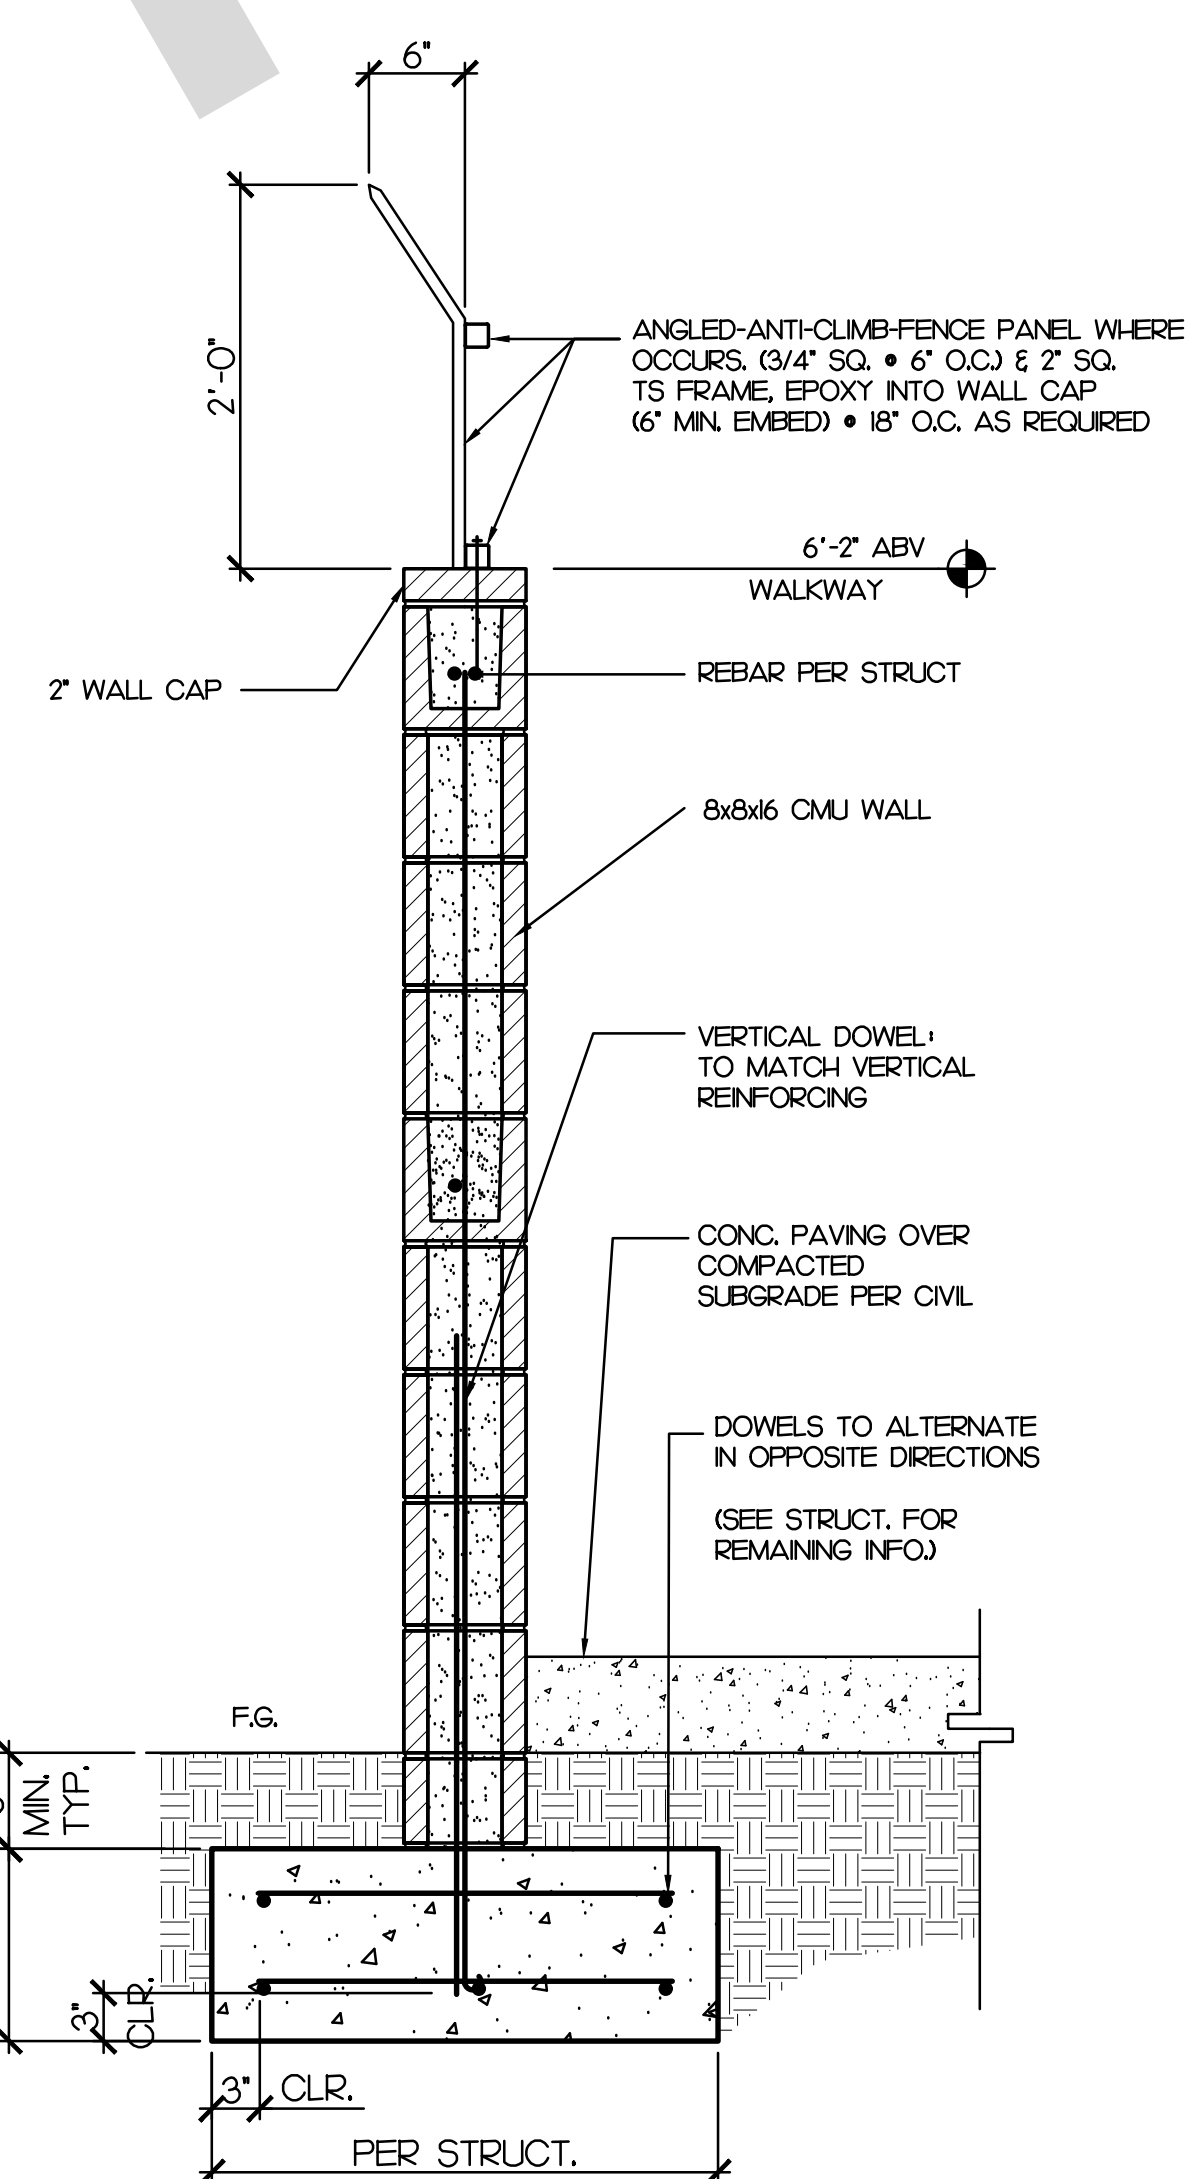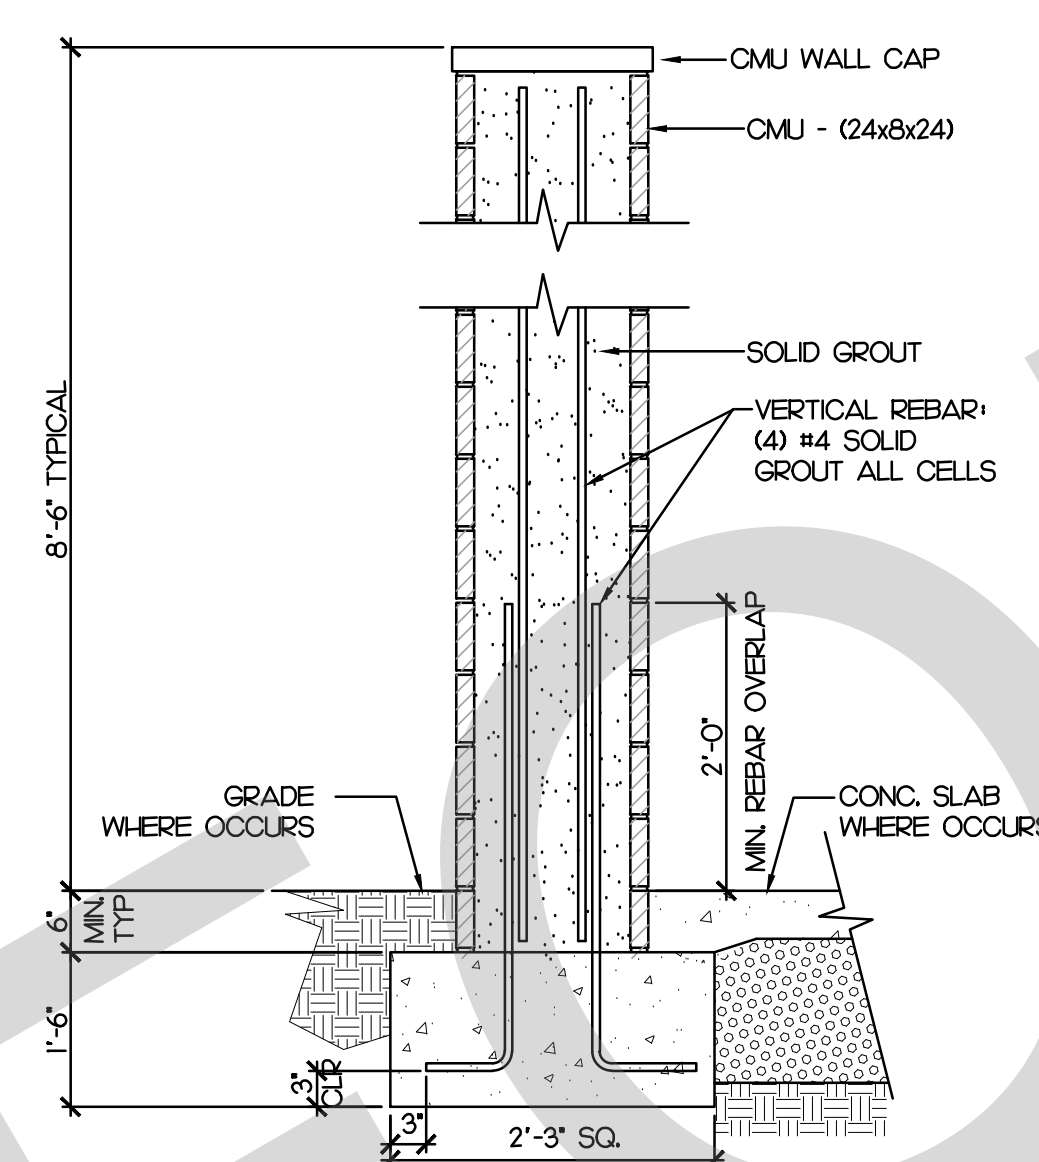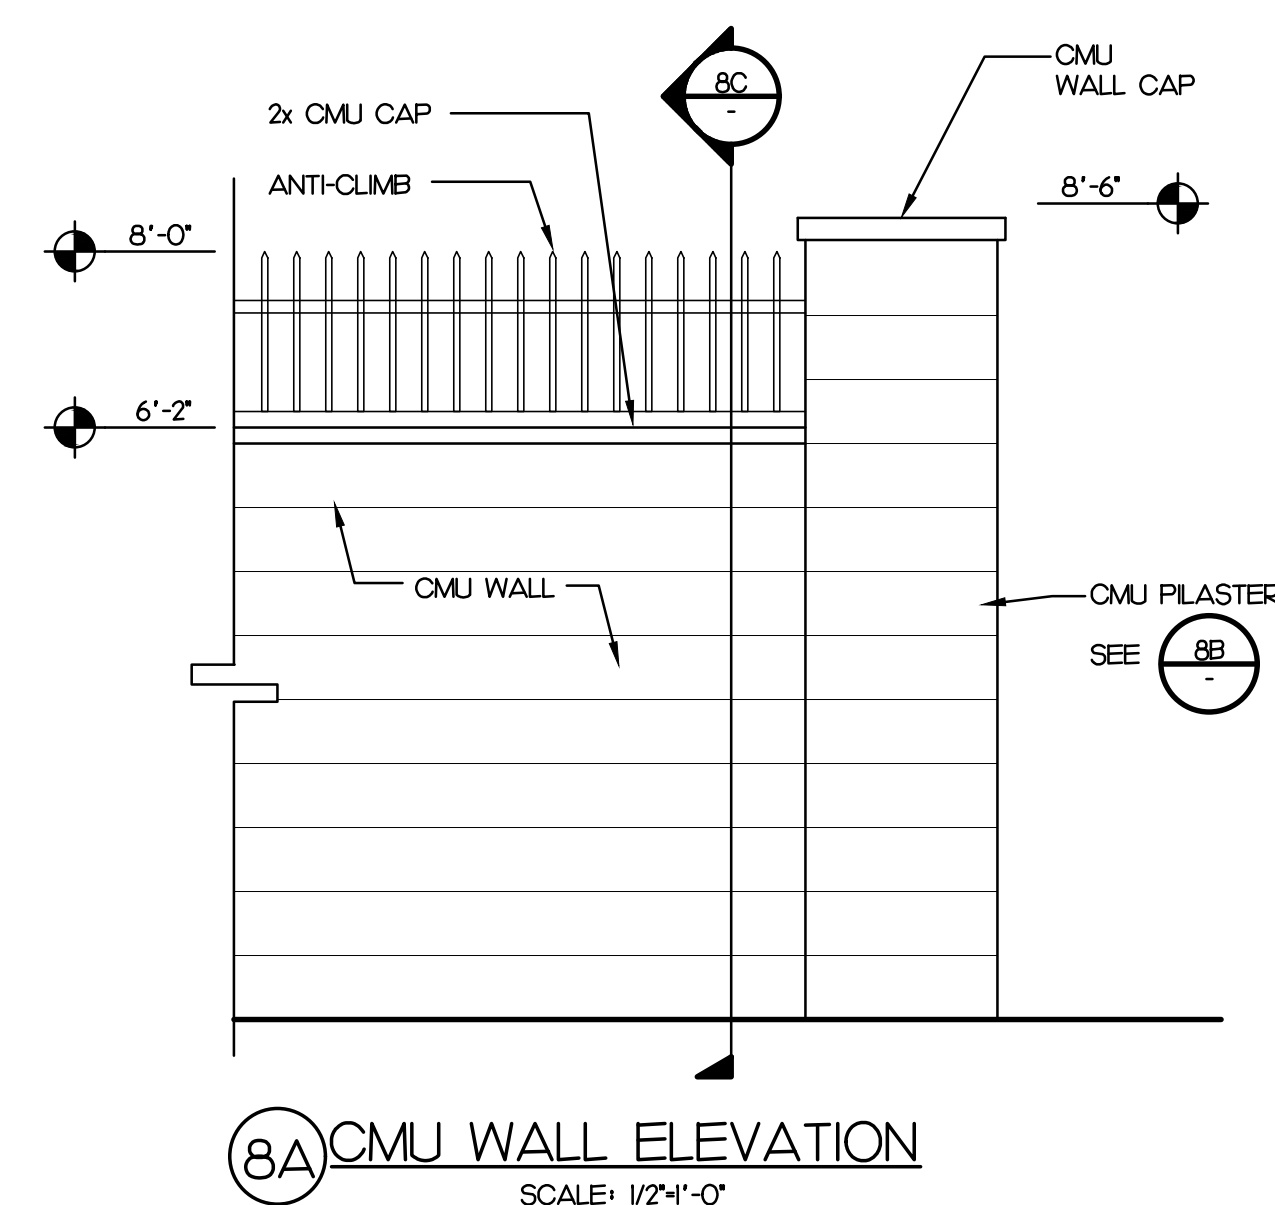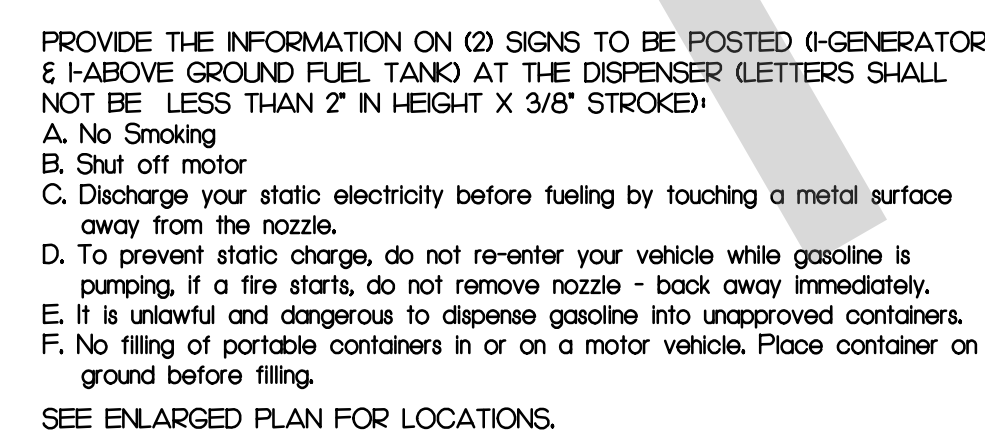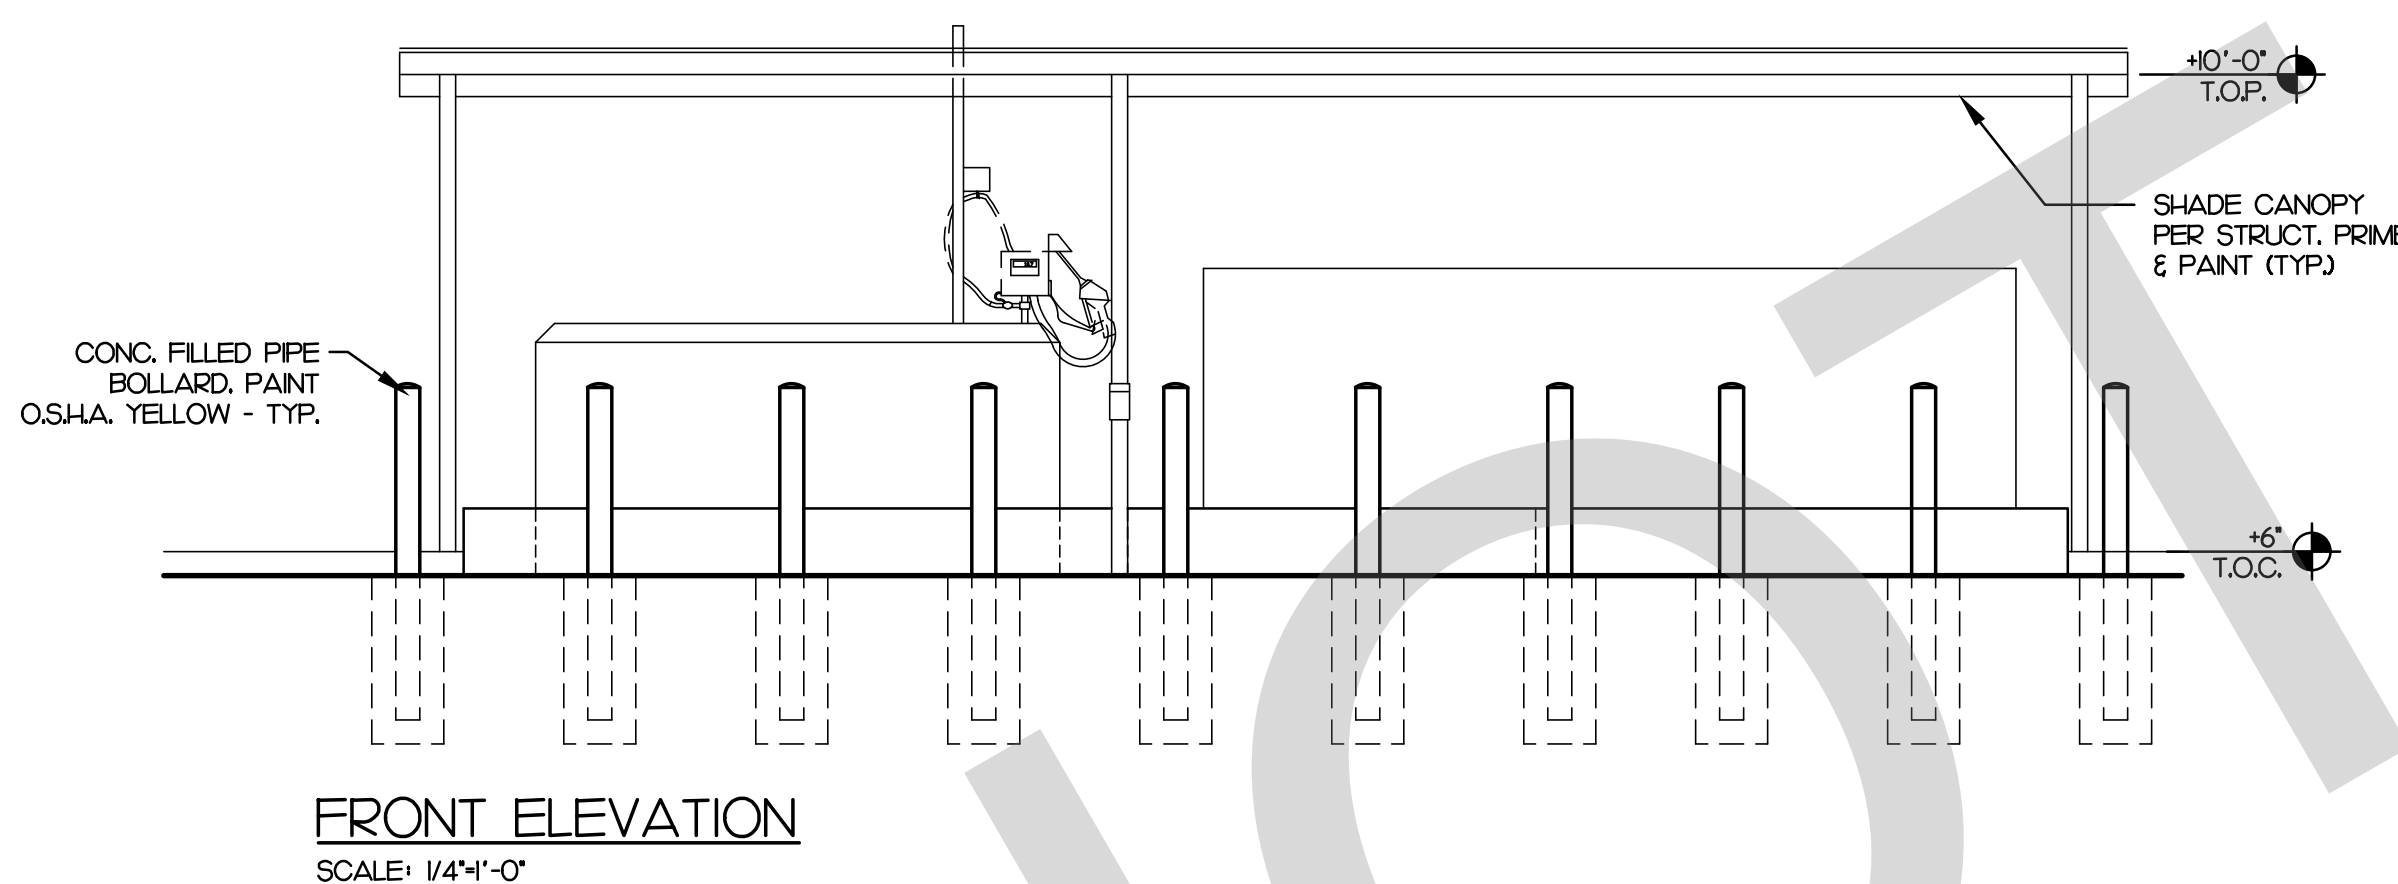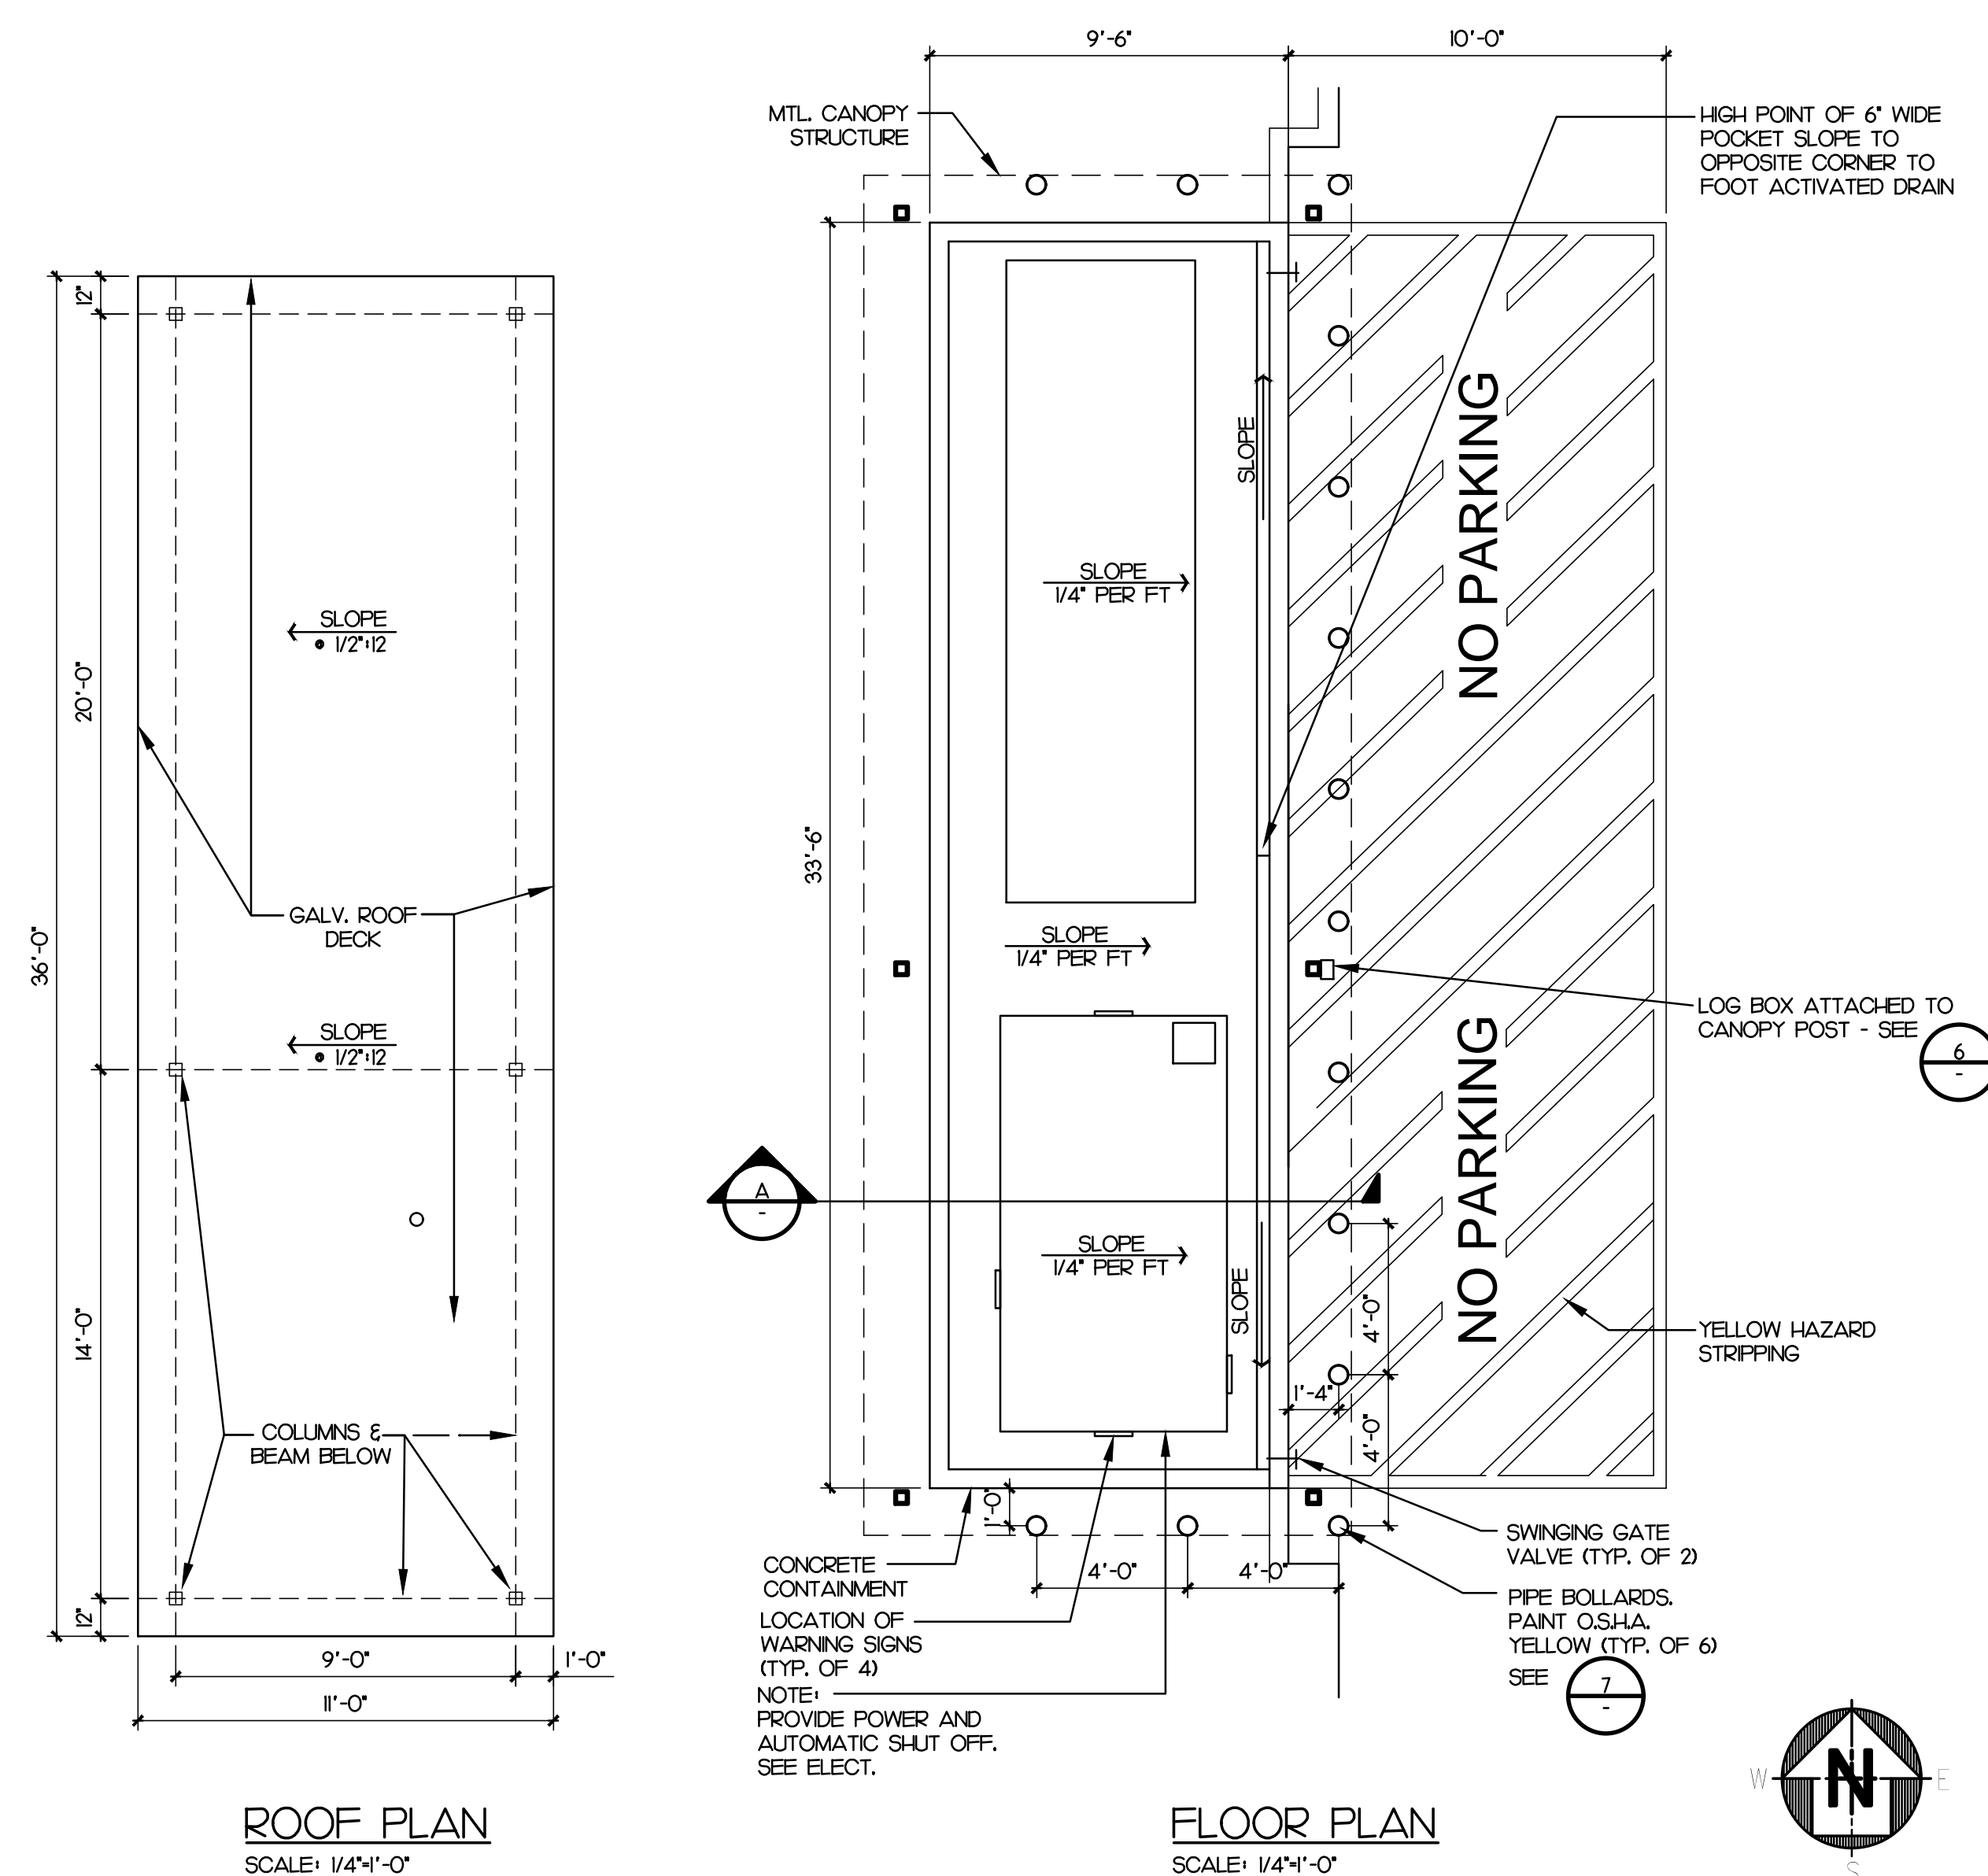

PROJECT ADMINISTERED BY:
SAN BERNARDINO COUNTY
PROJECT & FACILITIES
MANAGEMENT DEPARTMENT

385 N. ARROWHEAD AVE.
SAN BERNARDINO, CA 92415

PROJECT NAME:
SAN BERNARDINO
COUNTY FIRE
DEPARTMENT:
FIRE STATION 226

PROJECT # 10.10.1032
CIP #21-037
CAFM # SABI98
APN # 0273-011-22

1920 DEL ROSA AVE N.
SAN BERNARDINO,
CA 92404

ISSUE INFORMATION:	
DATE:	INFORMATION:
04-11-2022	20% CD SET
04-28-2022	50% CD SET
06-15-2022	95% CD SET
09-16-2022	95% CD- 3rd BA
10-03-2022	PLAN CHECK

SHEET INFORMATION:

STK PROJECT NO.: 374-154-
SCALE: AS NOTED
DATE: JANUARY 20
PLOT DATE:
DRAWING NAME:

SEAL:










SHEET TITLE:


SITE DETAILS

SHEET NO.:


A1.2

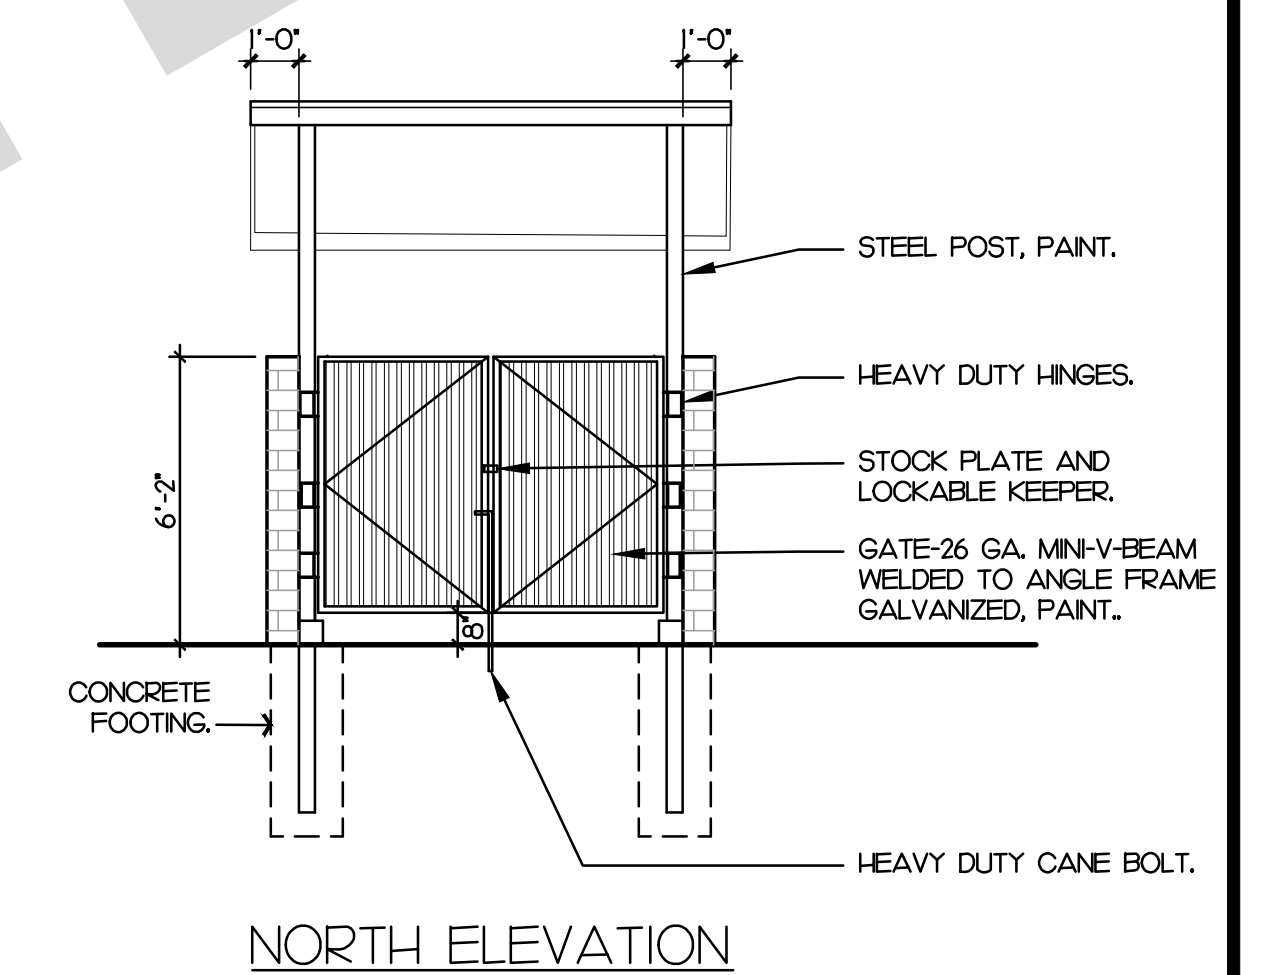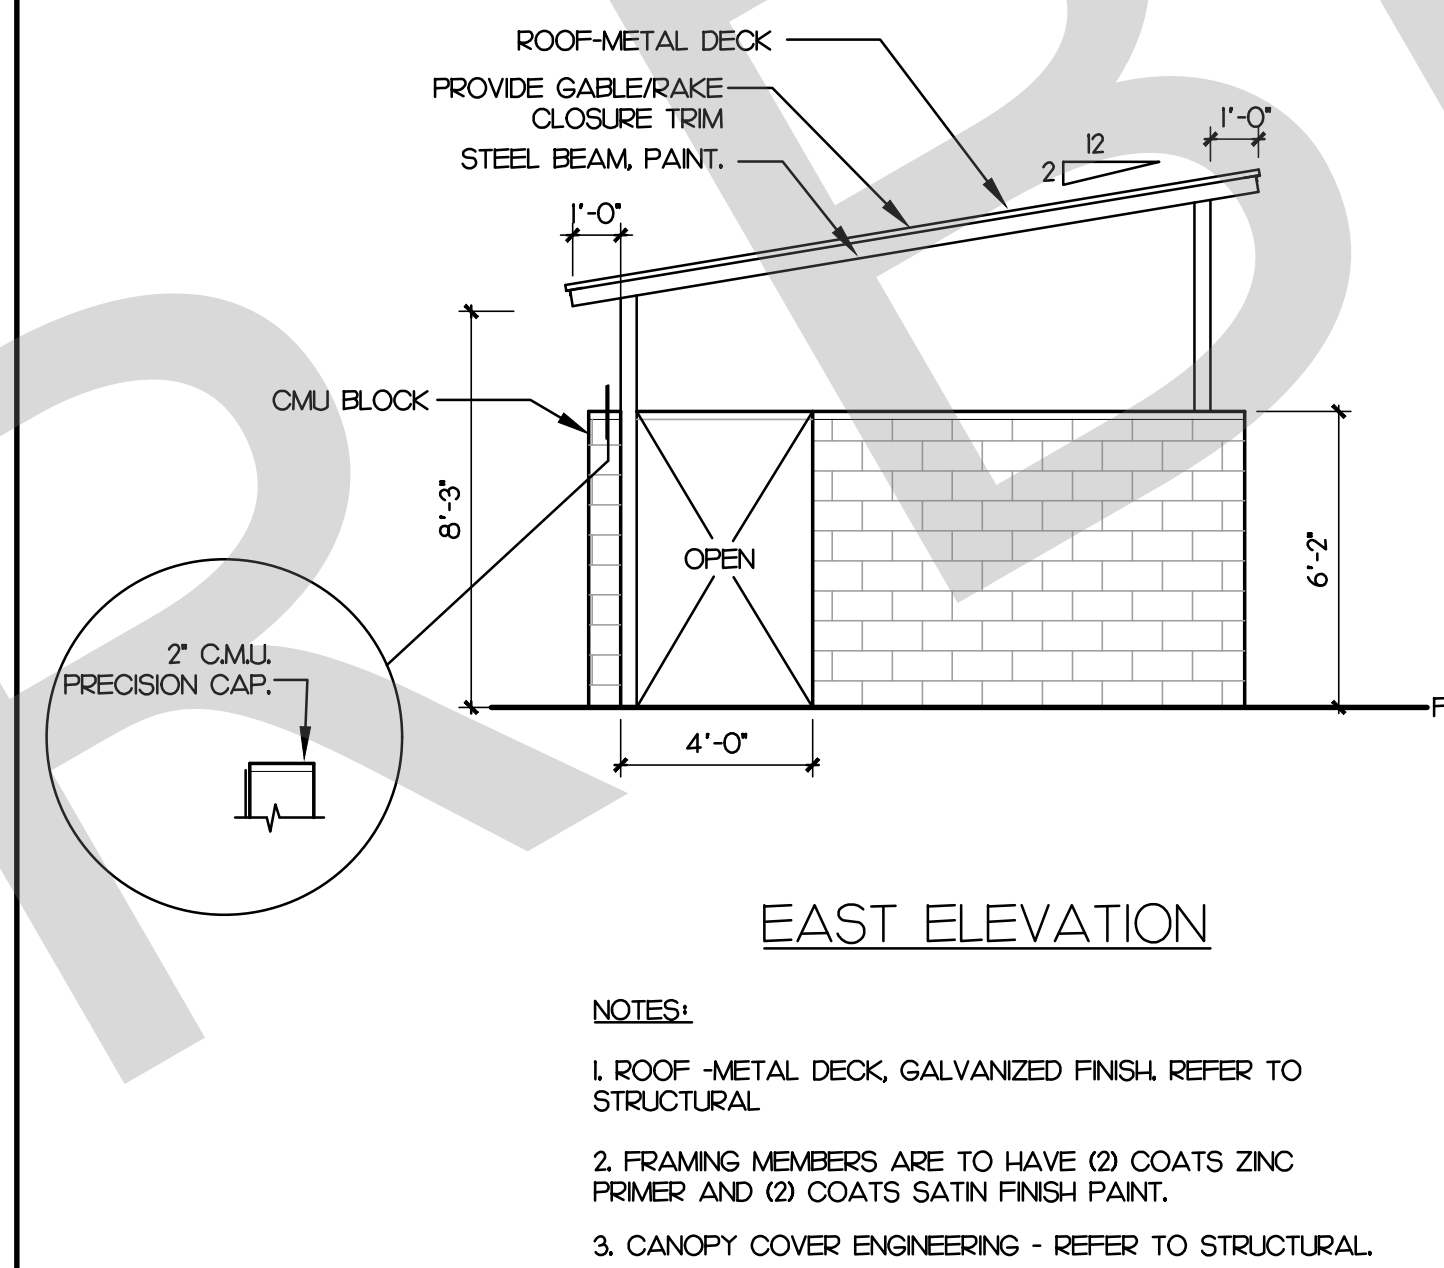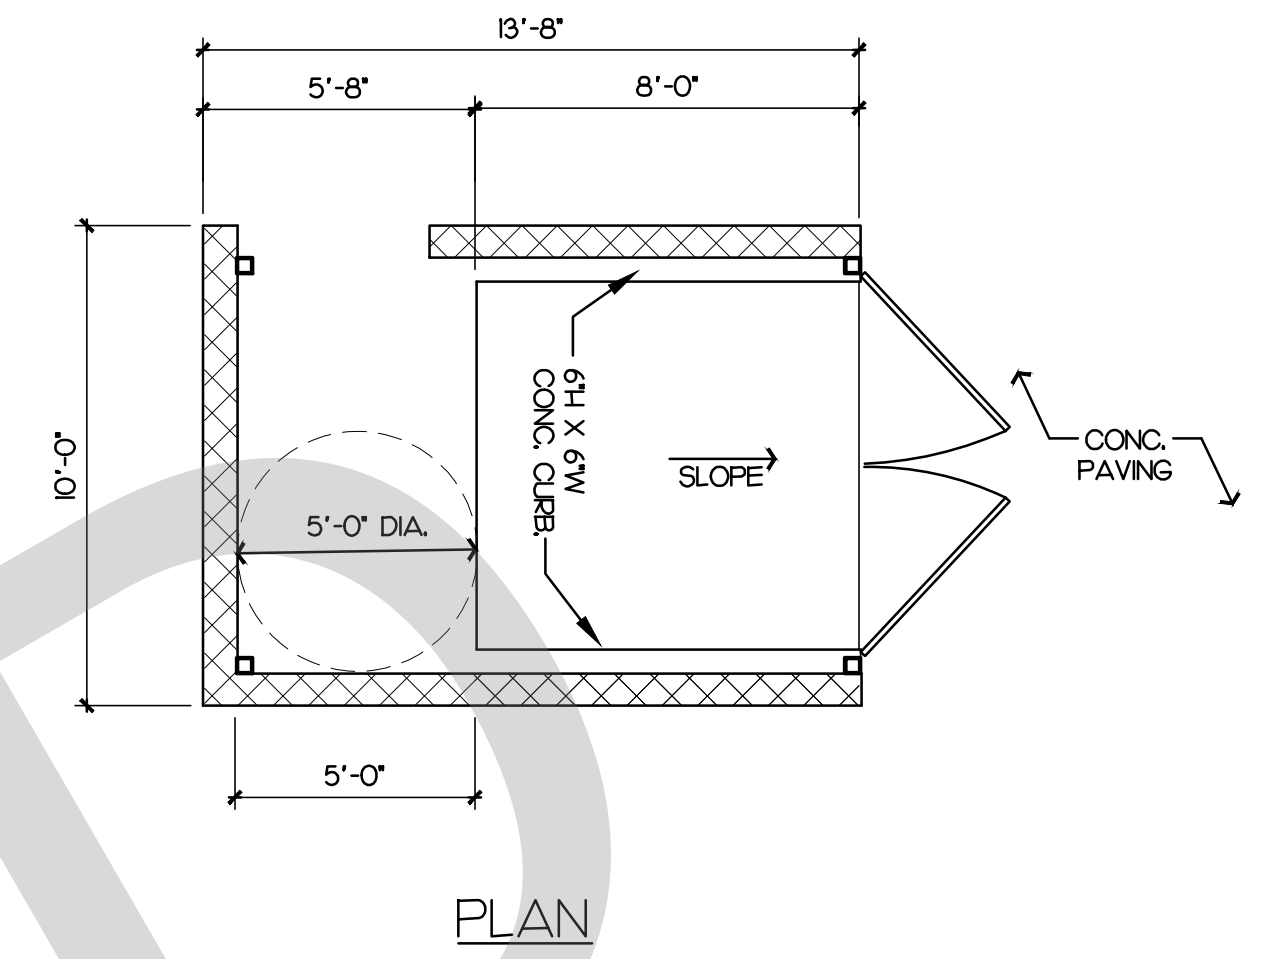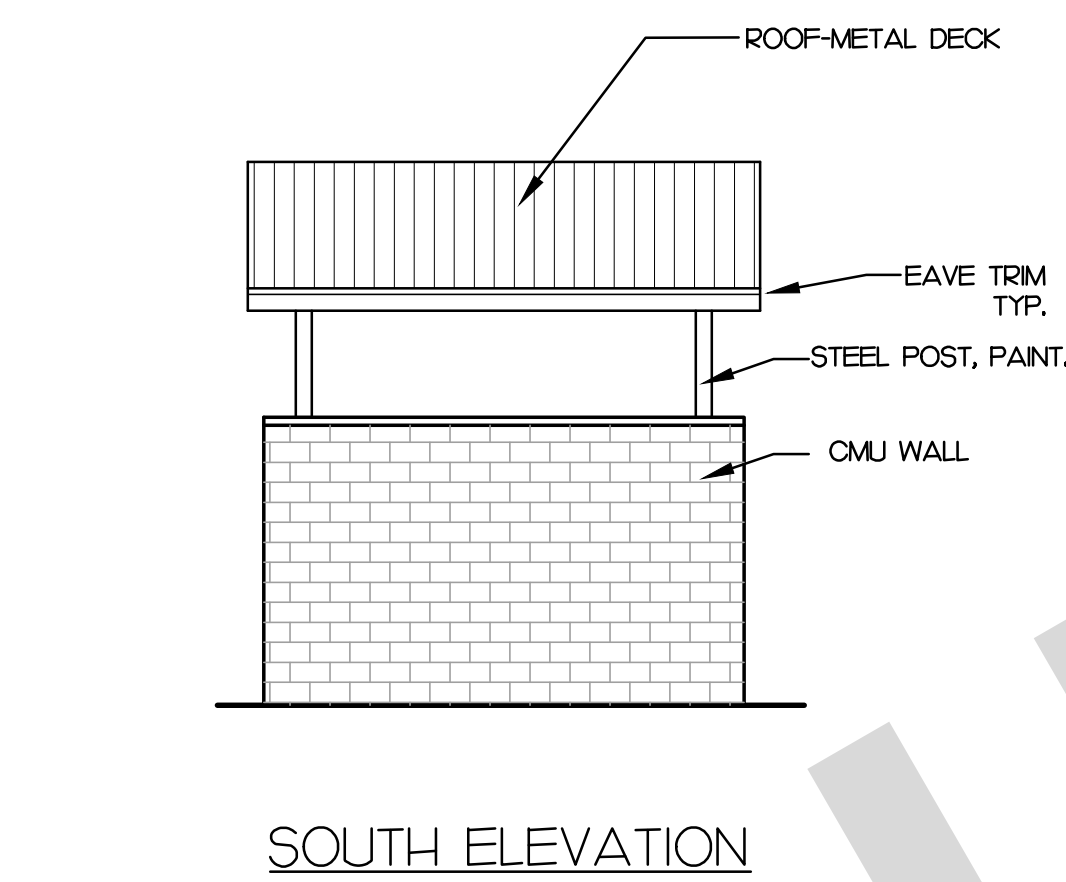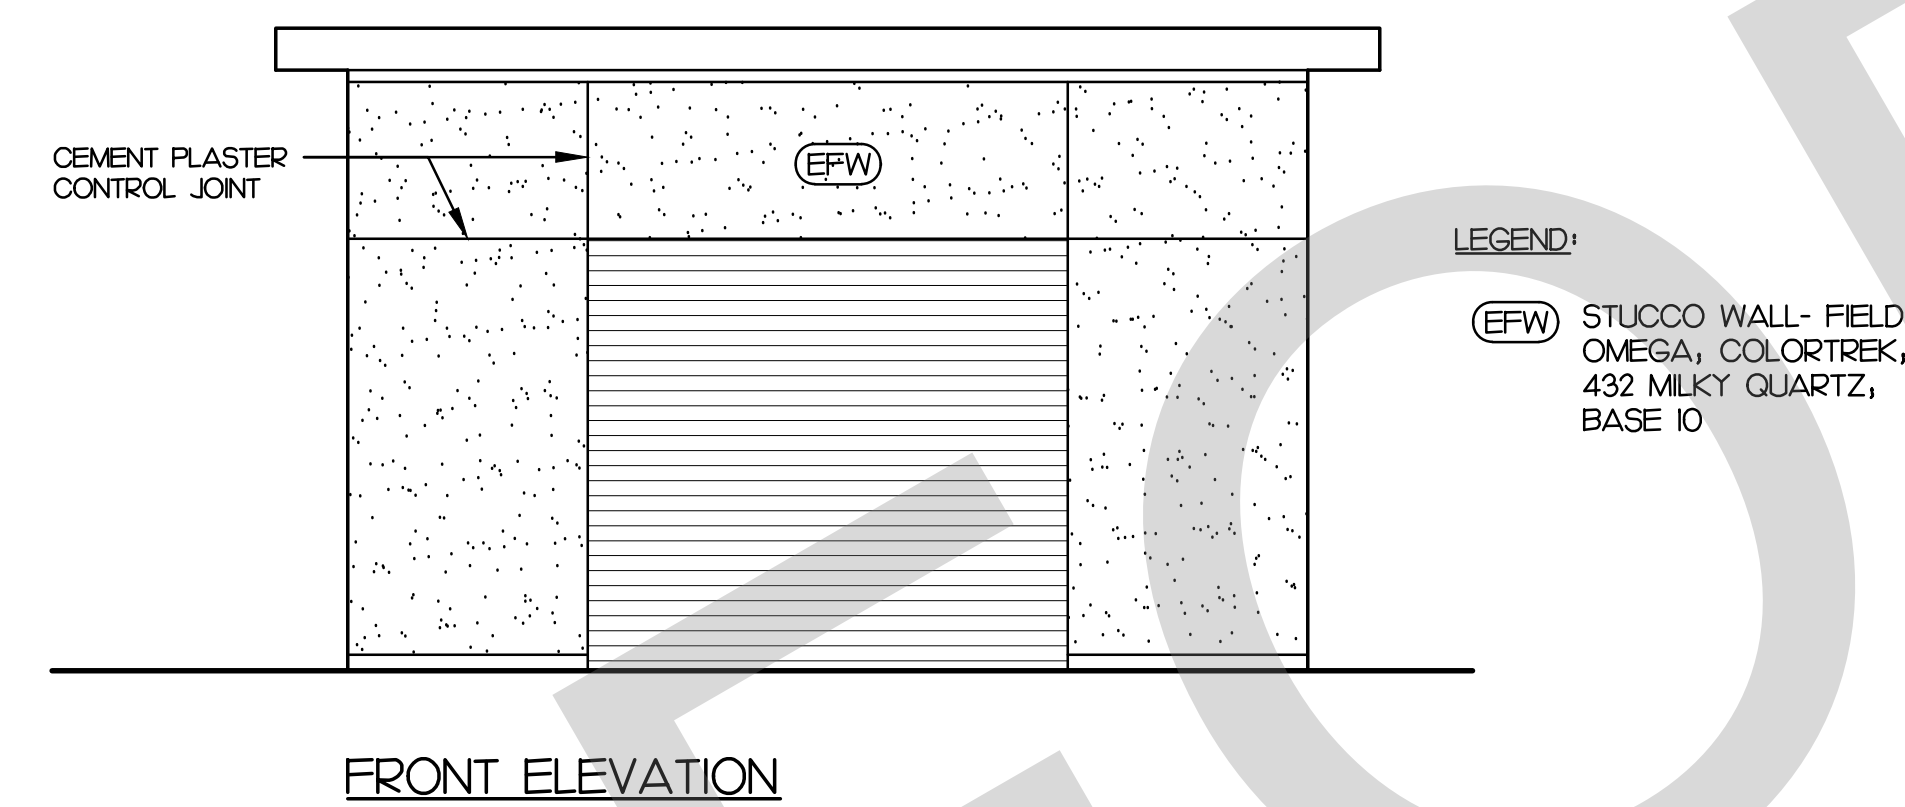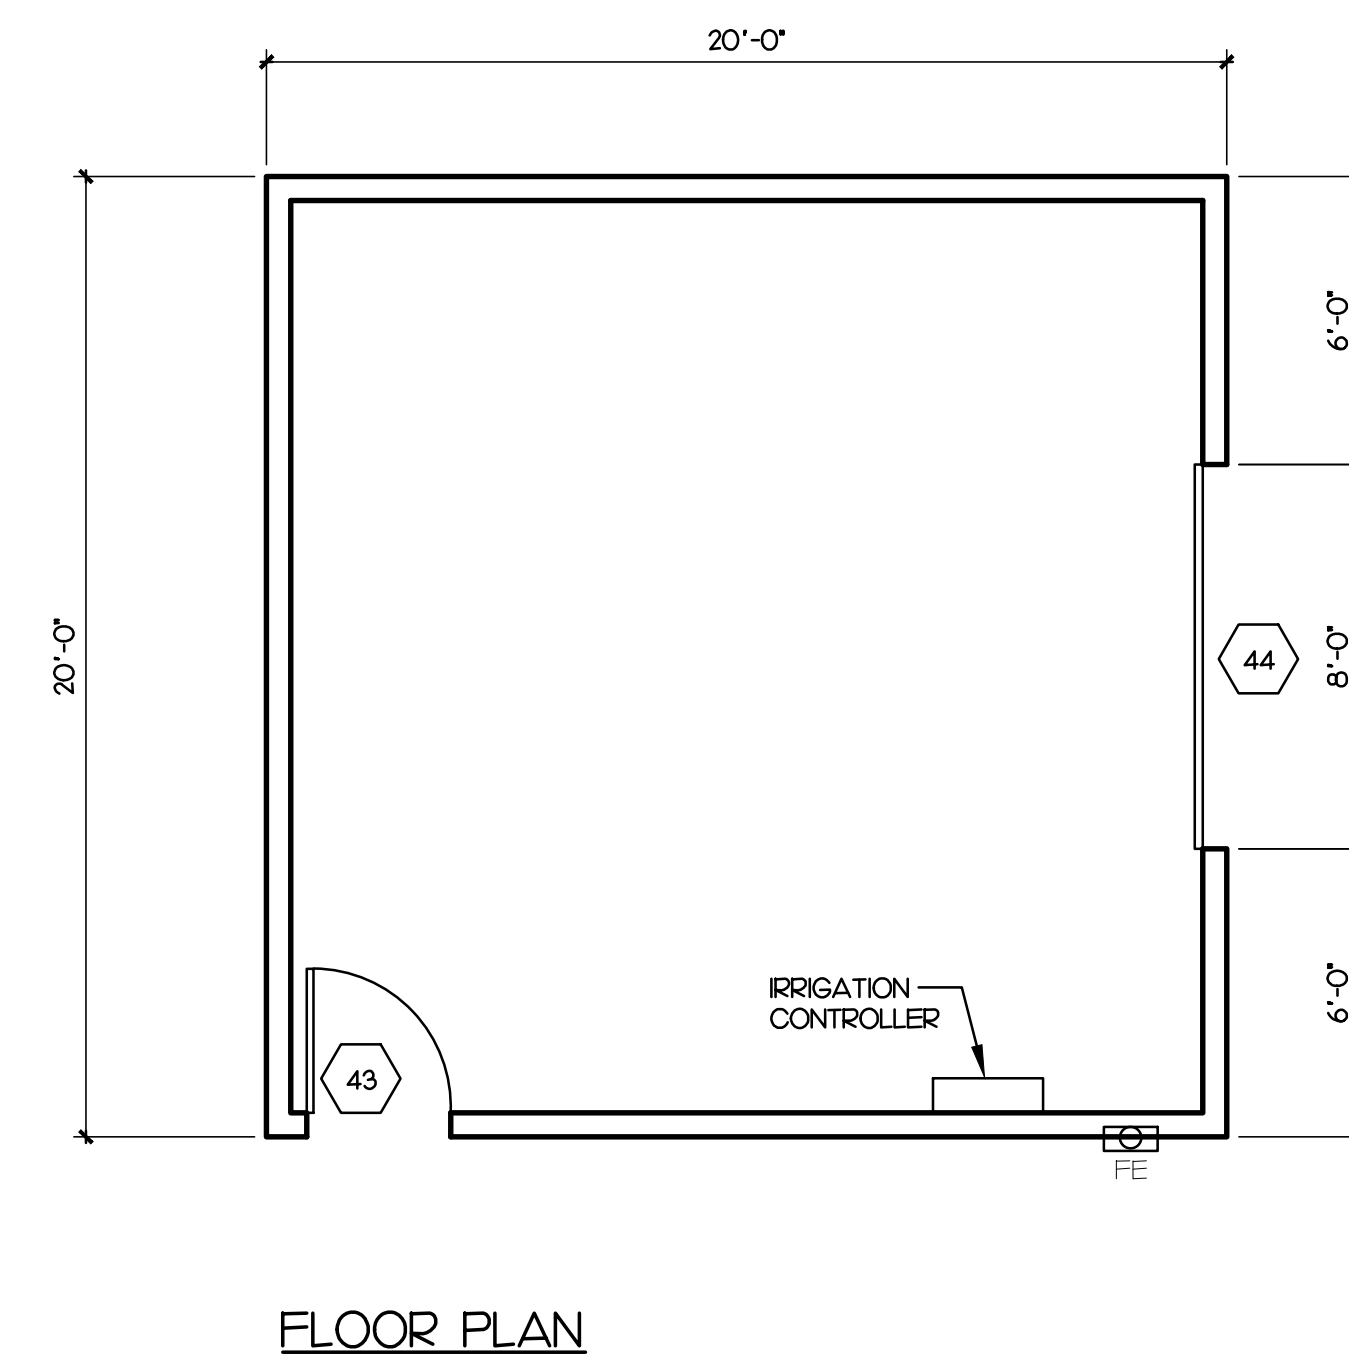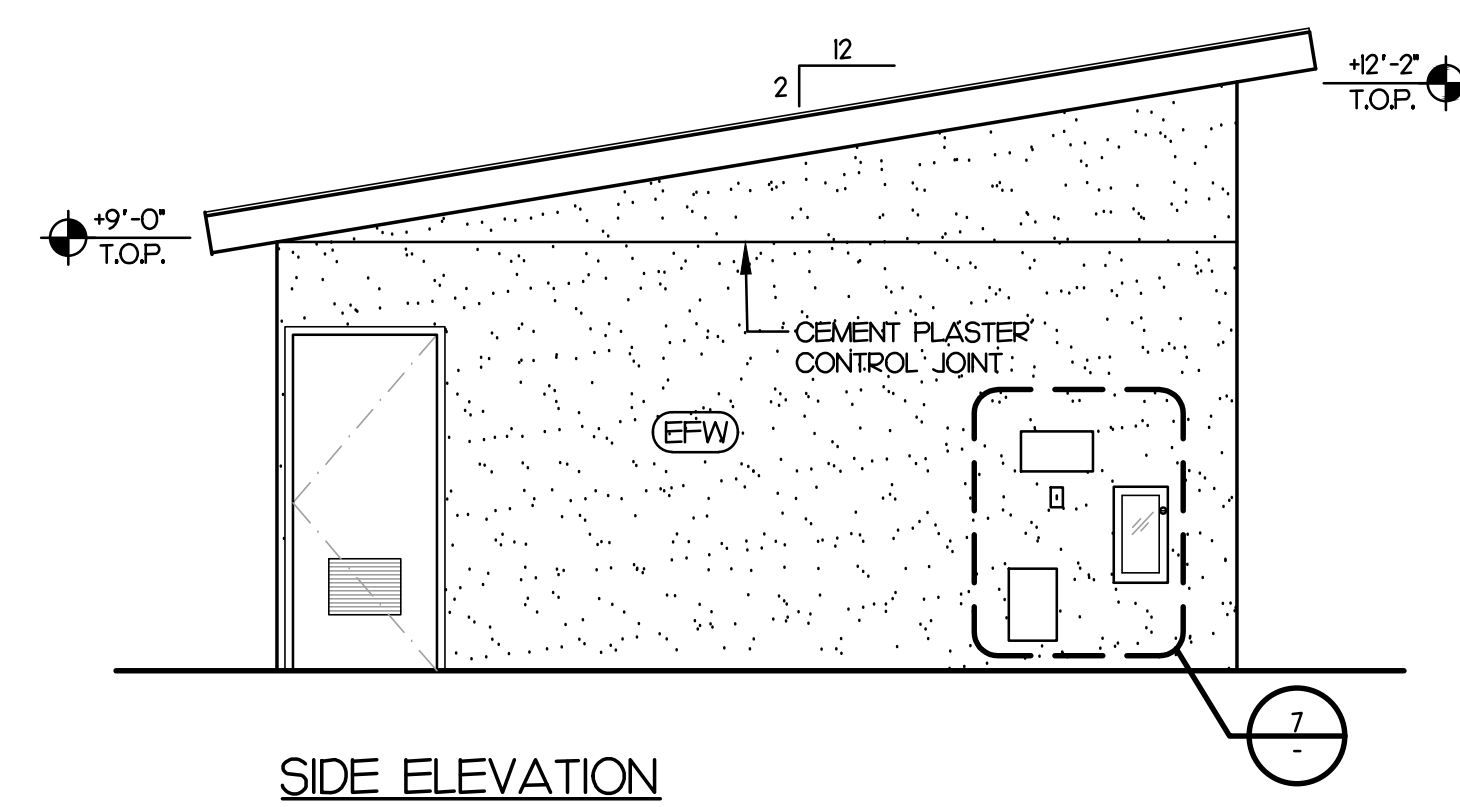


STORAGE BUILDING

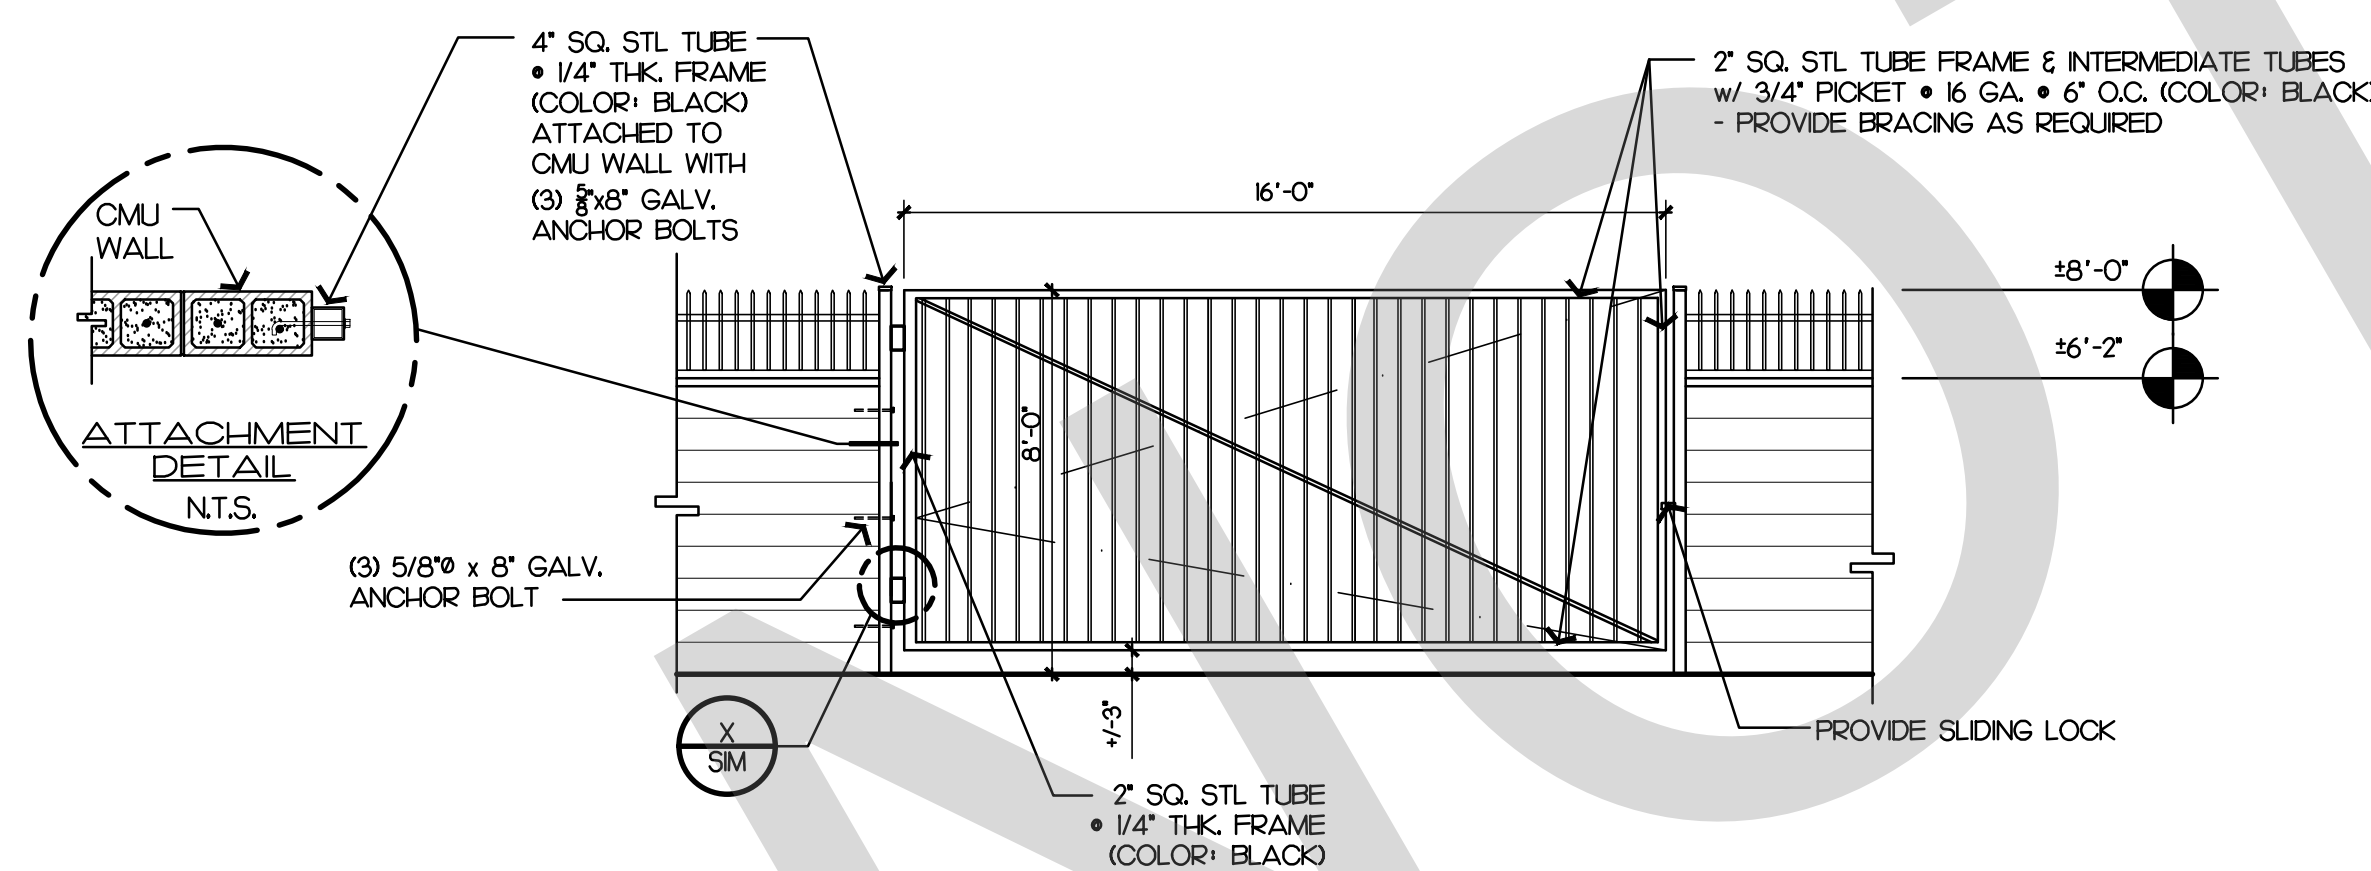


MANUAL SWINGING GATE

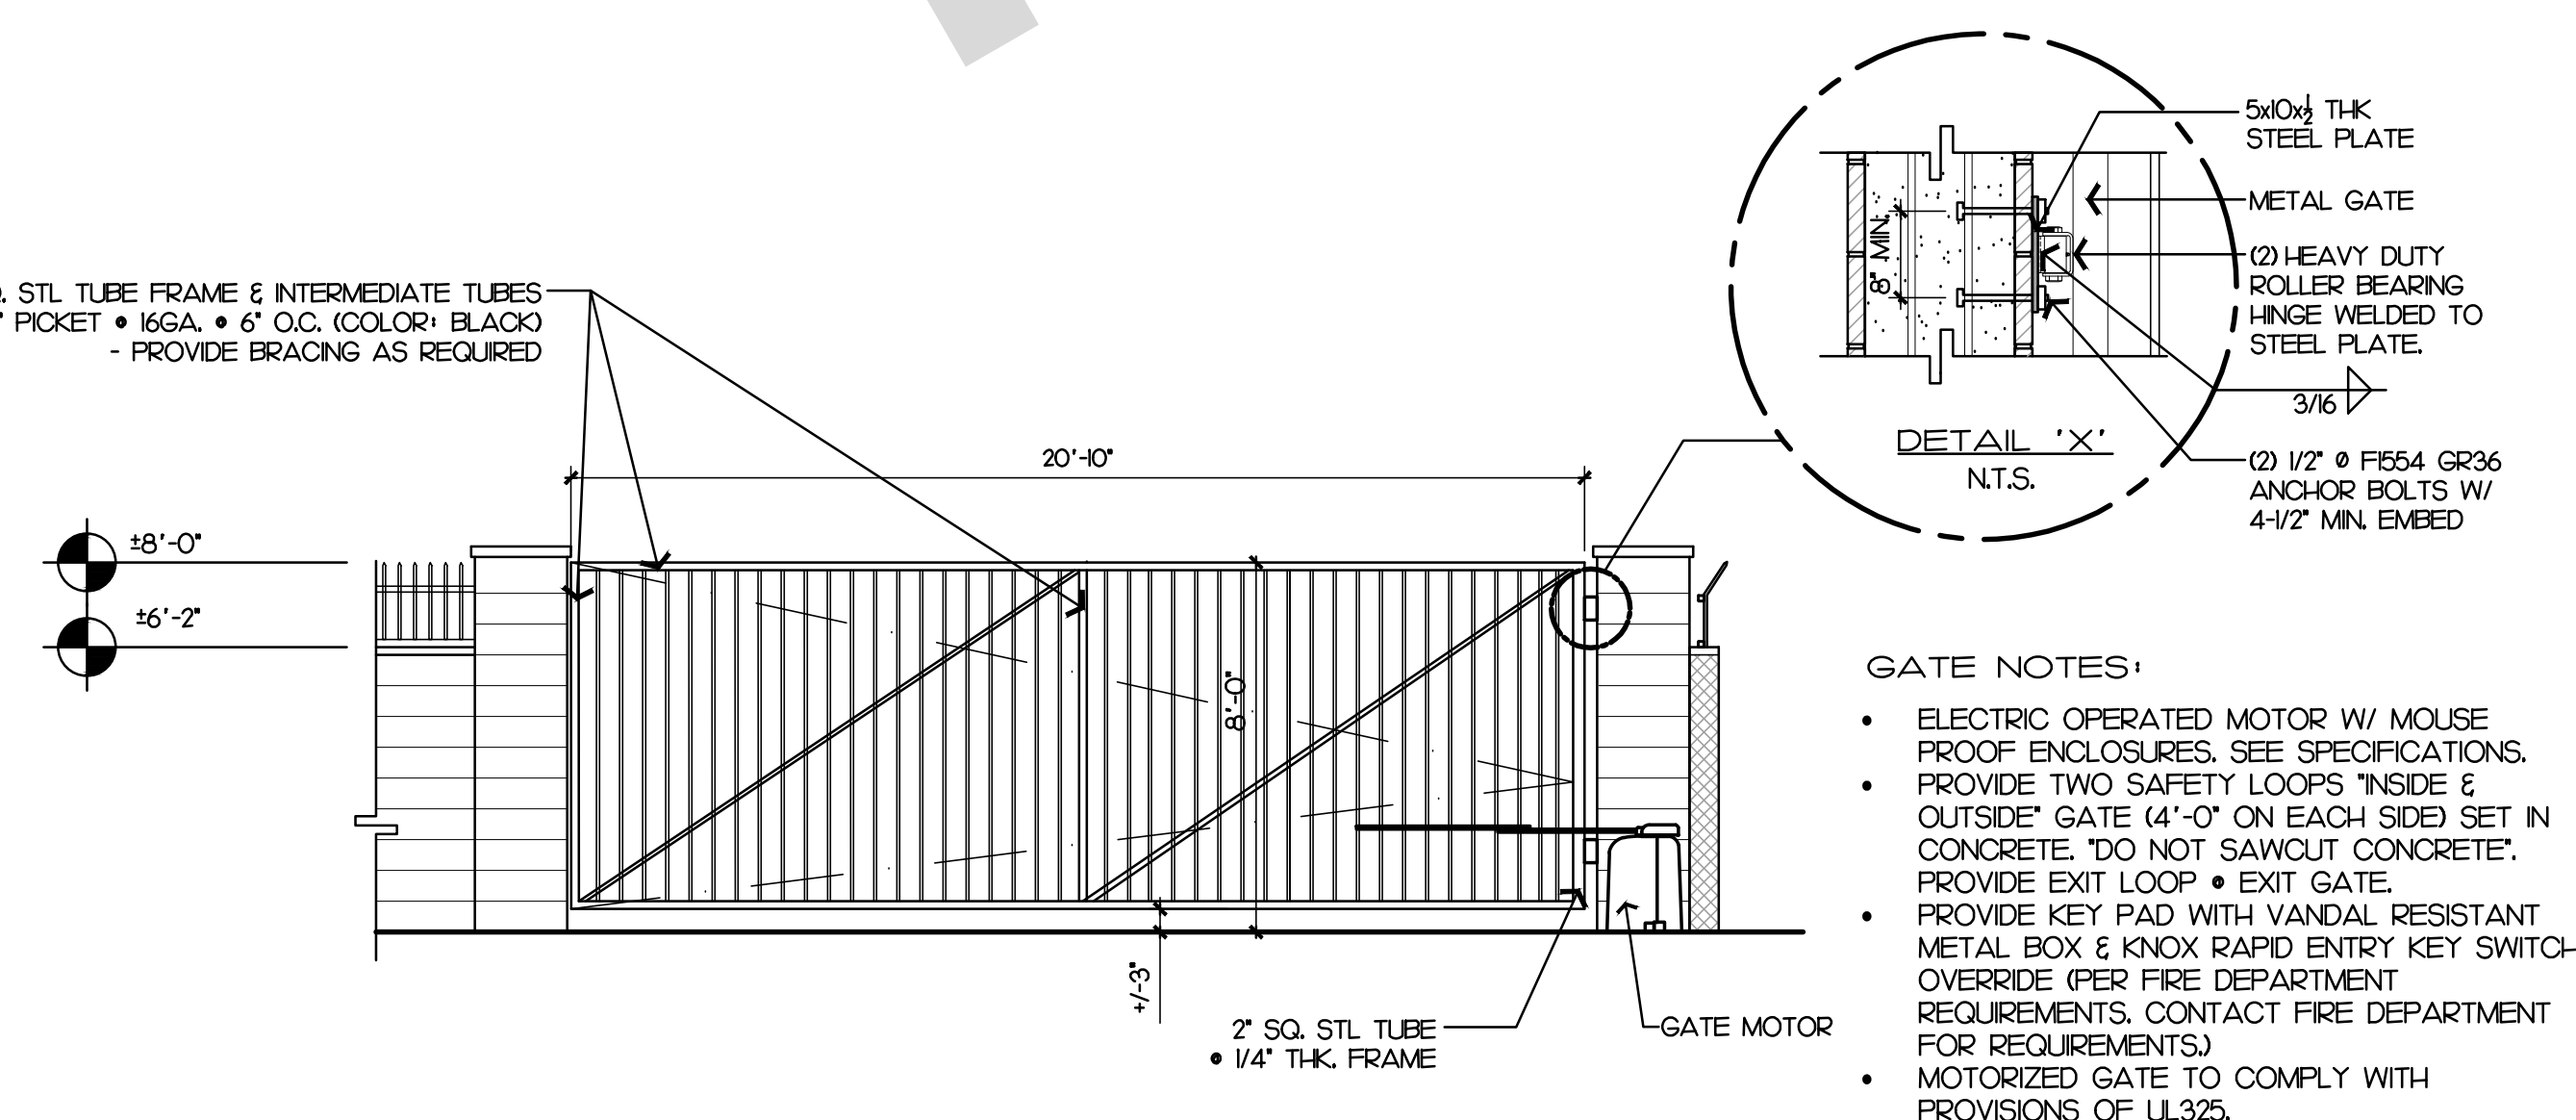

MOTORIZED SWINGING GATE

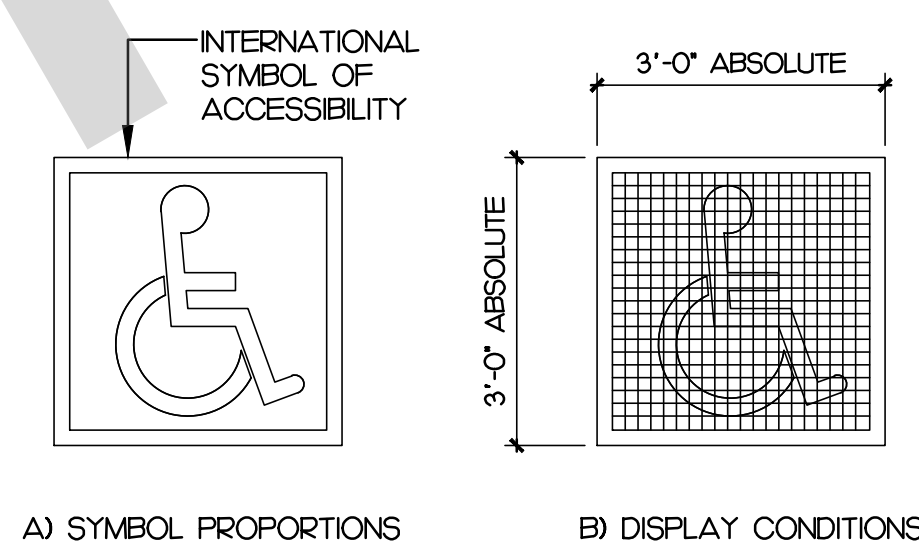


ADA SYMBOL

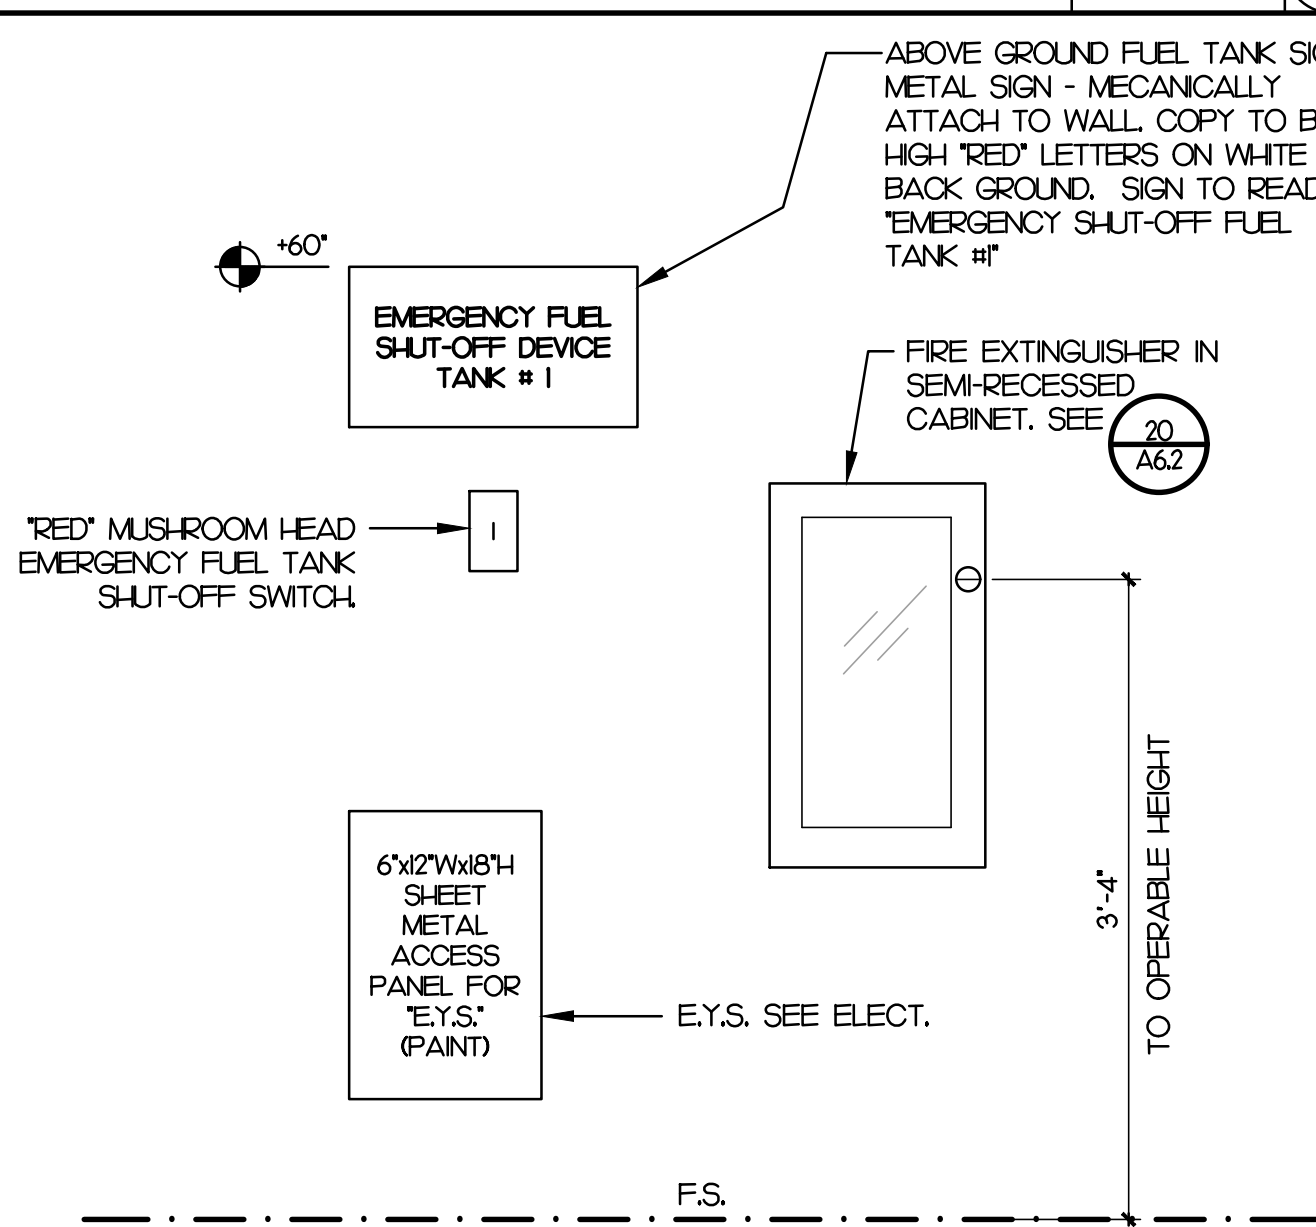


ENLARGED DETAIL



TRASH ENCLOSURE

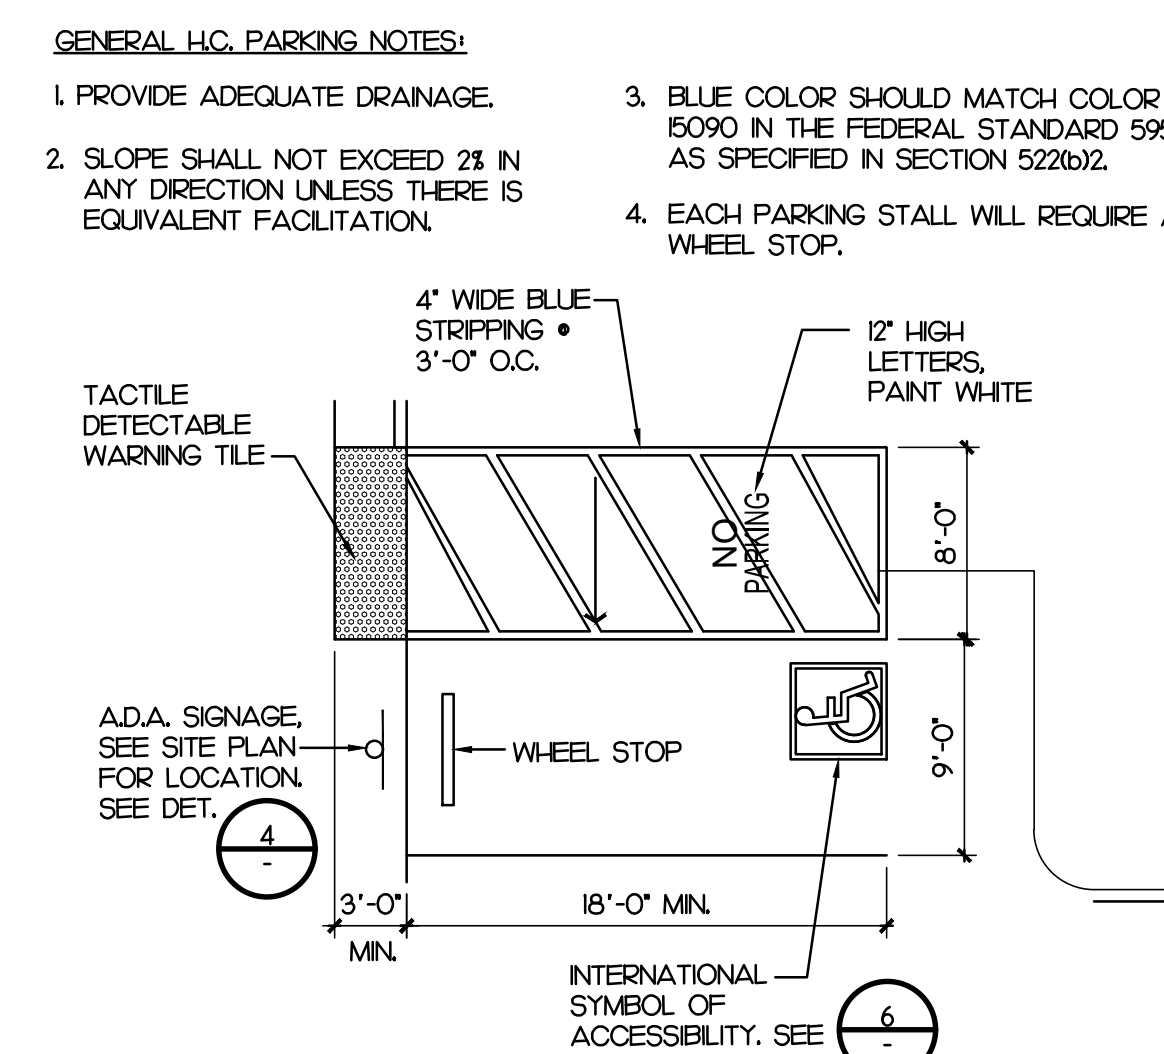

ADA PARKING

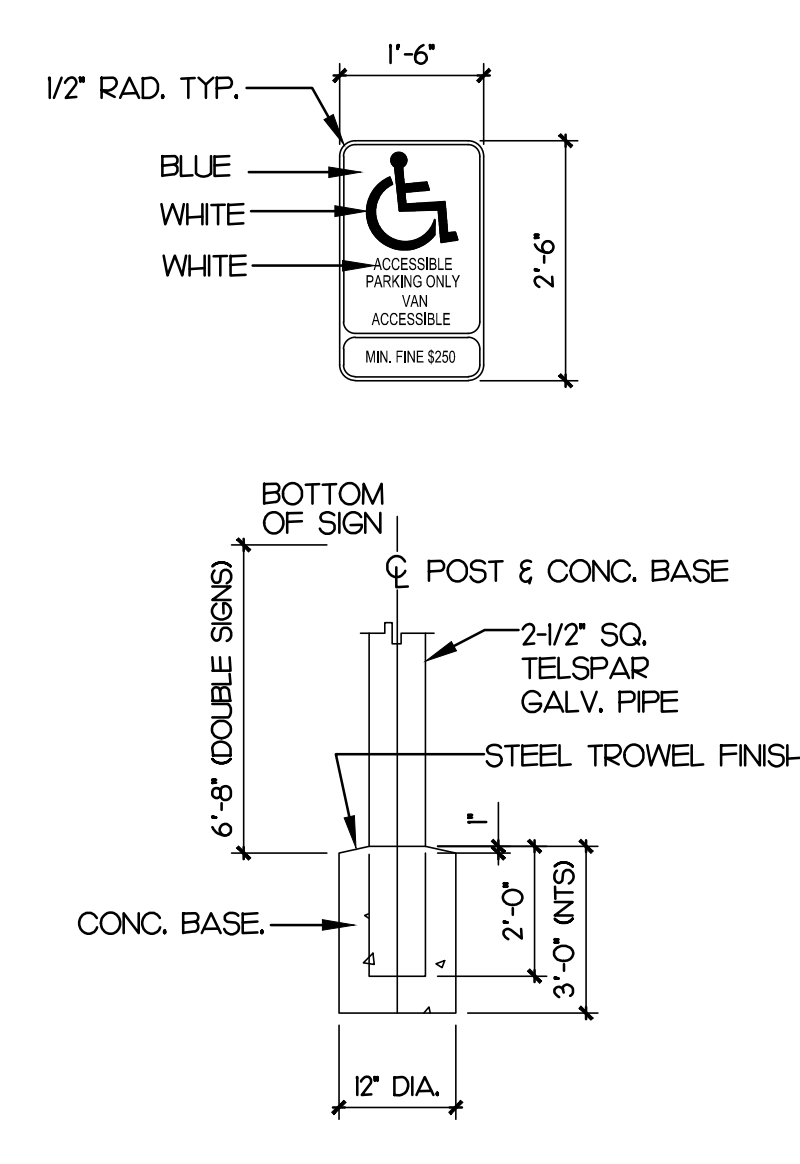

ADA PARKING SIGN

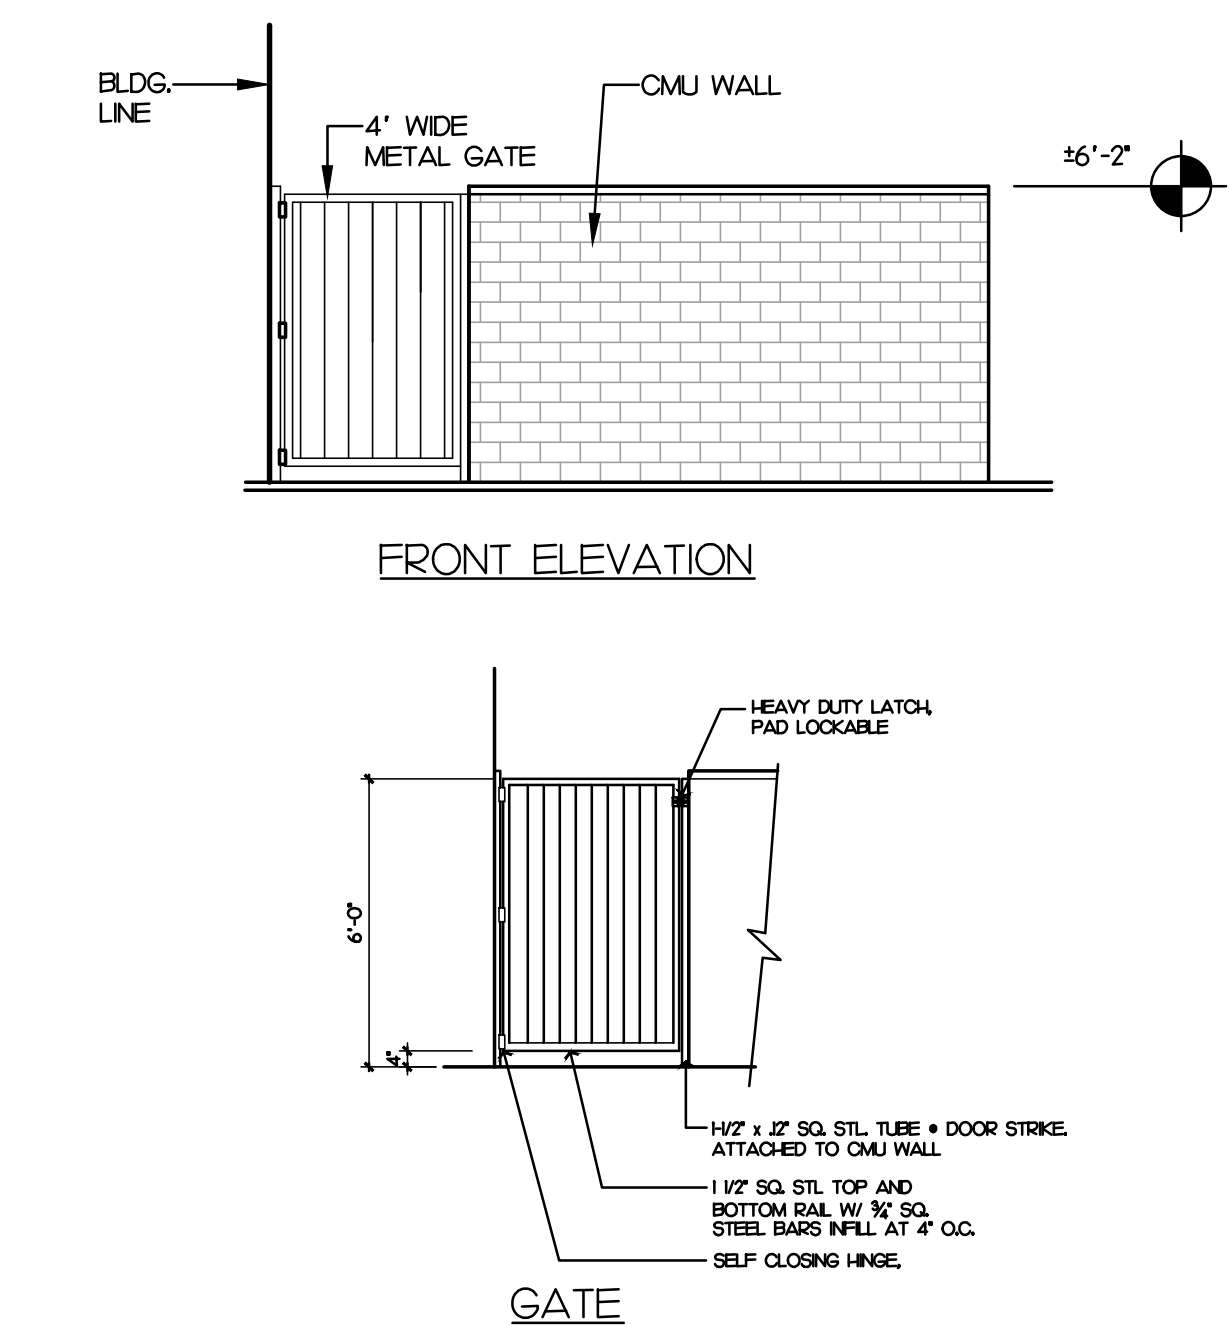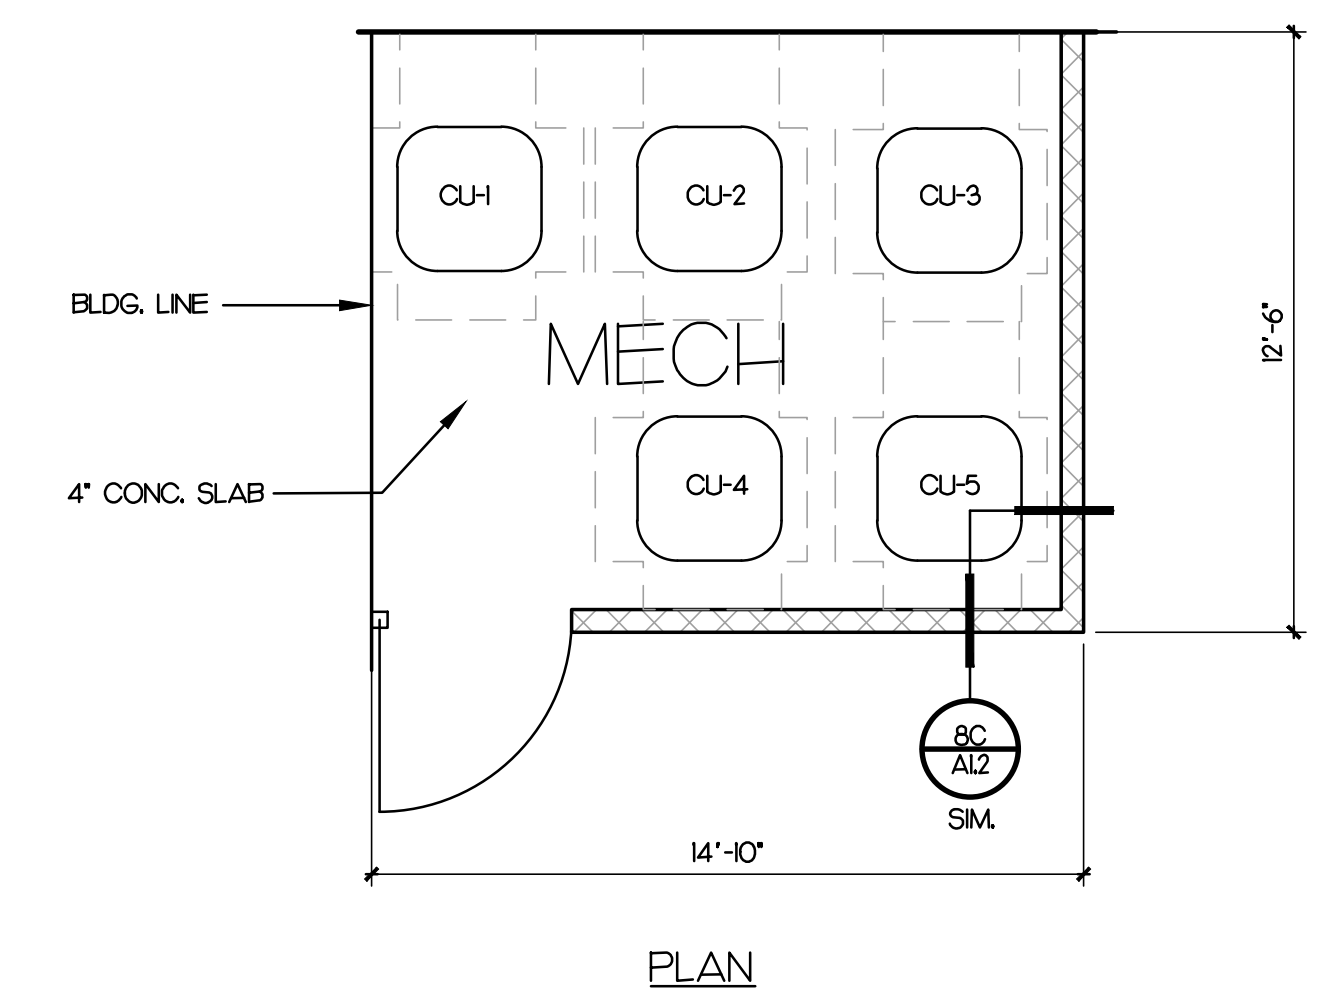

4 MECHANICAL ENCLOSURE



PROJECT ADMINISTERED BY:
SAN BERNARDINO COUNTY
PROJECT & FACILITIES
MANAGEMENT DEPARTMENT

385 N. ARROWHEAD AVE.
SAN BERNARDINO, CA 92415

PROJECT NAME:
SAN BERNARDINO
COUNTY FIRE
DEPARTMENT:
FIRE STATION 226

PROJECT # 10.10.1032

CIP #21-037

AFM # SABI98

N # 0273-011-22

20 DEL ROSA AVE N.
SAN BERNARDINO,
CA 92404

SUE INFORMATION:	
DATE:	INFORMATION:
4-11-2022	20% CD SET
4-28-2022	50% CD SET
6-15-2022	95% CD SET
9-16-2022	95% CD- 3rd BAY
-03-2022	PLAN CHECK

SHEET INFORMATION:

TK PROJECT NO.: 374-154-21

SCALE: AS NOTED
DATE: JANUARY 2021

LOT DATE: -

DRAWING NAME: _____

FAI :




SHEET TITLE:

SITE DETAILS

SHEET NO.: _____

A1.3

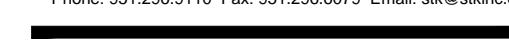

PROJECT ADMINISTERED BY:
SAN BERNARDINO COUNTY
PROJECT & FACILITIES
MANAGEMENT DEPARTMENT

PROJECT NAME:

PROJECT # 10.10.1032

CP #21-037

CAFM # SABI98

APN #: 0273-011-22

ISSUE INFORMATION:

SHEET INFORMATION

STK PROJECT NO.: 374-154-

SCALE: AS NOTED
DATE: 11/11/84 22

PLOT DATE:


DRAWING NAME:

SEAL:



SHEET NO.:

A1.4

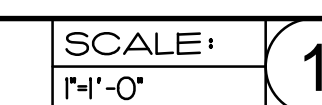


RETAINING WALL @ PROPERTY LINE CONDITION



NOT
USED


J:\174 SAN BERNARDINO\174-184-21-1800 Fire Station No. 226\Architectural\1.5 - CAR PARK CANOPY DETAILS.dwg
15/03/2022 11:30AM

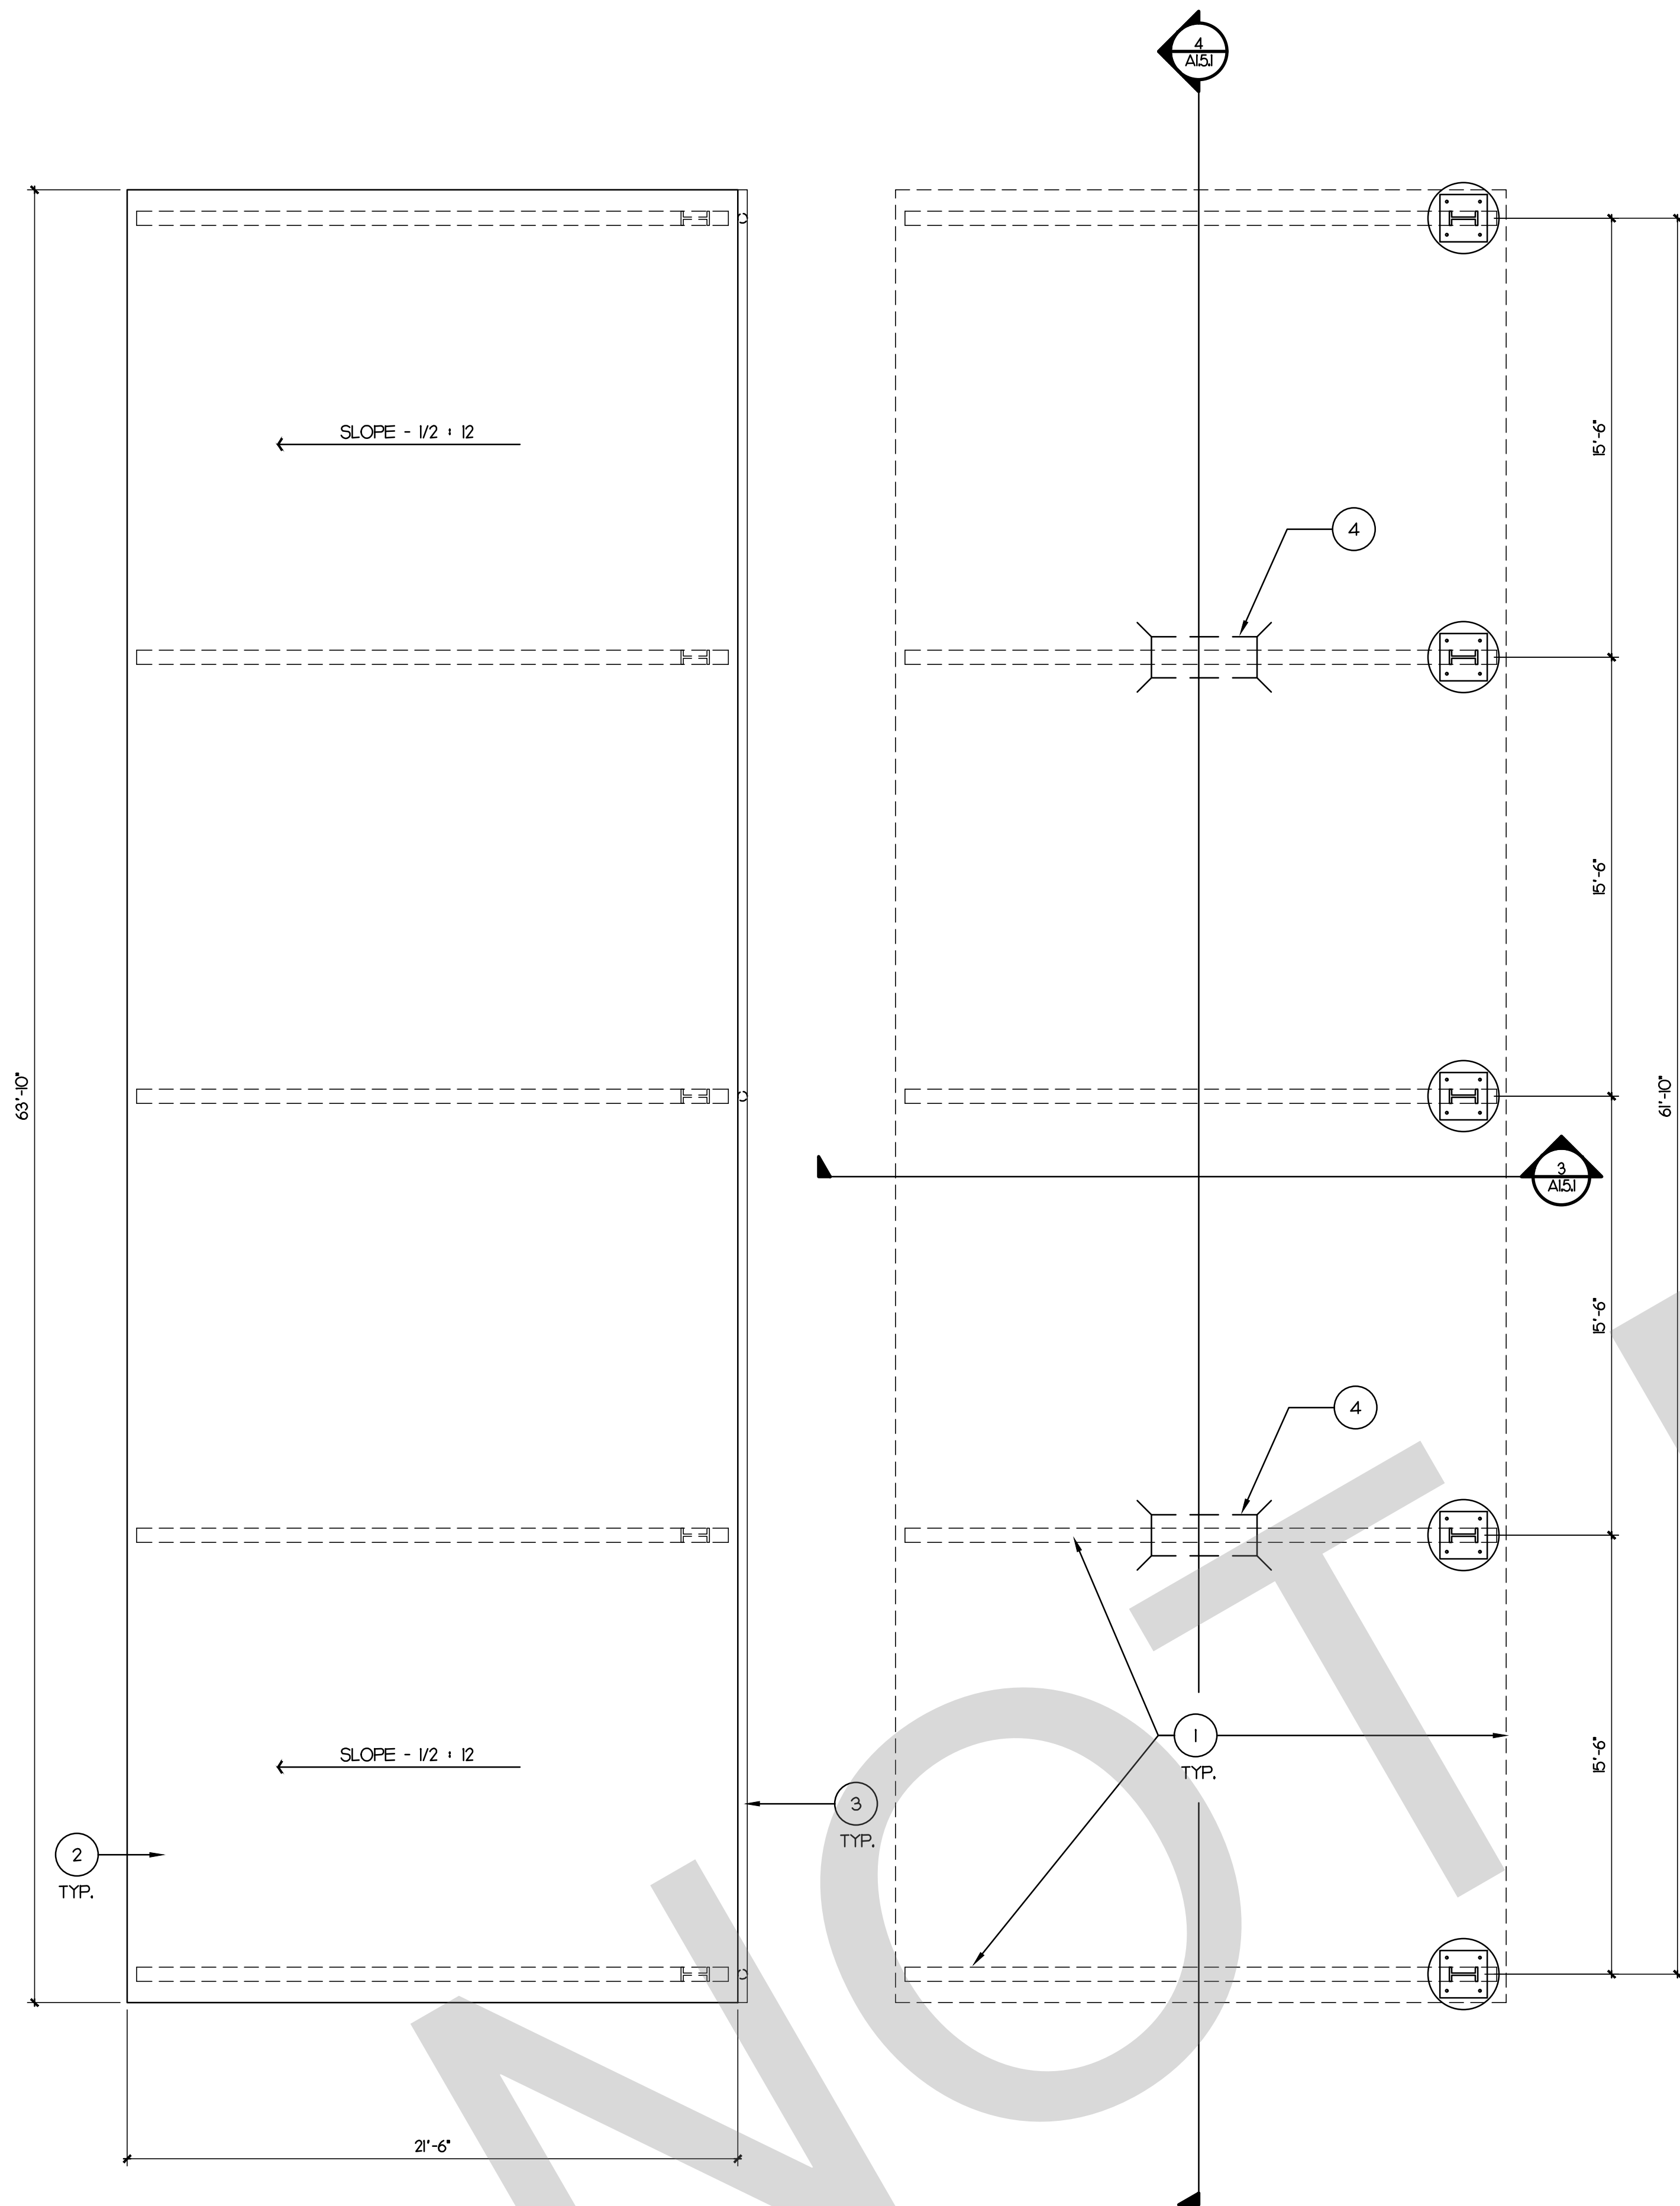

ROOF PLAN

FLOOR PLAN


NOTES:
THE DRAWING & NOTES SHOWN ON THIS SHEET IS FOR INFORMATION & BIDDING PURPOSE ONLY. FINAL DESIGN & ENGINEERING/SHOP DRAWING SHALL BE PROVIDED BY THE GENERAL CONTRACTOR, WET STAMPED BY A REGISTERED CALIFORNIA ENGINEER. SEE SECTION 13 3420 OF SPECIFICATIONS.

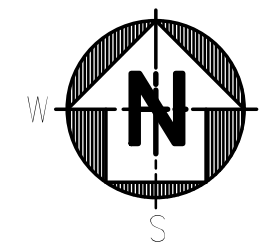

SCALE: 1/4"=1'-0"

2


SOUTH CANOPY

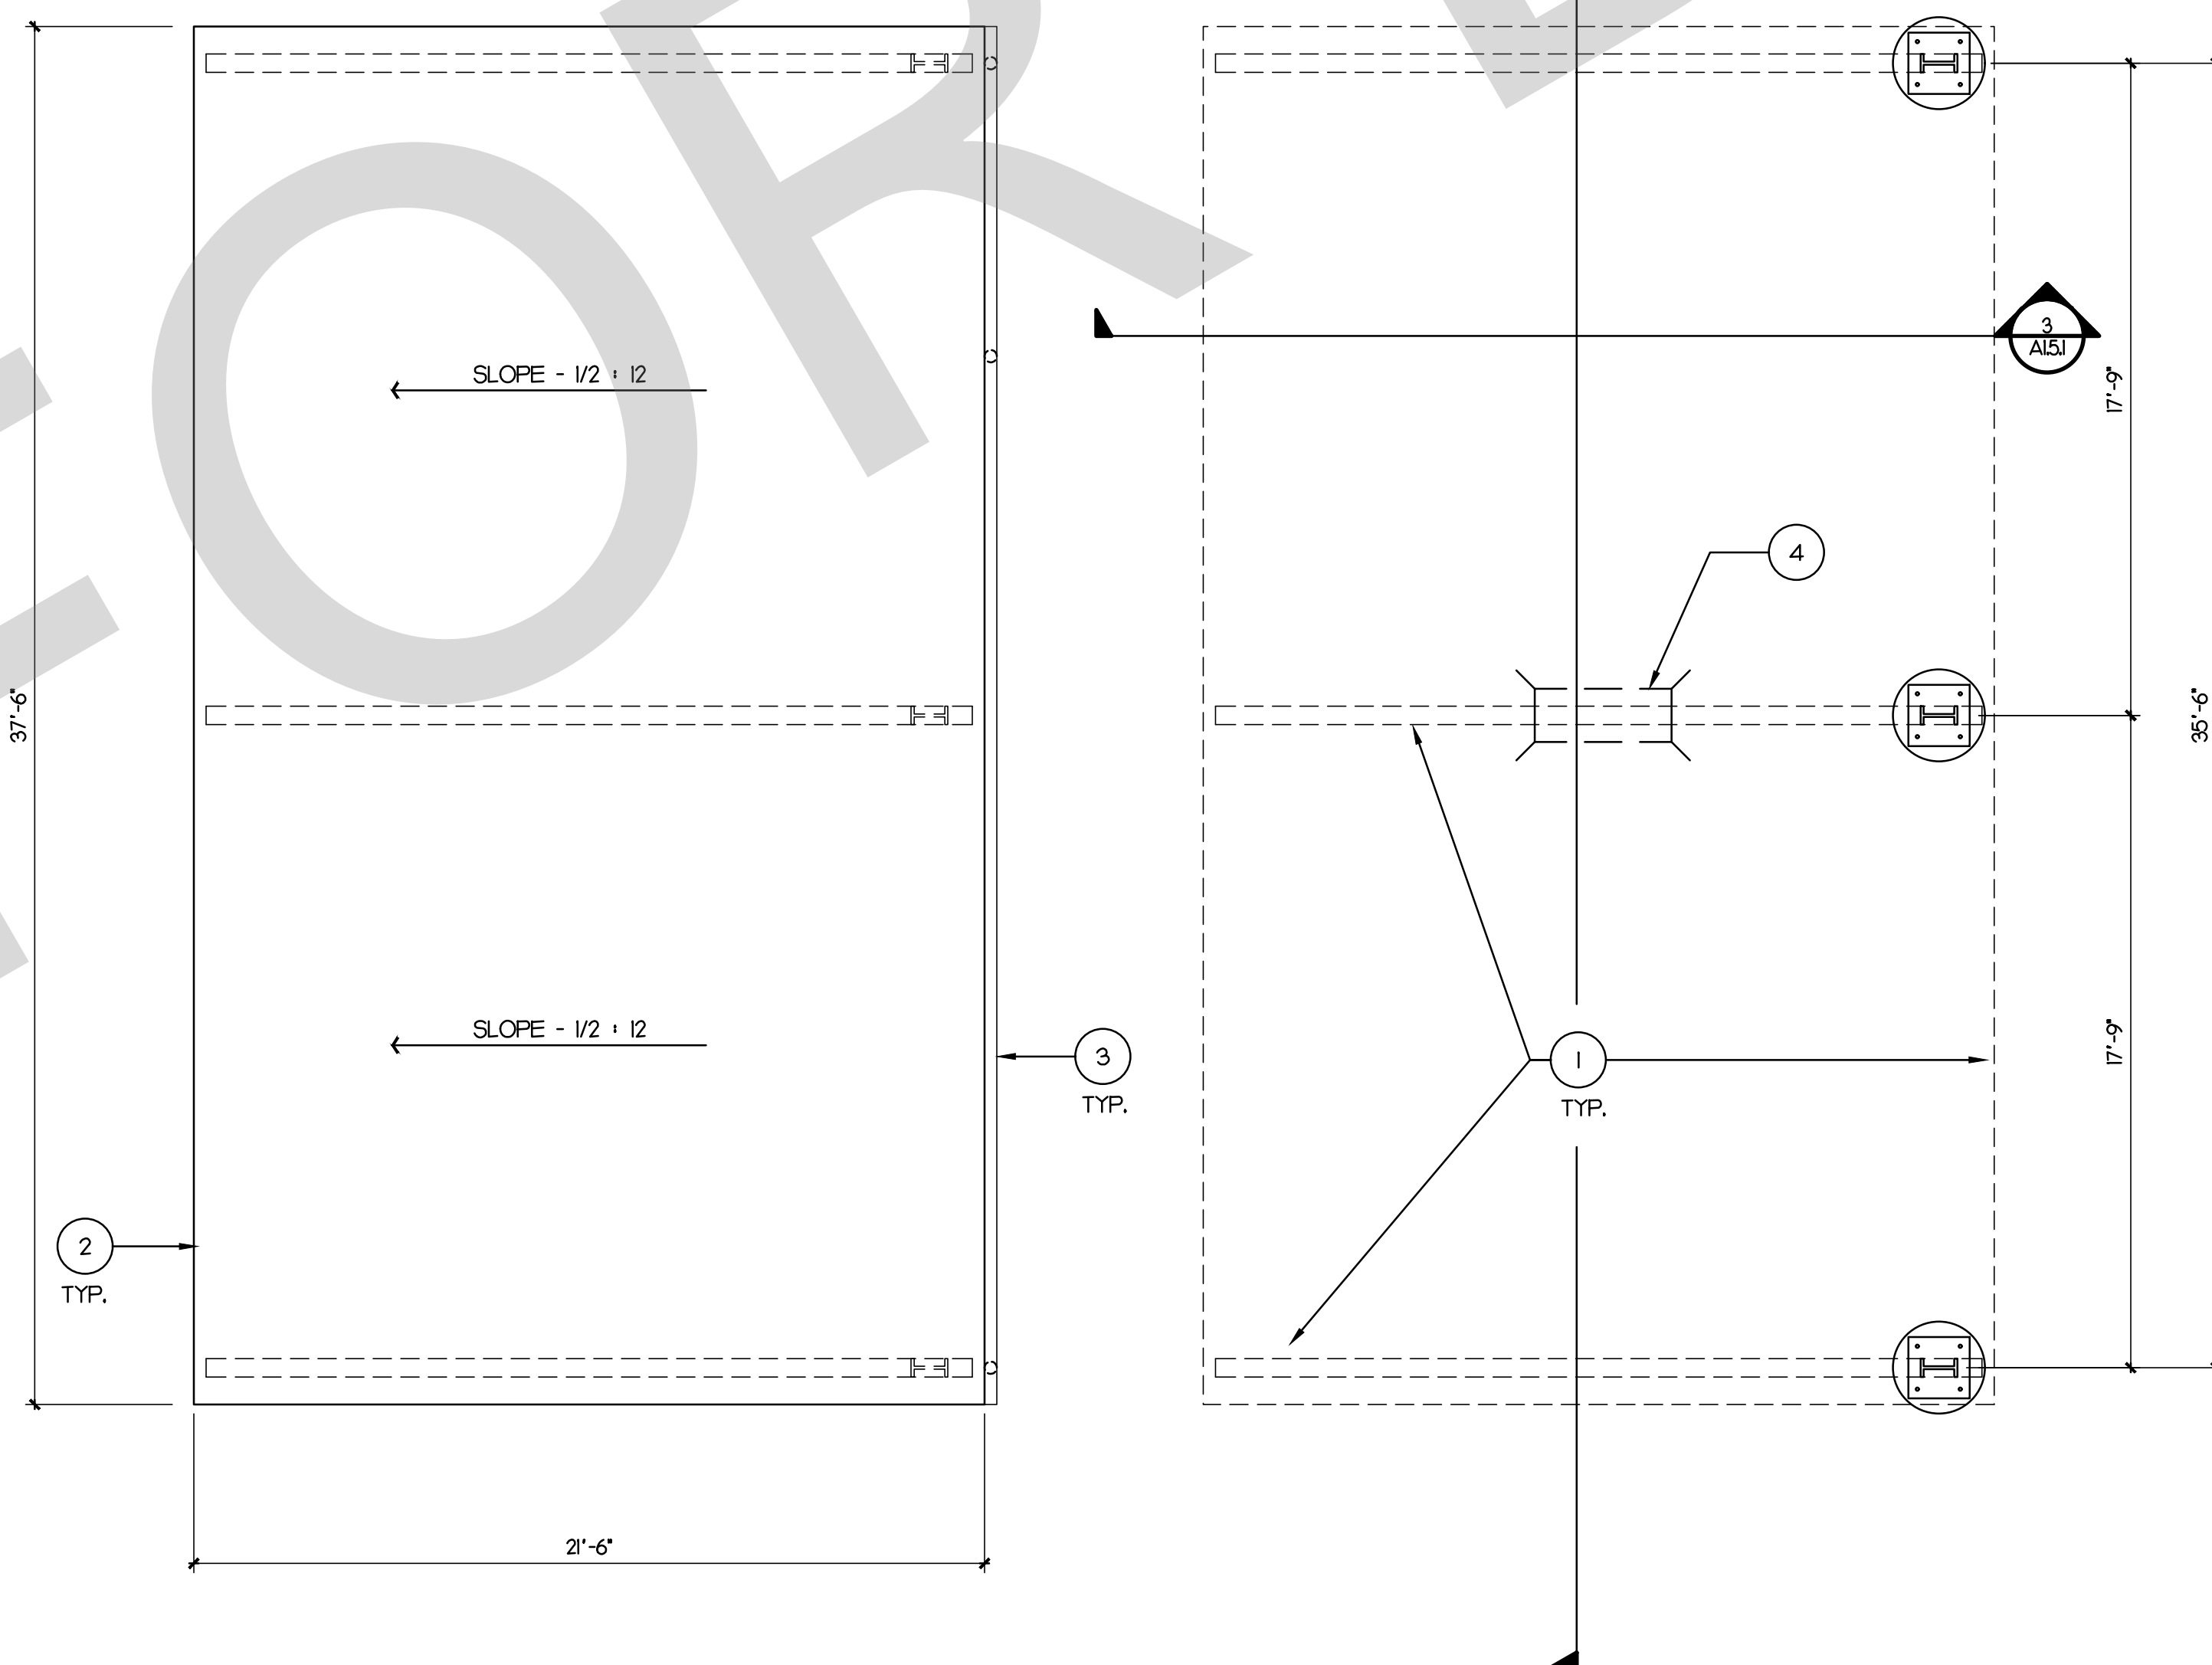

ROOF PLAN

FLOOR PLAN

NOTES:
THE DRAWING & NOTES SHOWN ON THIS SHEET IS FOR INFORMATION & BIDDING PURPOSE ONLY. FINAL DESIGN & ENGINEERING/SHOP DRAWING SHALL BE PROVIDED BY THE GENERAL CONTRACTOR, WET STAMPED BY A REGISTERED CALIFORNIA ENGINEER. SEE SECTION 13 3420 OF SPECIFICATIONS.

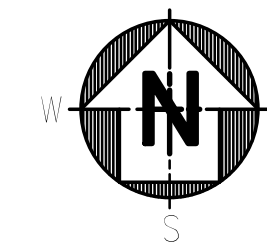

SCALE: 1/4"=1'-0"

1

KEY NOTE

1. PRE-FABRICATED METAL SHADE CANOPY & FOOTING/FOUNDATION WITH PRE-FINISHED METAL ROOF PANELS. SEE SPECIFICATIONS.
2. METAL ROOFING BY PRE-FAB BUILDING MANUFACTURE & PER SPECIFICATIONS.
3. GALVANIZED SHEET METAL GUTTER AND DOWNSPOUT (AT 3 LOCATIONS) BY PRE-FAB METAL BUILDING MANUFACTURER - PAINT, SURFACE DRAIN AWAY FROM STRUCTURE.
4. CAR CANOPY LIGHTING. SEE ELECTRICAL.

- A. THE DRAWING SHOWN HEREIN IS FOR REFERENCE ONLY. GENERAL CONTRACTOR SHALL ENGINEER & CONSTRUCT ALL FOUNDATIONS REQUIRED BY THE PRE-FABRICATED METAL BUILDING COMPANY. CONTRACTOR SHALL PROVIDE ENGINEERED & WET STAMPED SHOP DRAWINGS FOR BUILDING & FOUNDATIONS.
- B. THE STRUCTURAL COMPONENTS/SIZES SHOWN HEREIN ARE FOR REFERENCE ONLY. CONTRACTOR'S ENGINEER SHALL PROVIDE STRUCTURAL CALCULATIONS VERIFYING STRUCTURAL COMPONENT'S SIZING. SIZE MAY INCREASE OR DECREASE AT NO ADDED COST TO OWNER.
- C. ALL BAYS TO REMAIN CLEAR - TYP.
- D. NO "X" BRACING IS ALLOWED BETWEEN COLUMNS - TYP.
- E. DESIGN: PORTAL / MOMENT FRAMES ONLY - TYP.
- F. SPECIFICATIONS ARE UNDER SEPARATE COVER AND ARE PART OF THE BID DOCUMENTS.
- G. GENERAL CONTRACTOR TO PROVIDE STAMPED, SIGNED, ENGINEERED SHOP DRAWINGS AS PART OF THE CONTRACT.
- H. GENERAL CONTRACTOR TO SUBMIT ALL REQUIRED PLANS & DOCUMENTS THROUGH THE COUNTY LAND USE SERVICES AND IS A "DEFERRED APPROVAL" WITH APPROXIMATE FOUR (4) WEEK LEAD TIME.
- J. GENERAL CONTRACTOR TO FIELD VERIFY ALL SITE EXISTING SITE UTILITIES, INCLUDING UNDERGROUND ELEMENTS, PRIOR TO PLACING BUILDING FOUNDATION.



PROJECT ADMINISTERED BY:
SAN BERNARDINO COUNTY
PROJECT & FACILITIES
MANAGEMENT DEPARTMENT

385 N. ARROWHEAD AVE.
SAN BERNARDINO, CA 92415

PROJECT NAME:
SAN BERNARDINO
COUNTY FIRE
DEPARTMENT:
FIRE STATION 226

PROJECT # 10J0J032
CIP #21-037
CAFM # SAB198
APN # 0273-011-22

1920 DEL ROSA AVE N.
SAN BERNARDINO,
CA 92404


ISSUE INFORMATION:	
DATE:	INFORMATION:
04-11-2022	20% CD SET
04-28-2022	50% CD SET
06-15-2022	95% CD SET
09-16-2022	95% CD- 3rd BAY
10-03-2022	PLAN CHECK

SHEET INFORMATION:
STK PROJECT NO.: 374-154-21
SCALE: AS NOTED
DATE: JANUARY 2021
PLOT DATE:
DRAWING NAME:



SHEET TITLE:
CAR PARK
CANOPY
PLANS

SHEET NO.:
A1.5

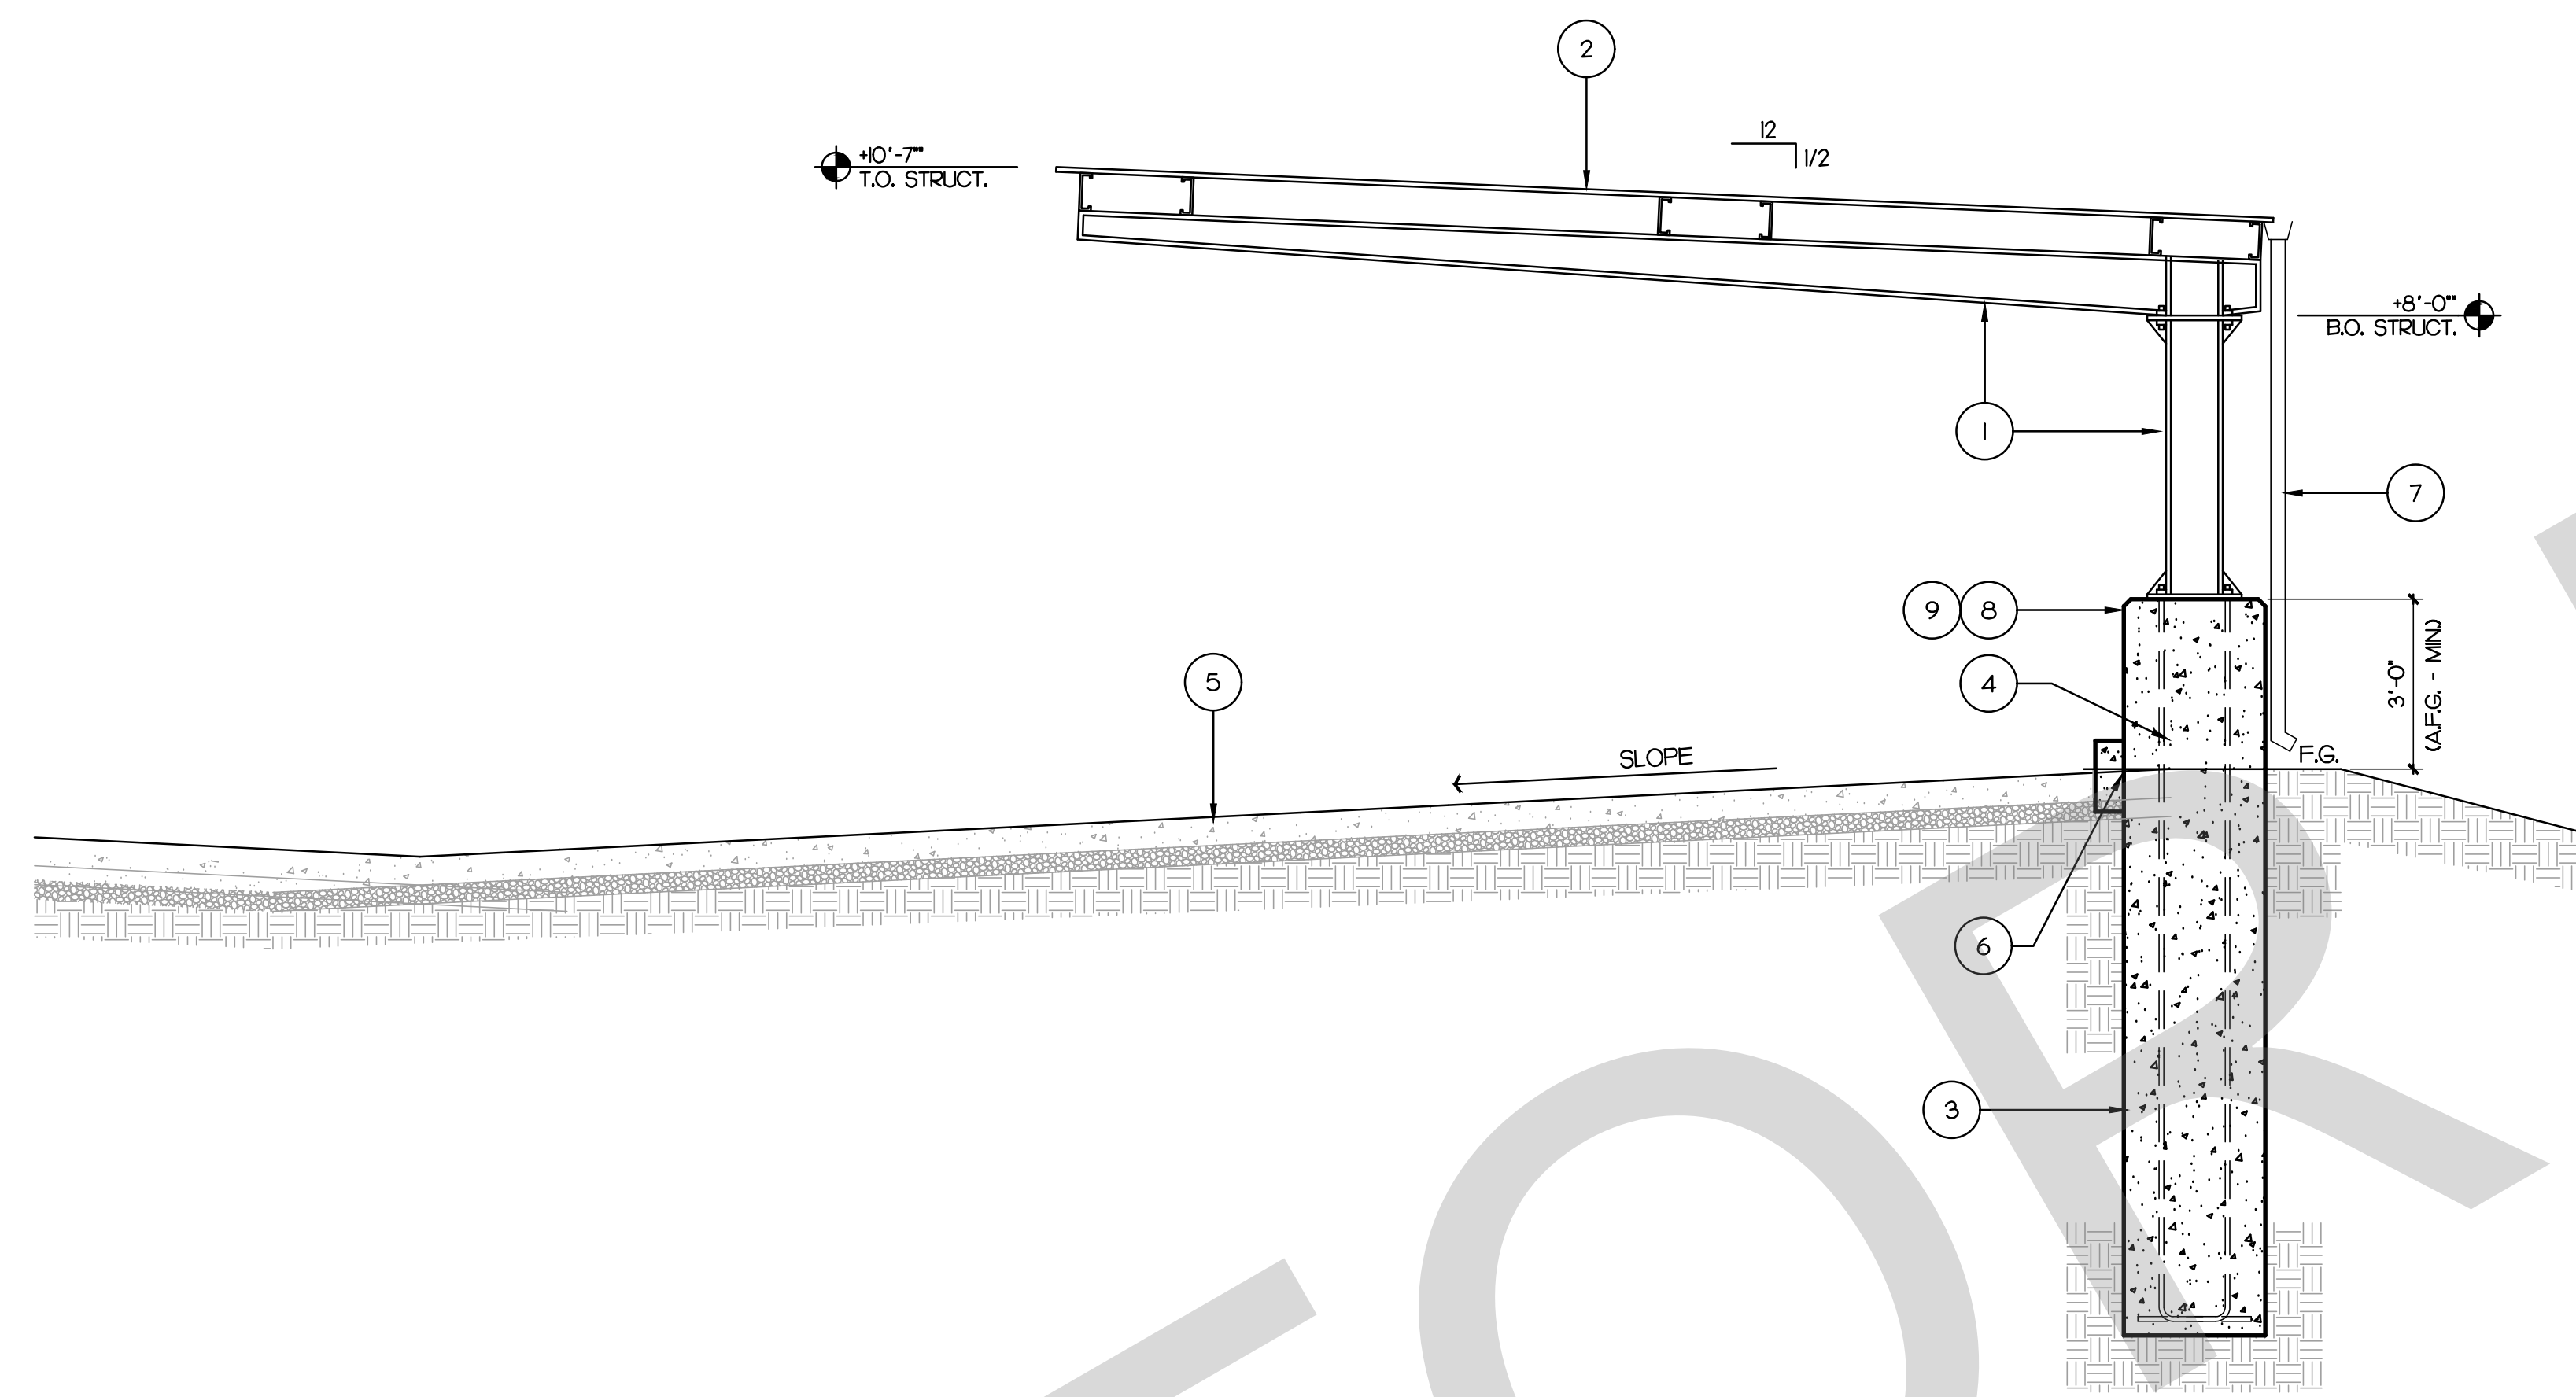

CANOPY ELEVATION / SECTION - SIM.

SCALE:	
3/8"=1'-0"	

1. PRE-FABRICATED METAL SHADE CANOPY. STRUCTURAL MEMBER SIZING PER MANUF.'S RECOMMENDATIONS. SEE SPECIFICATIONS. PAINT ALL EXPOSED STRUCT. SURFACES AS REQUIRED. COLOR TO BE DETERMINED AND FIELD VERIFY BY OWNER. COORDINATE WITH OWNER.
2. METAL ROOFING & SECONDARY FRAMING BY PRE-FAB BUILDING MANUFACTURE, PER SPECIFICATIONS.
3. CONCRETE FOOTING, STEEL ANCHOR PLATE, REINFORCING, ETC. PER PRE-FAB METAL BUILDING MANUF.'S & SOILS REPORT RECOMMENDATIONS.
4. CONCRETE CURB AS OR WHERE OCCURS PER CIVIL.
5. CONCRETE PAVING AS OCCURS OVER CLASS II BASE PER CIVIL.
6. SEAL AT COLUMN - TYP.
7. GALVANIZED SHEET METAL GUTTER AND DOWNSPOUT (AT 3 LOCATIONS) BY PRE-FAB METAL BUILDING MANUFACTURER - PAINT. SURFACE DRAIN AWAY FROM STRUCTURE.
8. PAINT ALL EXPOSED CAISSONS WITH 2-COATS PRIMERS & 2-COATS "SAFETY YELLOW".
9. INSTALL 2 BANDS OF 3" WIDE 3M REFLECTIVE TAPE AROUND THE CAISSONS. SEE


THE DRAWING & NOTES SHOWN ON THIS SHEET IS FOR INFORMATION & BIDDING PURPOSE ONLY. FINAL DESIGN & ENGINEERING/SHOP DRAWING SHALL BE PROVIDED BY THE GENERAL CONTRACTOR, WET STAMPED BY A REGISTERED CALIFORNIA ENGINEER. SEE SECTION 13 3420 OF SPECIFICATIONS.



SCALE:	4
3/8"=1'-0"	



A1.5.1

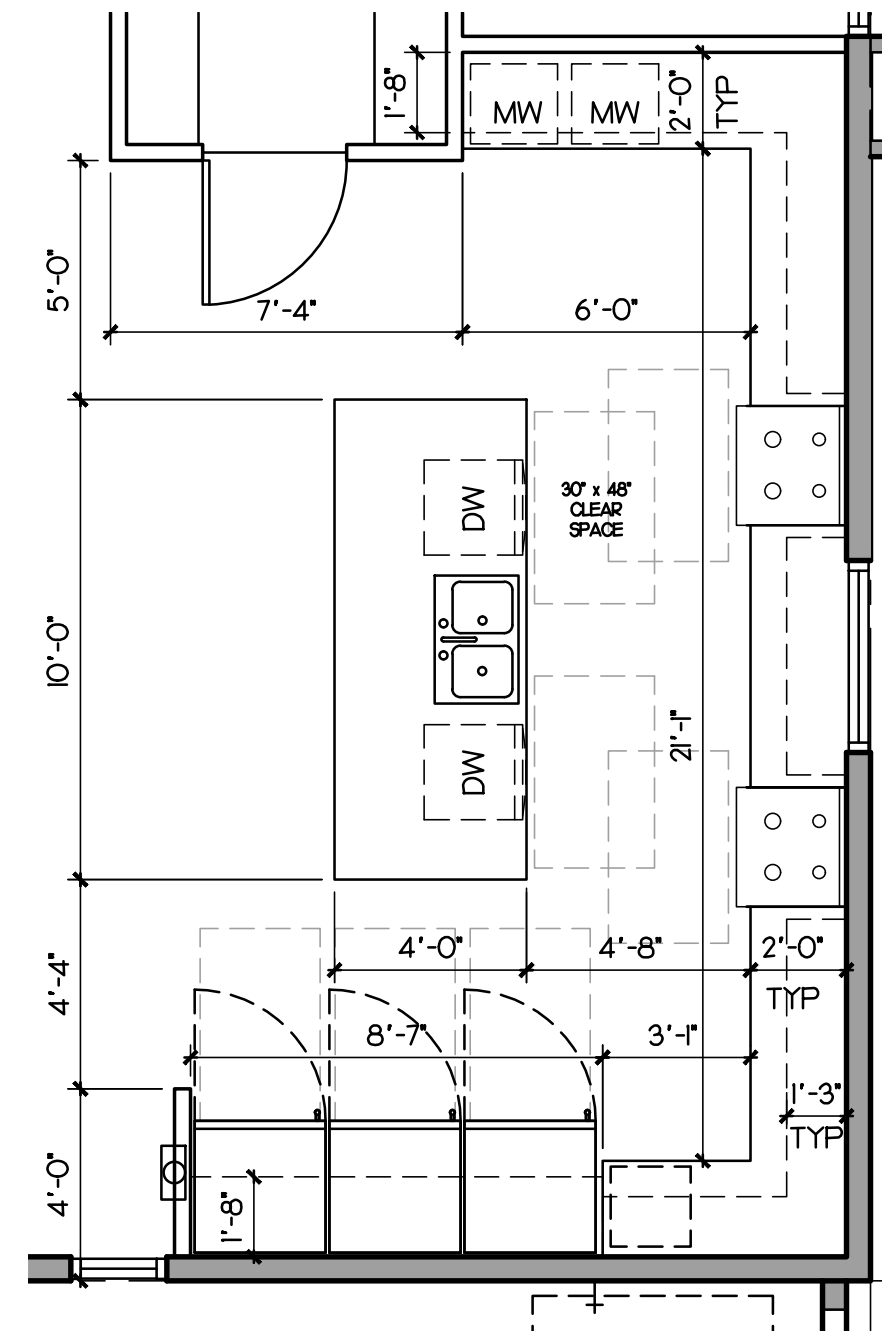


ENLARGED KITCHEN PLAN

SCALE: 1/4"=1'-0"

2



NOT USED

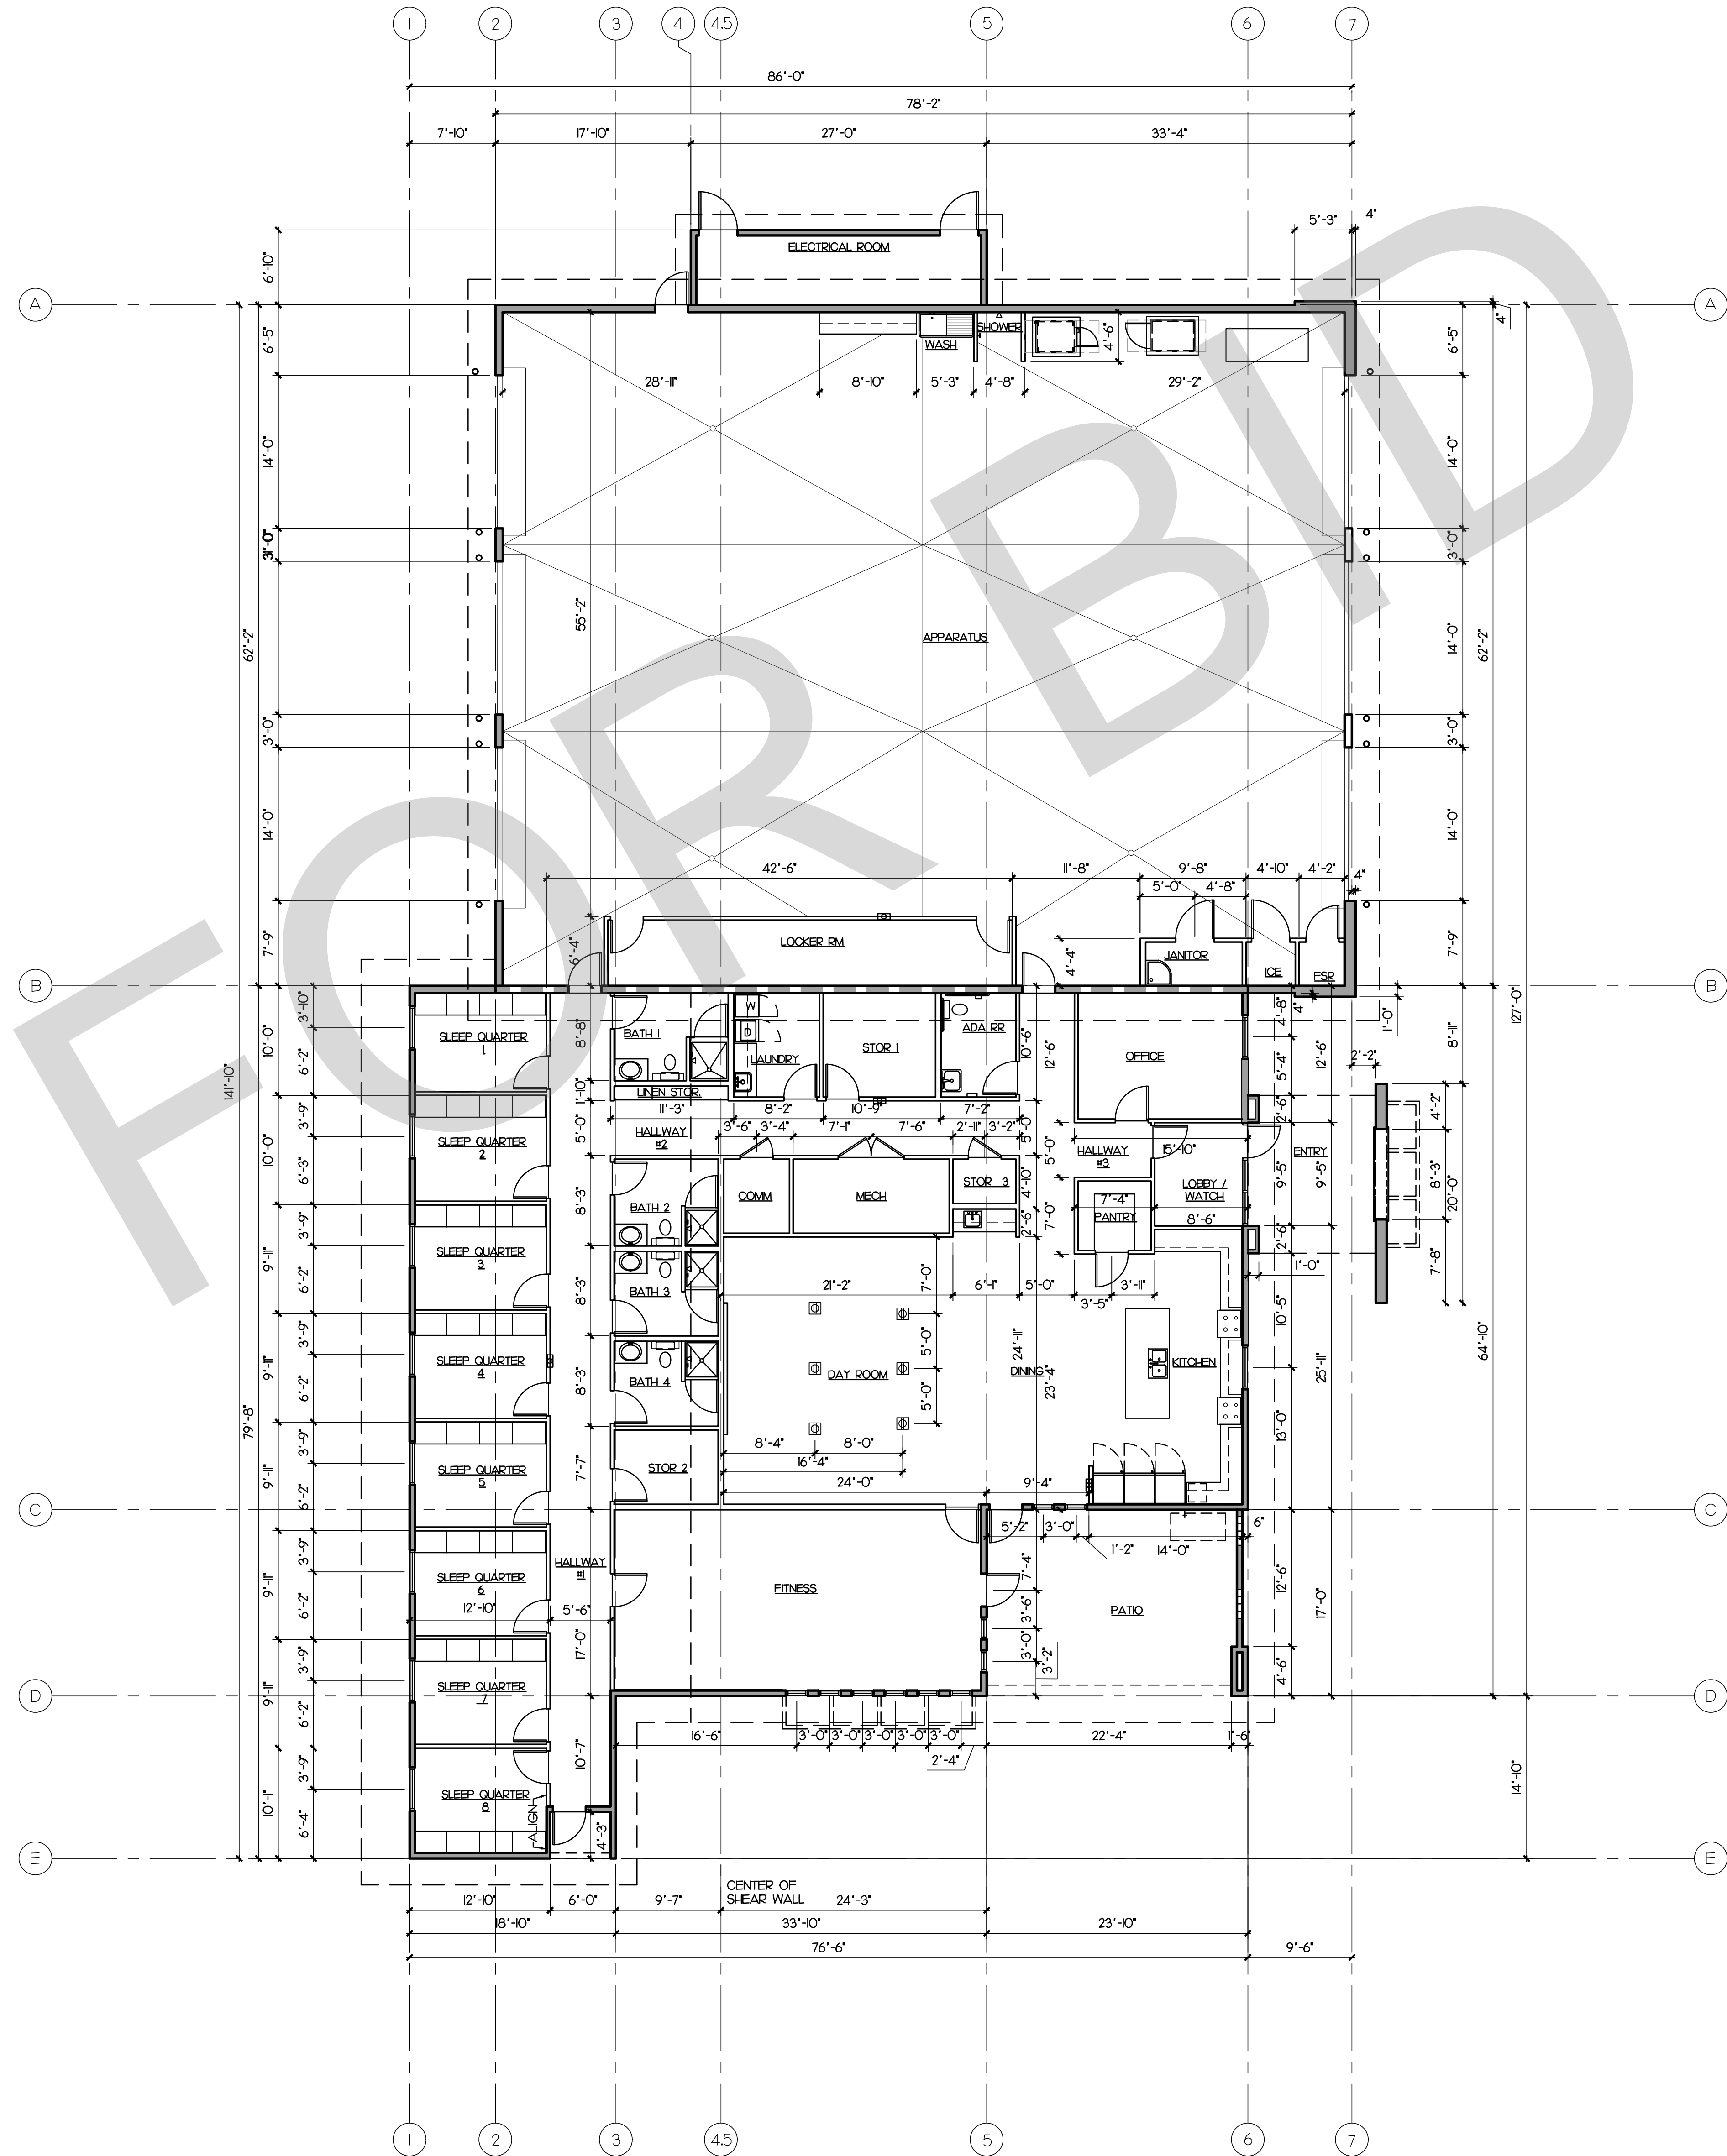

DIMENSION FLOOR PLAN

SCALE: 1/8"=1'-0"

1

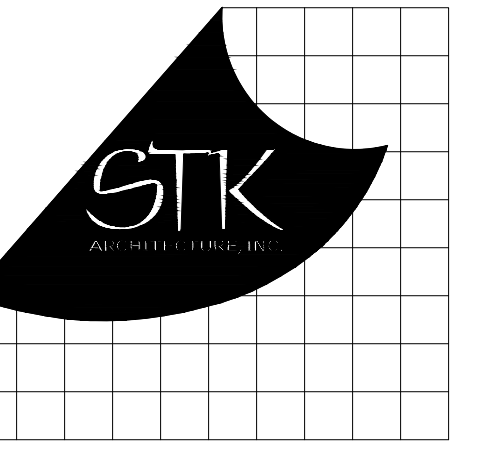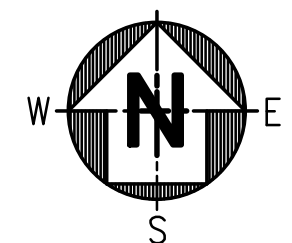

CONSULTANT:

PROJECT ADMINISTERED BY:
SAN BERNARDINO COUNTY
PROJECT & FACILITIES
MANAGEMENT DEPARTMENT

385 N. ARROWHEAD AVE.
SAN BERNARDINO, CA 92415

PROJECT NAME:
SAN BERNARDINO
COUNTY FIRE
DEPARTMENT:
FIRE STATION 226

PROJECT # 10101032
CIP #21-037
CAFM # SAB198
APN # 0273-011-22

1920 DEL ROSA AVE N.
SAN BERNARDINO,
CA 92404

ISSUE INFORMATION:	
DATE:	INFORMATION:
04-11-2022	20% CD SET
04-28-2022	50% CD SET
06-15-2022	95% CD SET
09-16-2022	95% CD- 3rd BAY
10-03-2022	PLAN CHECK

SHEET INFORMATION:
STK PROJECT NO.: 374-154-21
SCALE: AS NOTED
DATE: JANUARY 2021
PLOT DATE:
DRAWING NAME:

SEAL:



SHEET TITLE:

DIMENSION
PLAN

SHEET NO.:

A2.0

03/20/2022 4:29PM J:\174 SAN BERNARDINO COUNTY FIRE STATION 226\Architectural\A2.1 - REFERENCE FLOOR PLAN.dwg

GA FILE NO. WP 3005

PROPRIETARY*

1/2 HOUR FIRE

50 to 54 STC SOUND

GYPSUM WALLBOARD, WOOD STUDS

One layer 5/8" proprietary gypsum wallboard or gypsum veneer base applied parallel or at right angles to each side of 2 x 4 wood studs 16" o.c. with 1-5/8" Type S drywall screws 12" o.c. Vertical joints centered over studs and staggered one stud cavity on opposite sides. Horizontal joints need not be staggered or backed. (LOAD-BEARING)

Sound tested with resilient channels on one side, 3-1/2" glass fiber insulation and a double layer of 5/8" proprietary gypsum wallboard applied with screws spaced 12 o.c.

PROPRIETARY GYPSUM BOARD

United States Gypsum Company.....5/8" SHEETROCK® Brand UltraLight Panels FIRECODE® 30

Thickness: 4-3/4" (Fire)

6-1/4" (Sound)

Approx. Weight: 7 psf

Fire Test: UL R1319, 11NK03873, 4-15-11, UL Design U407

Sound Test: RAL TL11-132, S-23-11

1/2 HOUR FIRE RATED WALL

GA FILE NO. WP 3614

GENERIC

1 HOUR FIRE

GYPSUM WALLBOARD, WOOD STUDS

Fire Design:
One layer 5/8" type X gypsum wallboard or gypsum veneer base applied parallel or at right angles to each side of 2 x 4 wood studs 16" o.c. with 1-1/4" Type W screws 12" o.c. Joints staggered 16" on opposite sides. (LOAD-BEARING)

Thickness: 4-3/4" (Fire)

Approx. Weight: 7 psf (Fire)

Fire Test: SWRI 01-4511-619[1], 3-94

1 HOUR FIRE RATED WALL

Fire-rated Construction

Fire Rating

Detail & Physical Data

Description & Test No.

Acoustical Performance

STC RC

Description & Test No.

System Reference

1 hr.

5/8" Sheetrock Board Gypsum Panel, Firecode C core, plastered wood truss of min. 2 x 4 lumber, dry UL Class A, B or C ceiling system—RSC-1 channels or equivalent spaced 12" or 16" o.c.—gypsum panels attached with 1" Type S screws, joints finished—optional insulation directly over gypsum ceiling membrane—**UL Test P922**

N/A


5

United States Gypsum Company 58024

11

1/2 HOUR FIRE RATED CEILING

1/2 HOUR FIRE RATED TYPE X GYPSUM BOARD PROVIDES 30 MIN. RATINGS TO AN ASSEMBLY PER ASTM C36.

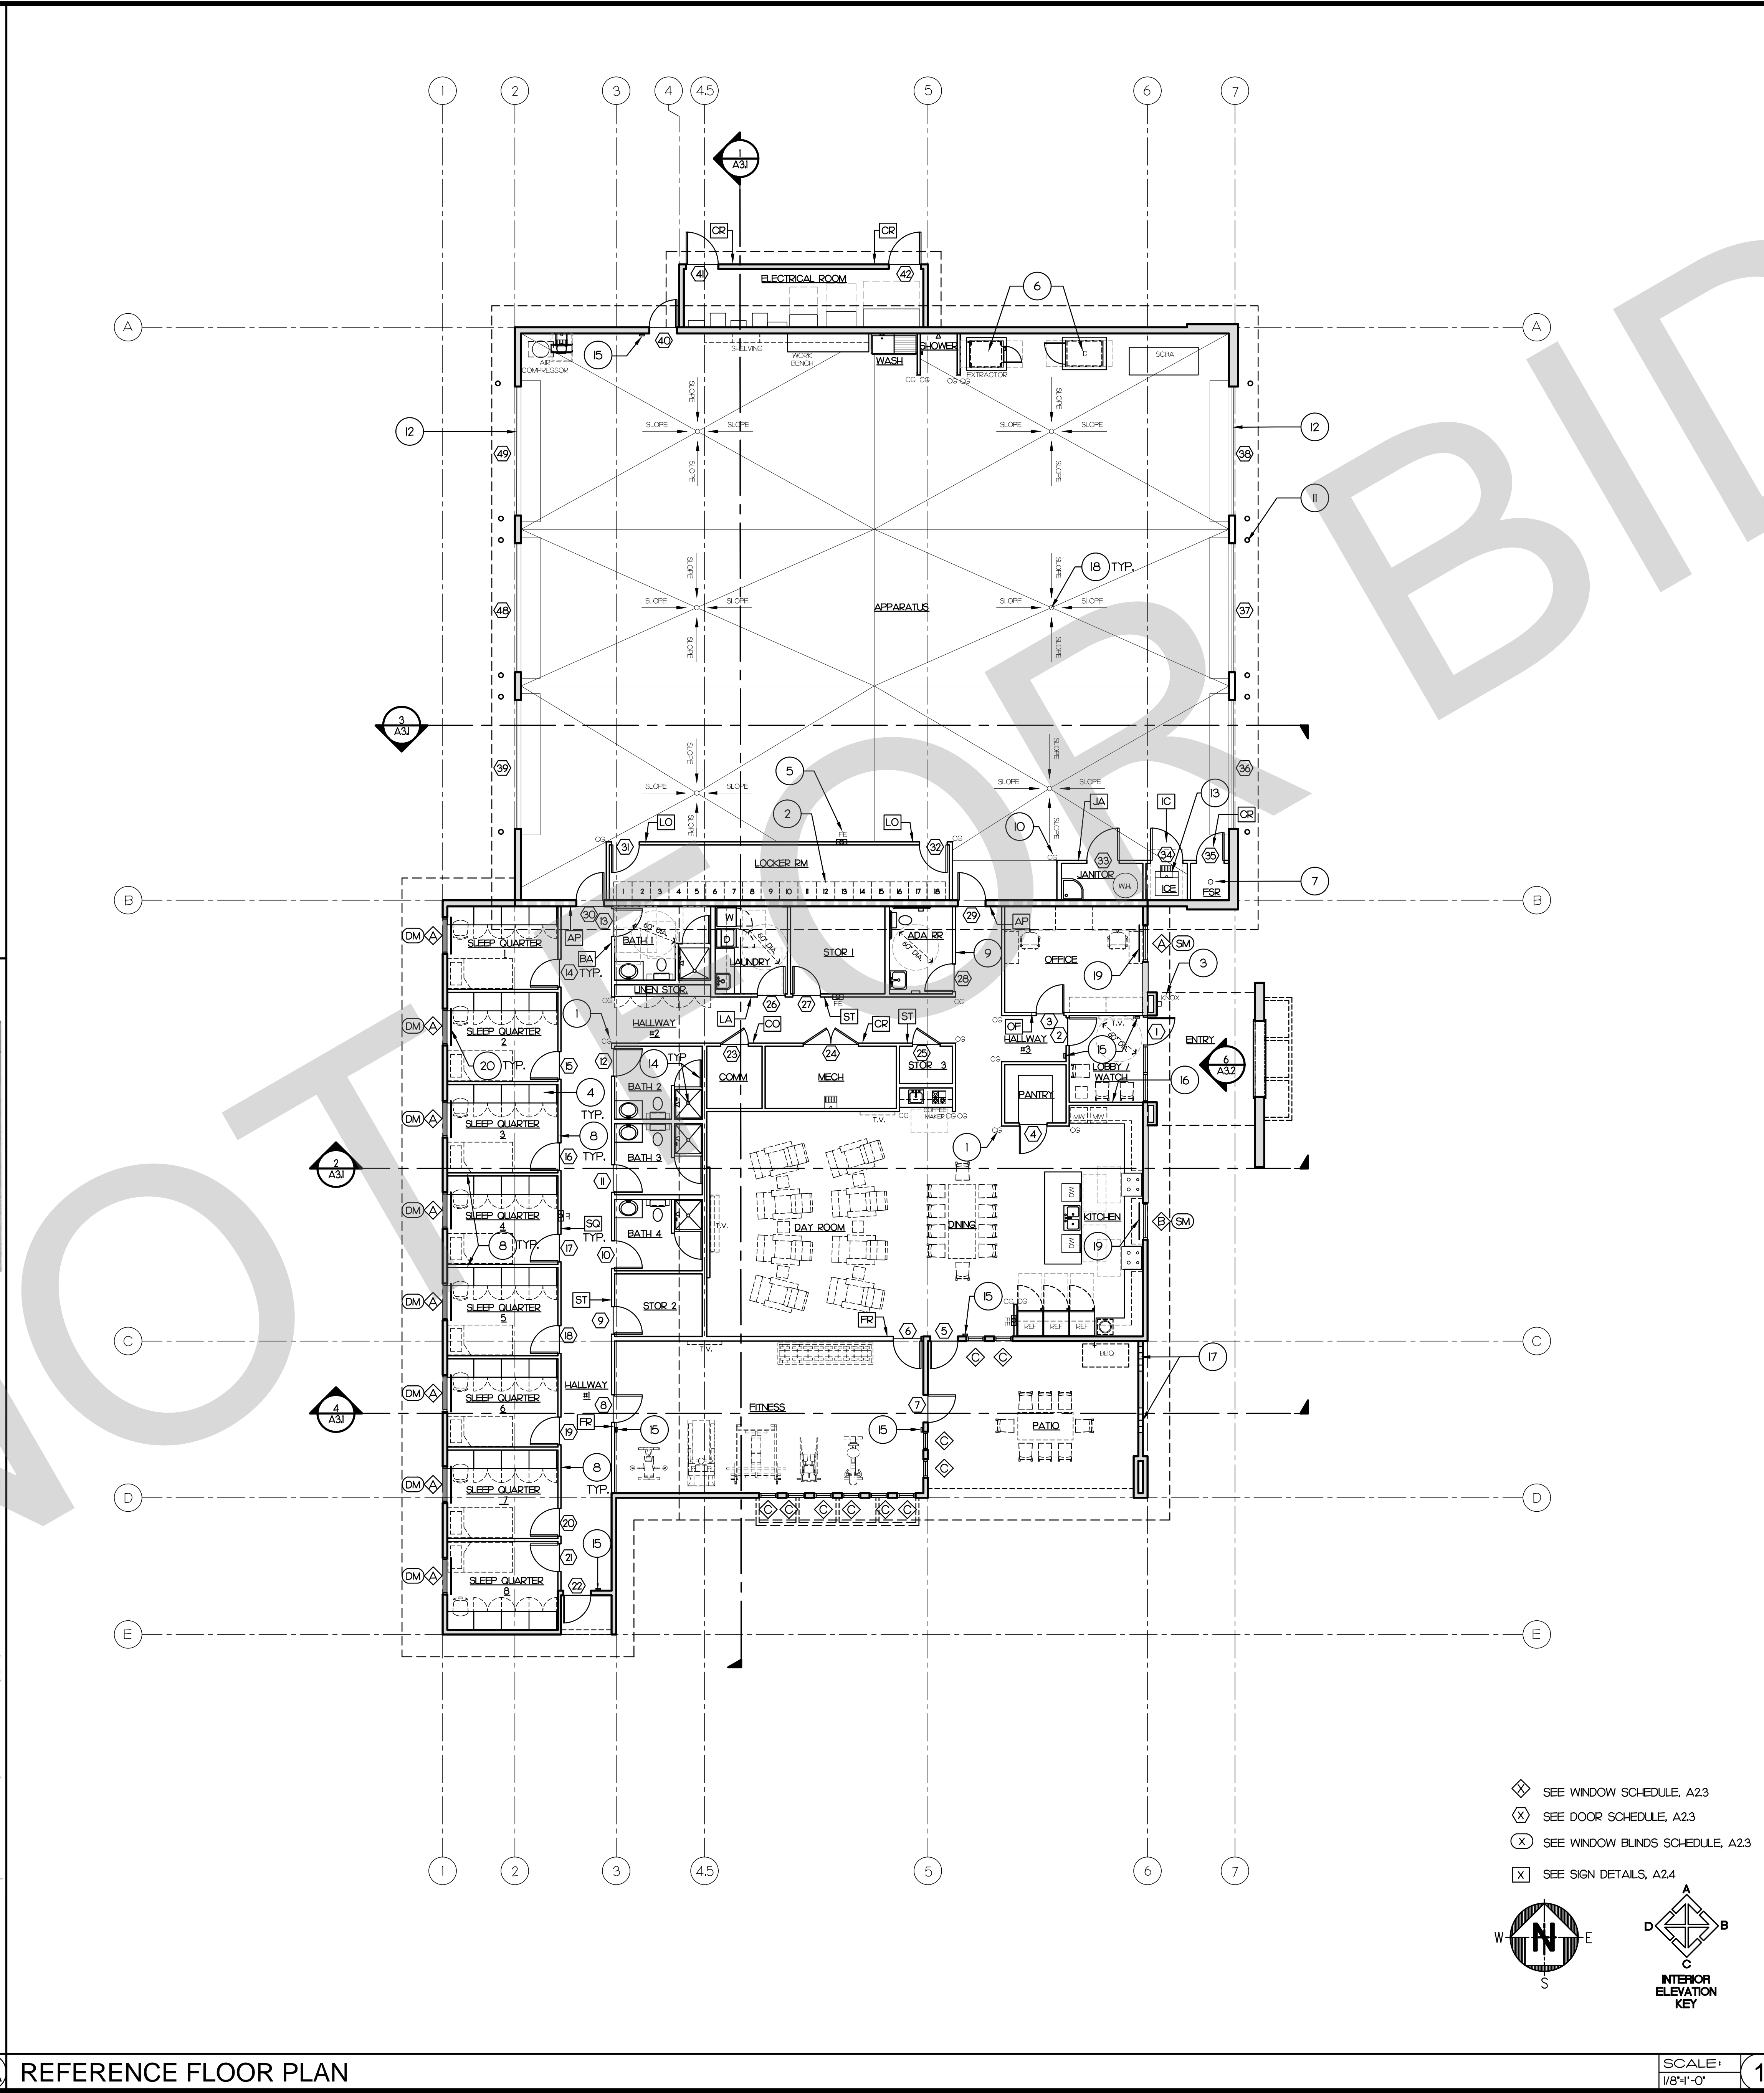

KEY NOTE

1. CORNER GUARDS (PVC), (TYP. OF 13)

2. WALL MOUNTED METAL LOCKERS, PROVIDE BACKING AS REQUIRED, (TYP. OF 18)

3. KNOX BOX, PROVIDE PER COUNTY OF SAN BERNARDINO FIRE DEPT. REQUIREMENTS.

4. WARDROBE LOCKERS, SEE

5. SEMI-RECESSED FIRE EXTINGUISHER, SEE

6. 46" HIGH CONC. PAD FOR EXTRACTOR & DRYER, SEE

7. FIRE SPRINKLER RISER.

8. 1/2 HOUR FIRE RATED WALL.

9. ADA RESTROOM WALL AND DOOR SIGNAGE, SEE

10. CORNER GUARDS (STAINLESS STEEL), (TYP. OF 7)

11. 6" DIA. X 4" HIGH CONCRETE FILLED BOLLARD, PAINT OSHA YELLOW, SEE

12. OVERHEAD COILING DOORS, (TYP. OF 4) SEE

13. ICE MACHINE

14. 3" WIDE GLASS SHOWER DOOR & SHOWER RECEPTOR.

15. TACTILE EXIT SIGN, SEE

16. WALL COVER WITH GRAPHICS.

17. MASONRY SCREEN BLOCK, FOR OPENING REFER TO EXTERIOR ELEVATIONS, SEE

18. AREA DRAIN, SEE PLUMBING DWGS.

19. MANUAL WINDOW SHADES.

20. MANUAL WINDOW DUAL SHADES AT SLEEP QUARTERS, (TYP. OF 8)

WALL LEGEND

EXTERIOR WALL: 2x6 or 2x8 WOOD STUDS • 16" O.C. W/ SHEATHING PER STRUCTURAL DRAWINGS W/ CEMENT GYPSUM PLASTER W/ R-21 BATT INSULATION & ONE LAYER OF 5/8" TYPE "X" GYP. BD. ON INTERIOR FACE, UNLESS OTHERWISE NOTED.

1 HOUR WALL: 2x6 WOOD STUDS • 16" O.C. W/ ONE LAYER OF 5/8" TYPE "X" GYP. BD. FROM FLOOR TO UNDERSIDE OF ROOF SHEATHING ON APPARATUS BAY SIDE AND ONE LAYER OF 5/8" TYPE "X" GYP. BD. FROM FLOOR TO UNDERSIDE OF ROOF SHEATHING ON LIVING QUARTERS SIDE W/ PLYWOOD PER STRUCT. DRAWING. USE R-21 BATT INSULATION TO FILL CAVITY.

INTERIOR WALL: 2x6 OR 2x4 WOOD STUDS • 16" O.C. W/ 5/8" TYPE "X" GYP. BD. ON EACH FACE (UNLESS OTHERWISE NOTED) W/ (SOUND) INSULATION FULL HEIGHT OF WALL, REFER TO FIRE RATED WALL ASSEMBLIES FOR SPECIFICATION.

NOTE: PROVIDE WATER RESISTANT GYP. BD. BEHIND ALL WET AREAS.

NOTE: COORDINATE / SEE STRUCTURAL DRAWINGS FOR ALL 46" HIGH CONC. CURB - CURB WIDTH TO MATCH WALL STUD WIDTH. (TYP. AT ALL EXTERIOR WALLS AND ALL APPARATUS WALLS)

NOTE: ALL PIPING, CONDUITS, WIRES, DUCTS, ETC. SHALL BE CONCEALED INSIDE WALLS OR ATTIC, NO EXCEPTIONS.

EQUIPMENT LIST

QTY.	ITEM	FURNISHED BY	INSTALLED BY
3	REFRIGERATOR/FREEZER	CONTRACTOR	CONTRACTOR
2	DISHWASHER	CONTRACTOR	CONTRACTOR
2	RANGE & HOOD	CONTRACTOR	CONTRACTOR
2	MICROWAVE	CONTRACTOR	CONTRACTOR
1	COFFEE MAKER	CONTRACTOR	CONTRACTOR
1	WASHER	CONTRACTOR	CONTRACTOR
1	DRYER	CONTRACTOR	CONTRACTOR
5	FIRE EXTINGUISHERS	CONTRACTOR	CONTRACTOR
18	METAL LOCKERS	OWNER	CONTRACTOR
24	PLASTIC LAMINATE WARDROBE LOCKERS	CONTRACTOR	CONTRACTOR
1	ICE MACHINE/ BIN	CONTRACTOR	CONTRACTOR
1	P/A SYSTEM - SEE DATA22	OWNER	CONTRACTOR
1	RADIO COMM. SYSTEMS - SEE DATA22	OWNER	OWNER
1	EXTRACTOR WASHER (65lb)	CONTRACTOR	CONTRACTOR
1	COMM. DRYER	CONTRACTOR	CONTRACTOR
1	AIR COMPRESSOR	CONTRACTOR	CONTRACTOR
1	VEHICLE EXHAUST SYSTEM	CONTRACTOR	CONTRACTOR
8	CEILING FANS	CONTRACTOR	CONTRACTOR
2	BIG FORMAT CEILING FANS	CONTRACTOR	CONTRACTOR
1	AUTO TRANSFER SWITCH	CONTRACTOR	CONTRACTOR
2	UNIT HEATER	CONTRACTOR	CONTRACTOR
1	EXERCISE EQUIPMENT	OWNER	CONTRACTOR
1	EMERGENCY GENERATOR	CONTRACTOR	CONTRACTOR
2	COMPRESSED AIR HOSE REEL	CONTRACTOR	CONTRACTOR
1	2000gal DIESEL FUEL TANK	OWNER (RE-USE)	CONTRACTOR
	FURNITURE	CONTRACTOR	CONTRACTOR

NOTES:

- "OWNER" REFERS TO COUNTY OF SAN BERNARDINO FIRE DEPT.

COMPRESSED AIR HOSE REEL: CONCRETE T-SERIES, EZ-15H-3000 OR APPROVED EQUAL.

FURNITURE: RECLINERS, DINING TABLE & CHAIRS, PATIO TABLE & CHAIRS AND SLEEP QUARTER MATTRESSES ARE BY CONTRACTOR

WALL/DOOR SIGNS LEGEND

TAG	QTY	SIGN
AP	(2)	APPARATUS
BA	(4)	BATH-ROOM 1 to 4
CO	(1)	COMM ROOM
FI	(2)	FITNESS
FR	(1)	FIRE RISER ROOM
IC	(1)	ICE MACHINE
CR		CODE REQUIRED SIGNS
JA	(1)	JANITOR
MR	(1)	MECH ROOM
LA	(1)	LAUNDRY
LO	(2)	LOCKER
OF	(1)	OFFICE
ST	(3)	STORAGE
SQ	(8)	SLEEP QUARTERS 1 to 8

NOTE: ALSO PROVIDE UNSEX SIGN FOR BATHROOMS 1-4

42055 ZEVIO DR., TEMECULA, CALIFORNIA 92590-3760
Phone: 951.296.8110 Fax: 951.296.6079 Email: stk@stkinc.com

CONSULTANT:

PROJECT ADMINISTERED BY:

SAN BERNARDINO COUNTY
PROJECT & FACILITIES
MANAGEMENT DEPARTMENT

PROJECT NAME:

SAN BERNARDINO
COUNTY FIRE
DEPARTMENT:
FIRE STATION 226

PROJECT # 10J0J032

CIP #21-037

CAFM # SABI98

APN # 0273-011-22

1920 DEL ROSA AVE N.
SAN BERNARDINO,
CA 92404

ISSUE INFORMATION:

DATE:	INFORMATION:
04-11-2022	20% CD SET
04-28-2022	50% CD SET
06-15-2022	95% CD SET
09-16-2022	95% CD- 3rd BAY
10-03-2022	PLAN CHECK

SHEET INFORMATION:

STK PROJECT NO.: 374-154-21

SCALE: AS NOTED

DATE: JANUARY 2021

DRAWING NAME:


SEAL:

SHEET TITLE:

REFERENCE
PLAN

SHEET NO.:

A2.1

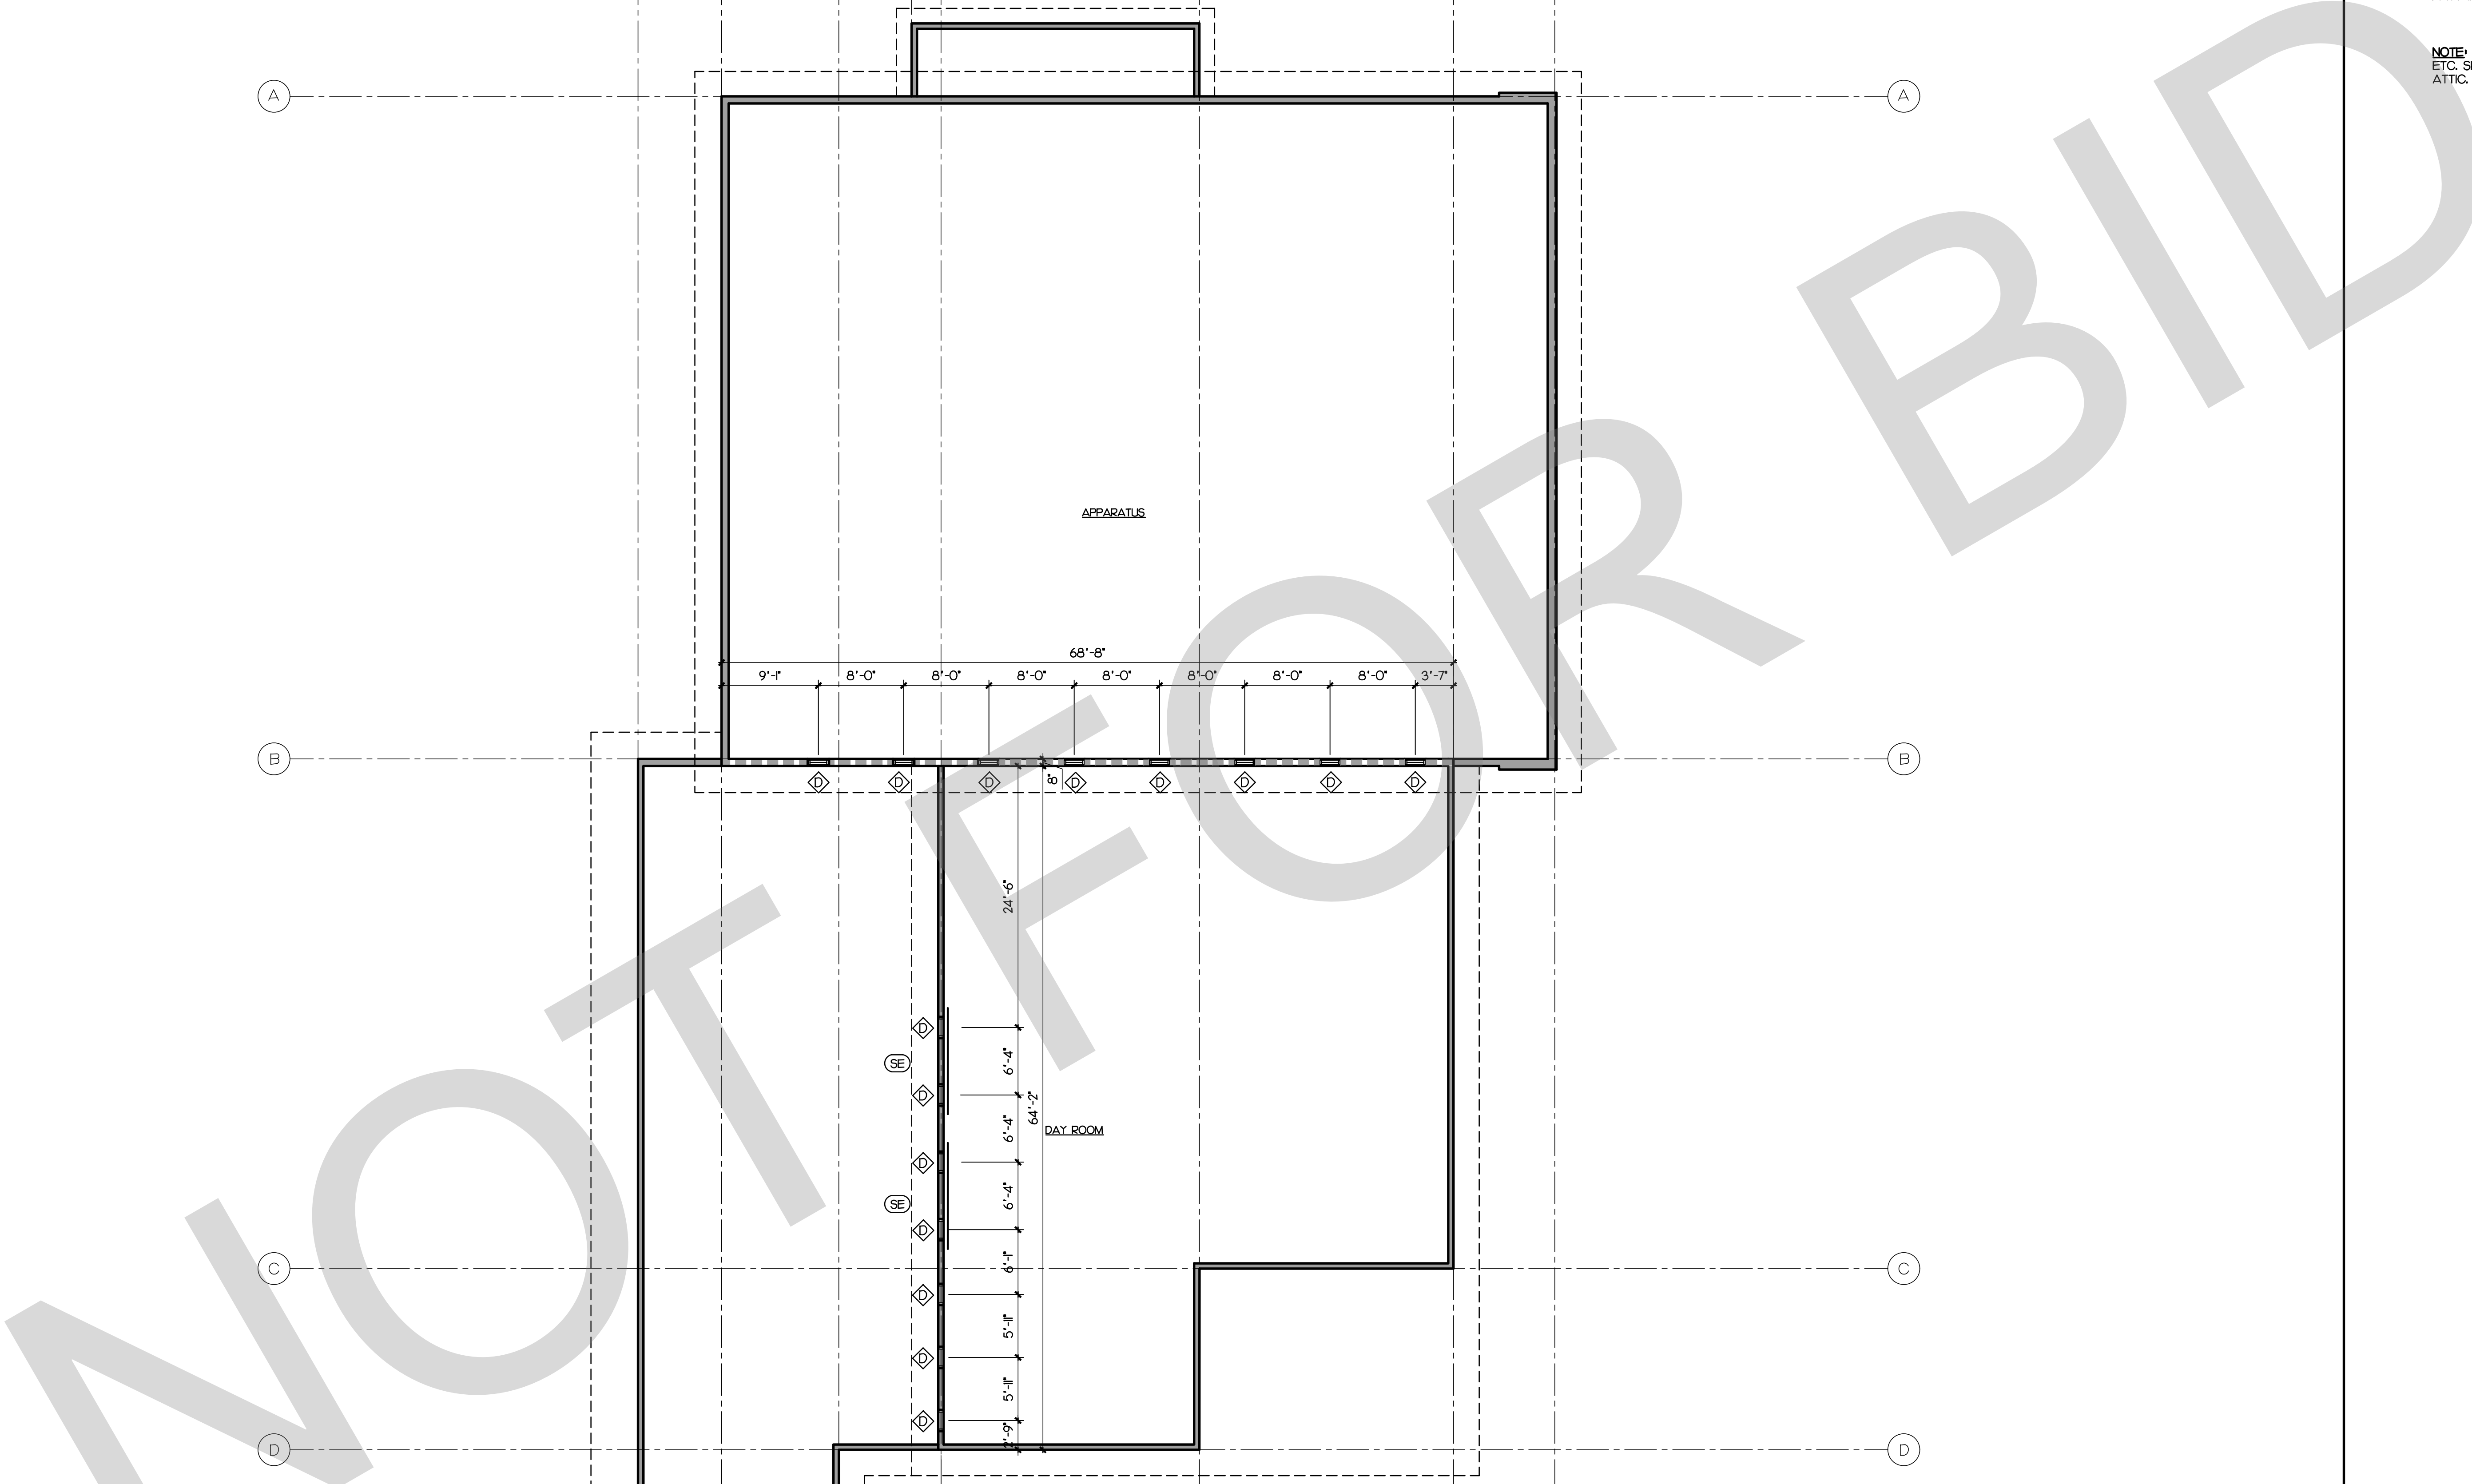

NOTE: ALL PIPING, CONDUITS, WIRES, DUCTS, ETC. SHALL BE CONCEALED INSIDE WALLS OR ATTIC. NO EXCEPTIONS.

A2.2

SCALE:	1
1/8"=1'-0"	

DOOR SCHEDULE														
DOOR								FIRE RATING LABEL (M/R)	FRAME				HARDWARE GROUP (SEE SPEC'S)	REMARKS
MARK	SIZE		TYPE	MATL	FIN	GLAZING	MATL		DETAIL, SHEET A2.4					
	WD-HT	TH-K							HEAD	JAMB	SILL			
FRE STATION	1	3070	1-3/4	D	AL	AL	TP	-	HM	12	13	14		①②③④
	2	3070	1-3/4	B	SC	WD	TP	-	HM	2	2	9B		
	3	3070	1-3/4	B	SC	WD	TP	-	HM	2	2	9A		
	4	3070	1-3/4	A	SC	WD	-	-	HM	2	2	9B		⑫
	5	3070	1-3/4	E	HM	MP	TP	-	HM	1	1	10		②③④
	6	3070	1-3/4	E	SC	WD	TP	-	HM	2	2	9E		
	7	3070	1-3/4	E	HM	MP	TP	-	HM	1	1	10		②③④
	8	3070	1-3/4	E	SC	WD	TP	-	HM	2	2	9E		
	9	3070	1-3/4	A	SC	WD	-	-	HM	2	2	9D		
	10	3070	1-3/4	A	SC	WD	-	-	HM	2	2	9C		⑫
	11	3070	1-3/4	A	SC	WD	-	-	HM	2	2	9C		⑫
	12	3070	1-3/4	A	SC	WD	-	-	HM	2	2	9C		⑫
	13	3070	1-3/4	A	SC	WD	-	-	HM	2	2	9C		⑫
	14	3070	1-3/4	A	SC	WD	-	-	HM	2	2	9A		②
	15	3070	1-3/4	A	SC	WD	-	-	HM	2	2	9A		②
	16	3070	1-3/4	A	SC	WD	-	-	HM	2	2	9A		②
	17	3070	1-3/4	A	SC	WD	-	-	HM	2	2	9A		②
	18	3070	1-3/4	A	SC	WD	-	-	HM	2	2	9A		②
	19	3070	1-3/4	A	SC	WD	-	-	HM	2	2	9A		②
	20	3070	1-3/4	A	SC	WD	-	-	HM	2	2	9A		②
	21	3070	1-3/4	A	SC	WD	-	-	HM	2	2	9A		②
	22	3070	1-3/4	B	HM	MP	TP	-	HM	1	1	10		②③④
	23	4070	1-3/4	F	HM	MP	-	-	HM	2	2	9D		⑨
	24	6070	1-3/4	C	HM	MP	-	-	HM	2	2	9D		⑨
	25	3070	1-3/4	A	SC	WD	-	-	HM	2	2	9D		
	26	3070	1-3/4	E	SC	WD	TP	-	HM	2	2	9B		⑫
	27	3070	1-3/4	A	SC	WD	-	-	HM	2	2	9D		
	28	3070	1-3/4	A	SC	WD	-	-	HM	2	2	9C		⑧⑫
	29	3070	1-3/4	B	HM	MP	TP	20	HM	4	4	10		②⑤⑩
	30	3070	1-3/4	B	HM	MP	TP	20	HM	4	4	10		②⑤⑩
	31	3070	1-3/4	F	HM	MP	-	-	HM	2	2	9B		②⑨
	32	3070	1-3/4	F	HM	MP	-	-	HM	2	2	9B		②⑨
	33	4070	1-3/4	A	HM	MP	-	-	HM	2	2	9B		
	34	3670	1-3/4	A	HM	MP	-	-	HM	2	2	9B		⑨
	35	3070	1-3/4	A	HM	MP	-	-	HM	2	2	9B		
	36	14040	-	G	RF	MF	-	-	RF	3	3	-		
	37	14040	-	G	RF	MF	-	-	RF	3	3	-		
	38	14040	-	G	RF	MF	-	-	RF	3	3	-		
	39	14040	-	G	RF	MF	-	-	RF	3	3	-		
	47	14040	-	G	RF	MF	-	-	RF	3	3	-		
	48	14040	-	G	RF	MF	-	-	RF	3	3	-		
	40	3070	1-3/4	B	HM	MP	-	-	HM	1	1	10		②③④
41	4070	1-3/4	A	HM	MP	-	-	HM	1	1	10			
42	4070	1-3/4	F	HM	MP	-	-	HM	1	1	10		⑨	
STORAGE BUILDING	43	3070	1-3/4	A	HM	MP	-	-	HM	1	1	10		⑨
	44	8080	-	H	RF	MF	-	-	RF	3	3	-		⑦
GATES	45	4070	-	J	MG	PC	-	-	-	-	-			
	46	3070	-	J	MG	PC	-	-	-	-	-			①

X DOOR MARK PER REFERENCE PLAN, A2.2

NOTES

- ALL DOORS TO HAVE THE BOTTOM OF 10" OF SMOOTH UNINTERRUPTED SURFACE OR SHALL BE PROVIDED WITH A 10" HIGH SMOOTH METAL PANEL AT THE BOTTOM OF THE DOOR.
- ALL EXITS TO BE OPENABLE FROM THE INSIDE WITHOUT THE USE OF A KEY OR ANY SPECIAL KNOWLEDGE OR EFFORT.

MATL/GLAZING KEY

H-M	HOLLOW METAL
RF	ROLL FORMED GALVANIZED STEEL
SC	SOLID CORE
MG	METAL GATE
TP	TEMPERED PLATE
GL	GLASS
AL	ALUMINUM

FINISH KEY

MF	MANUFACTURE'S FINISH
MP	METAL PAINTED
WD	WOOD VENEER
PC	POWDER COATED
AL	ALUMINUM

REMARKS KEY

- INSTALL SIGN ABOVE DOOR STATING THIS DOOR TO REMAIN UNLOCKED WHEN BUILDING IS OCCUPIED. PROVIDE 1" HIGH LETTERS ON A CONTRASTING BACKGROUND.
- W/ CLOSER.
- PROVIDE EXIT SIGNAGE - SEE ① A2.4
- LOCK OR LATCH SHALL BE OPENABLE FROM THE INSIDE WITHOUT THE USE OF A KEY OR ANY SPECIAL KNOWLEDGE OR EFFORT.
- PROVIDE DOOR FRAME WITH SEAL.
- FIELD VERIFY SIZE.
- PROVIDE WEATHER STRIPPING AT JAMES.
- PROVIDE ADA RR SIGNAGE SEE ⑧ A2.4
- PROVIDE LOUVER. SEE MECH.
- WITH FIRE RESISTANT GLAZING.
- WITH CIPHER LOCK
- UNDERCUT DOOR 1"

FINISH SCHEDULE

ROOM NAME	FLOOR		WALL A		WALL B		WALL C		WALL D		CEILING		REMARKS
	MTL	BASE	MTL	FN	MTL	FN	MTL	FN	MTL	FN	MTL	FN	
LOBBY / WATCH	F4	BI	WI	A	WI	A	WW7	A/C	WI	A	C2	C	
ADA BATH	F1	B2	WW3	A/C	WW3	A/C	WW3	A/C	WW3	A/C	C1	A	WATER RESISTANT GYP. BD. FROM FLOOR TO BOTTOM OF CEILING
OFFICE	F2	BI	WI	A	WI	A	WI	A	WI	A	C2	C	
KITCHEN	F4	BI	WW3	A	WW3	A/C	WW3	A	WI	A	C1	A	
DINING	F4	BI	WI	A	WI	A	WI	A	WI	A	C2	C	
DAYROOM	F2	BI	WI	A	WI	A	WI	A	WI	A	C1/C2	A/C	
FITNESS	F3	BI	WI	A	WI	A	WI	A	WI	A	C1/C2	A/C	
LAUNDRY	F4	BI	WI	A	WI	A	WI	A	WI	A	C2	C	PROVIDE WATER RESISTANT GYP. BD. FOR WALL 17 ONLY
SLEEP QUARTER'S #1	F2	BI	WI	A	WI	A	WI	A	WI	A	C1	A	
SLEEP QUARTER'S #2	F2	BI	WI	A	WI	A	WI	A	WI	A	C1	A	
SLEEP QUARTER'S #3	F2	BI	WI	A	WI	A	WI	A	WI	A	C1	A	
SLEEP QUARTER'S #4	F2	BI	WI	A	WI	A	WI	A	WI	A	C1	A	
SLEEP QUARTER'S #5	F2	BI	WI	A	WI	A	WI	A	WI	A	C1	A	
SLEEP QUARTER'S #6	F2	BI	WI	A	WI	A	WI	A	WI	A	C1	A	
SLEEP QUARTER'S #7	F2	BI	WI	A	WI	A	WI	A	WI	A	C1	A	
SLEEP QUARTER'S #8	F2	BI	WI	A	WI	A	WI	A	WI	A	C1	A	
BATH #1	F1	B2	WW3	A/C	WW3	A/C	WW3	A/C	WW3	A/C	C1	A	WATER RESISTANT GYP. BD. FROM FLOOR TO BOTTOM OF CEILING
BATH #2	F1	B2	WW3	A/C	WW3	A/C	WW3	A/C	WW3	A/C	C1	A	WATER RESISTANT GYP. BD. FROM FLOOR TO BOTTOM OF CEILING
BATH #3	F1	B2	WW3	A/C	WW3	A/C	WW3	A/C	WW3	A/C	C1	A	WATER RESISTANT GYP. BD. FROM FLOOR TO BOTTOM OF CEILING
BATH #4	F1	B2	WW3	A/C	WW3	A/C	WW3	A/C	WW3	A/C	C1	A	WATER RESISTANT GYP. BD. FROM FLOOR TO BOTTOM OF CEILING
PANTRY	F4	BI	WI	A	WI	A	WI	A	WI	A	C1	A	
STOR #1	F6	BI	WI	A	WI	A	WI	A	WI	A	C1	A	
STOR #2	F6	BI	WI	A	WI	A	WI	A	WI	A	C1	A	
STOR #3	F6	BI	WI	A	WI	A	WI	A	WI	A	C1	A	
HALLWAY #1	F4	BI	WI	A	WI	A	WI	A	WI	A	C2	C	
HALLWAY #2	F4	BI	WI	A	WI	A	WI	A	WI	A	C2	C	
HALLWAY #3	F4	BI	WI	A	WI	A	WI	A	WI	A	C2	C	
COMMUNICATION	F5	-	WI	A	W6	-	W6	-	W6	-	C1	A	FIRE RESISTANT PLYWOOD AT ALL WALLS
MECH	F5	-	WI	A	WI	A	WI	A	WI	A	C1	A	
COVERED PATIO	F5	-	W4	C	W4	C	W4	C	W4	C	C4	C	
APPARATUS	F6	B3	WW2	A/C	WW2	A/C	WW2	A/C	WW2	A/C	C3/C5	-	PROVIDE SANITARY WALL PANEL FROM 4'-0" TO 4'-6" - TYP. FOR ALL WALLS
LOCKER ROOM	F6	BVB3	WI	A	WI	A	WI	A	WI	A	C1	A	
JANITOR	F6	BVB3	W2	C	W2	C	W2	C	W2	C	C1	A	PROVIDE SANITARY WALL PANEL FOR WALLS C & D.
ICE MACHINE	F6	BVB3	W2	C	W2	C	W2	C	W2	C	C1	A	PROVIDE WATER RESISTANT GYP. BD.
FSR	F5	-	WI	A	WI	A	WI	A	WI	A	-	-	
SHOWER	F6	BVB3	WW2	A/C	WW2	A/C	-	-	WW2	A/C	-	-	PROVIDE WATER RESISTANT GYP. BD.
ELECTRICAL ROOM	F5	-	WI	A	WI	A	WI	A	WI	A	C1	A	
STORAGE BUILDING	F6	B3	W5	C	W5	C	W5	C	W5	C	C3	C	

MATERIAL KEY

FLOOR

F1	CERAMIC TILE OVER FULL MORTAR BED 2X2 PORCELAIN TILE
F2	CARPET TILES
F3	RESILIENT ATHLETIC FLOORING
F4	LUXURY VINYL TILE
F5	EXPOSED CONCRETE, MEDIUM BROOM
F6	EXPOSED CONCRETE, SMOOTH TROWEL FINISH (SEALED)

BASE

B1	TOP SET BASE
B2	CERAMIC TILE COVERED
B3	6" CONC. BASE W/ SEALER

WALL


W1	GYPSUM BOARD, 5/8" TYPE X "MOLD RESISTANT" AND TEXTURED (MEDIUM ORANGE PEEL FINISH (PROVIDE WATER RESISTIVE TYPE BEHIND WET AREAS))
W2	SANITARY WALL PANEL
W3	CERAMIC TILE OVER CEMENT BOARD
W4	CEMENT PLASTER (STUCCO)
W5	5/8" PLYWOOD, FULL HEIGHT
W6	3/4" PLYWOOD, FULL HEIGHT
W7	WALL COVER WITH DIGITAL IMAGE

CEILING

C1	5/8" TYPE X GYPSUM BOARD, TAPED AND TEXTURED w/ MEDIUM ORANGE PEEL FINISH (PROVIDE MOISTURE RESISTIVE TYPE IN WET AREAS)
C2	2X2 LAY IN CEILING
C3	PAINT EXPOSED STRUCTURE
C4	CEMENT PLASTER CEILING
C5	VINYL FACED INSULATION

FINISH KEY


A	PAINT, EGGSHELL
B	CERAMIC TILE
C	MANUFACTURER'S FINISH (CLEAN)

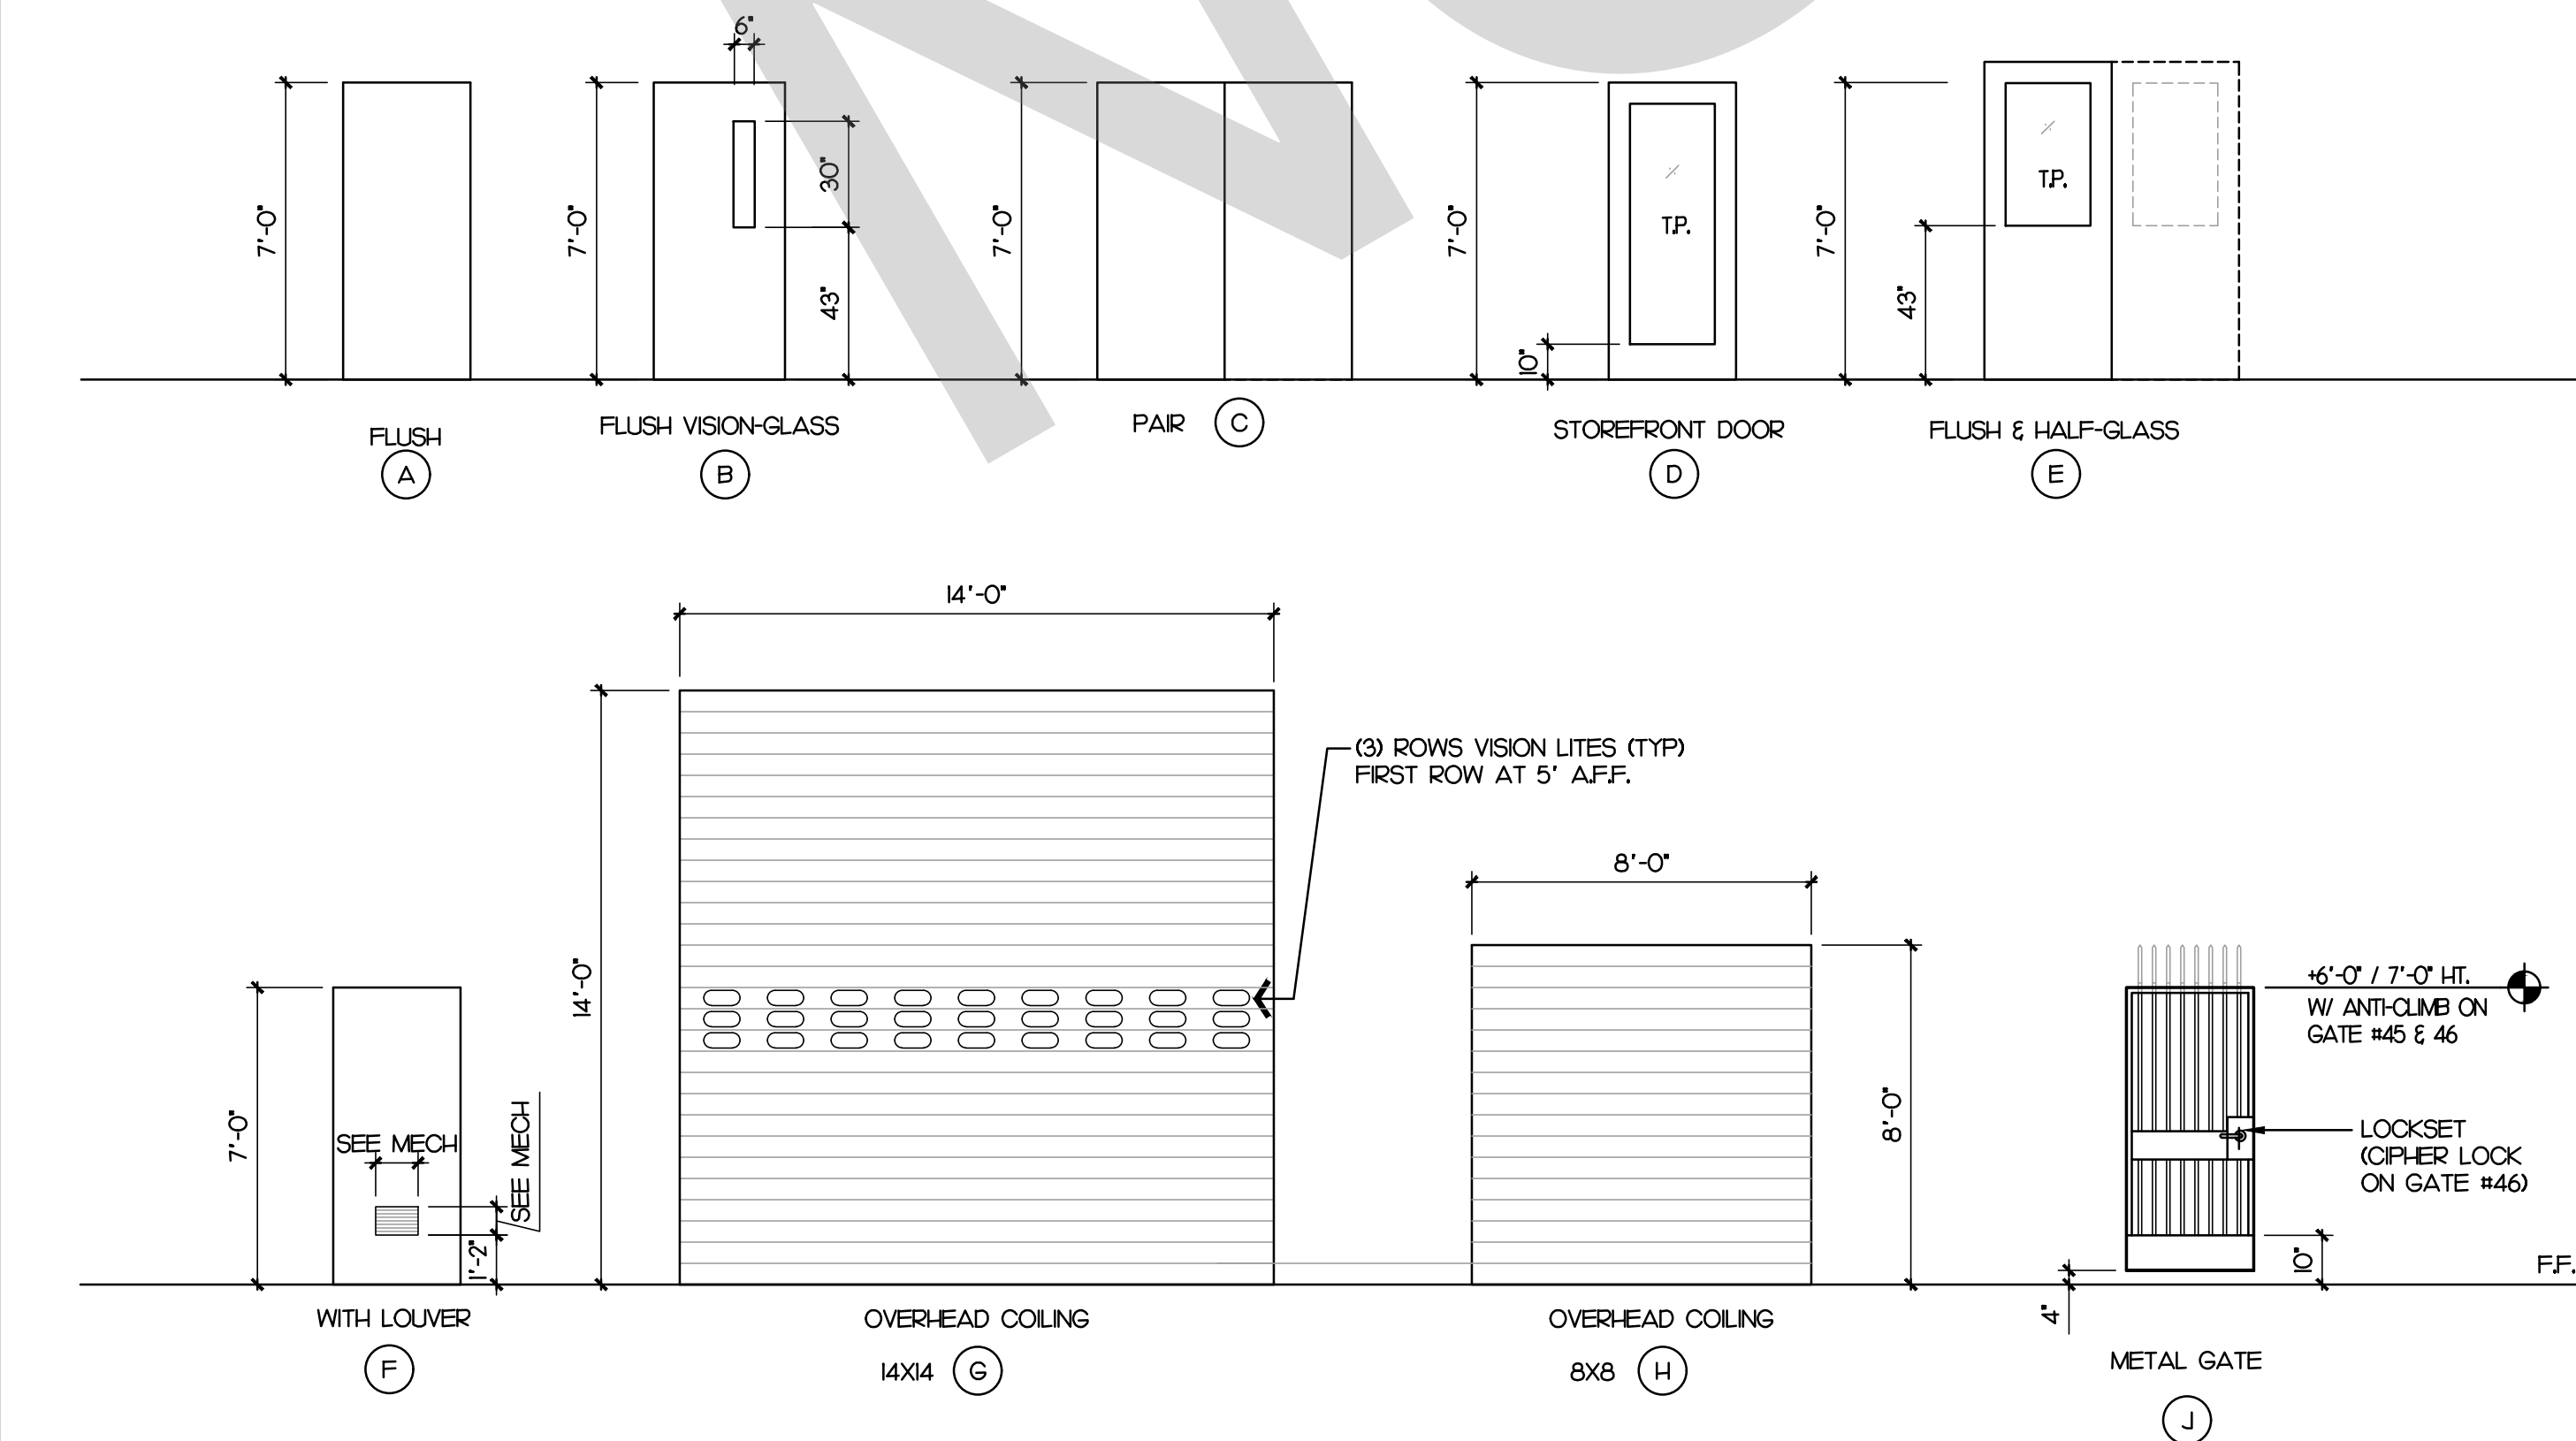

DOOR TYPES

SCALE: 1/4"=1'-0"

WINDOW SCHEDULE

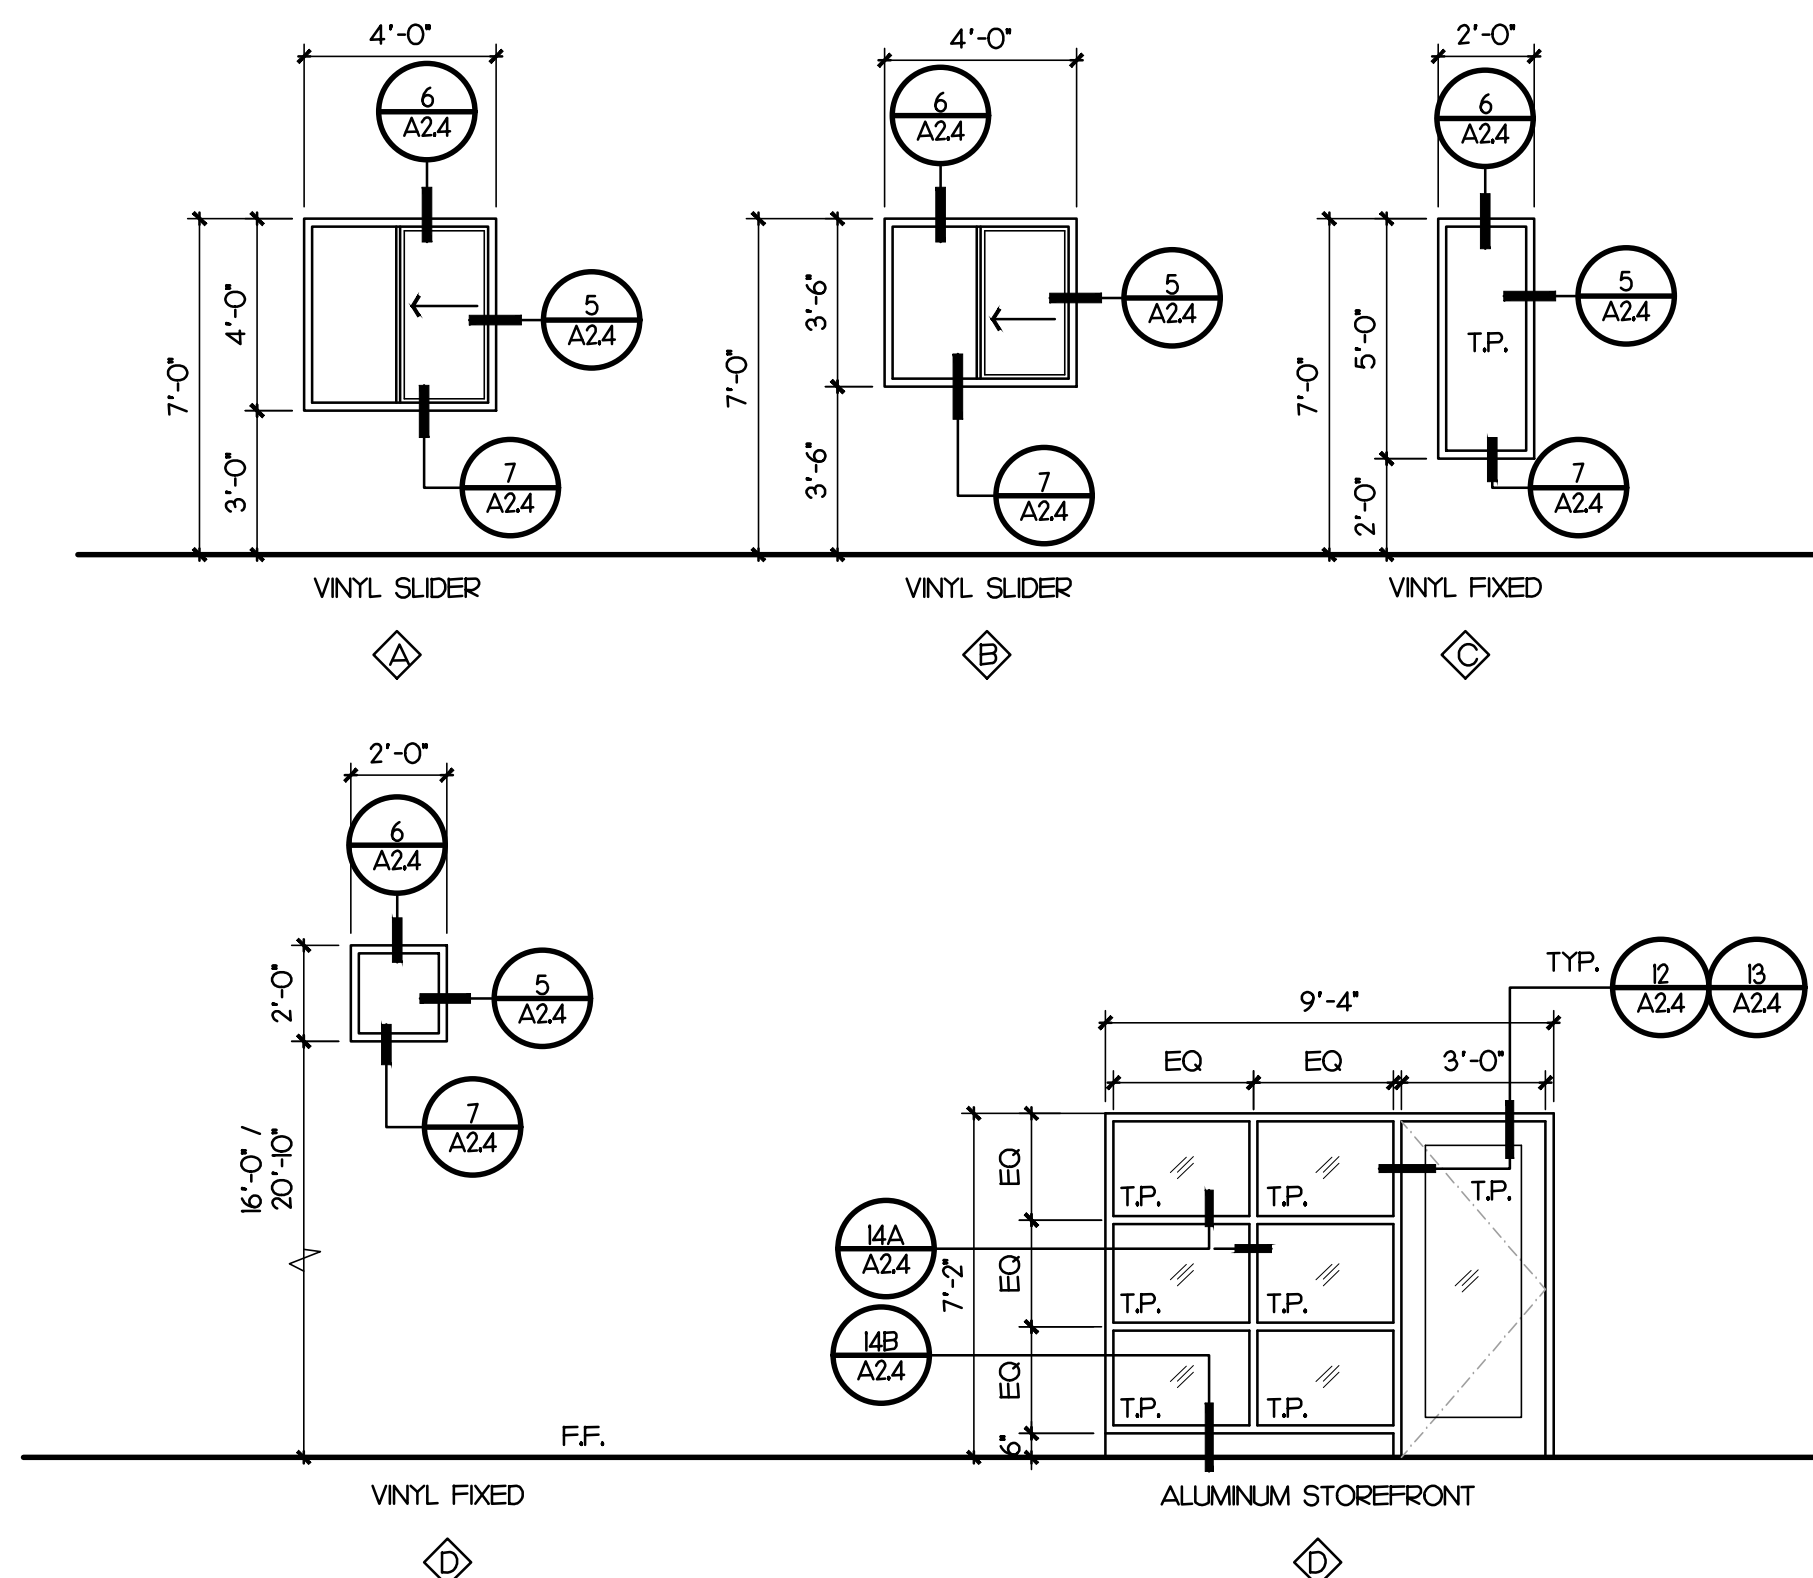

WINDOW LEGEND


- ◇ = WINDOW TYPES PER REFERENCE PLAN, A2.1 & A2.2
- TP. = TEMPERED PLATE

WINDOW NOTES

- ALL EXTERIOR WINDOWS DUAL GLAZED. FIELD MEASURE ALL ROUGH OPENINGS PRIOR TO FABRICATION/INSTALLATION.
- ALL WINDOWS SIZES SHOWN ARE NOMINAL SIZE. SEE MFR. INFORMATION FOR ROUGH OPENING SIZES.

WINDOW BLINDS LEGEND

- DM DUAL MANUAL
- SE SINGLE MOTORIZED
- SM SINGLE MANUAL

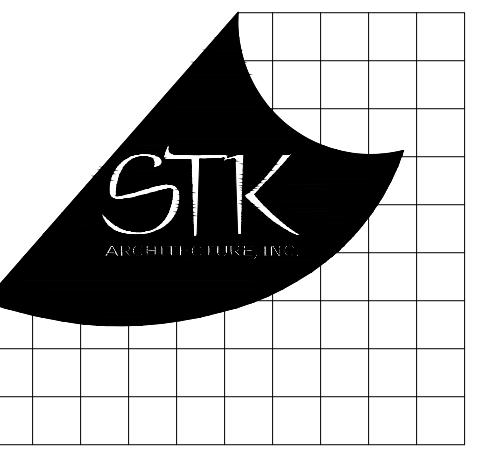

4205 ZEVOR DR., TEMECULA, CALIFORNIA 92590-3760
Phone: 951.296.8110 Fax: 951.296.6079 Email: stk@stkinc.com

CONSULTANT

PROJECT ADMINISTERED BY:
SAN BERNARDINO COUNTY
PROJECT & FACILITIES
MANAGEMENT DEPARTMENT

385 N. ARROWHEAD AVE.
SAN BERNARDINO, CA 92415

PROJECT NAME:
SAN BERNARDINO
COUNTY FIRE
DEPARTMENT:
FIRE STATION 226

PROJECT # 10J0J032

CIP #21-037

CAFM # SAB198

APN # 0273-011-22

1920 DEL ROSA AVE N.
SAN BERNARDINO,
CA 92404

ISSUE INFORMATION:


DATE:	INFORMATION:
04-11-2022	20% CD SET
04-28-2022	50% CD SET
06-15-2022	95% CD SET
09-16-2022	95% CD- 3rd BAY
10-03-2022	PLAN CHECK

SHEET INFORMATION:


STK PROJECT NO.: 374-154-21
SCALE: AS NOTED
DATE: JANUARY 2021
DRAWING NAME:

SEAL:




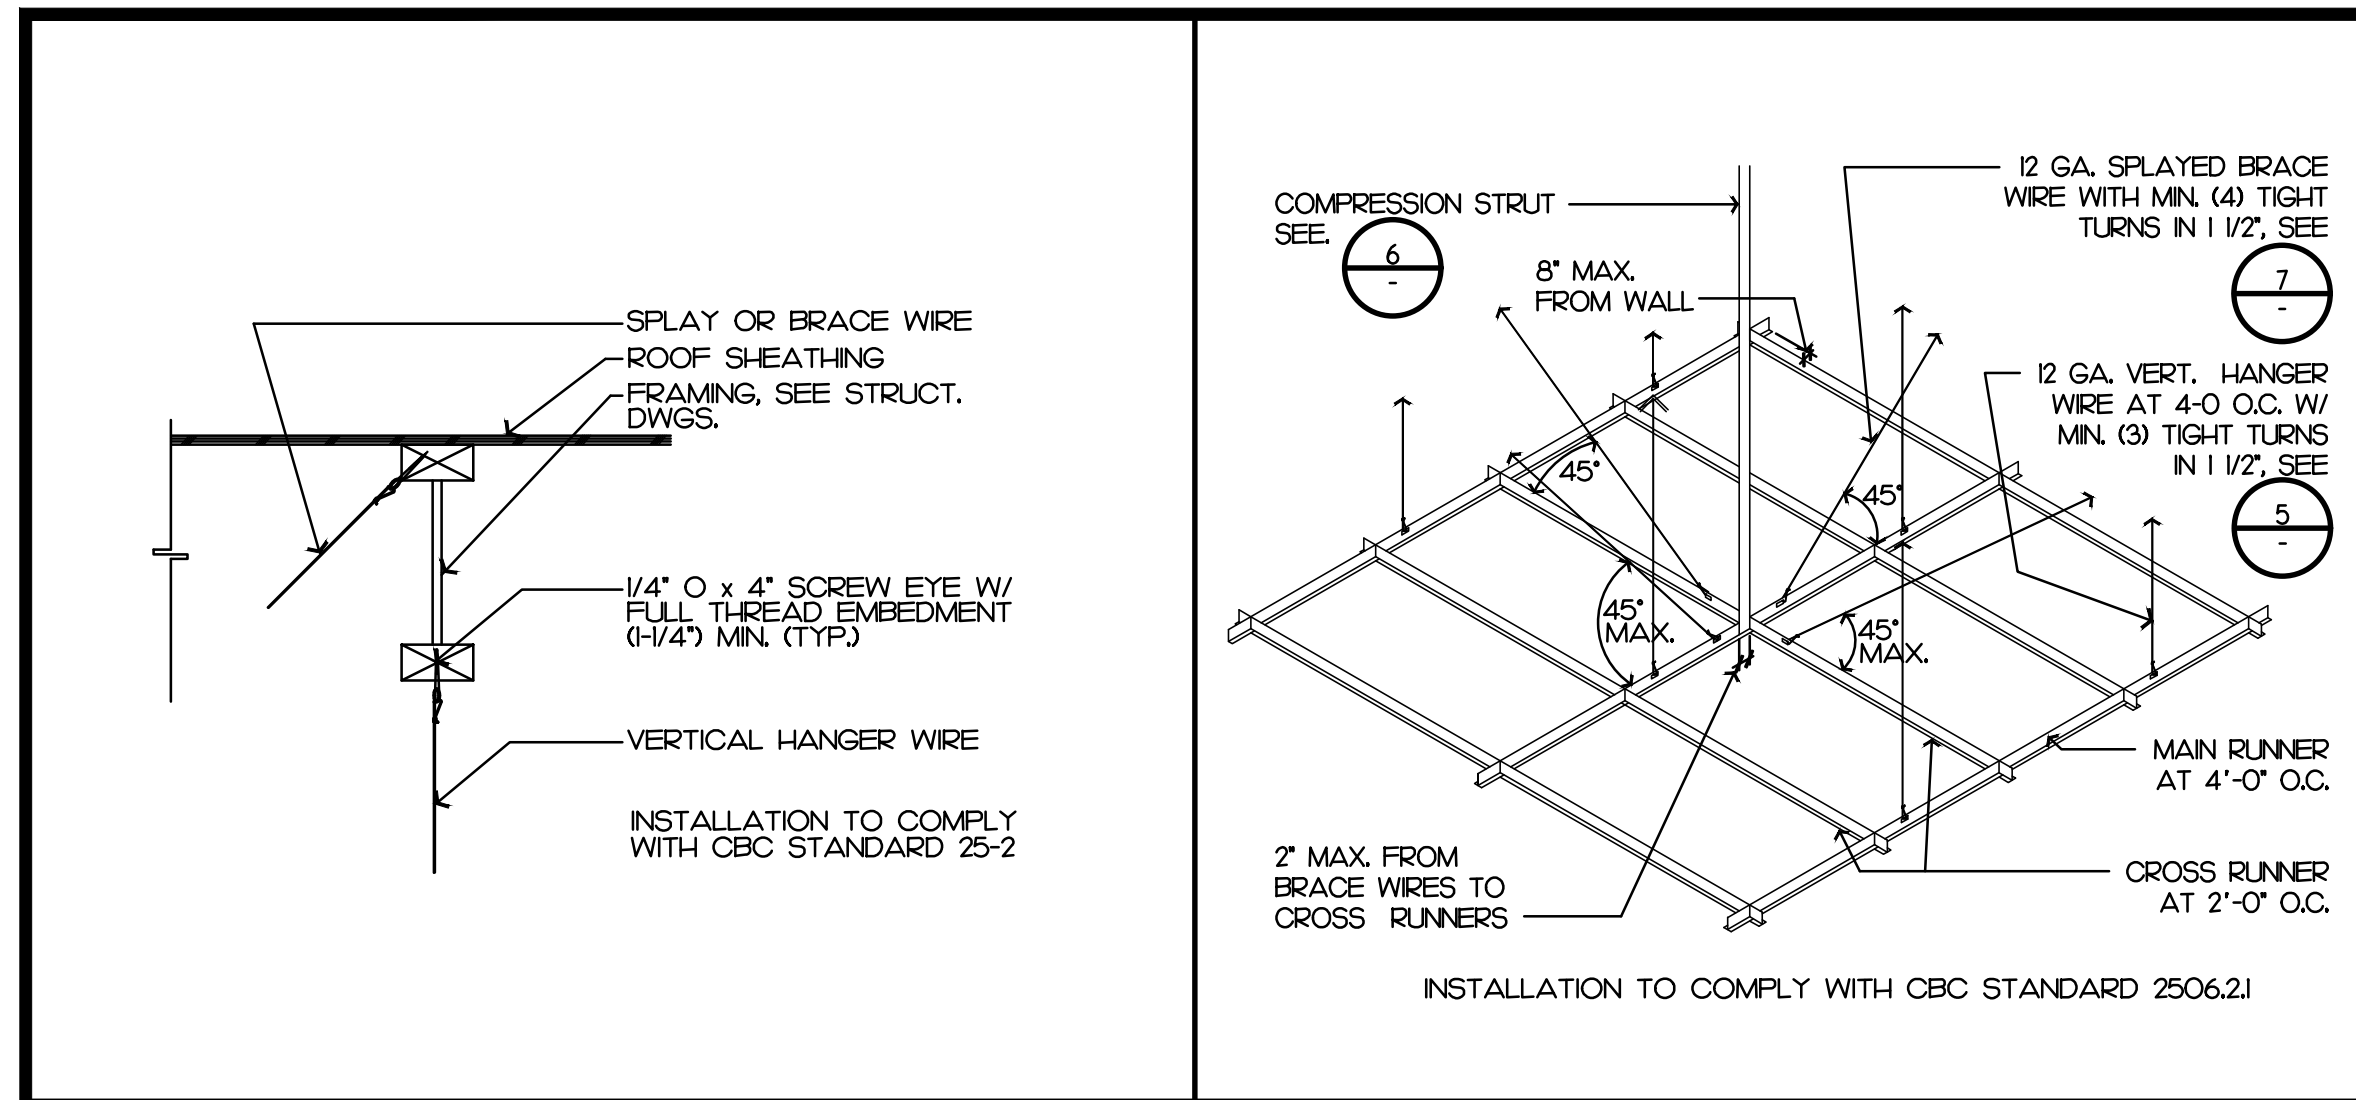


DETAIL 7 SCALE: 6'-4"=1' 7

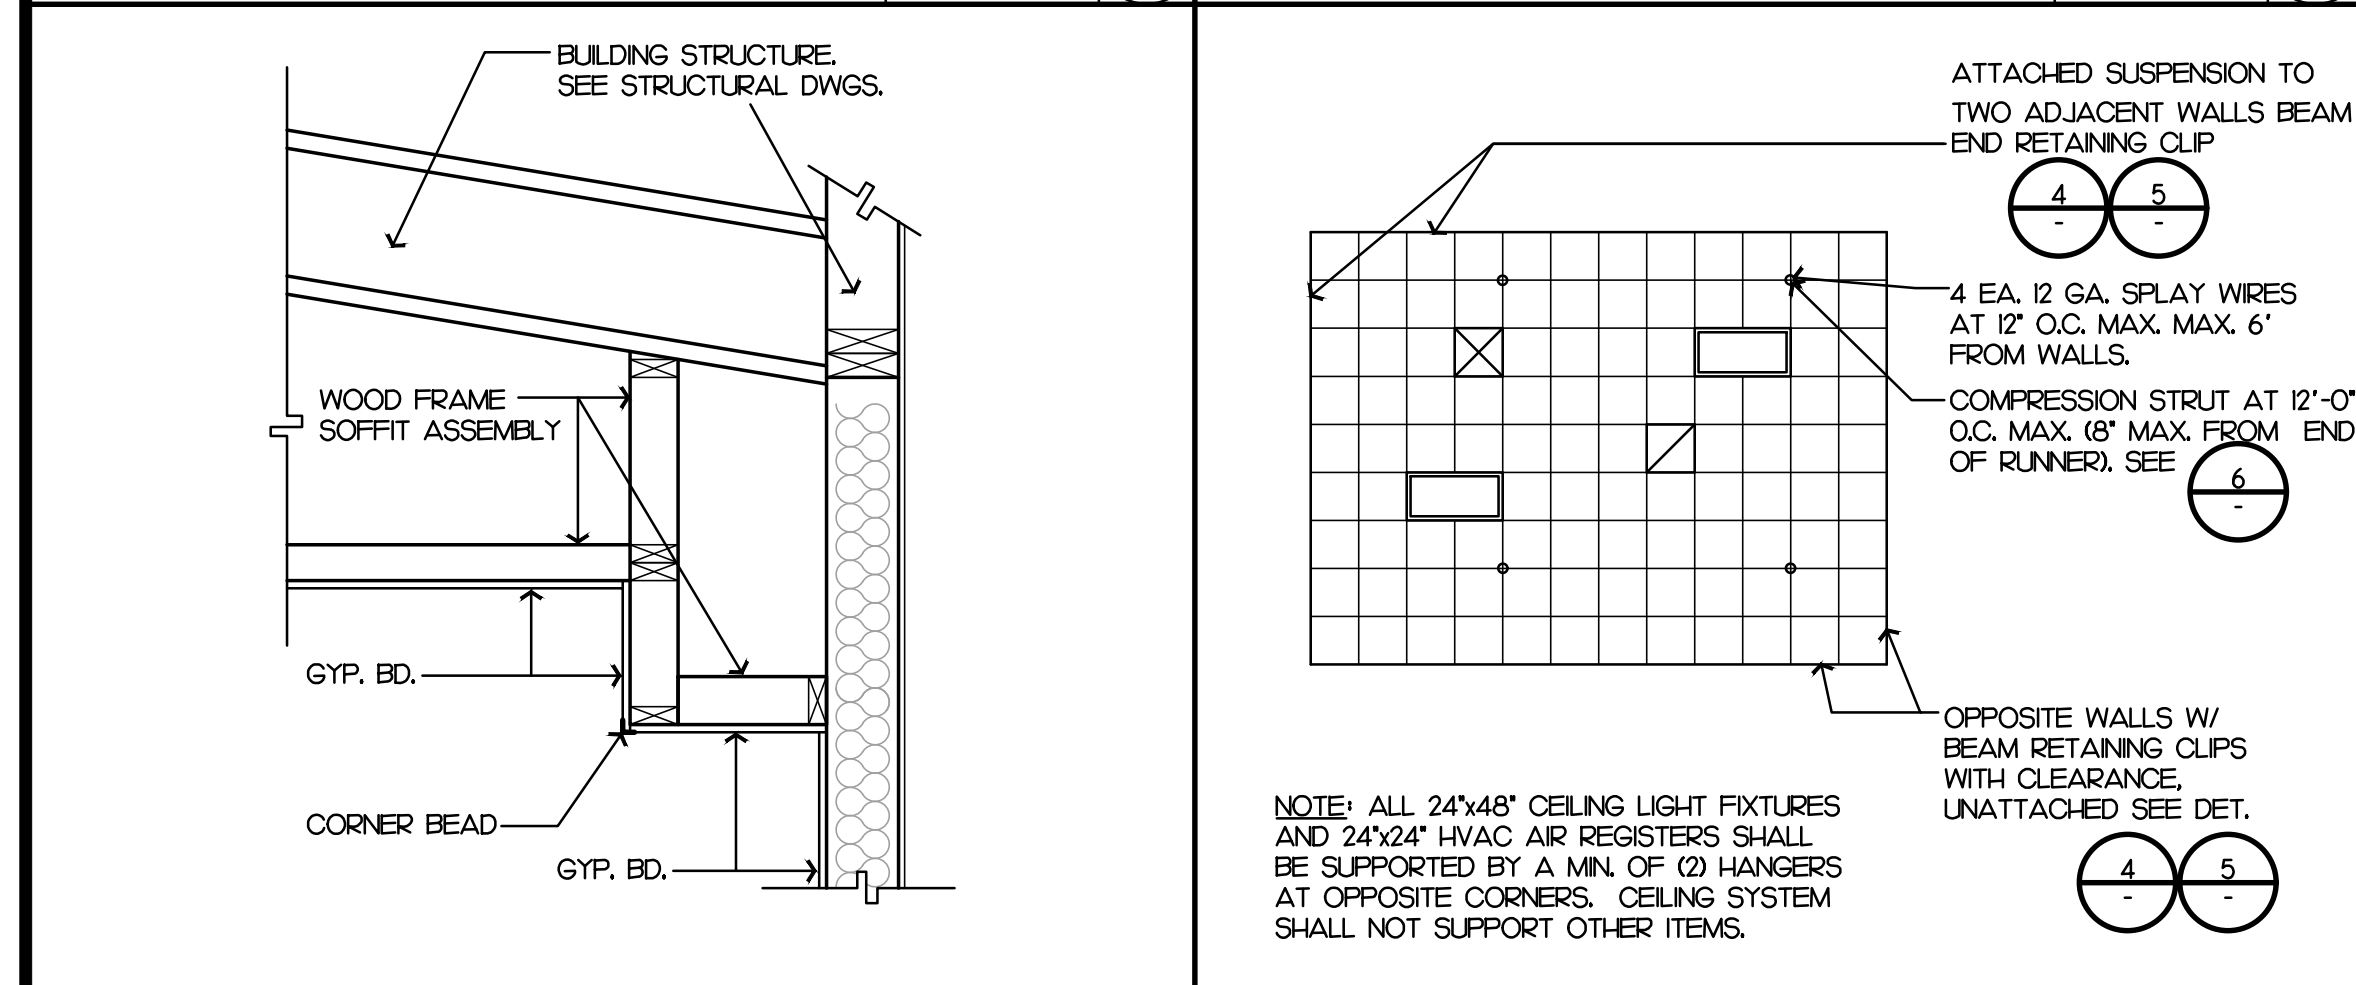


SOFFIT DETAIL 8 SCALE: 3/4'-1'-0" 8

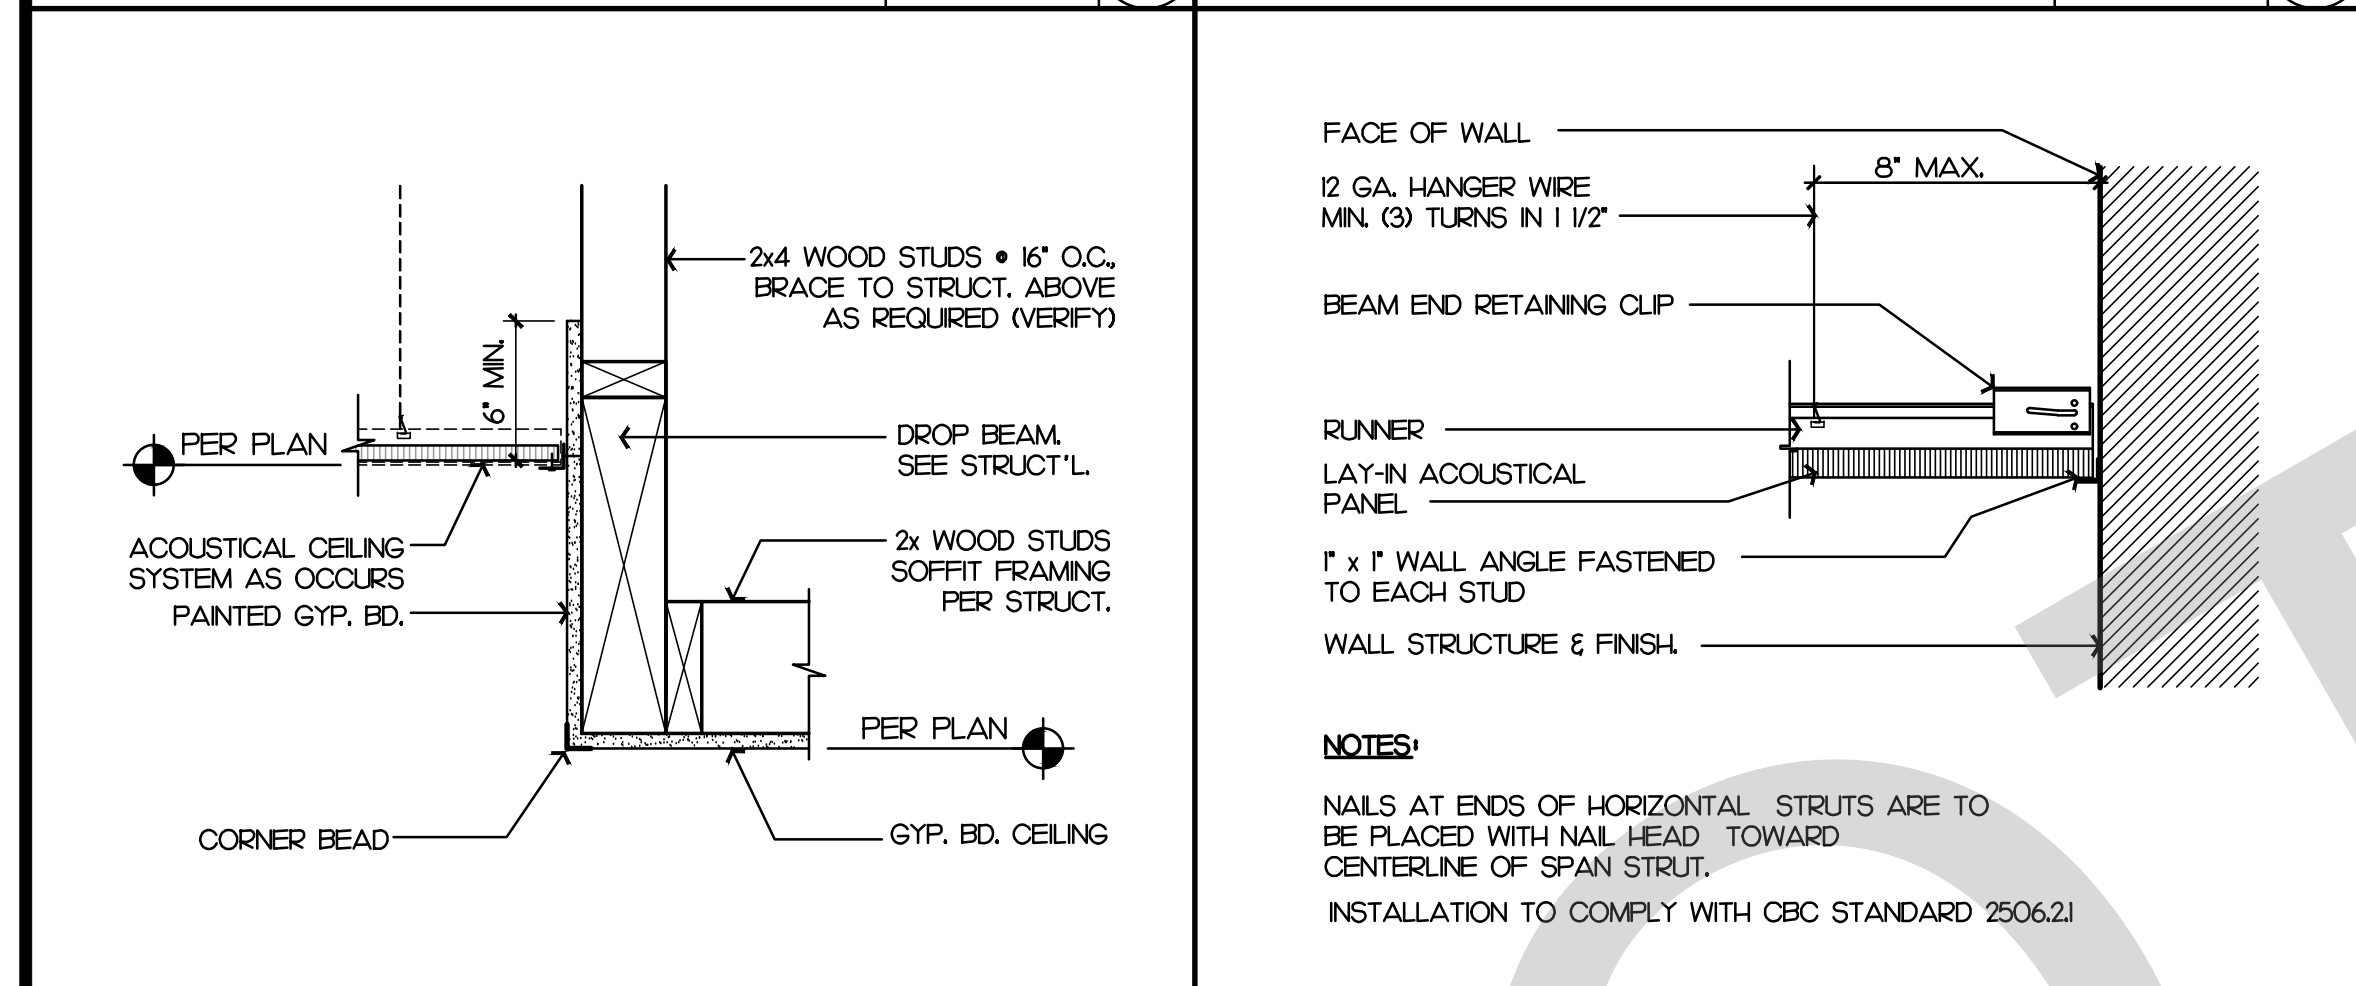


SOFFIT DETAIL 9 SCALE: 3/4'-1'-0" 9

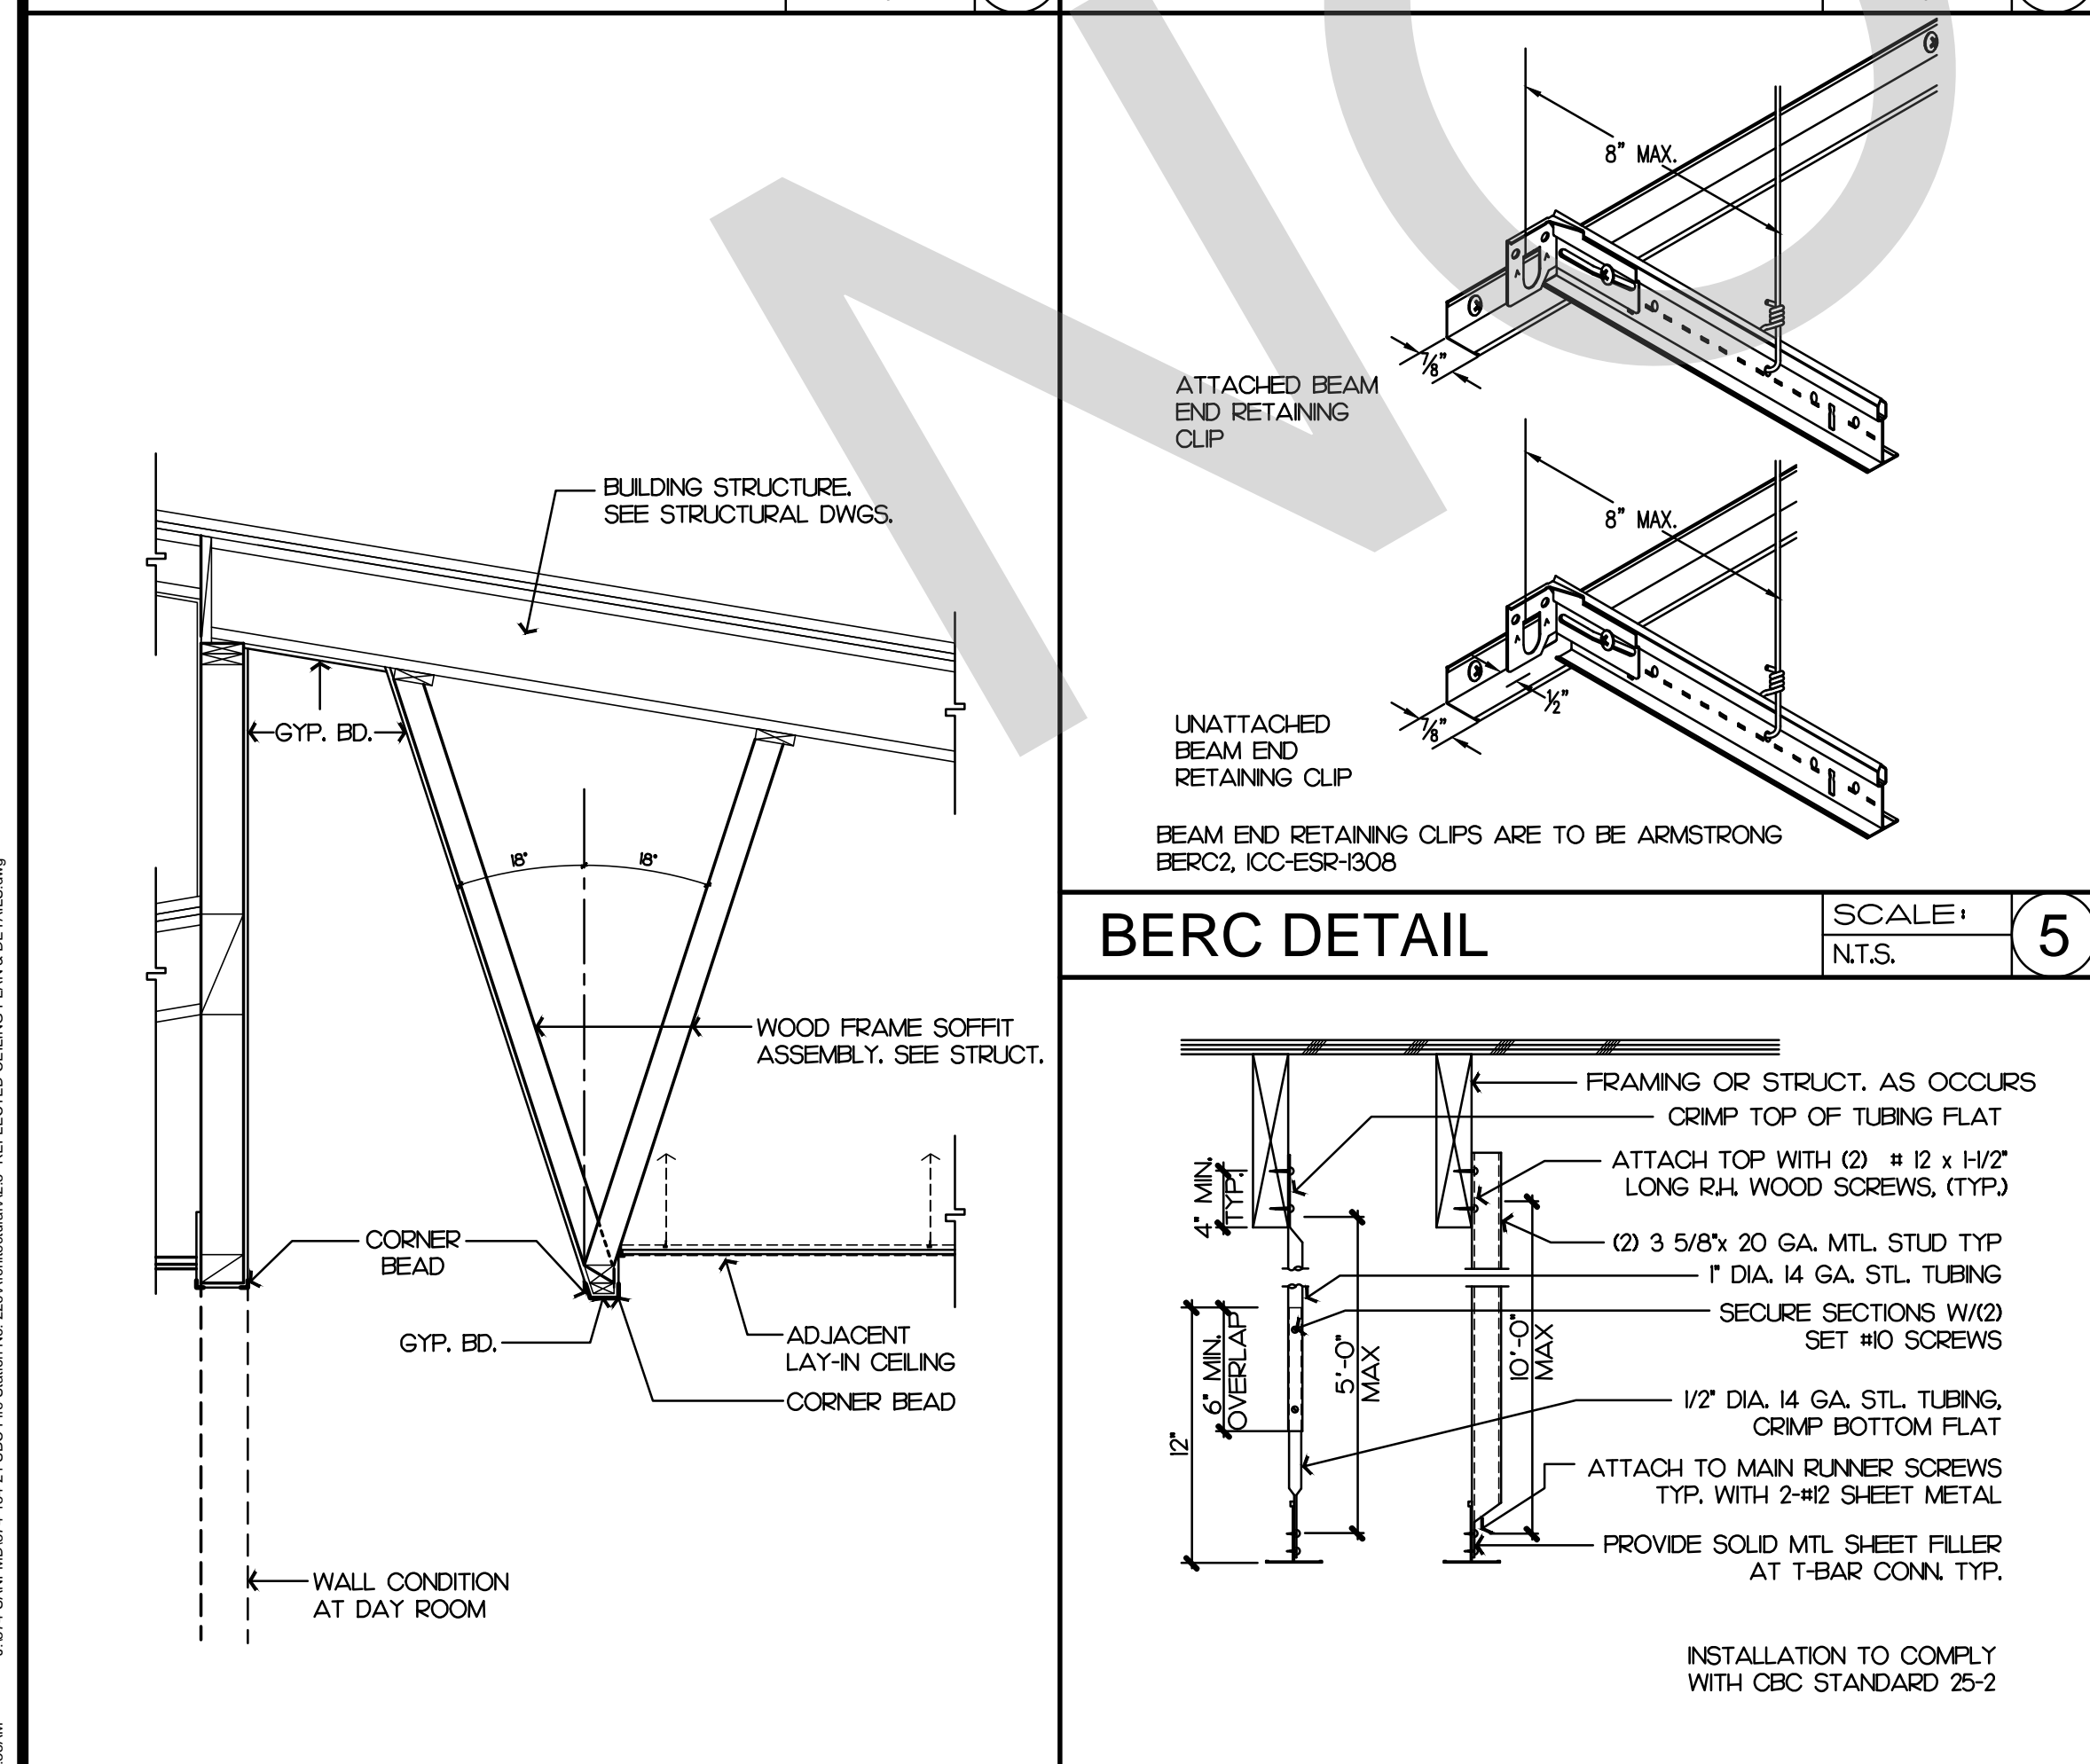


SOFFIT DETAIL 10 SCALE: 1/2'-1'-0" 10

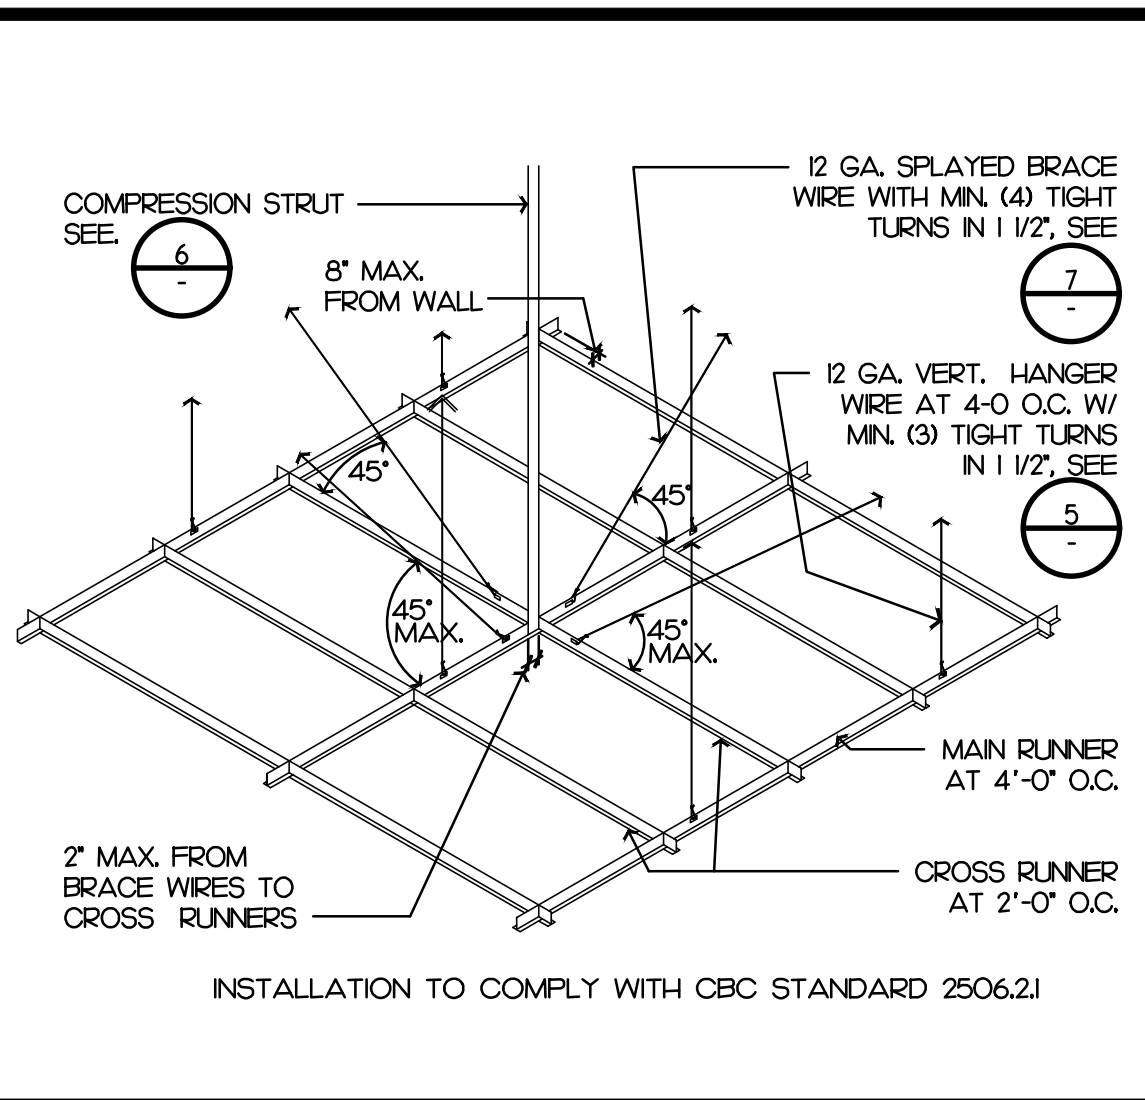


CEILING SYSTEM PLAN 2 SCALE: 3'-4"=1' 2

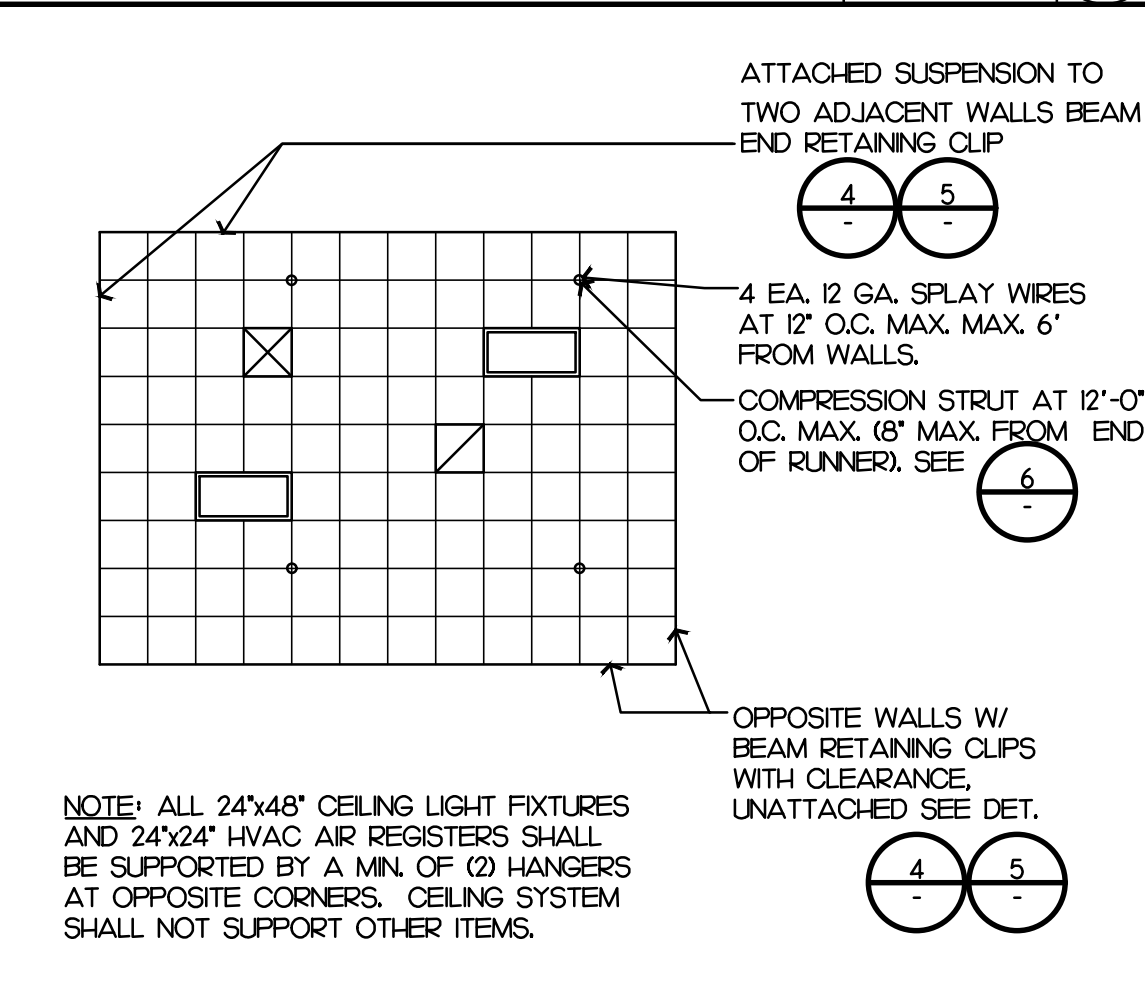


CEILING SYSTEM PLAN 3 SCALE: 1/8'-1'-0" 3

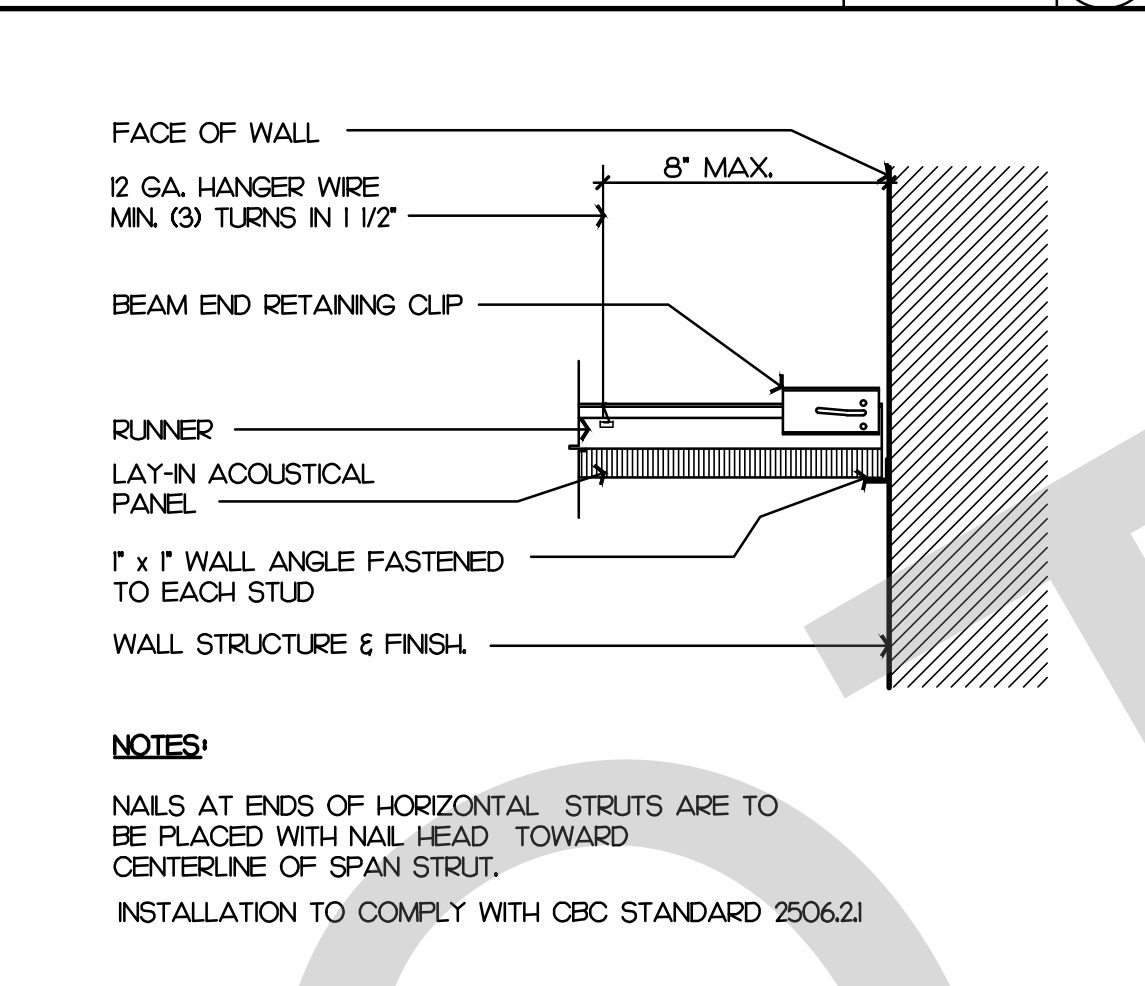

GRID BEAM END 4 SCALE: 1/2'-1'-0" 4

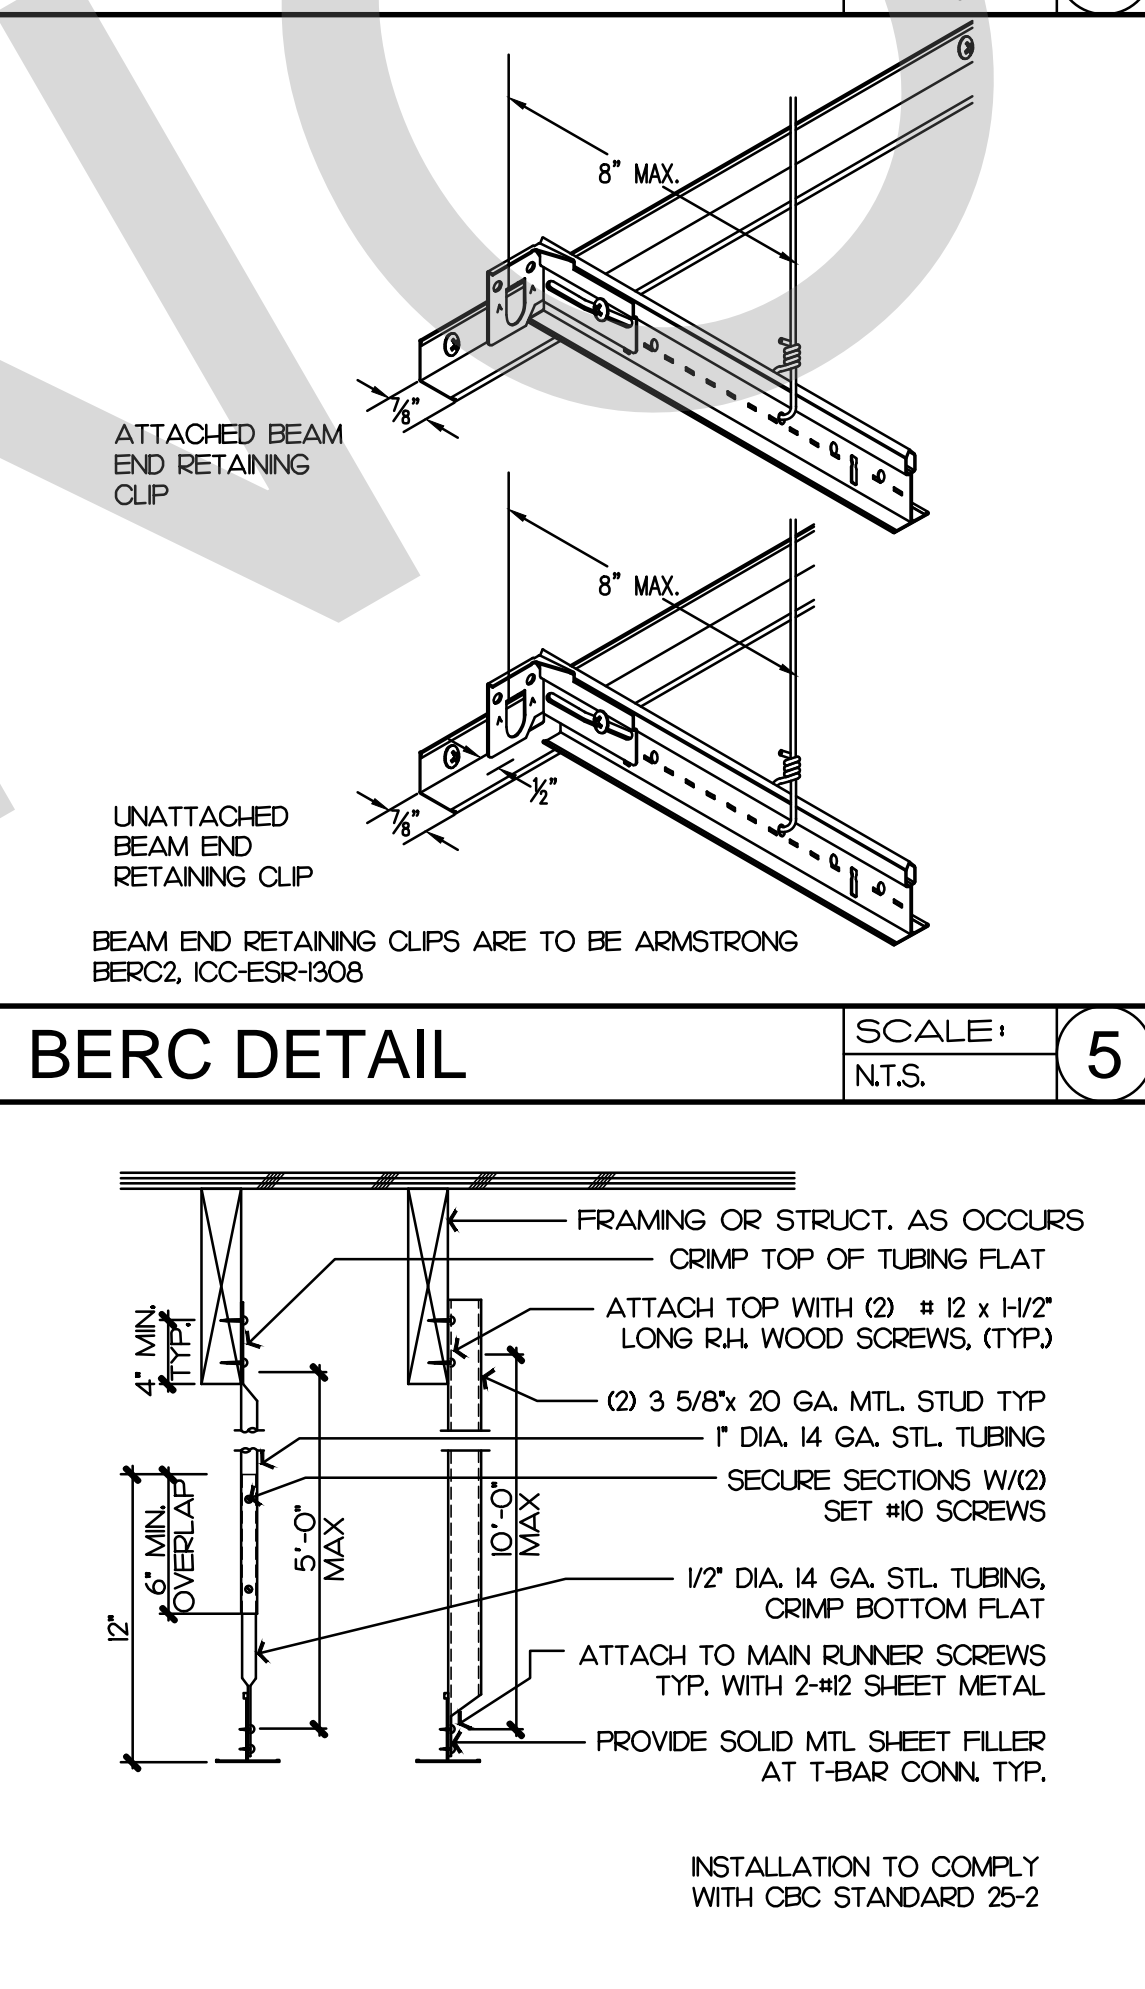

BERC DETAIL 5 SCALE: N.T.S. 5

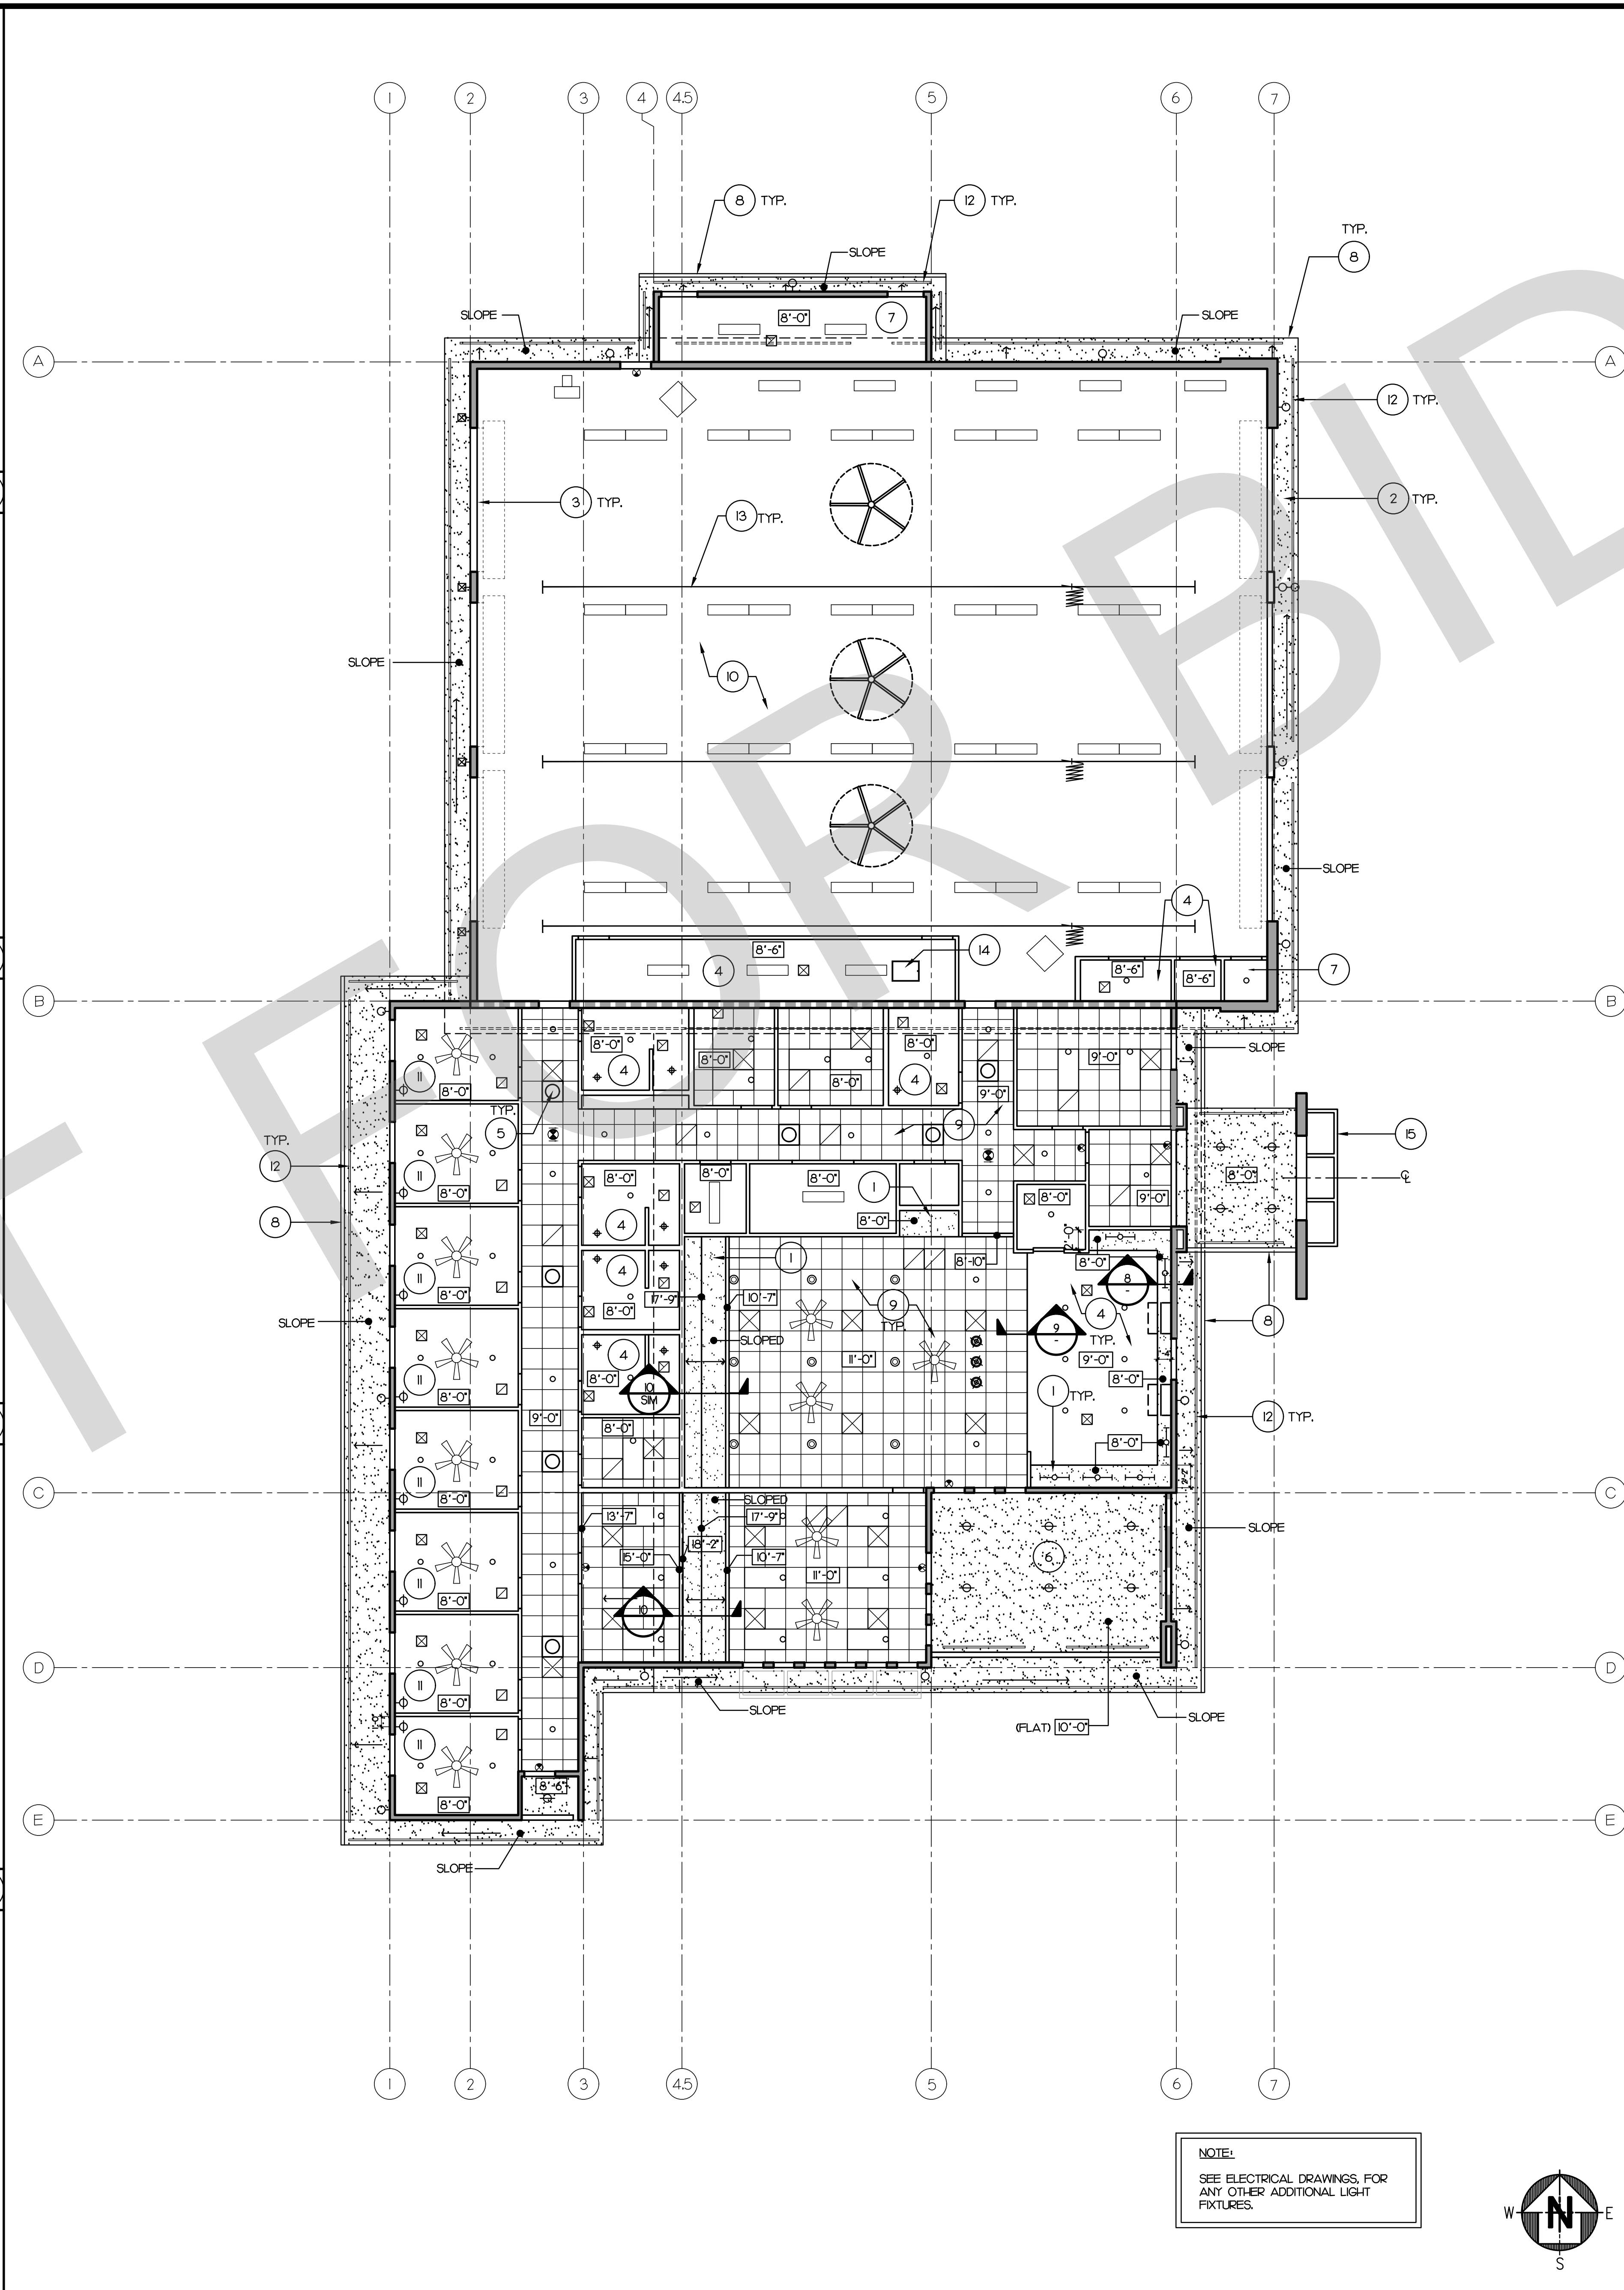

REFLECTED CEILING PLAN 1 SCALE: 1/8'-1'-0" 1

KEY NOTE

1. GYP. BD. SOFFIT OVER 2x FRAMING • 24" O.C.
2. CEMENT PLASTER / SLOPED CEILING.
3. OVERHEAD COILING DOOR - TYP. OF 4.
4. GYP. BOARD CEILING W/ CONTROL JOINT.
5. TUBULAR SKYLIGHT - TYP. OF 7.
6. CEMENT PLASTER / FLAT CEILING OVER PLYWOOD & ROOF INSULATION.
7. OPEN TO STRUCTURE.
8. GALV. SHEET METAL GUTTER & DOWNSPOUT.
9. 2x2 LAY IN CEILING TILE
10. EXPOSED INSULATION ON CEILING. PAINT EXPOSED STRUCTURE AND MPE SYSTEMS, ETC.
11. 1/2 HOUR RATED GYPSUM BOARD CEILING. PROVIDE DAMPERS AT AC REGISTERS. PROVIDE FIRE RATED RECESSED LIGHT FIXTURE ENCLOSURES. SEE MECH. AND ELECT. SEE 1A/22 FOR UL ASSEMBLY.
12. CONTINUOUS 2" EAVE SOFFIT VENT.
13. VEHICLE EXHAUST SYSTEM. REFER TO MECH.
14. 22x30 ACCESS PANEL FOR ALERT SYSTEMS.
15. STEEL AWNING. LOCATE AT CENTER OF OPENING.

SYMBOL LEGEND

- 1' x 4' SURFACE MOUNTED FLUORESCENT FIXTURE
- 2' x 4' LAY IN RECESSED LED LIGHT FIXTURE
- 2' x 2' LAY IN RECESSED LED LIGHT FIXTURE
- RECESSED DOWN LIGHT FIXTURE
- RECESSED DOWN LIGHT FIXTURE ON DIMMER SWITCH
- SURFACE MOUNTED FIXTURE UNDER CABINET. (NOTE: NO EXPOSED CONDUIT. USE ELECT. WIRING W/HP)
- WALL MOUNTED READING LIGHT FIXTURE AT 5'-0" AFF.
- PENDANT LIGHT FIXTURE
- EXTERIOR RECESSED DOWN LIGHT FIXTURE
- EXTERIOR WALL LIGHT FIXTURE
- EXTERIOR WALL MOUNTED AREA LIGHT
- EXIT SIGN
- SUPPLY AIR REGISTER
- RETURN AIR REGISTER
- EXHAUST FAN
- TUBULAR SKYLIGHT
- CEILING FAN MANUFACTURE: MINKA AIRE MODEL: F766-WHF 44". EXT. RATED WALL CONTROL-WC400 INSTALL AT 7'-0" AFF. CLEARANCE MIN.
- LARGE FORMAT CEILING FAN



PROJECT ADMINISTERED BY:
SAN BERNARDINO COUNTY
PROJECT & FACILITIES
MANAGEMENT DEPARTMENT

385 N. ARROWHEAD AVE.
SAN BERNARDINO, CA 92415

PROJECT NAME:
SAN BERNARDINO
COUNTY FIRE
DEPARTMENT:
FIRE STATION 226

PROJECT # 10.10.032
CIP #21-037
CAFM # SABI98
APN # 0273-011-22

1920 DEL ROSA AVE N.
SAN BERNARDINO,
CA 92404

ISSUE INFORMATION:	
DATE:	INFORMATION:
04-11-2022	20% CD SET
04-28-2022	50% CD SET
06-15-2022	95% CD SET
09-16-2022	95% CD- 3rd BAY
10-03-2022	PLAN CHECK


SHEET INFORMATION:	
STK PROJECT NO.:	374-154-21
SCALE:	AS NOTED
DATE:	JANUARY 2021
PLOT DATE:	
DRAWING NAME:	



SHEET TITLE:
REFLECTED
CEILING PLAN
& DETAILS

SHEET NO.:


A2.5

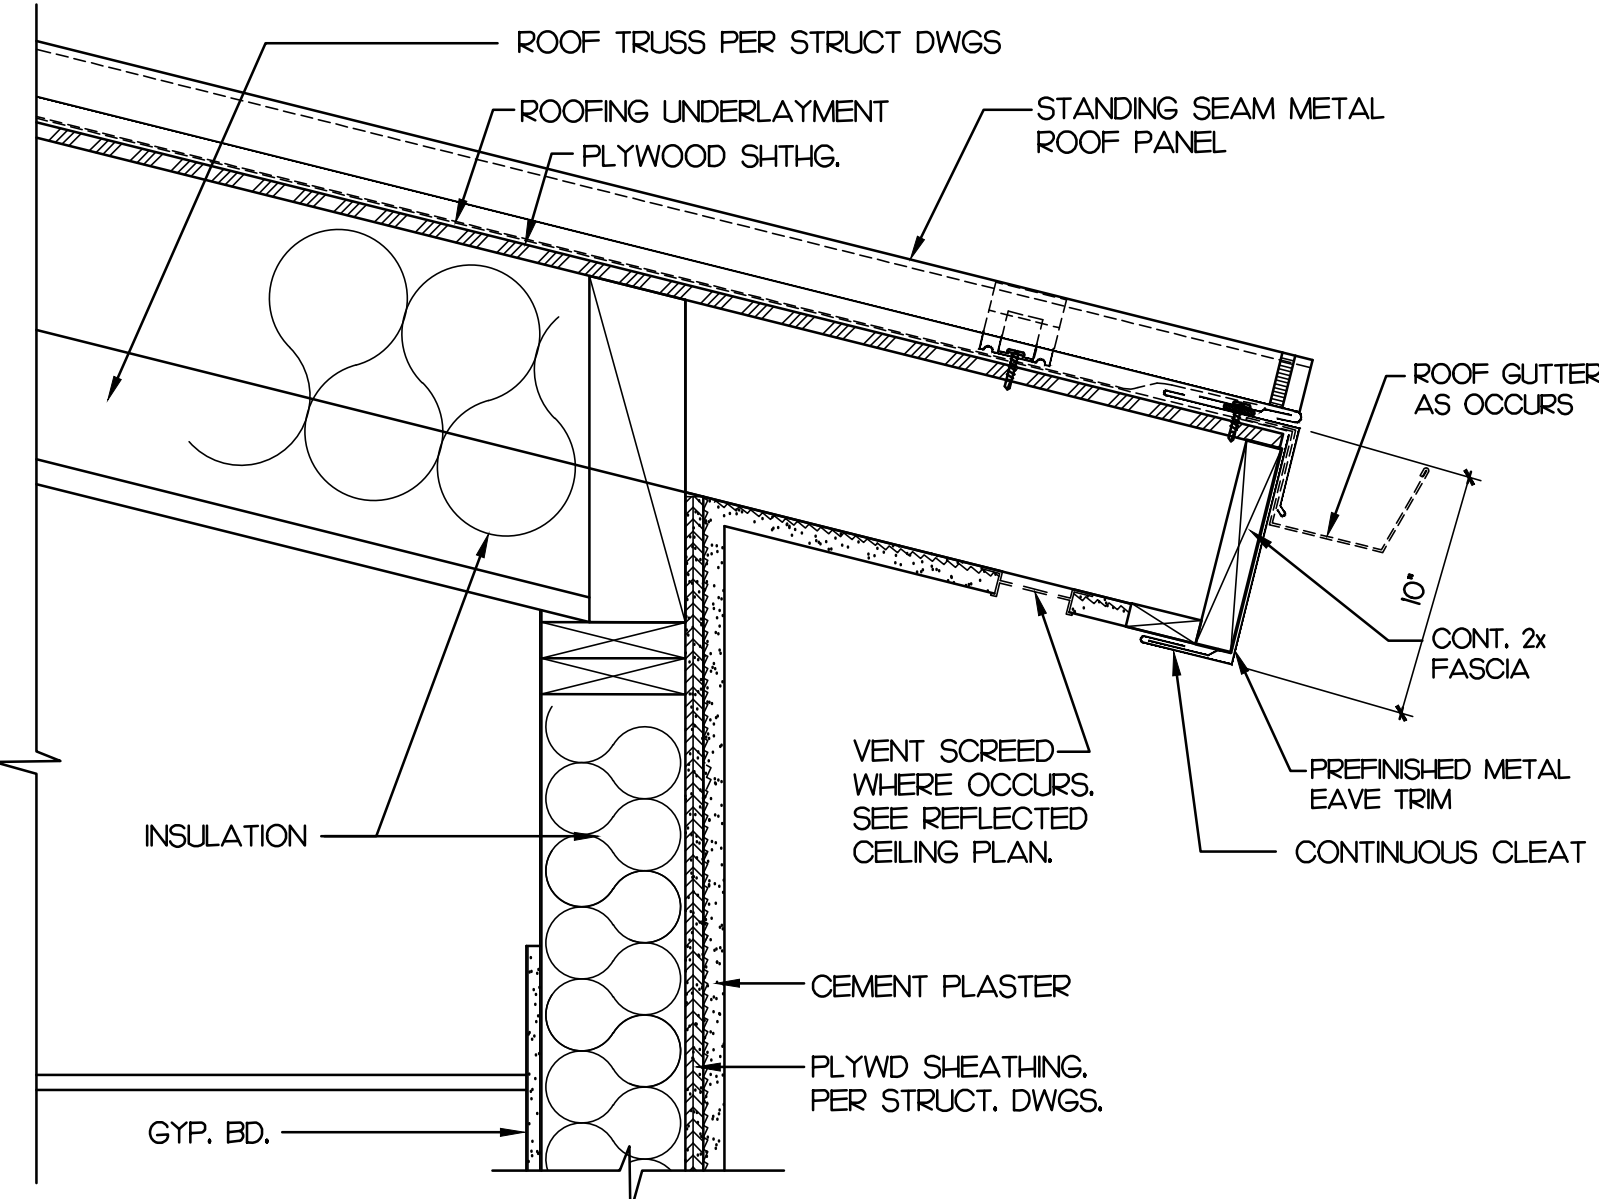

ROOF EAVE

SCALE: 1 1/2"=1'-0"


13

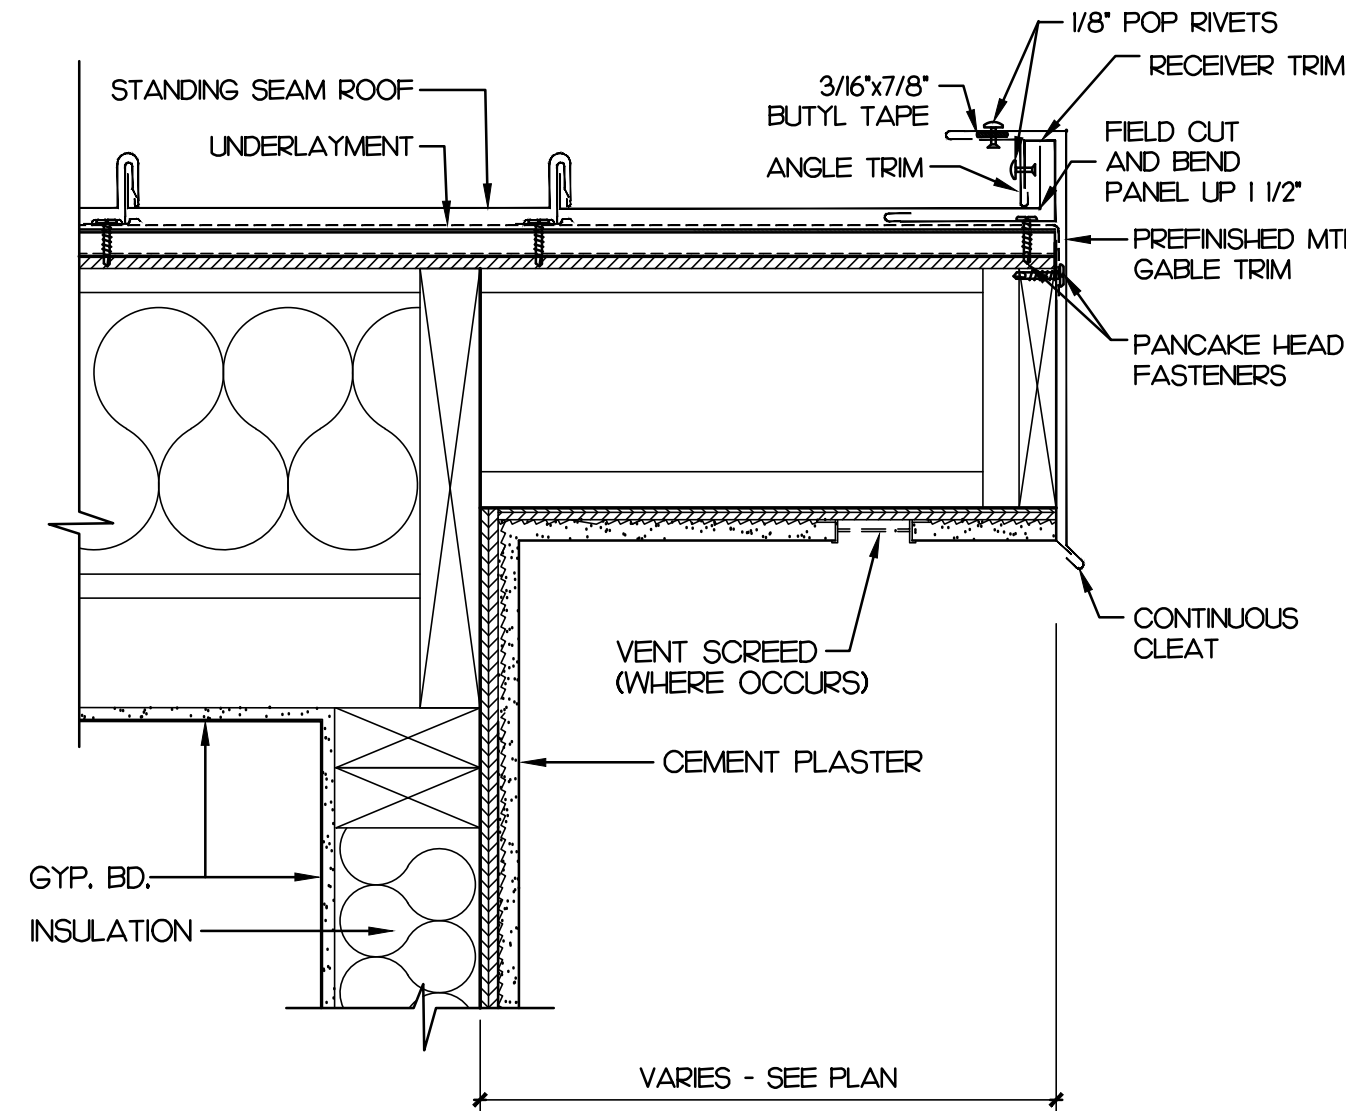

ROOF RAKE

SCALE: 1 1/2"=1'-0"


14

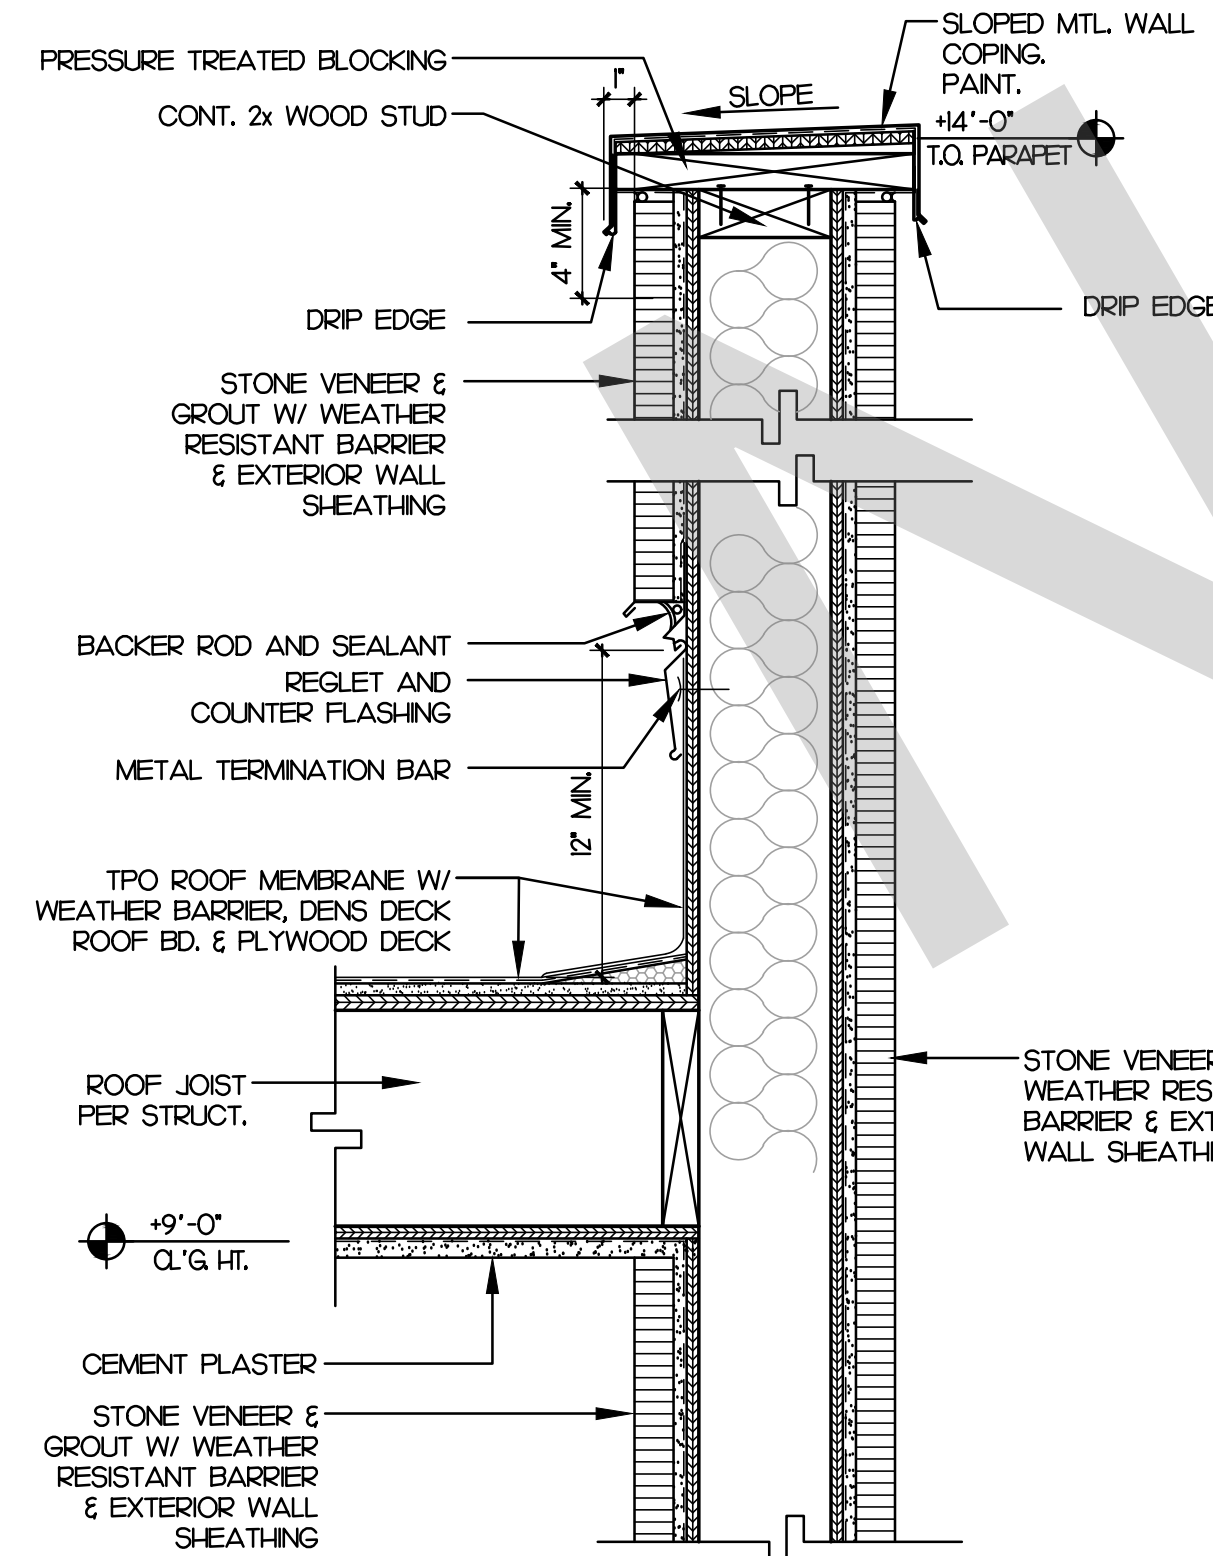

ENTRY WALL

SCALE: 1 1/2"=1'-0"


16

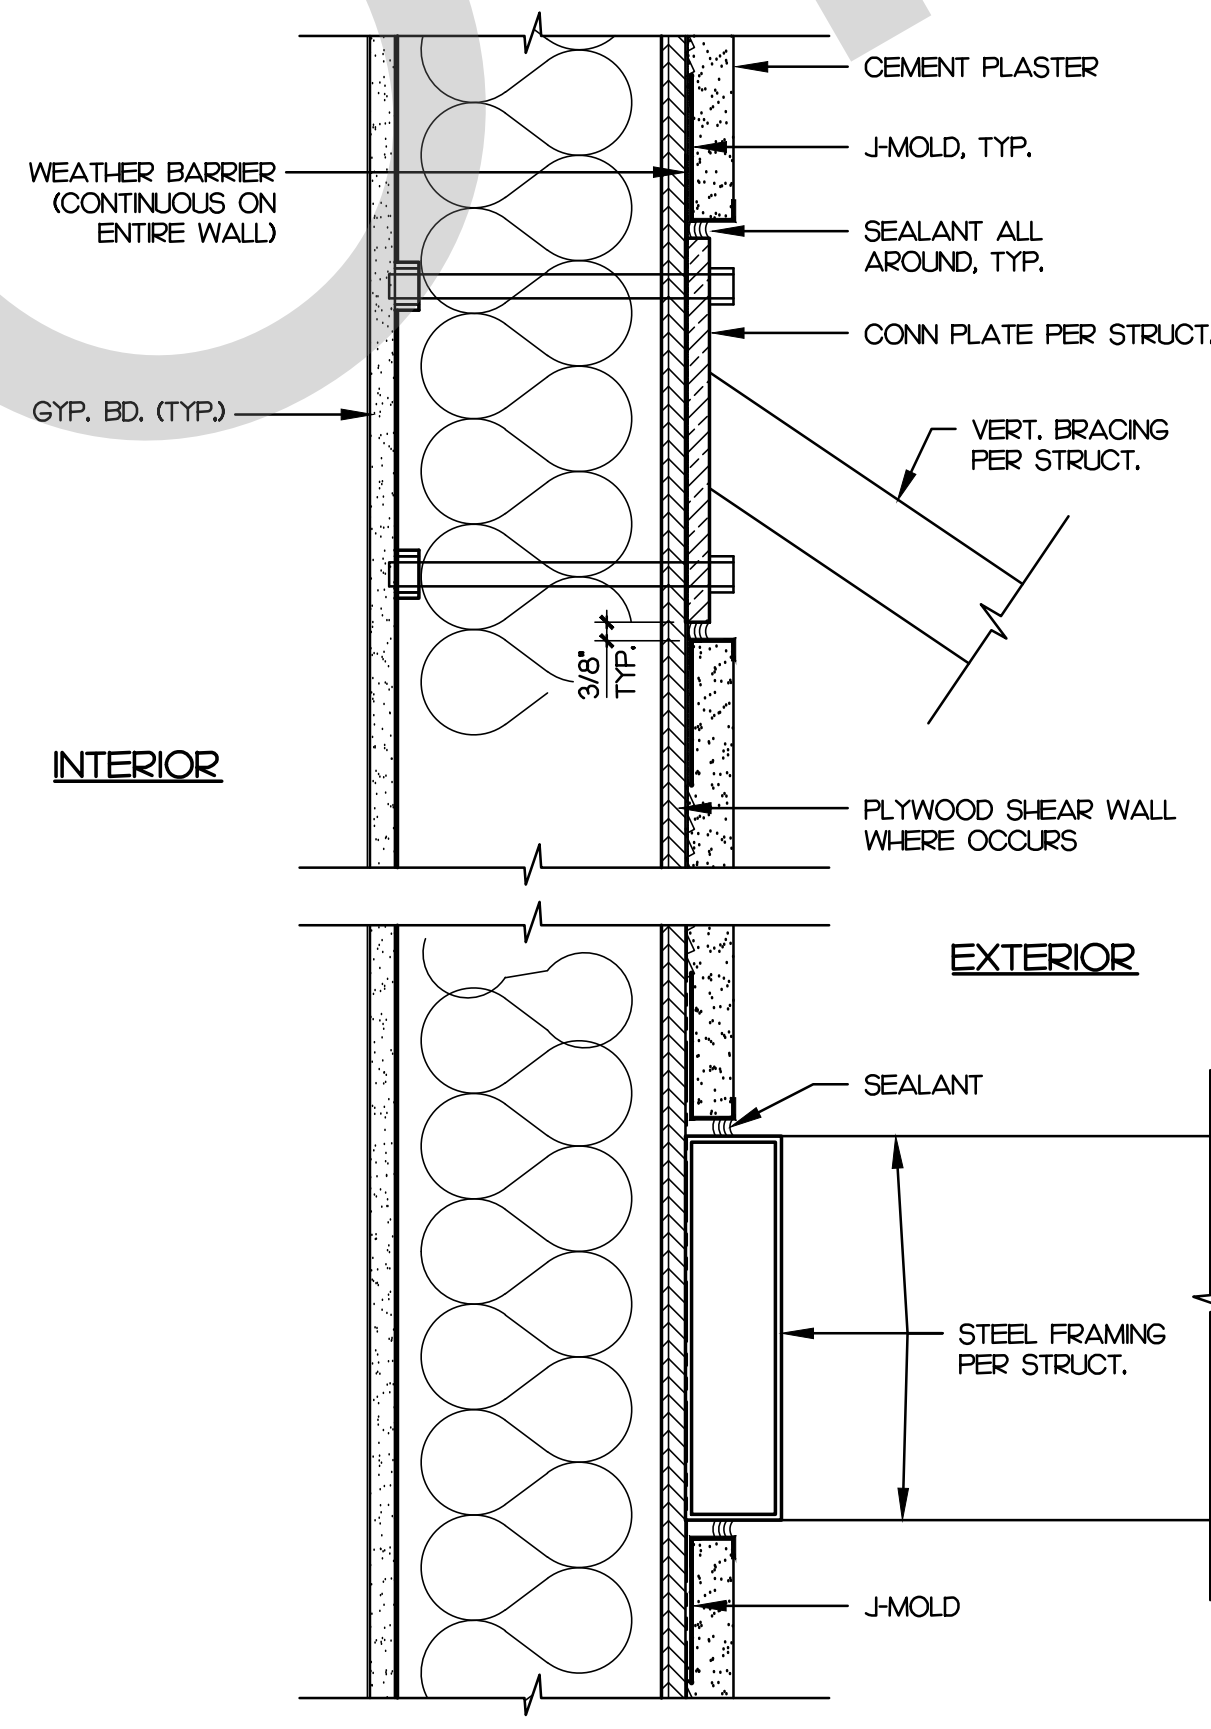

CANOPY TO WALL FLASHING

SCALE: 1 1/2"=1'-0"

12

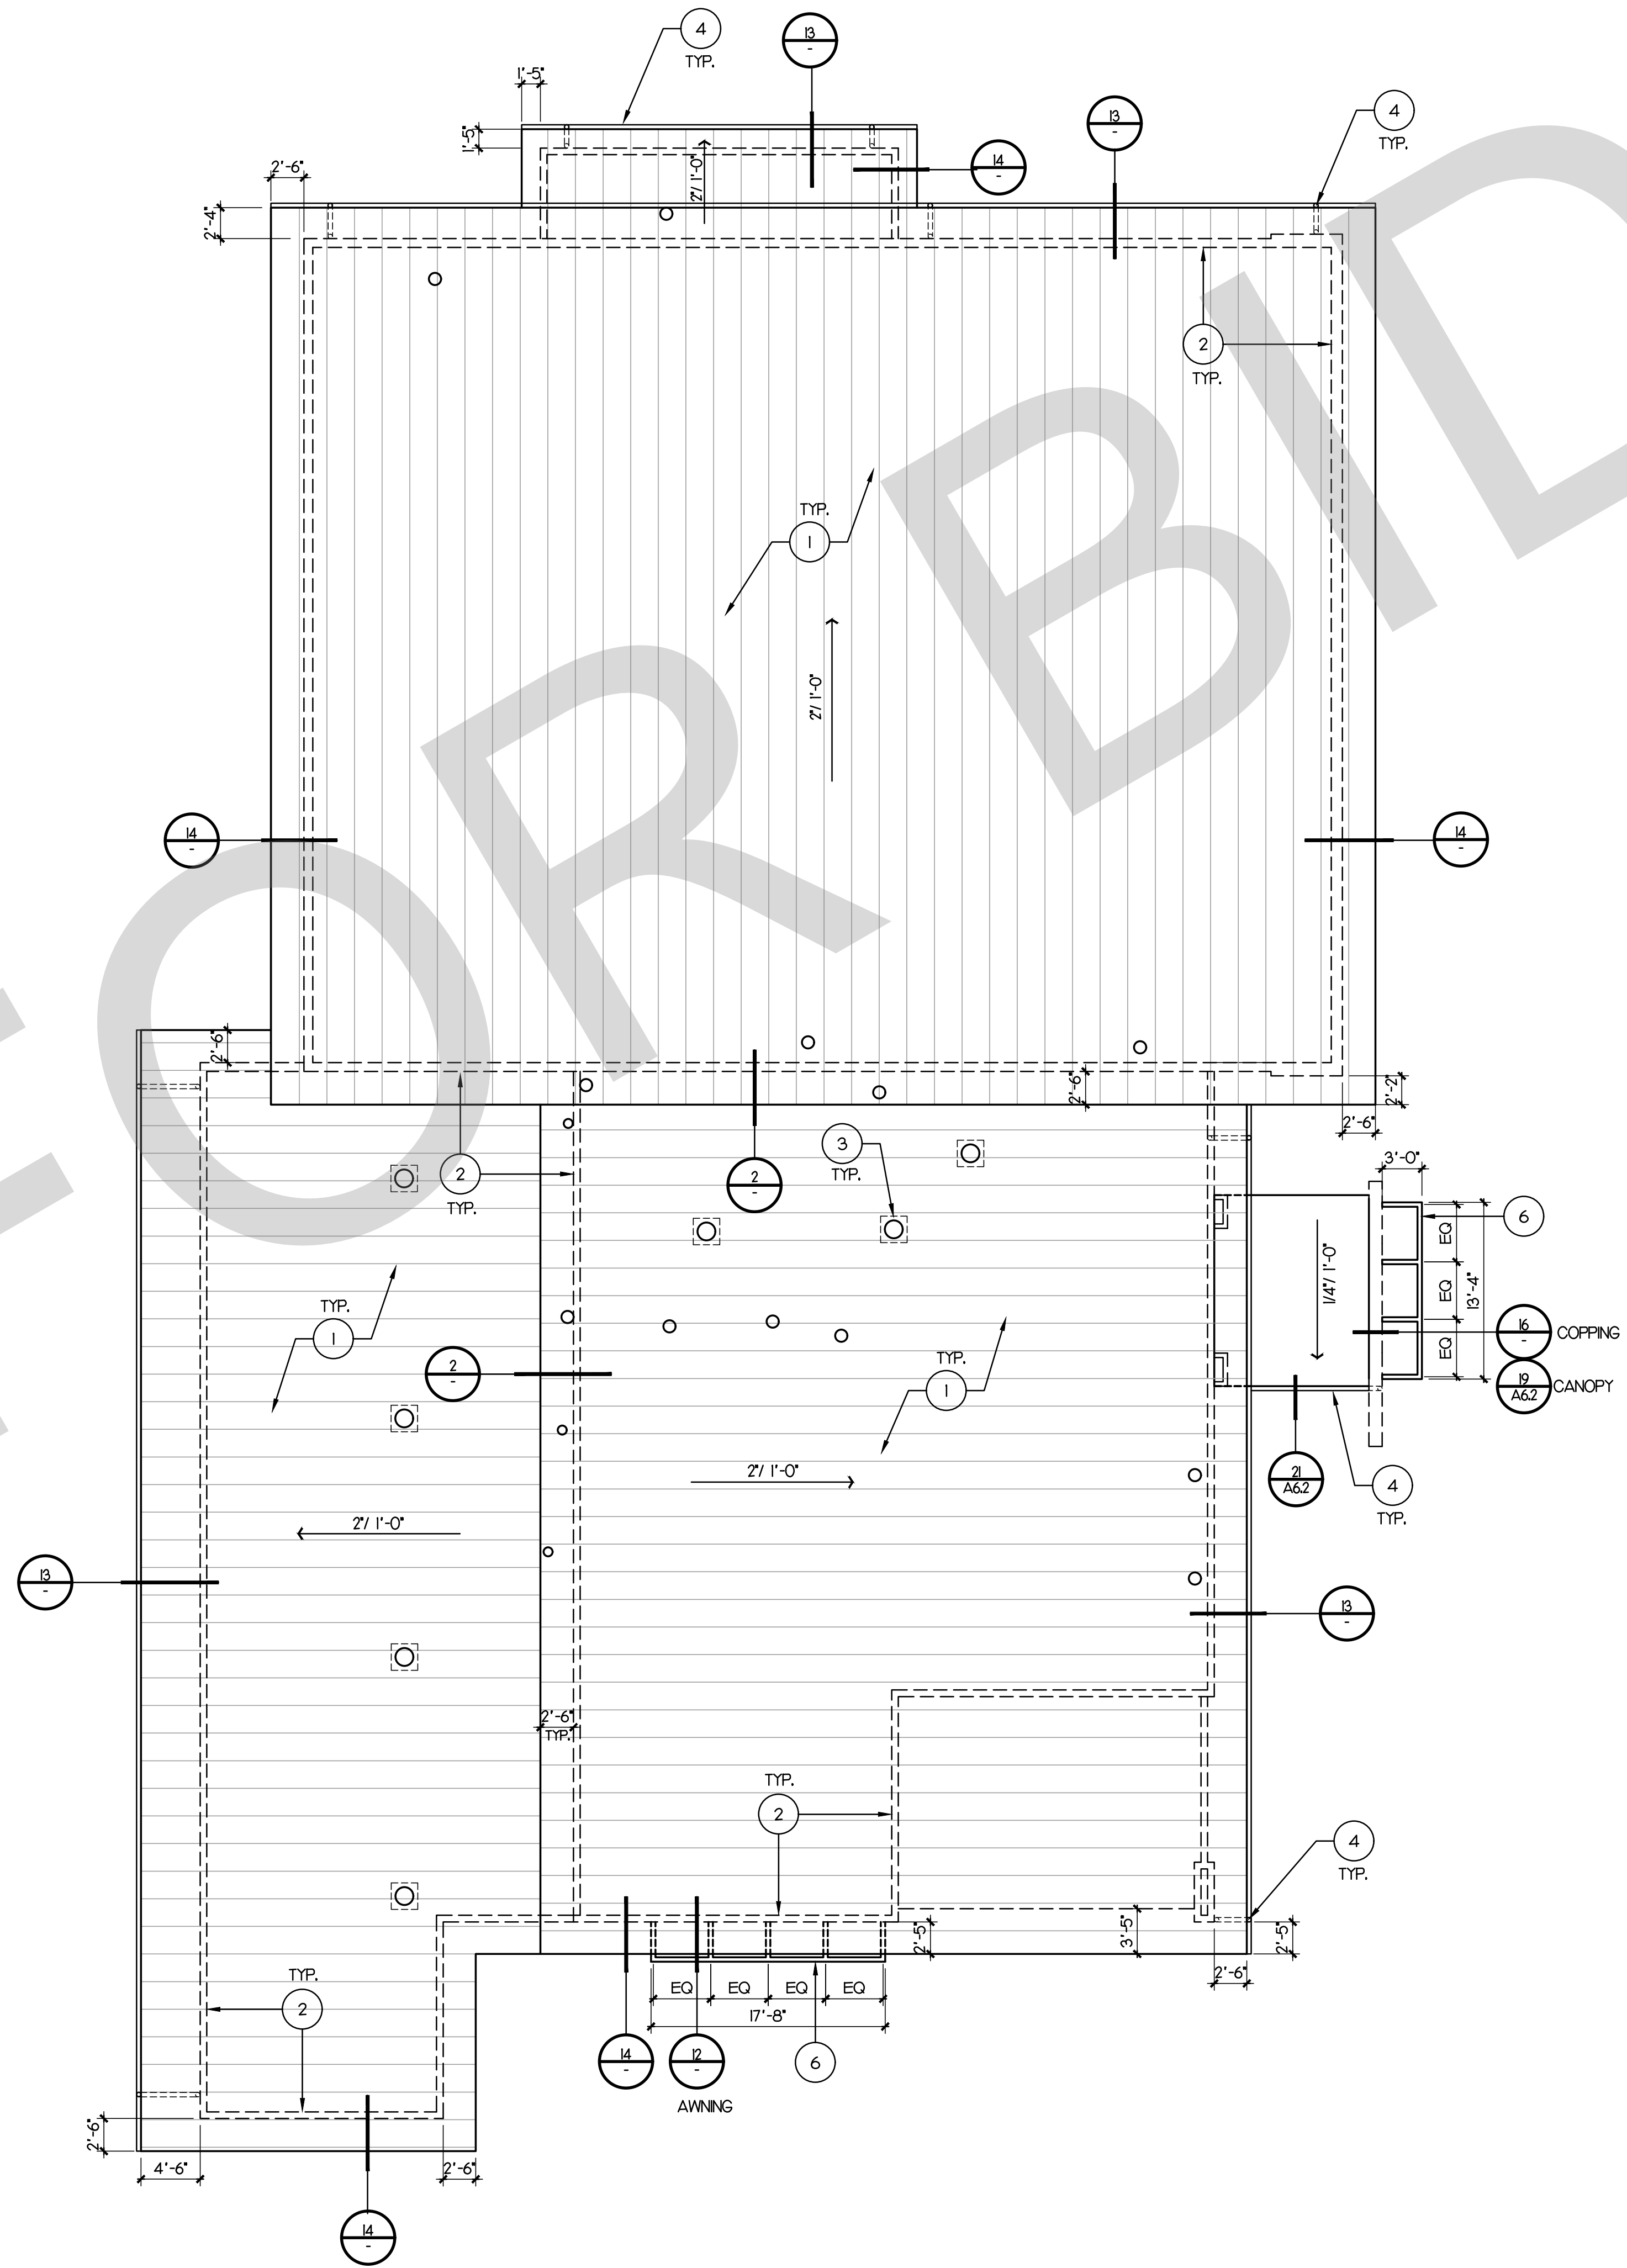

ROOF PLAN

SCALE: 1/8"=1'-0"

4

KEY NOTE

1. STANDING SEAM METAL ROOF OVER PLYWOOD SHEATHING WITH RADIANT BARRIER.
2. WALL LINE BELOW SHOWN DASHED.
3. TUBULAR SKYLIGHT - TYP. OF 7.
4. GALV. SHEET METAL GUTTER AND DOWNSPOUT, DOWN FROM EXTERIOR WALL OR SPILL UNDER CONC. SLAB TO LANDSCAPE PAINT.
5. DUCT ROOF CAP. SEE MECH'L.
6. STEEL AWNING. PAINT.

STK CONSULTANTS

4205 DEVO DR., TEMECULA, CALIFORNIA 92590-3761
Phone: 951.296.8110 Fax: 951.296.6079 Email: stk@stkc.com

CONSULTANT:

PROJECT ADMINISTERED BY:
SAN BERNARDINO COUNTY
PROJECT & FACILITIES
MANAGEMENT DEPARTMENT

385 N. ARROWHEAD AVE.
SAN BERNARDINO, CA 92415

PROJECT NAME:
SAN BERNARDINO
COUNTY FIRE
DEPARTMENT:
FIRE STATION 226

PROJECT # 10101032
CIP #21-037
CAFM # SAB198
APN # 0273-011-22

1920 DEL ROSA AVE N.
SAN BERNARDINO,
CA 92404

ISSUE INFORMATION:	
DATE:	INFORMATION:
04-11-2022	20% CD SET
04-28-2022	50% CD SET
06-15-2022	95% CD SET
09-16-2022	95% CD- 3rd BAY
10-03-2022	PLAN CHECK

SHEET INFORMATION:

STK PROJECT NO.: 374-154-21
SCALE: AS NOTED
DATE: JANUARY 2021
PLOT DATE:
DRAWING NAME:



SHEET TITLE:


ROOF PLAN &
DETAILS

SHEET NO.:

A2.6

1/10/2022 12:14 PM J:\174 SAN BERNARDINO COUNTY FIRE STATION 226\Architectural\A2.7 FINISH FLOOR PLAN.dwg

FINISH FLOOR PLAN

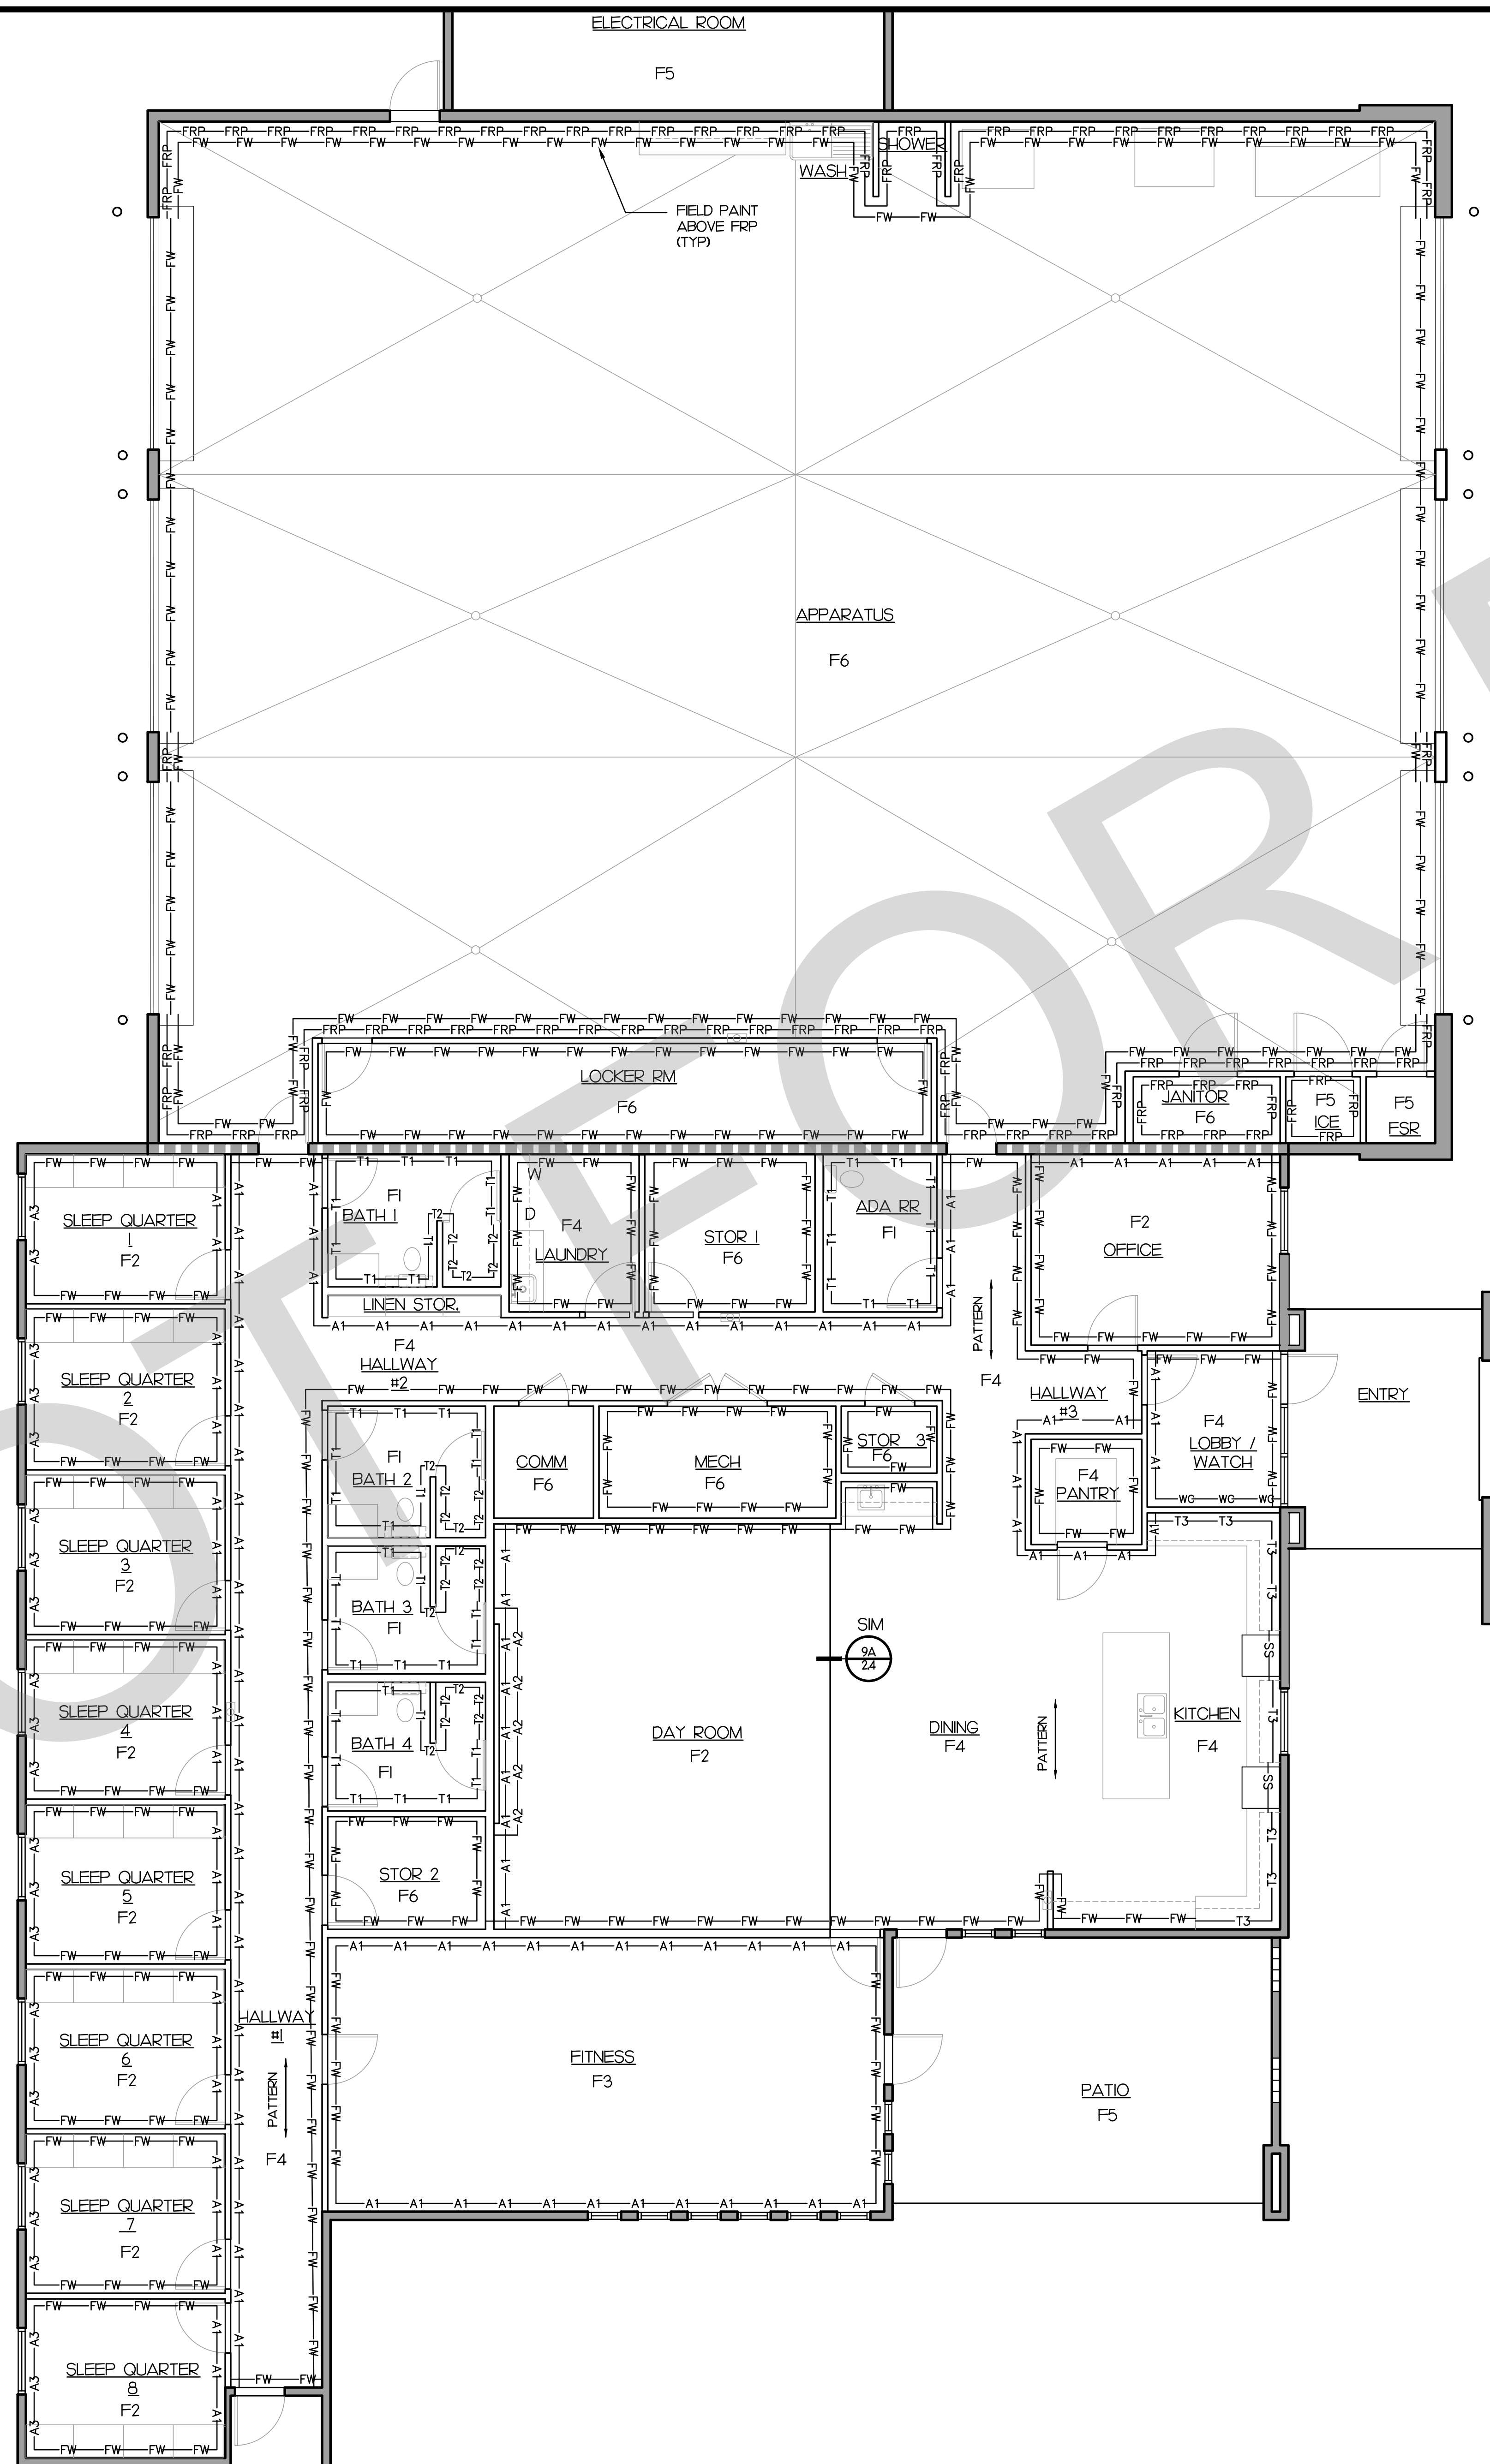

FINISH LEGEND

INTERIOR FINISHES:

FLOOR FINISHES:

- F1 CERAMIC TILE OVER FULL MORTAR BED
- F2 CARPET TILE
- F3 RESILIENT ATHLETIC FLOORING
- F4 LUXURY VINYL TILE
- F5 EXPOSED CONCRETE, MEDIUM BROOM
- F6 EXPOSED CONCRETE, SMOOTH TROWEL FINISH (SEALED)

WALL FINISHES:

WALL PAINT

- FW FIELD
- A1 ACCENT 1
- A2 ACCENT 2
- A3 ACCENT 3

WG WALLCOVER GRAPHICS

WALL TILE
4"x12" SUBWAY TILE, STACKED BOND


- T1 4FT HT.
- T2 FULL HT.
- T3 AS SHOWN IN KITCHEN ELEV.

SS STAINLESS STEEL
BEHIND RANGE UP TO UNDERSIDE OF HOOD
AND ON SIDES OF BASE CABINETS.

FRP SANITARY WALL PANEL
FROM 4' TO 8'-6" AFF.

NOTE:

REFER TO SHEET A23 FOR THE FINISH SCHEDULE
AND A32 FOR EXTERIOR ELEVATION FINISHES.

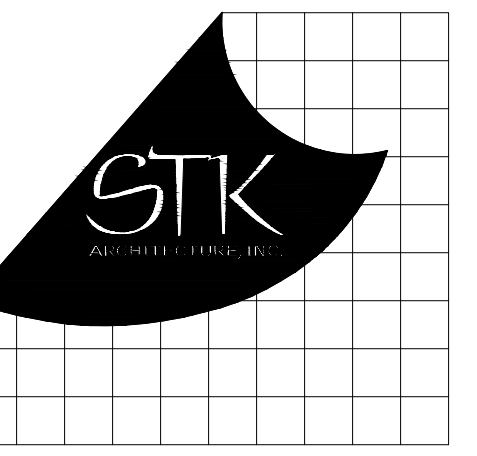

42055 ZEVIO DR., TEMECULA, CALIFORNIA 92590-3760
Phone: 951.296.8110 Fax: 951.296.6079 Email: sk@stkinc.com

CONSULTANT:

PROJECT ADMINISTERED BY:
SAN BERNARDINO COUNTY
PROJECT & FACILITIES
MANAGEMENT DEPARTMENT

385 N. ARROWHEAD AVE.
SAN BERNARDINO, CA 92415

PROJECT NAME:
SAN BERNARDINO
COUNTY FIRE
DEPARTMENT:
FIRE STATION 226

PROJECT # 10J0J032
CIP #21-037
CAFM # SAB198
APN # 0273-011-22

1920 DEL ROSA AVE N.
SAN BERNARDINO,
CA 92404

ISSUE INFORMATION:

DATE:	INFORMATION:
04-11-2022	20% CD SET
04-28-2022	50% CD SET
06-15-2022	95% CD SET
09-16-2022	95% CD- 3rd BAY
10-03-2022	PLAN CHECK

SHEET INFORMATION:

STK PROJECT NO.: 374-154-21
SCALE: AS NOTED
DATE: JANUARY 2021
PLOT DATE:
DRAWING NAME:

SEAL:




SHEET TITLE:

FINISH FLOOR
PLAN

SHEET NO.:

A2.7

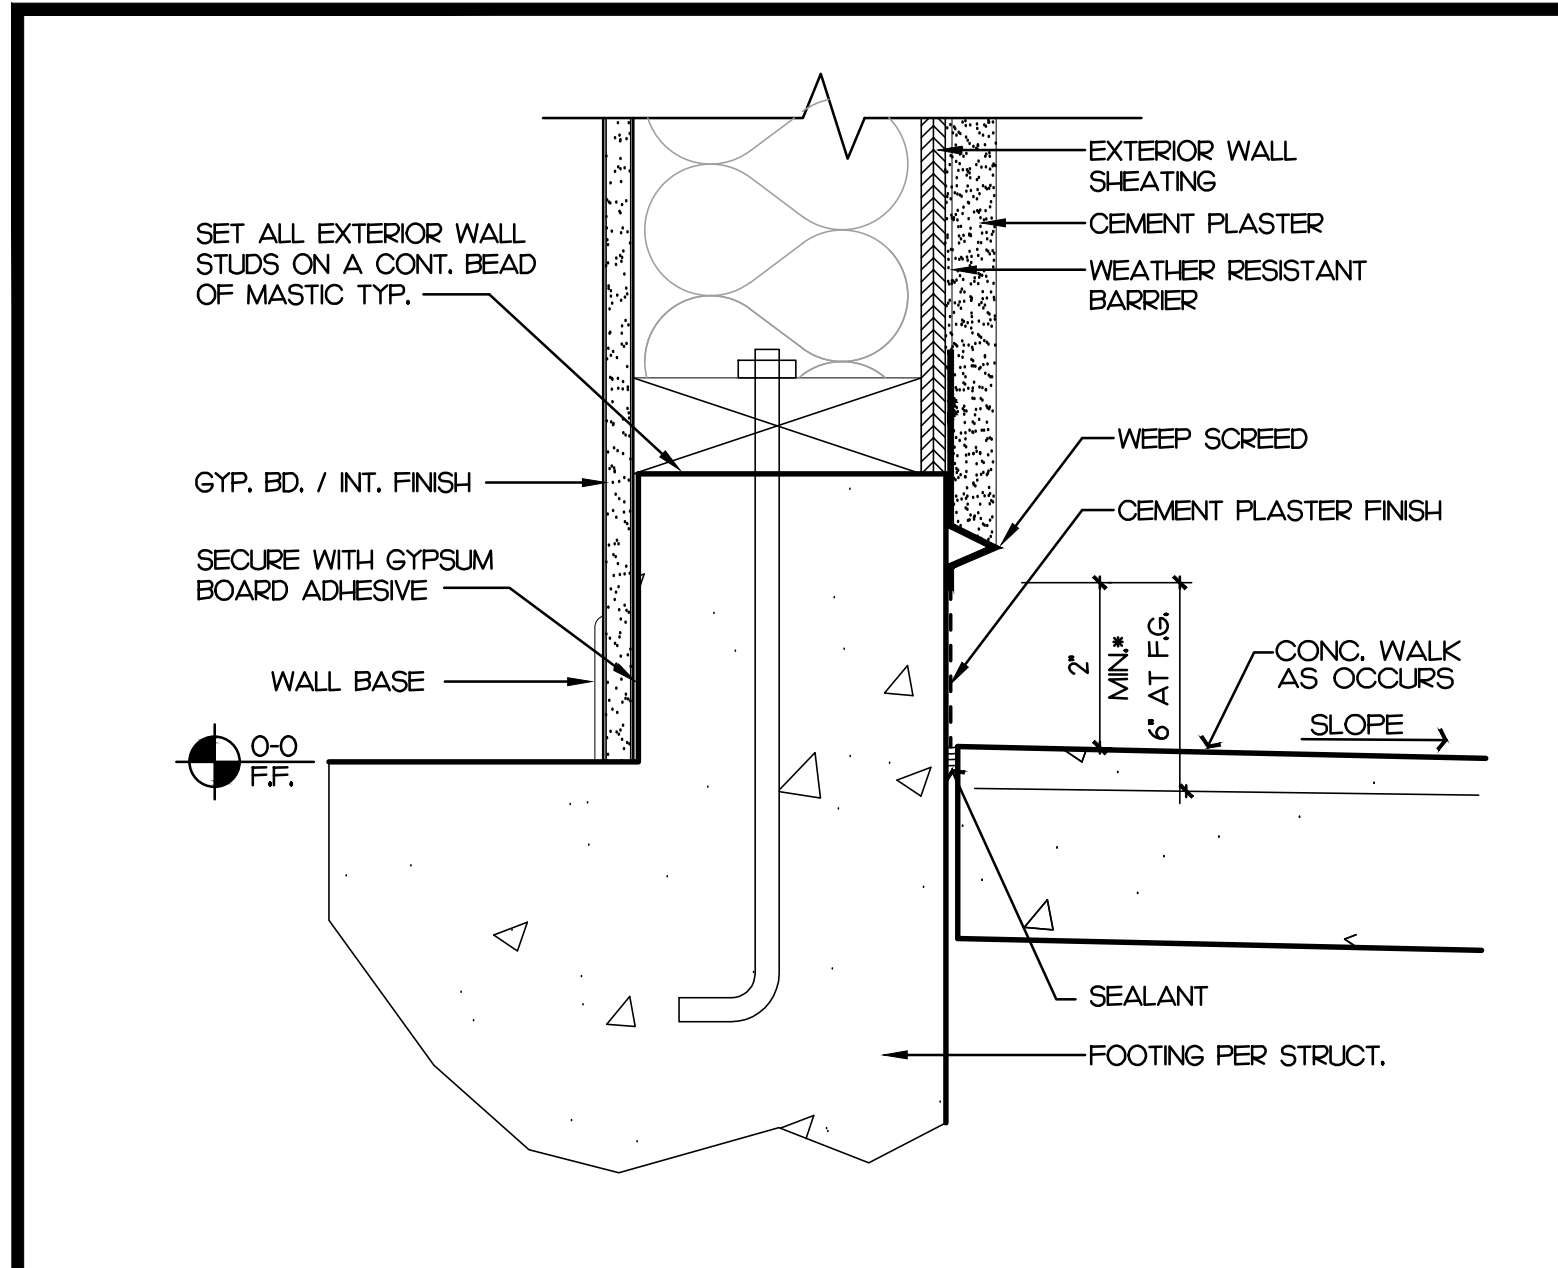


DETAIL

SCALE: 3/4"=1'-0"

5

SECTION

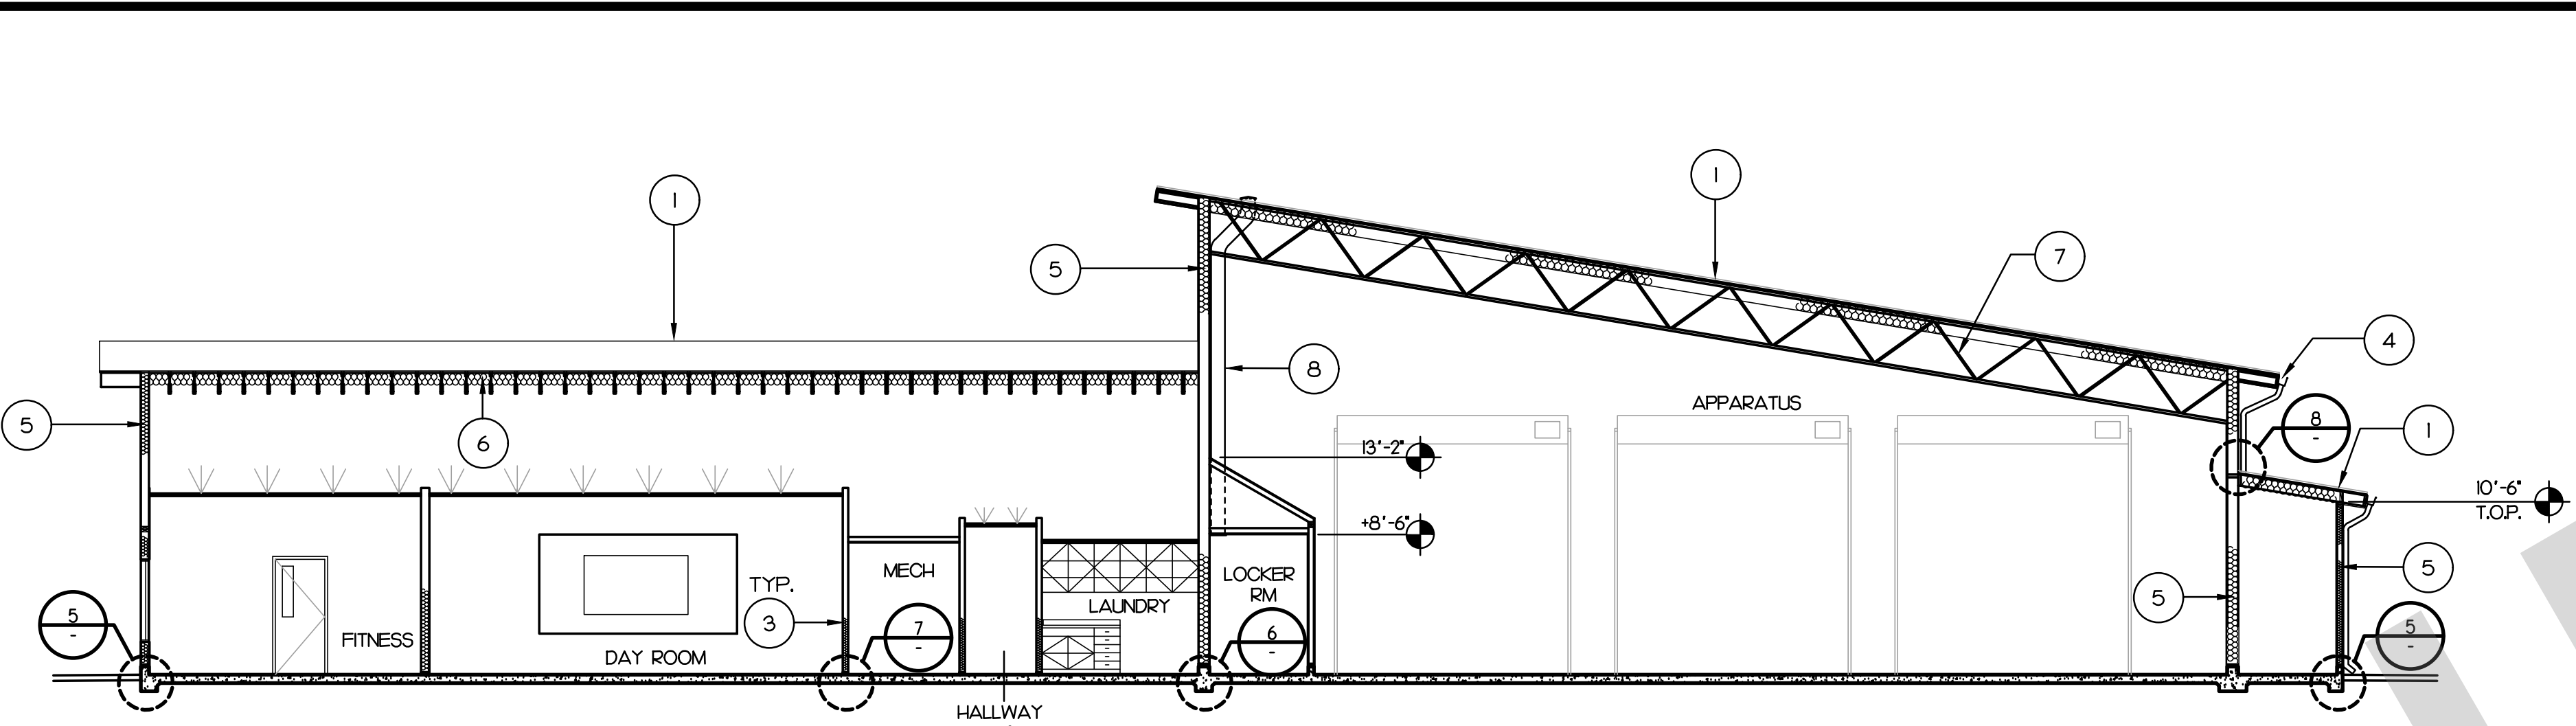


SCALE: 1/8"=1'-0"

1

KEY NOTE

1. STANDING SEAM METAL ROOF.
2. CEMENT PLASTER CEILING.
3. SOUND INSULATION, TYP. ALL INTERIOR WALLS.
4. SHEET METAL GUTTER AND DOWNSPOUT, PAINT.
5. R-21 WALL INSULATION, TYP. ALL EXTERIOR WALLS.
6. R-38 ROOF INSULATION.
7. BUILDING STRUCTURE. SEE STRUCTURAL DRAWINGS.
8. DUCT UP THRU ROOF TO ROOF CAP, BRACE TO WALL. SEE MECHANICAL DRAWINGS.

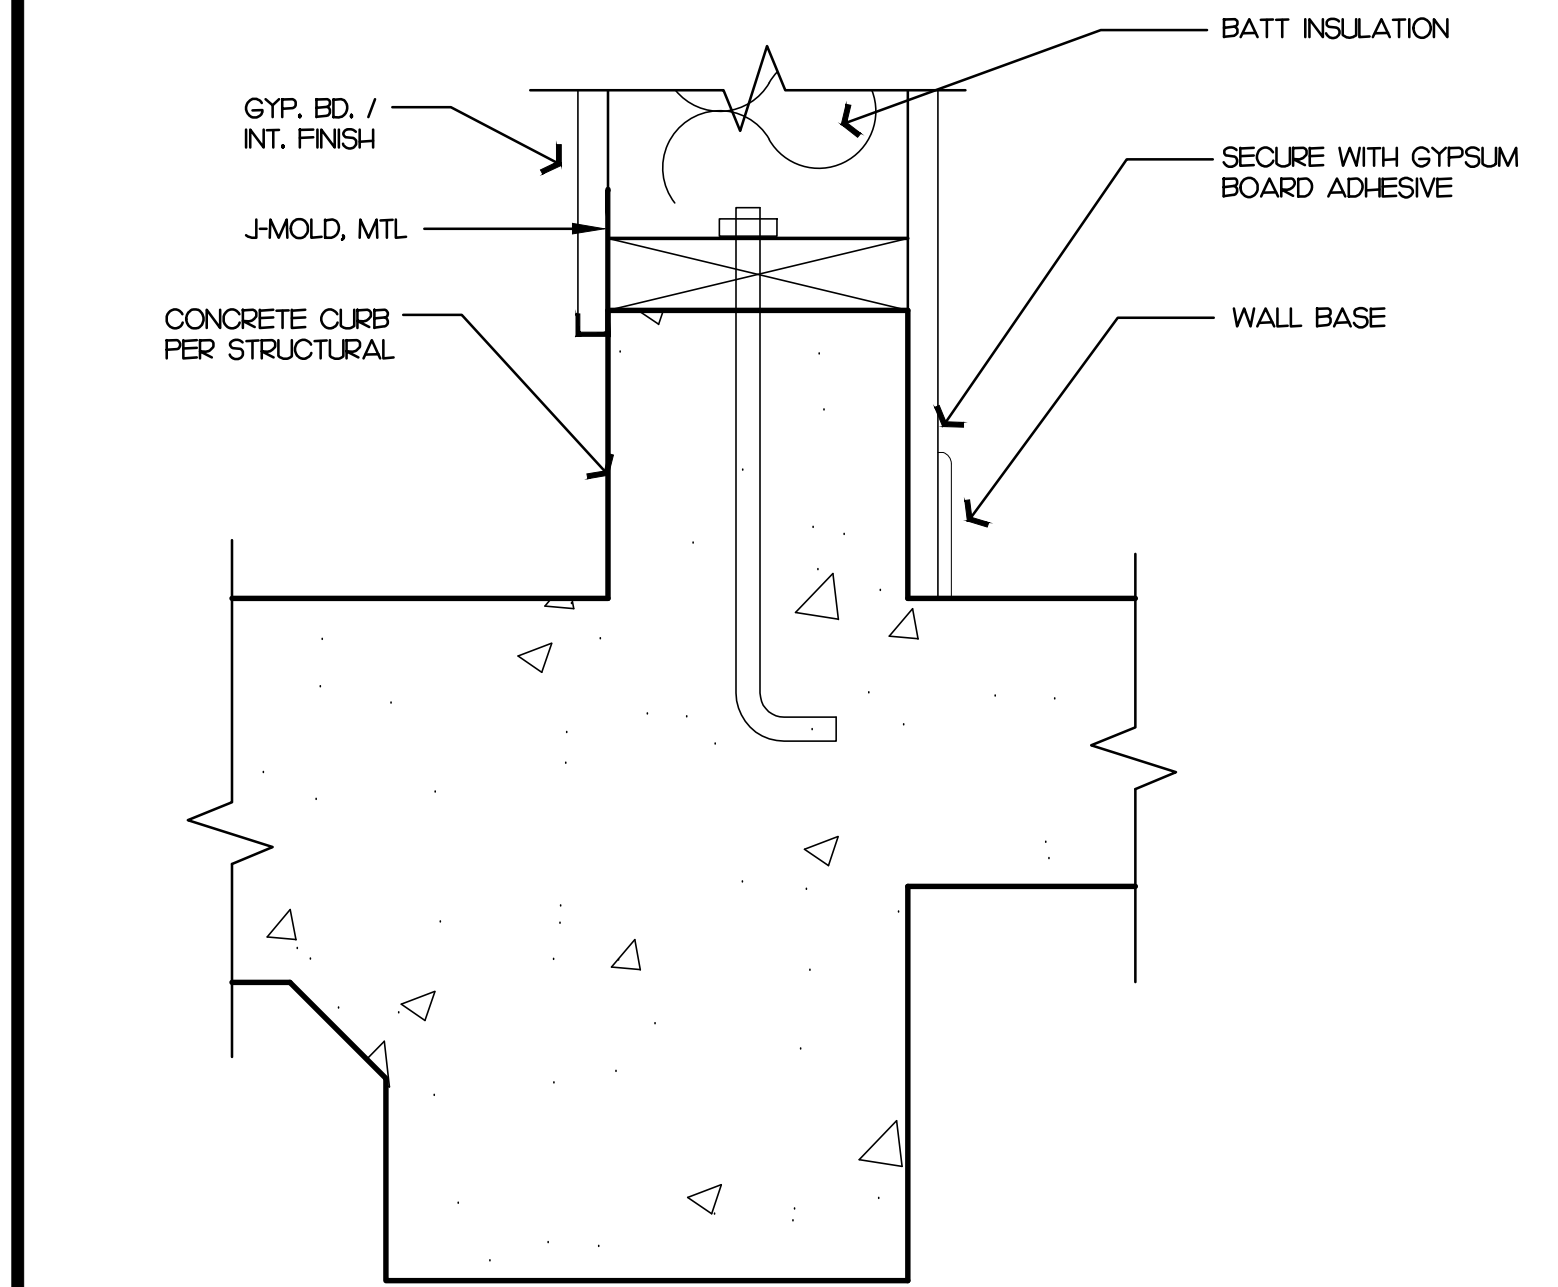


DETAIL

SCALE: 3/4"=1'-0"


6

SECTION

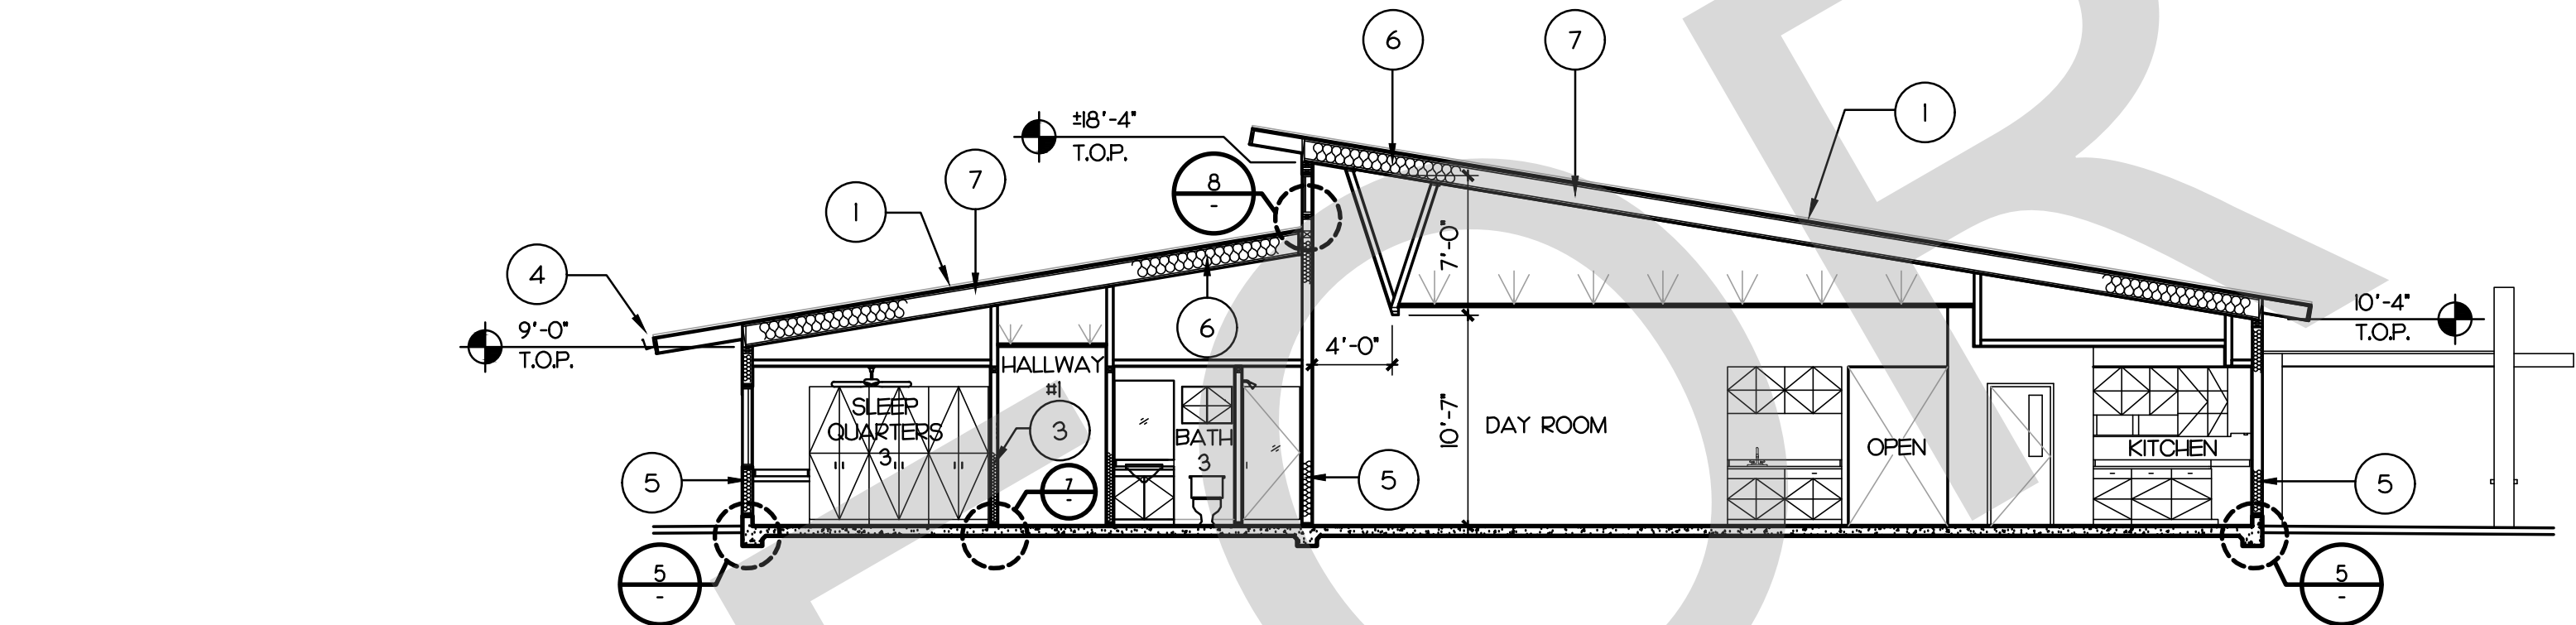

SCALE: 1/8"=1'-0"

2

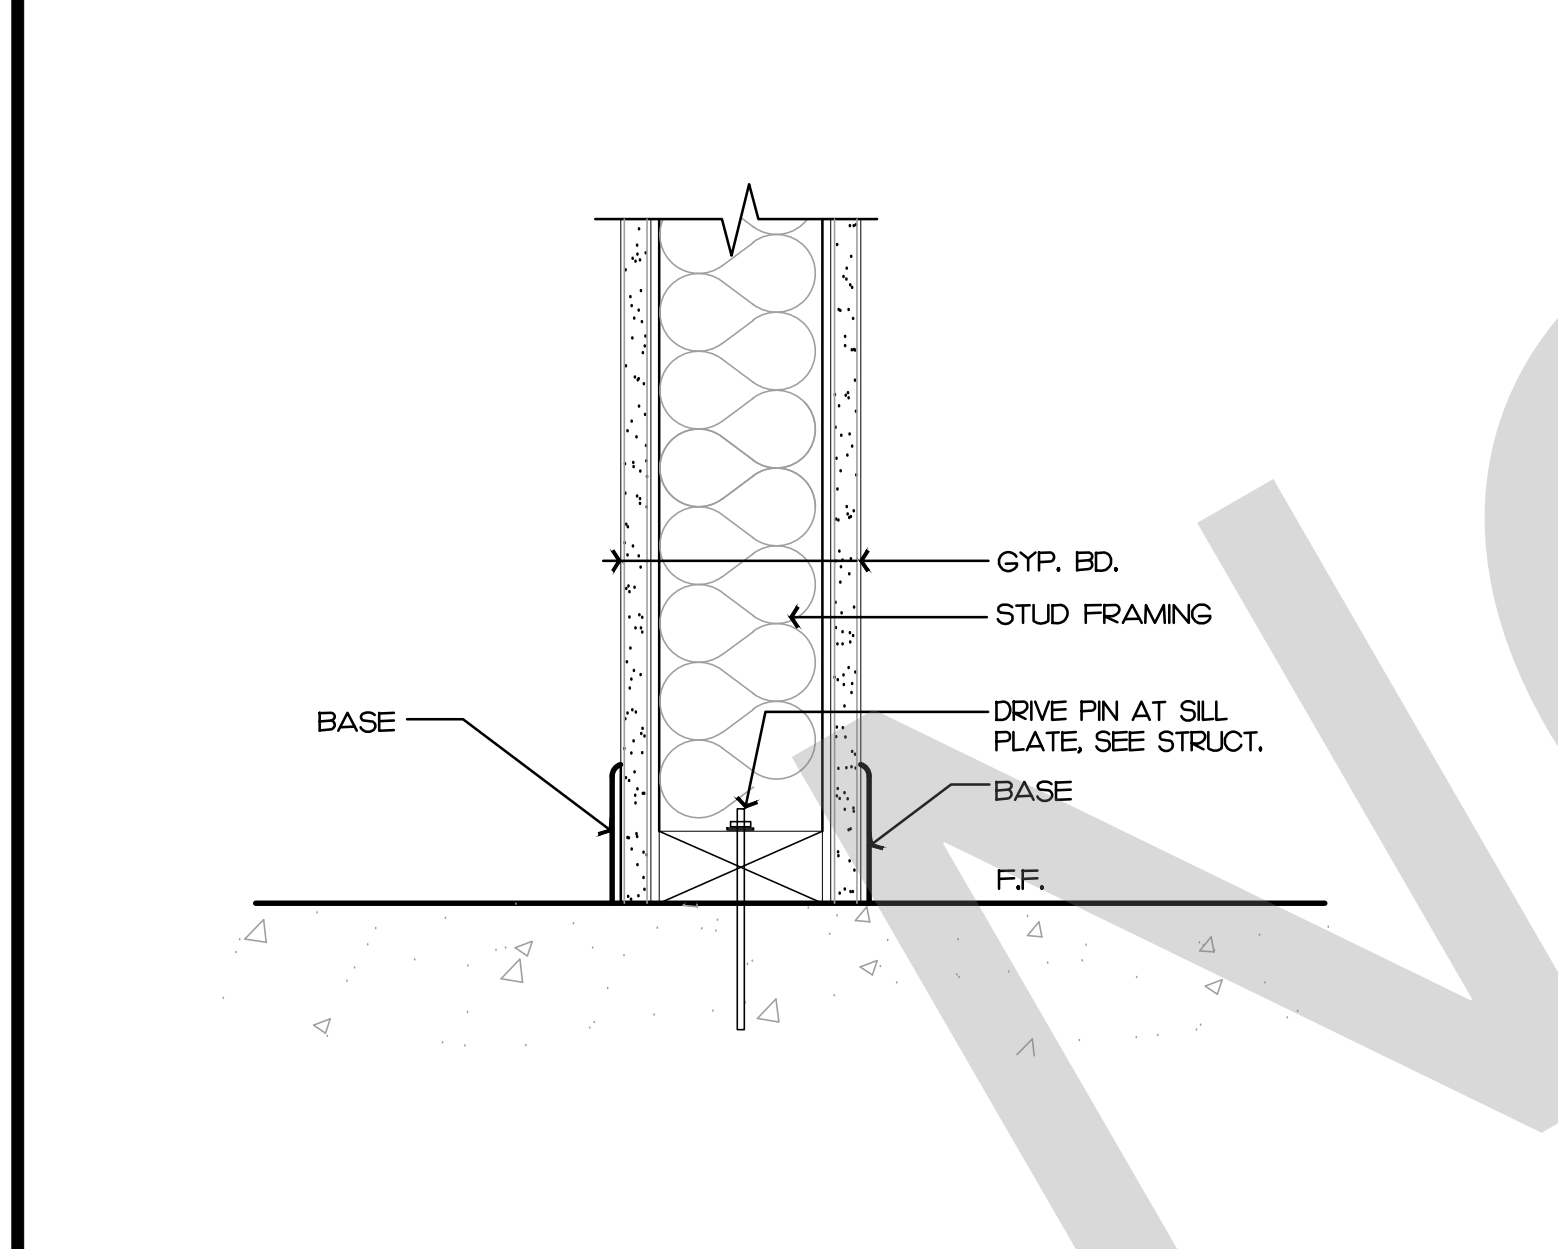


DETAIL

SCALE: 3/4"=1'-0"


7

SECTION

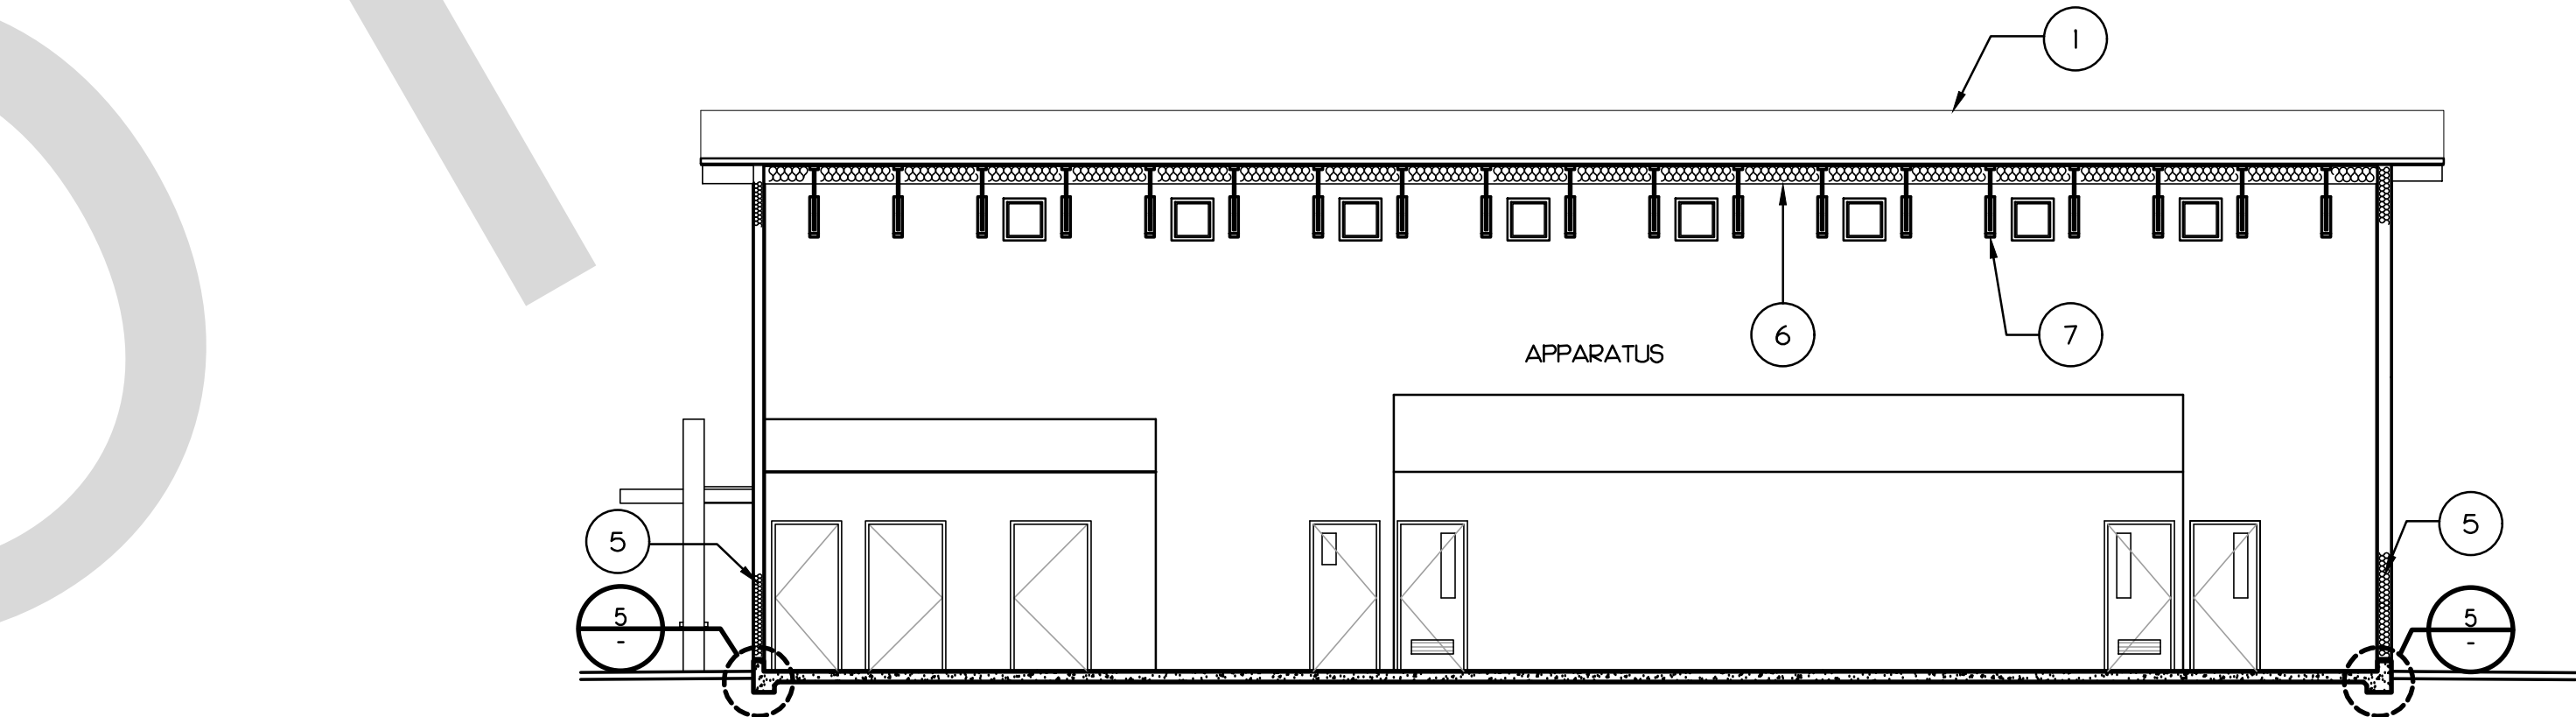

SCALE: 1/8"=1'-0"

3

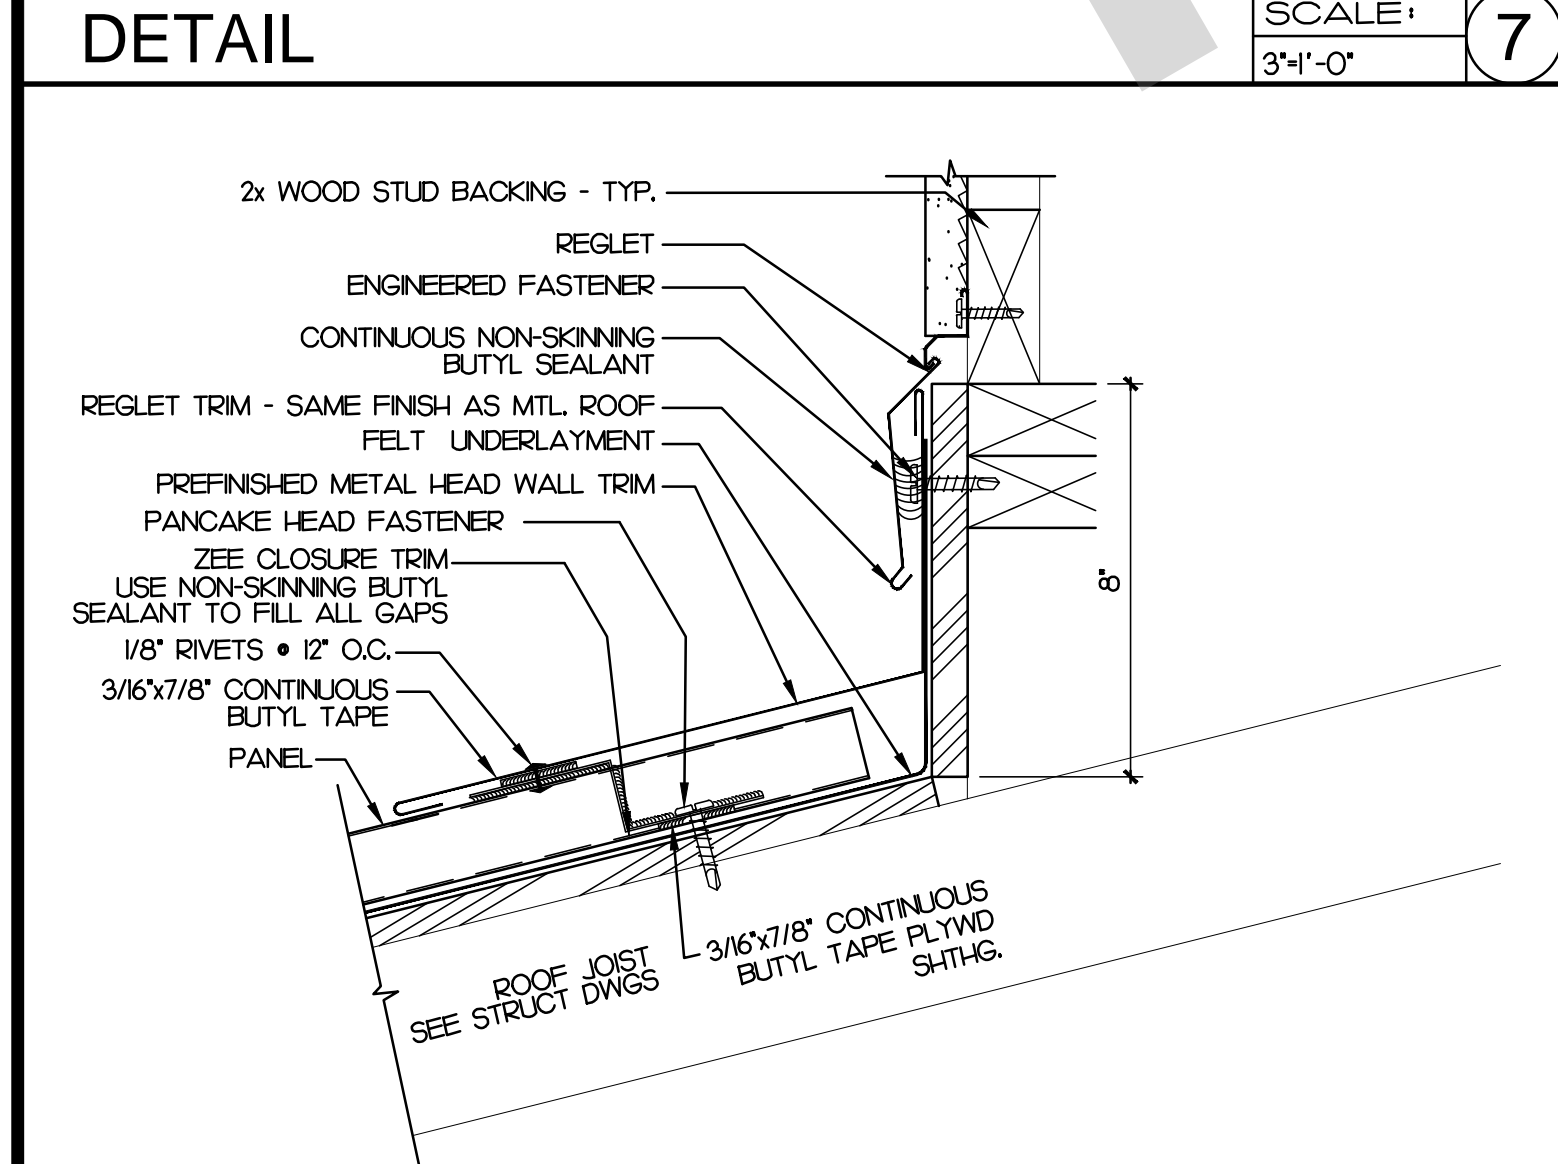


DETAIL

SCALE: 3/4"=1'-0"


8

SECTION

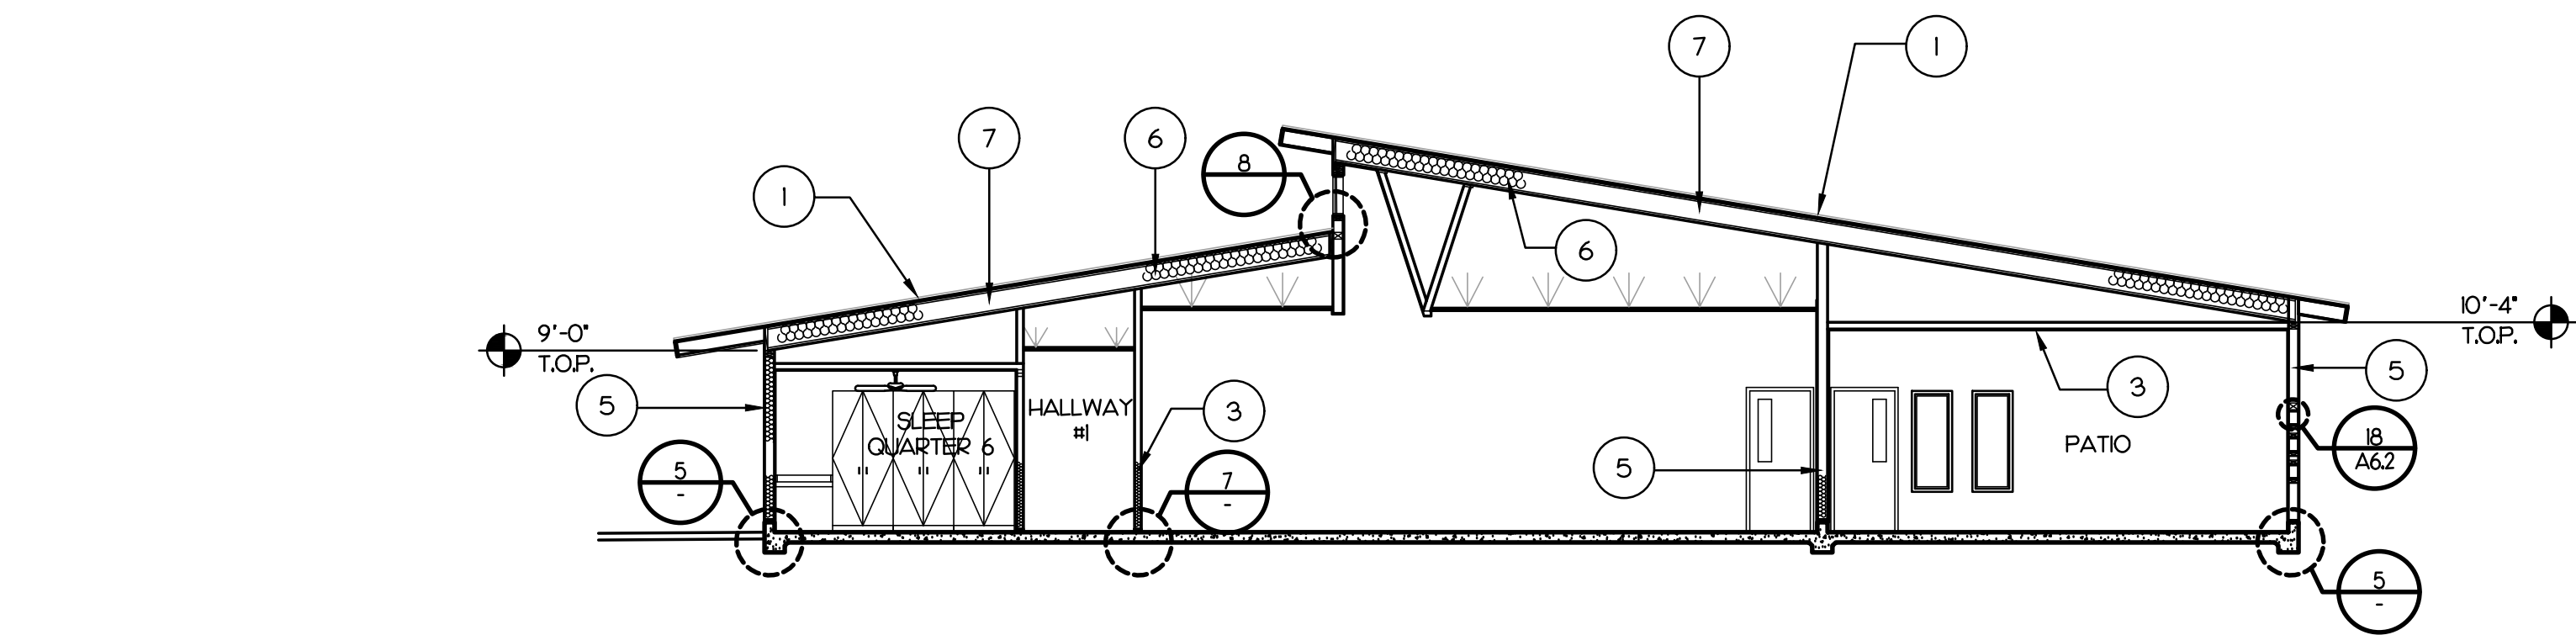

SCALE: 1/8"=1'-0"

4

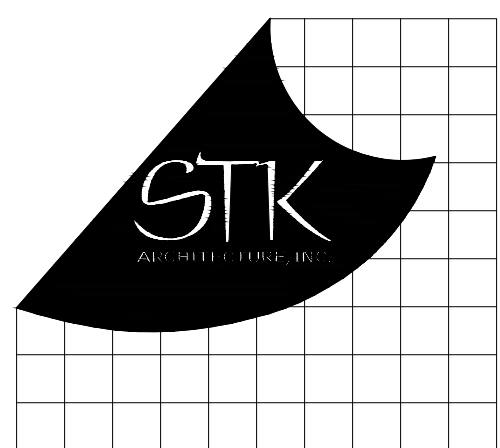

4205 ZEVIO DR., TEMECULA, CALIFORNIA 92590-3760
Phone: 951.296.8110 Fax: 951.296.6079 Email: stk@stkinc.com

CONSULTANT:

PROJECT ADMINISTERED BY:
SAN BERNARDINO COUNTY
PROJECT & FACILITIES
MANAGEMENT DEPARTMENT

385 N. ARROWHEAD AVE.
SAN BERNARDINO, CA 92415

PROJECT NAME:
SAN BERNARDINO
COUNTY FIRE
DEPARTMENT:
FIRE STATION 226

PROJECT # 10101032

CIP #21-037

CAFM # SAB198

APN # 0273-011-22

1920 DEL ROSA AVE N.
SAN BERNARDINO,
CA 92404

ISSUE INFORMATION:

DATE:	INFORMATION:
04-11-2022	20% CD SET
04-28-2022	50% CD SET
06-15-2022	95% CD SET
09-16-2022	95% CD- 3rd BAY
10-03-2022	PLAN CHECK

SHEET INFORMATION:

STK PROJECT NO.: 374-154-21
SCALE: AS NOTED
DATE: JANUARY 2021
PLOT DATE:
DRAWING NAME:

SEAL:




SHEET TITLE:


BUILDING
SECTIONS
& DETAILS

SHEET NO.:


A3.1

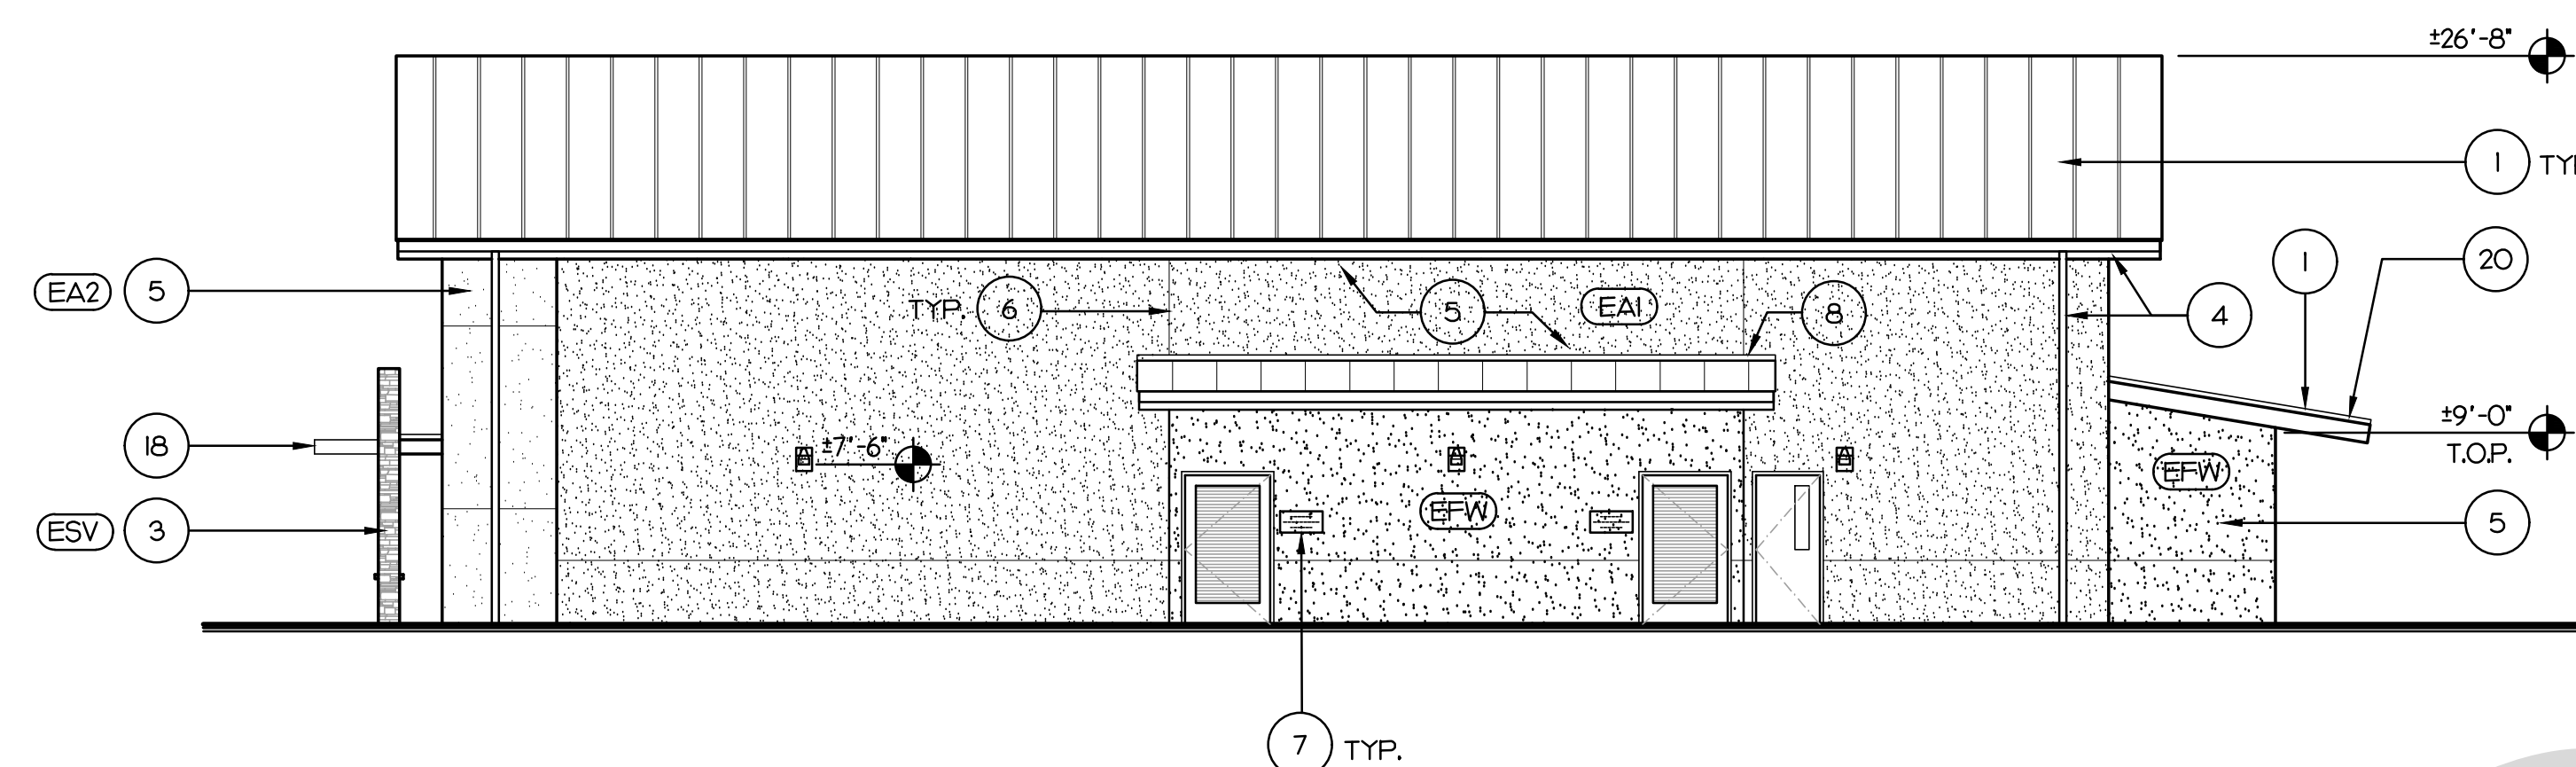


NORTH ELEVATION

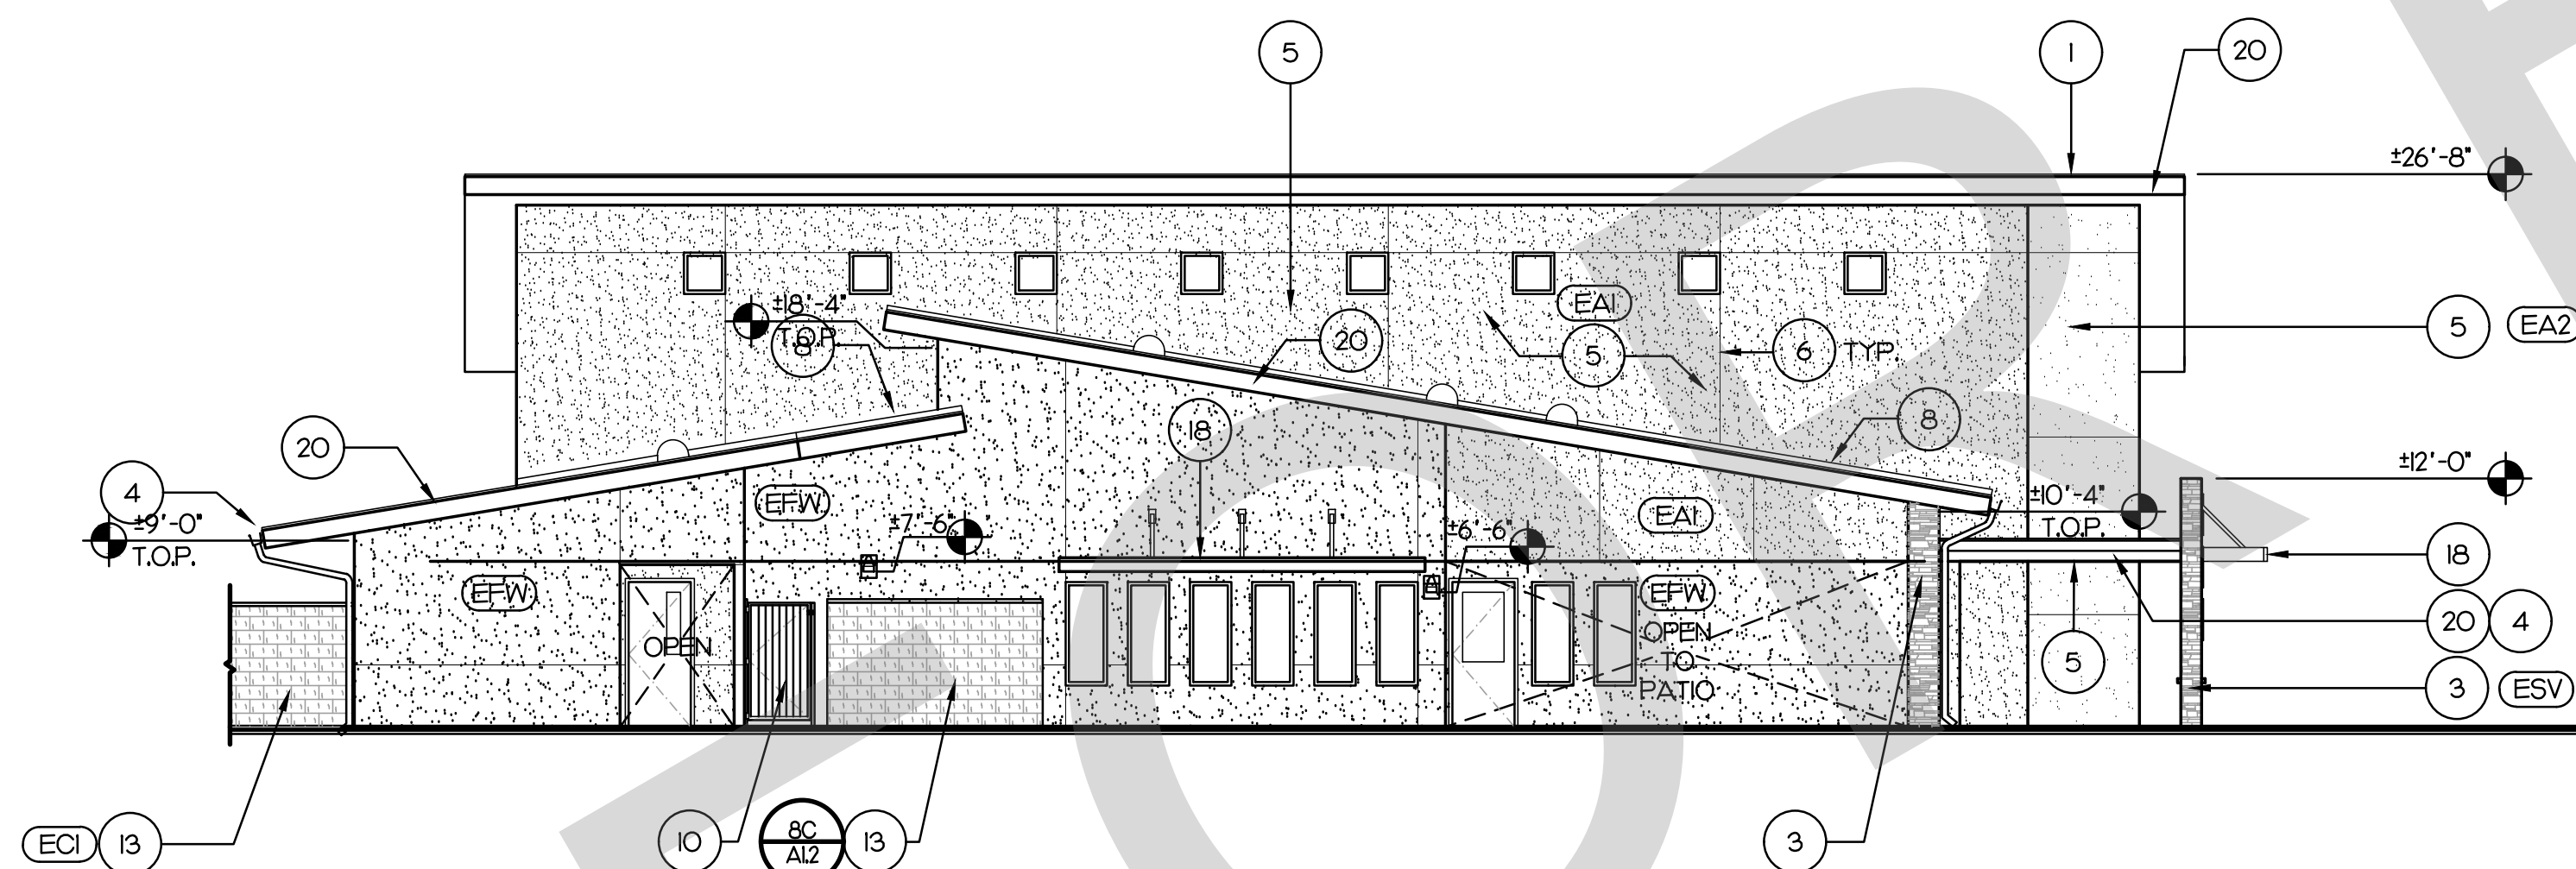

SOUTH ELEVATION

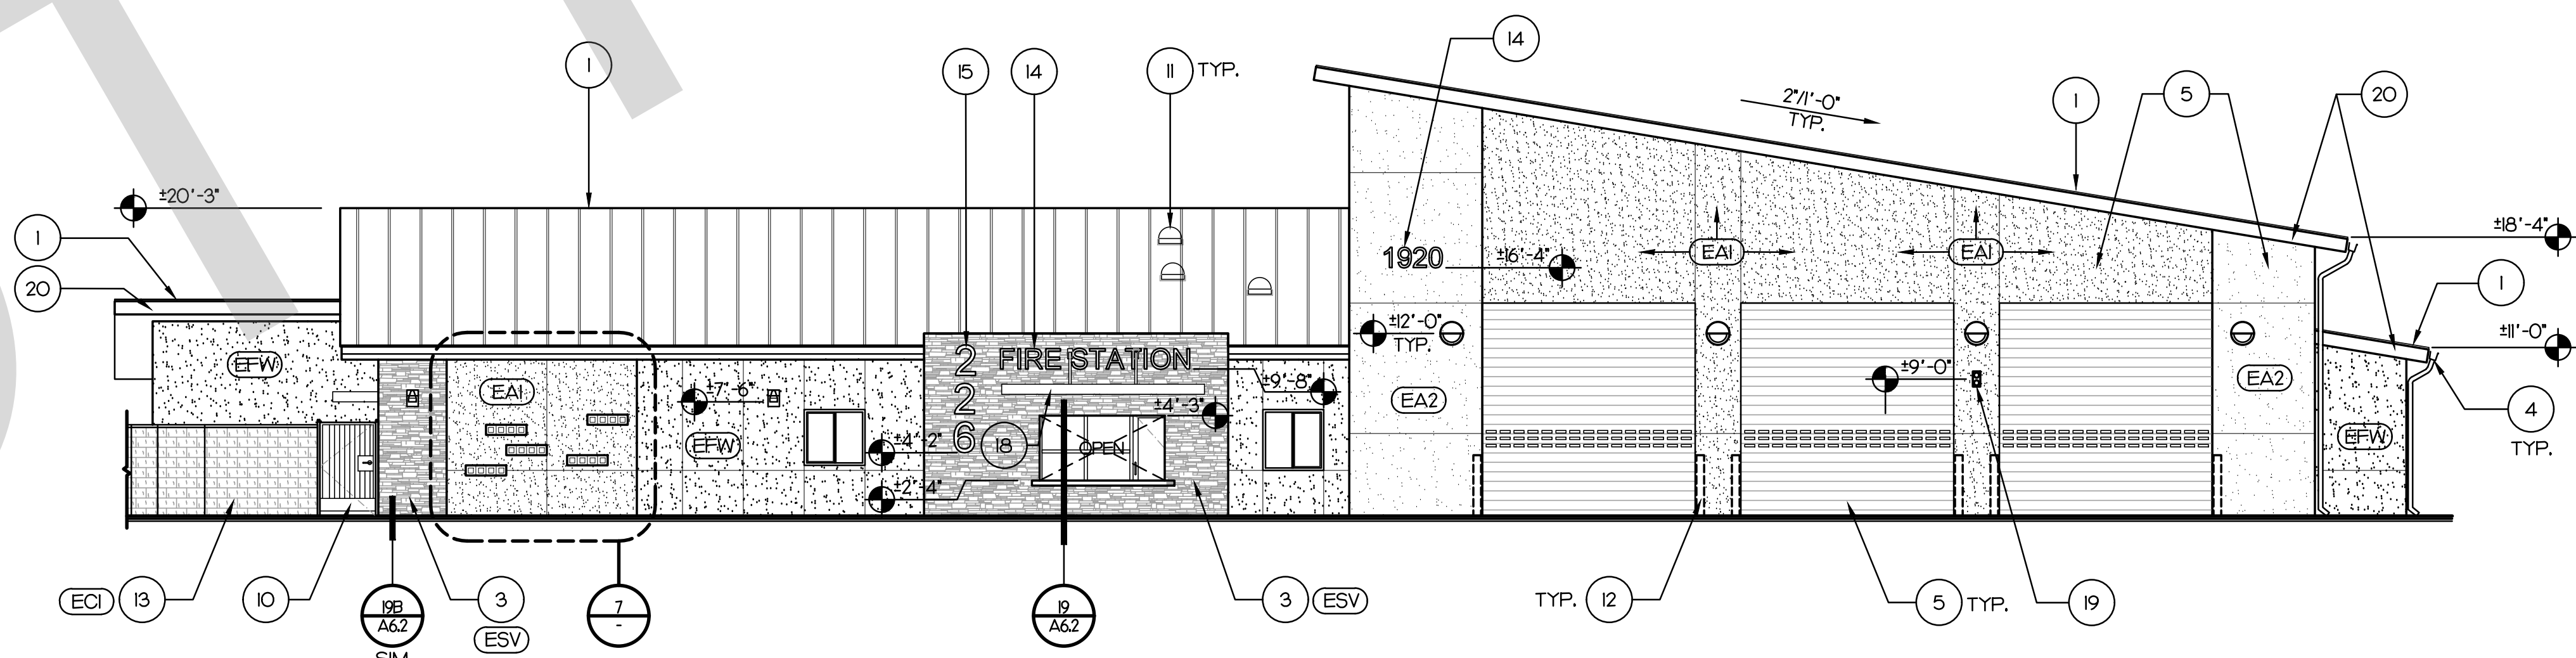

EAST ELEVATION

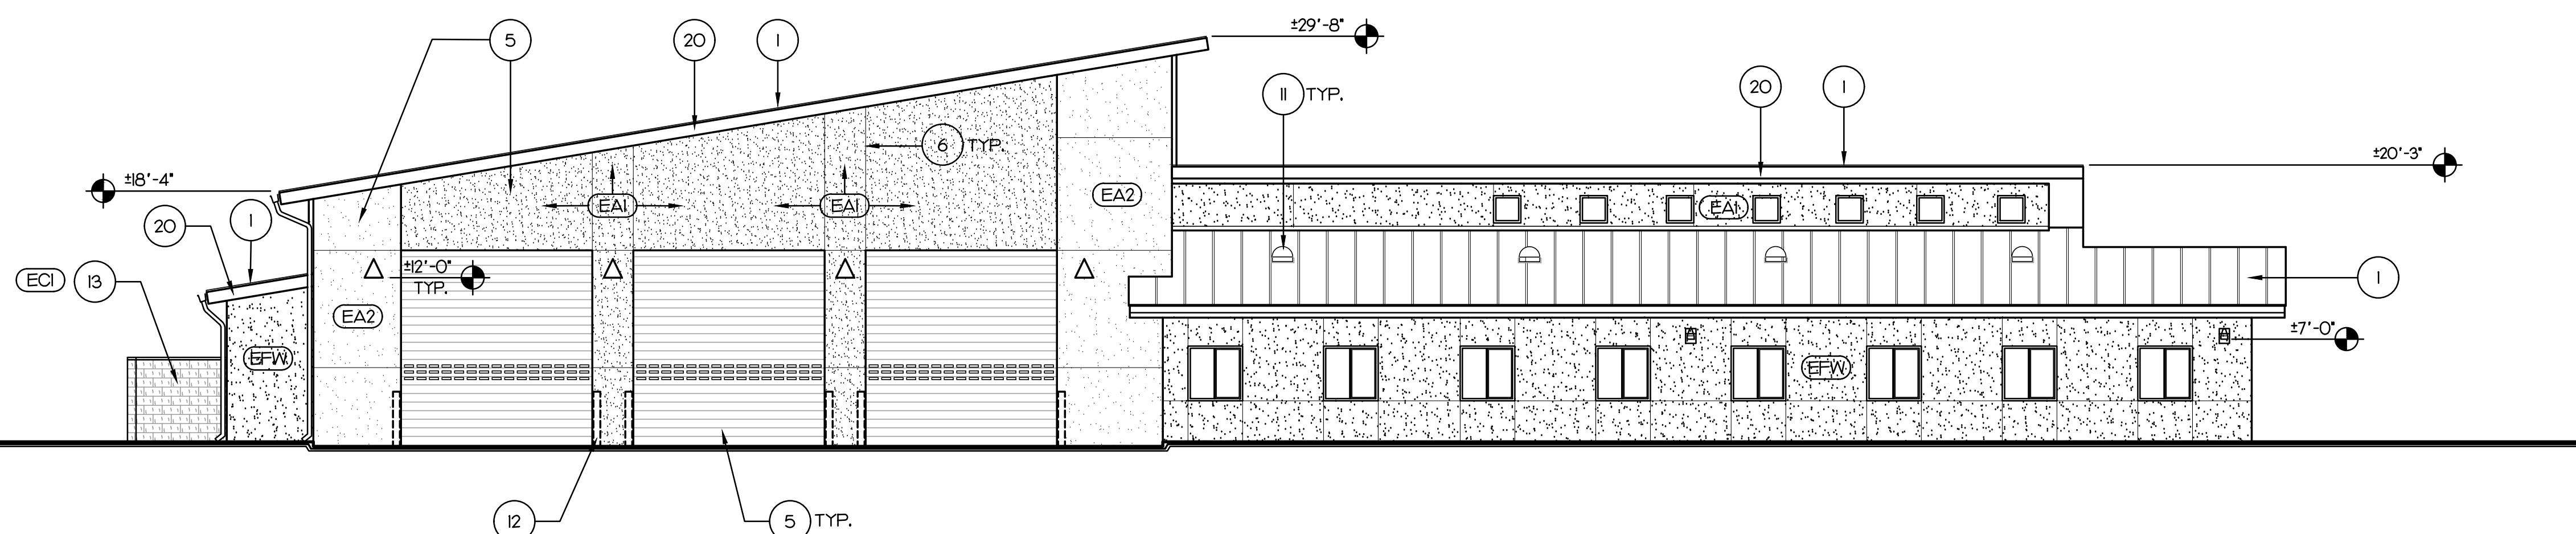

WEST ELEVATION

1. STANDING SEAM METAL ROOF.
2. OVER-HEAD COILING DOOR. TYP. OF 2
3. STONE VENEER.
4. GALV. SHEET METAL GUTTER AND SURFACE MOUNTED DOWNSPOUT, PAINT.
5. CEMENT PLASTER.
6. CEMENT PLASTER CONTROL JOINT. SEE 2/62
7. 6'X12' SIGN THAT READS "ELECTRICAL ROOM WITH 3" X 3/4" STROKE LETTERS WITH CONTRASTING WHITE REFLECTIVE BACKGROUND. SIGN SHALL ALSO STATE "THIS BUILDING IS SUPPLIED BY AN ON-SITE GENERATOR IN THE BACK PARKING AREA".
8. SHEET METAL FLASHING. PAINT TO MATCH ADJACENT PLASTER CEMENT. SEE 8/AS1
9. KNOX BOX LOCATED PER FIRE DEPARTMENTS DIRECTION.
10. METAL PERSONNEL GATE.
11. TUBULAR SKYLIGHT
12. CONC. FILLED PIPE BOLLARD. PAINT O.S.H.A. YELLOW. SEE 7/AD2
13. 6'-0" HIGH CMU WALL WITH 2" CONC. CAP.
14. 12" CAST NUMBERS & LETTERS.
15. 24" CAST NUMBERS.
16. 8x8 MASONRY SCREEN BLOCK
17. DEDICATION PLAQUE. SEE 11/AS1
18. STEEL AWNING. PAINT.
19. RED AND GREEN LIGHT. SEE ELECT'L.
20. METAL FASCIA

(EFW)	STUCCO WALL - FIELD OMEGA, COLORTREK, 432 MILKY QUARTZ, BASE 10
(EAI)	STUCCO WALL - ACCENT 1 OMEGA, COLORTREK, 69 TRUE GRAY, BASE 2
(EA2)	STUCCO WALL - ACCENT 2 (DARK) OMEGA, COLORTREK, 412 BISON BEIGE, BASE 2
(ESV)	STONE VENEER
(ECI)	8x8x6 CMJ WALL
(EC2)	8x8x4(D) BREEZE BLOCK



42095 ZEVO DR., TEMECULA, CALIFORNIA 92590-3780
Phone: 951.296.9110 Fax: 951.296.6079 Email: stk@stkin.com

CONSULTANT:

PROJECT ADMINISTERED BY:
SAN BERNARDINO COUNTY
PROJECT & FACILITIES
MANAGEMENT DEPARTMENT

PROJECT NAME:
SAN BERNARDINO
COUNTY FIRE
DEPARTMENT:
FIRE STATION 226

PROJECT # 10.10.1032
CIP #21-037
CAFM # SABI98
APN # 0273-011-22

1920 DEL ROSA AVE N
SAN BERNARDINO,
CA 92404

ISSUE INFORMATION:	
DATE:	INFORMATION:
04-11-2022	20% CD SET
04-28-2022	50% CD SET
06-15-2022	95% CD SET
09-16-2022	95% CD- 3rd BA
10-03-2022	PLAN CHECK

SHEET INFORMATION

STK PROJECT NO.: 374-154-7
SCALE: AS NOTED
DATE: JANUARY 2007
PLOT DATE: -
DRAWING NAME:

SEAL:




SHEET TITLE

EXTERIOR ELEVATIONS

SHEET NO.

A3.2



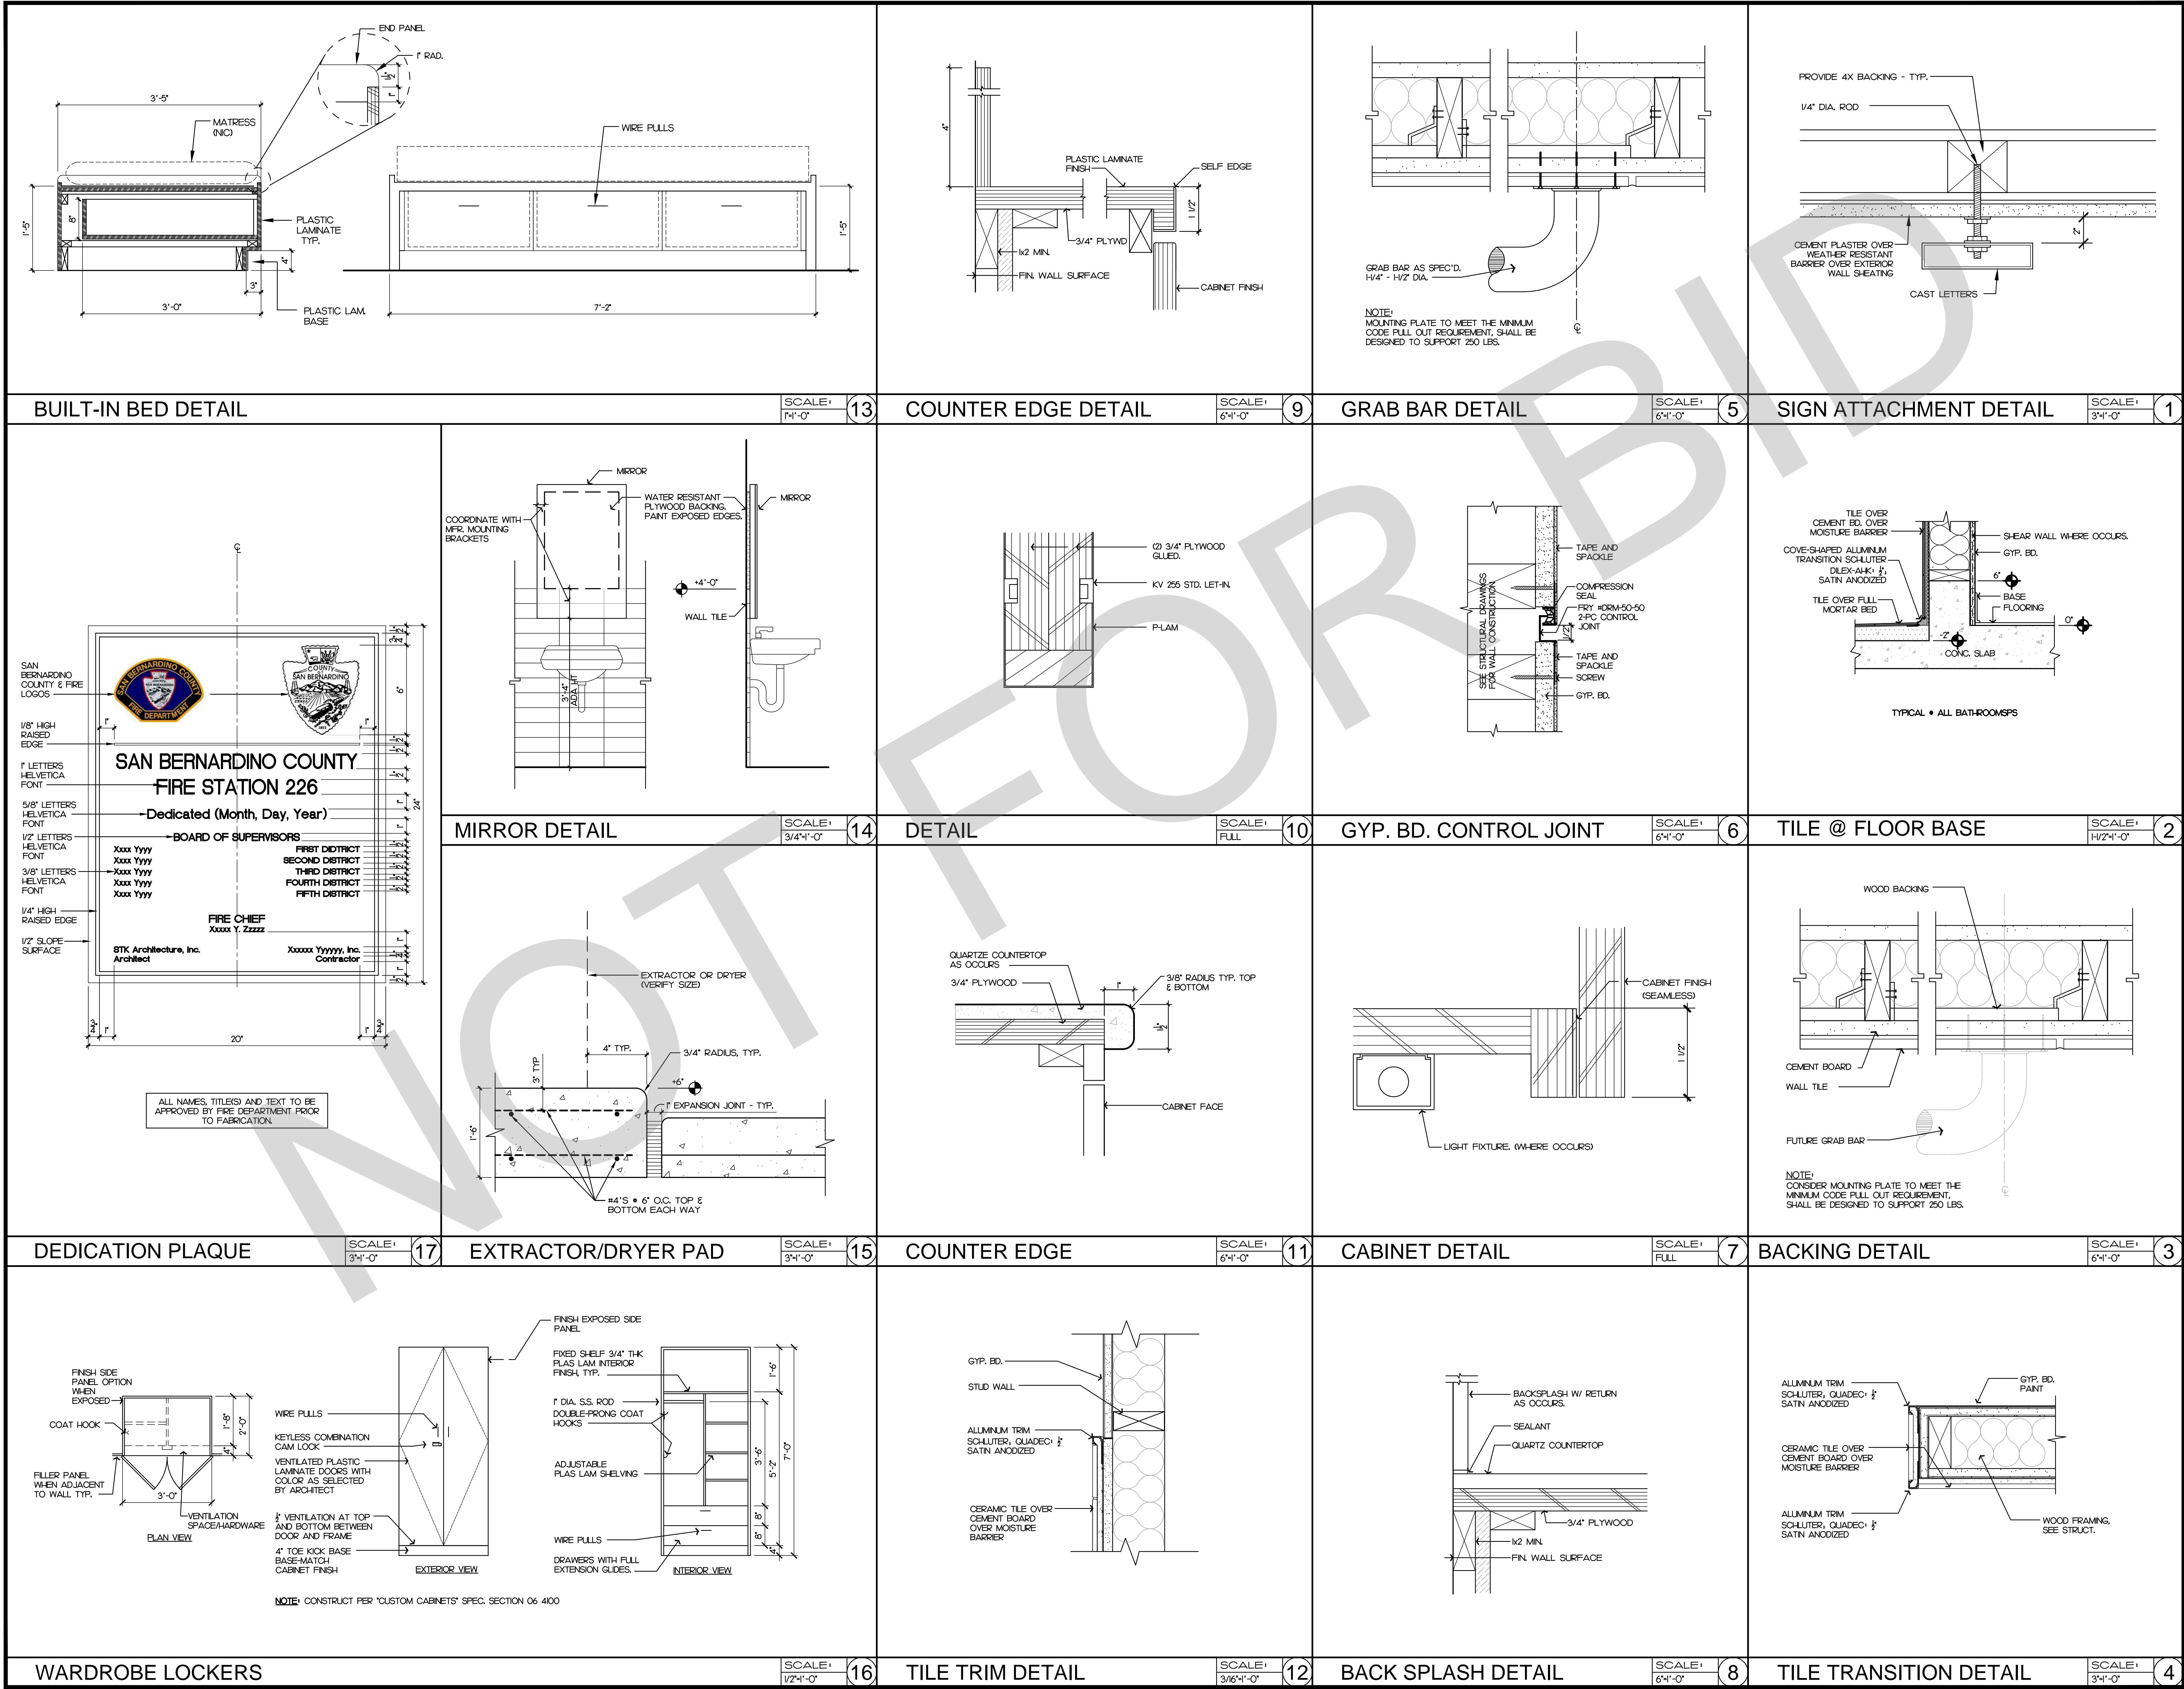

ISSUE INFORMATION:	
DATE:	INFORMATION:
04-11-2022	20% CD SET
04-28-2022	50% CD SET
06-15-2022	95% CD SET
09-16-2022	95% CD - 3rd BAY
10-03-2022	PLAN CHECK

SHEET INFORMATION:	
STK PROJECT NO.:	374-154-21
SCALE:	AS NOTED
DATE:	JANUARY 2021
PLOT DATE:	
DRAWING NAME:	
SEAL:	



SHEET TITLE:


MISC. DETAILS

SHEET NO.:

A6.1

03/20/2022 4:48PM J:\174 SAN BERNARDINO\174-154-21\SDC Fire Station No. 226\Architectural\A6.2 - MISC. DETAILS\DETAILS.dwg


NOT
USED

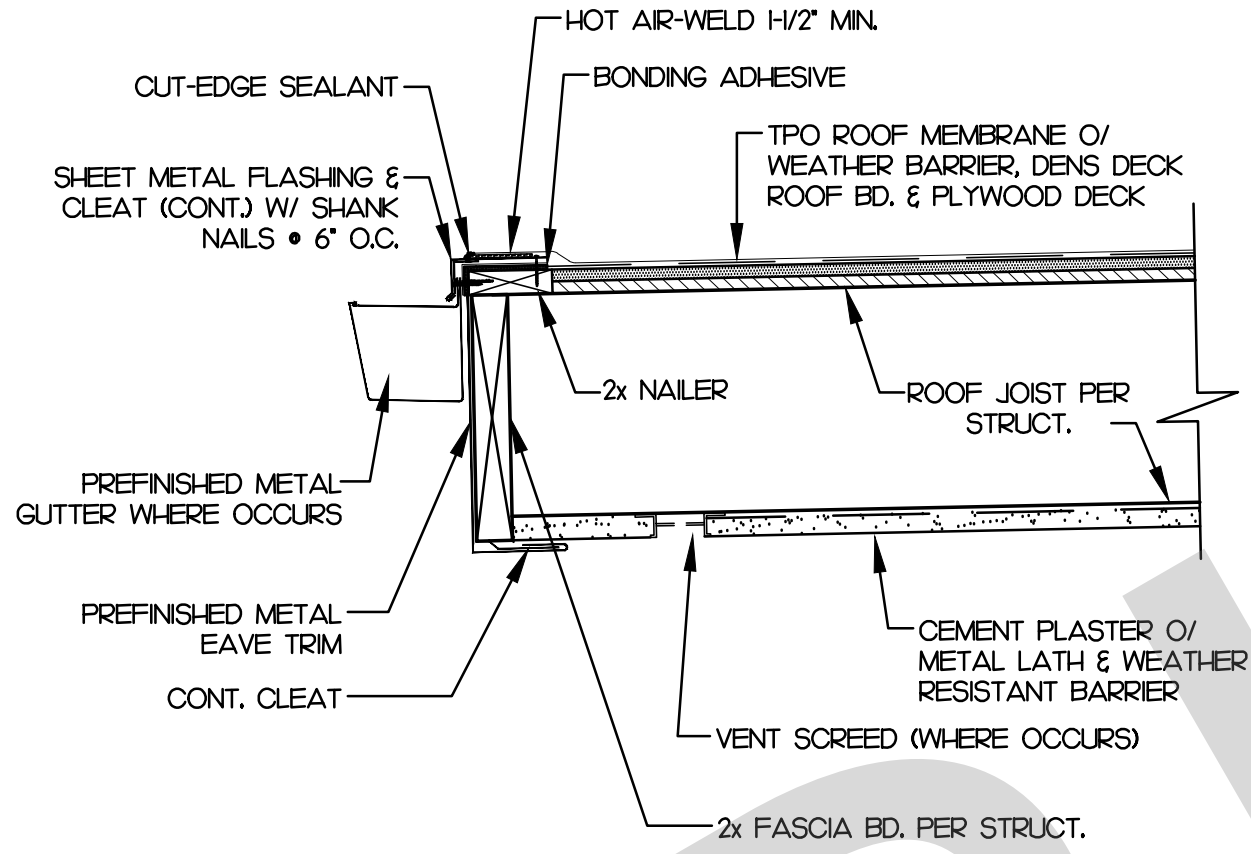

ROOF EDGE DETAIL

SCALE: 1/2"=1'-0"


21

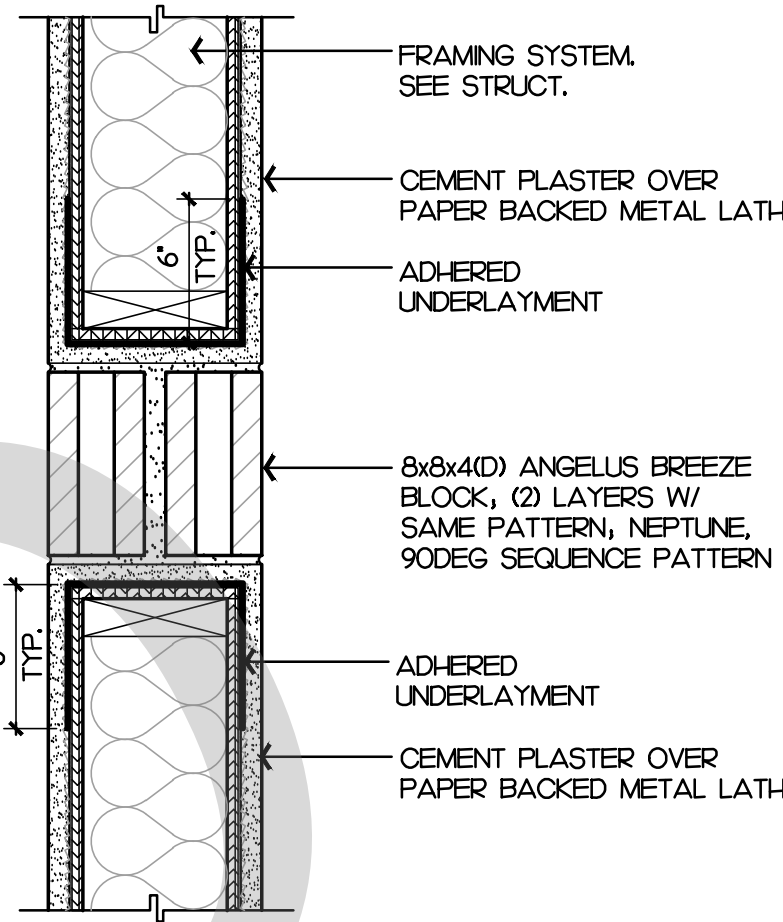

DETAIL

SCALE: 1/2"=1'-0"

18

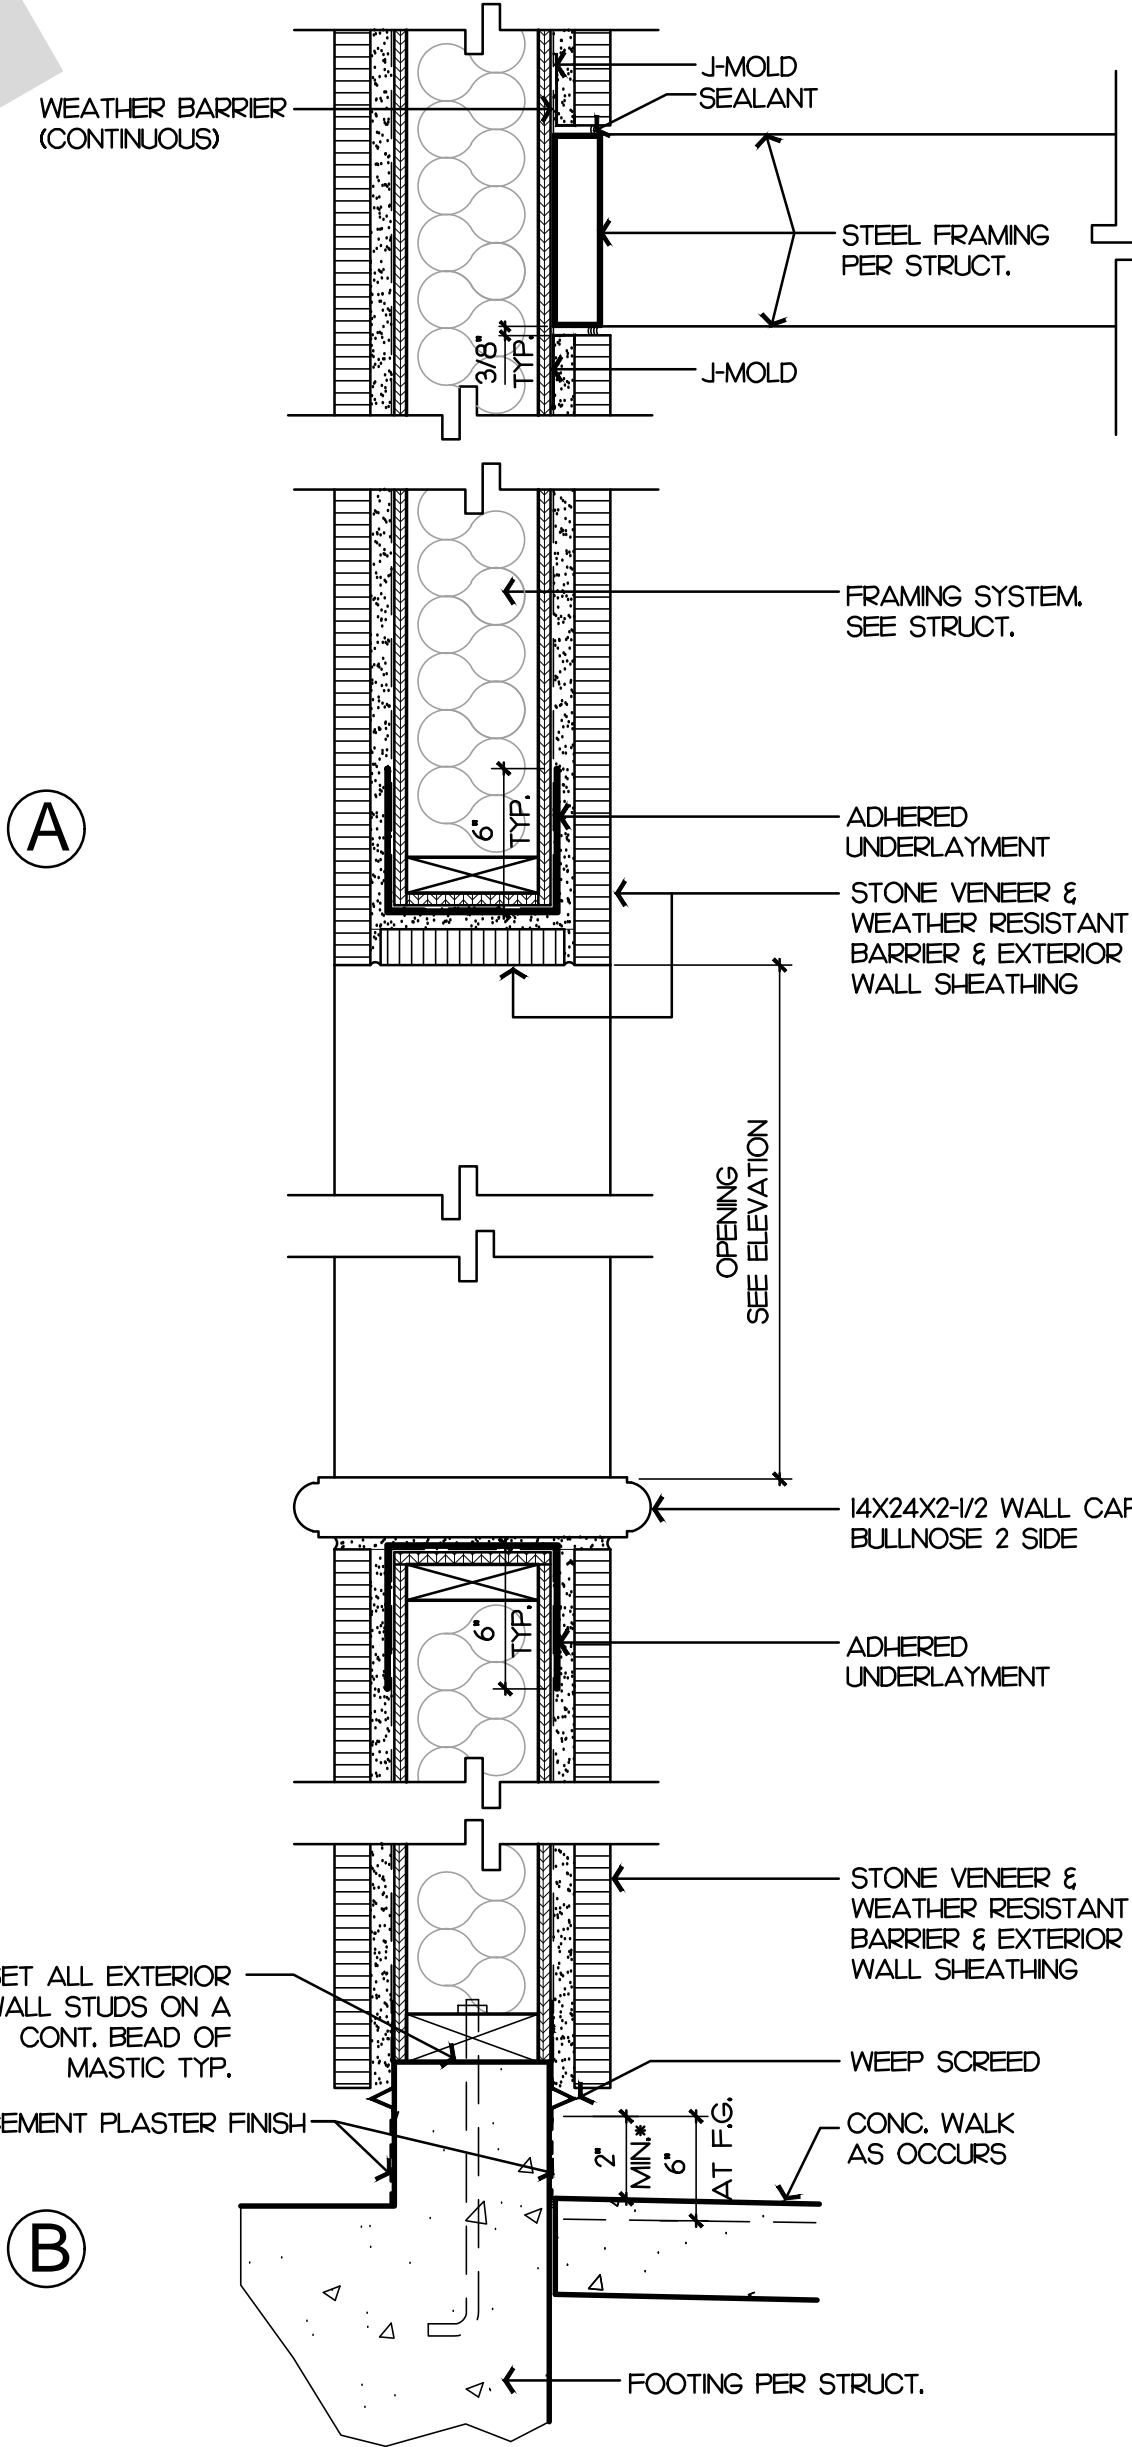


(A)

(B)

DETAIL

SCALE: 1/2"=1'-0"


19

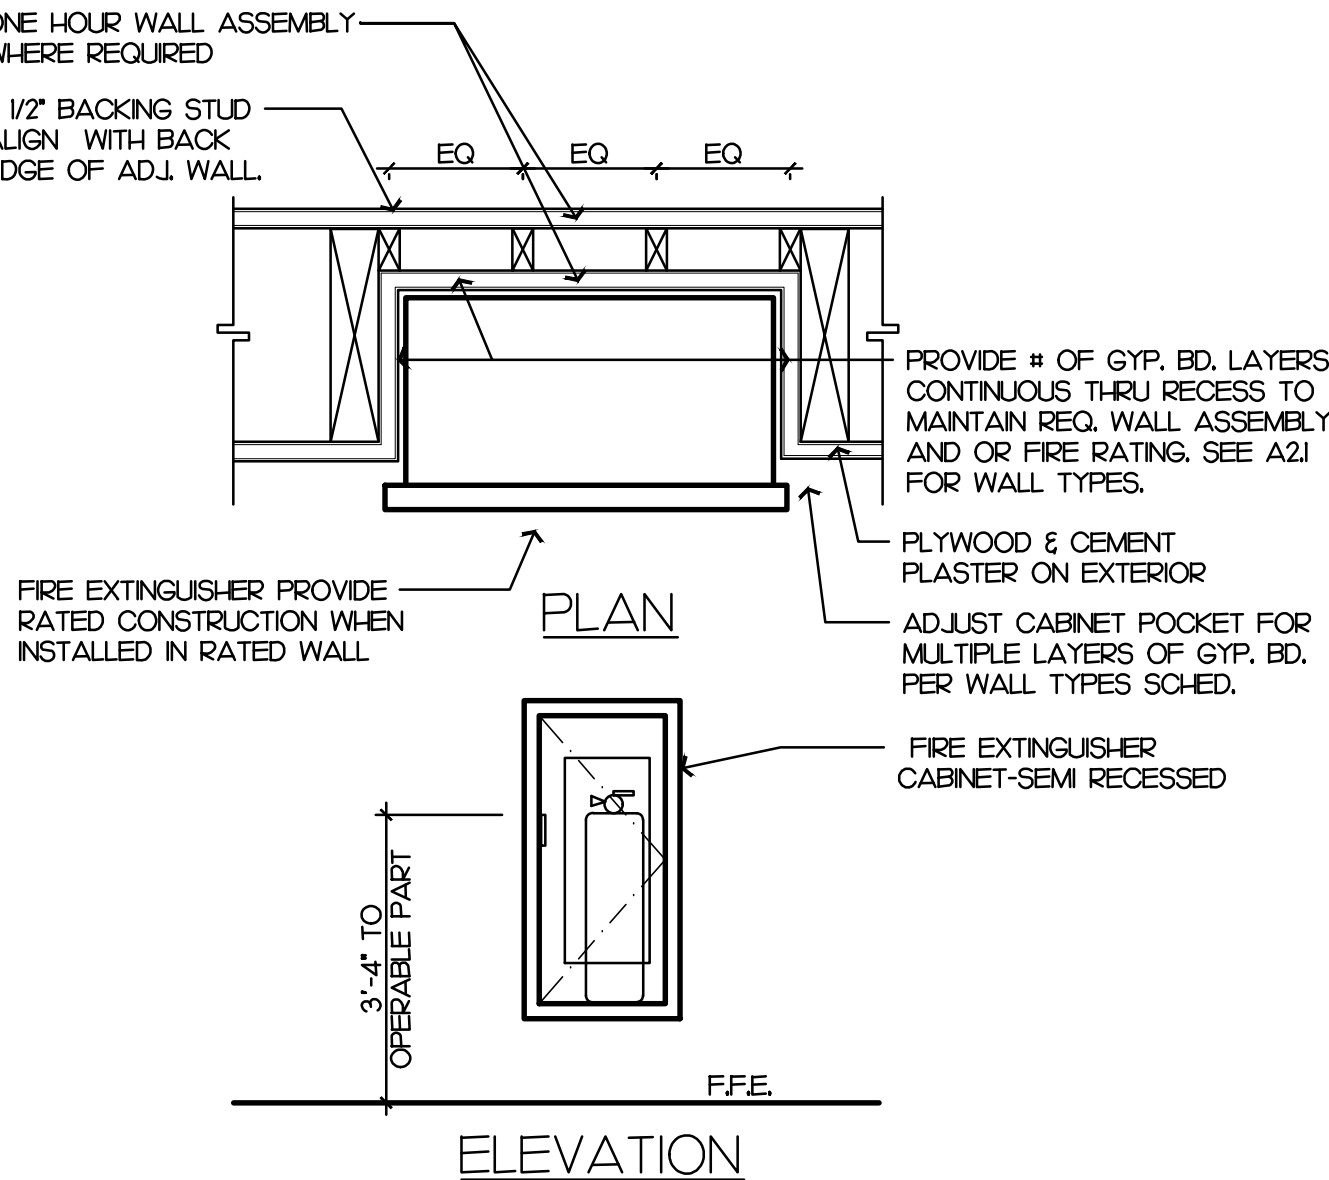

SEMI-RECESSED FIRE EXT.

SCALE: 3/4"=1'-0"

20

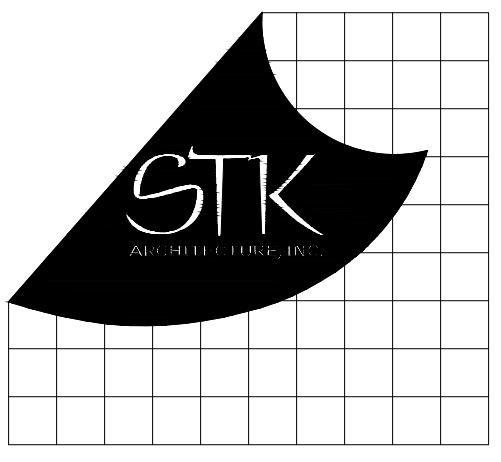

42055 DEVO DR., TEMECULA, CALIFORNIA 92590-3761
Phone: 951.296.8110 Fax: 951.296.6079 Email: stk@stkc.com

CONSULTANT:

PROJECT ADMINISTERED BY:
SAN BERNARDINO COUNTY
PROJECT & FACILITIES
MANAGEMENT DEPARTMENT

385 N. ARROWHEAD AVE.
SAN BERNARDINO, CA 92415

PROJECT NAME:
SAN BERNARDINO
COUNTY FIRE
DEPARTMENT:
FIRE STATION 226

PROJECT # 10101032
CIP #21-037
CAFM # SAB198
APN # 0273-011-22

1920 DEL ROSA AVE N.
SAN BERNARDINO,
CA 92404

ISSUE INFORMATION:		
DATE:	INFORMATION:	
04-11-2022	20% CD SET	
04-28-2022	50% CD SET	
06-15-2022	95% CD SET	
09-16-2022	95% CD- 3rd BAY	
10-03-2022	PLAN CHECK	

SHEET INFORMATION:
STK PROJECT NO.: 374-154-21
SCALE: AS NOTED
DATE: JANUARY 2021
PLOT DATE: -
DRAWING NAME: -

SEAL:



SHEET TITLE:

MISC. DETAILS


SHEET NO.:

A6.2



ASCE 7 Hazards Report

Address: No Address at This Location
Standard: ASCE/SEI 7-16
Risk Category: IV
Soil Class: C - Very Dense Soil and Soft Rock
Elevation: 1167.91 ft (NAVD 88)
Latitude: 34.13315
Longitude: -117.25332

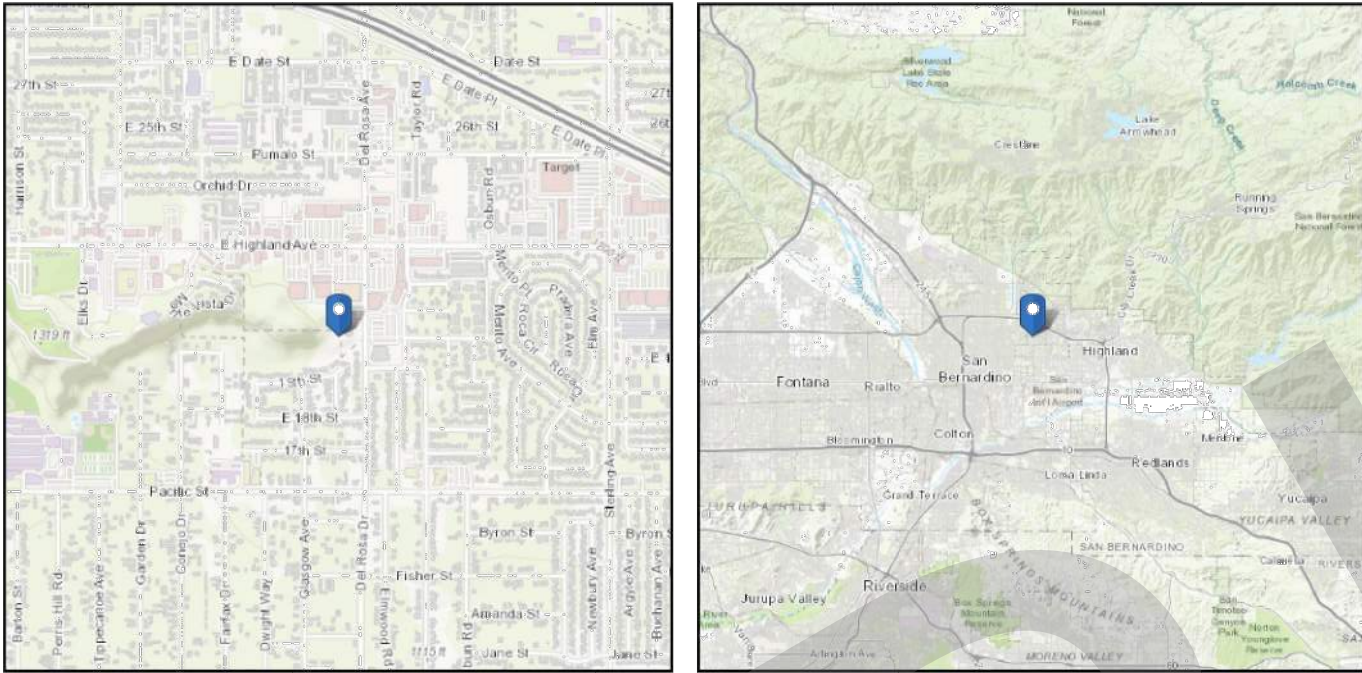

Wind

Results:

Wind Speed	107 Vmph
10-year MRI	67 Vmph
25-year MRI	73 Vmph
50-year MRI	77 Vmph
100-year MRI	82 Vmph

Data Source: ASCE/SEI 7-16, Fig. 26.5-1D and Figs. CC.2-1-CC.2-4, and Section 26.5.2
Date Accessed: Mon Mar 07 2022

Value provided is 3-second gust wind speeds at 33 ft above ground for Exposure C Category, based on linear interpolation between contours. Wind speeds are interpolated in accordance with the 7-16 Standard. Wind speeds correspond to approximately a 1.6% probability of exceedance in 50 years (annual exceedance probability = 0.00033, MRI = 3,000 years).

Site is not in a hurricane-prone region as defined in ASCE/SEI 7-16 Section 26.2.

<https://asce7hazardtool.online/>

Page 1 of 3

Mon Mar 07 2022

VALUES PER GEOTECH REPORT

Project No. 213764-1

Page 4

TABLE 1 – SUMMARY OF SEISMIC DESIGN PARAMETERS

Factor or Coefficient	Value
S _s	2.500g
S ₁	0.936g
F _a	1.2
F _v	1.4
S _{DS}	1.600g
S _{D1}	1.020g
S _{MS}	2.400g
S _{M1}	1.530g
T _L	8 Seconds
MCEG PGA	0.99g
Shear-Wave Velocity (V100)	2,018.9 ft/sec
Site Classification	C
Risk Category	IV

HISTORIC SEISMICITY

A computerized search, based on Southern California historical earthquake catalogs, has been performed using the computer program EQSEARCH (Blake, 1989-2000b) and the ANSS Comprehensive Earthquake Catalog (U.S.G.S., 2022a). The following table and discussion summarizes the historic seismic events (greater than or equal to M4.0) that have been estimated and/or recorded during the time period of 1800 to January 2022, within a 100-kilometer radius of the site.

TERRA GEOSCIENCES

GENERAL NOTES

SCS STRUCTURAL COVER SHEET

SN1 STRUCTURAL NOTES

SN2 STRUCTURAL NOTES

PLANS

S1 FOUNDATION PLAN

S2 LOW ROOF FRAMING PLAN

S3 HIGH / CLERESTORY ROOF FRAMING PLAN

S4 SITE STRUCTURES, STORAGE BUILDING & TRASH ENCLOSURE - ROOF FRAMING AND FOUNDATION PLANS

S5 SITE STRUCTURES, FUEL GENERATOR/TANK CANOPY - ROOF FRAMING AND FOUNDATION PLANS

STRUCTURAL DETAILS

SD1 FOUNDATION DETAILS

SD1.1 SITE & RETAINING WALL DETAILS


SD2 GENERAL WOOD FRAMING DETAILS

SD3 ROOF FRAMING DETAILS

SD3.1 AWNING FRAMING DETAILS

SD4 SITE STRUCTURE DETAILS

PROJECT DESIGN CRITERIA					
BUILDING CODE:	2019 CBC				
LOCATION (LATITUDE / LONGITUDE):	34.13315, -117.25332				
GEOTECHNICAL PARAMETERS:					
SOILS ENGINEER:	INLAND FOUNDATION ENGINEERING, INC.				
REPORT NUMBER:	S168-183				
DATE:	FEBRUARY 22, 2022 (ORIGINAL REPORT), JUNE 28, 2022 (LATERAL EARTH PRESSURE ADDENDUM)				
ALLOWABLE SOIL BEARING PRESSURE:	1,700PSF - 3,400PSF				
ALLOWABLE PASSIVE PRESSURE:	280PCF				
EXPANSION POTENTIAL:	LOW				
LIQUEFACTION POTENTIAL:	NONE				
TOTAL SETTLEMENT:	LESS THAN 1"				
DIFFERENTIAL SETTLEMENT POTENTIAL:	LESS THAN 1" OVER 40'				
CORROSIVITY:	MILD				
SULFATE CONTENT:	CLASS SO				
CHLORIDE CONTENT:	19 PPM				
SEISMIC DESIGN PARAMETERS:					
RISK CATEGORY:	IV				
SITE CLASS:	C				
SHORT PERIOD SPECTRAL ACCELERATION, S _{0.2} :	2.500				
1s PERIOD SPECTRAL ACCELERATION, S ₁ :	0.936				
SPECTRAL RESPONSE COEFFICIENT, S _{DP} :	1.020				
SHORT PERIOD SPECTRAL RESPONSE, S _{0.2} :	1.600				
SITE COEFFICIENT, F _a :	1.2				
SITE COEFFICIENT, F _v :	1.4				
SEISMIC DESIGN CATEGORY:	F				
SEISMIC IMPORTANCE FACTOR, I _e :	1.5				
RESPONSE MODIFICATION, R & SEISMIC FORCE RESISTING SYSTEM:	6.5 - LIGHT FRAMED SHEAR WALLS				
DESIGN PROCEDURE:	EQUIVALENT LATERAL FORCE				
REDUNDANCY FACTOR, ρ:	1.3				
SYSTEM OVERSTRENGTH FACTOR, Ω:	2.5				
DEFLECTION AMPLIFICATION FACTOR, C _d :	4.0				
HORIZONTAL STRUCTURAL IRREGULARITIES:	NONE				
VERTICAL STRUCTURAL IRREGULARITIES:	NONE				
WIND DESIGN PARAMETERS:					
RISK CATEGORY:	II				
WIND EXPOSURE CATEGORY:	C				
ULTIMATE DESIGN WIND SPEED (3-SECOND GUST), V _{ULT} :	107				
NOMINAL DESIGN WIND SPEED (3-SECOND GUST), V _{ASD} :	83 MPH				
INTERNAL PRESSURE COEFFICIENT, GC _{pi} :	±0.18				
GRAVITY DESIGN PARAMETERS: (PSF, SERVICE LOADS)					
	DEAD	ROOF LIVE	SNOW	LIVE	TOTAL
ROOF:	15	20	-	-	35
EXTERIOR WALL:	15	-	-	-	15
INTERIOR WALL:	10	-	-	-	10

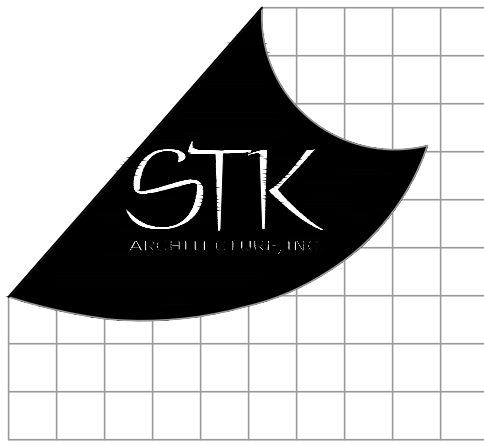

43095 DEVO DR, TEMECULA, CALIFORNIA 92590-3760
Phone: 951.296.8110 Fax: 951.296.6079 Email: sk@stkinc.com

CONSULTANT:



INNOVATIVE

STRUCTURAL ENGINEERING

27189 VIA INDUSTRIAL

TEMECULA, CA 92590

TEL: 951.400.1032

WWW.ISEENGINEERS.COM

SOCAL | NORCAL | COLORADO

ISE PROJECT NO.: 22-7067

PROJECT MANAGER:

SANDY FONG EXT. 1016

SANDY@ISEENGINEERS.COM

PROJECT ADMINISTERED BY:

SAN BERNARDINO COUNTY

REAL ESTATE SERVICES

DEPARTMENT -

PROJECT MANAGEMENT

DIVISION

385 N. ARROWHEAD AVE.
SAN BERNARDINO, CA 92415

PROJECT NAME:

SAN BERNARDINO

COUNTY FIRE

DEPARTMENT:

FIRE STATION 226

PROJECT # 10.10.1032

CIP # _____

CAFM # _____

1920 DEL ROSA AVE N.
SAN BERNARDINO,
CA 92404

ISSUE INFORMATION:

DATE: INFORMATION:

10-03-2022 PLAN CHECK

SHEET INFORMATION:

STK PROJECT NO.: 374-154-21

SCALE: AS NOTED

DATE: SEPTEMBER 2022

PLOT DATE: 09-28-2022

DRAWING NAME:

SEAL:



SHEET TITLE:

STRUCTURAL
COVER SHEET

SHEET NO.:

SCS

WOOD MANUFACTURED PLATED TRUSSES

- MANUFACTURED PLATED TRUSSES ARE A DEFERRED SUBMITTAL ITEM. SEE DESIGN/BUILD NOT GRAVITY LOADS. REFER TO PROJECT DESIGN CRITERIA FOR ALL ROOF & FLOOR MEMBER GRAVITY LOAD REQUIREMENTS. TRUSSES SHALL BE DESIGNED WITH CONSIDERATION FOR ALL SUPERIMPOSED LOADS, SUCH AS CHIMNEY FLUE FRAMING, MECHANICAL EQUIPMENT, ETC.
- LATERAL LOADS: TRUSSES SHALL BE DESIGNED FOR SPECIFIC DRAG LOADS NOTED ON THE STRUCTURAL PLANS. ALL GABLE END TRUSSES SHALL BE DESIGNED FOR A MINIMUM 1000' LATERAL LOAD.
- MATERIAL: ALL TRUSSES SHALL UTILIZE DOUGLAS FIR LUMBER UNLESS NOTED OTHERWISE.

- DESIGN & CONSTRUCTION: THE STRUCTURAL DESIGN, MEANS OF CONSTRUCTION AND BRACING OF TRUSSES IS THE SOLE RESPONSIBILITY OF THE TRUSS MANUFACTURER AND ENGINEER OF RECORD FOR THE TRUSS DESIGN AND NOT ISE.
- SHOP DRAWINGS: THE TRUSS SUPPLIER SHALL SUBMIT SHOP DRAWINGS TO ISE FOR REVIEW AND APPROVAL FOR GENERAL CONFORMANCE TO THE BUILDING STRUCTURAL DESIGN. THE SHOP DRAWINGS SHOULD INCLUDE A FLOOR PLAN LAYOUT AND DESIGN FOR EACH SPECIFIC TRUSS. THE TRUSS CALCULATION SHOULD INCLUDE MATERIAL TYPE, LOADING, TRUSS PROFILE AND REACTIONS.
- HANGERS: THE TRUSS SUPPLIER SHALL SPECIFY ALL TRUSS TO TRUSS & TRUSS TO FRAMING MEMBER HANGERS.
- LAYOUT & SPACING: THE STRUCTURAL PLANS SPECIFY A RECOMMENDED SPACING OF TRUSSES. THE TRUSS DESIGN PACKAGE DETERMINES THE FINAL SPACING OF TRUSSES. THE INTENT OF THE STRUCTURAL PLANS IS A RECOMMENDATION AND IN NO WAY REPRESENTS THE FINAL TRUSS SHAPE, CONFIGURATION OR SPACING.
- TRUSS DEFLECTION SHALL BE LIMITED TO THE FOLLOWING:

DEFLECTION CRITERIA		
LEVEL	LIVE LOAD	TOTAL LOAD
ROOF	L360	L240
FLOOR	L600	L240

CONVENTIONAL WOOD FRAMING REQUIREMENTS - CBC & TABLE 2304.10.1		
CONNECTION	NAILING	
BLOCKING BETWEEN JOISTS OR RAFTERS TO TOP PLATES, TOENAIL, END NAIL	(2) 8d COMMON, (3) 3" x 0.131" NAILS, OR (4) 3" x 14 GAGE STAPLES	
BLOCKING BETWEEN RAFTERS OR TRUSS NOT AT WALL, TOP PLATES, TOENAIL, END NAIL	(2) 8d COMMON, (3) 3" x 0.131" NAILS, (3) 3" x 14 GAGE STAPLES	
BLOCKING BETWEEN RAFTERS OR TRUSS NOT AT WALL, TOP PLATES, END NAIL	(2) 16d COMMON, (3) 3" x 0.131" NAILS, (3) 3" x 14 GAGE STAPLES	
FACE BLOCKING TO TRUSS/WEB FILLER, FACE NAIL	(2) 16d COMMON, (3) 3" x 0.131" NAILS, (3) 3" x 14 GAGE STAPLES	
CEILING JOIST TO TOP PLATE, EACH JOIST, TOENAIL	(3) 8d COMMON, (3) 3" x 0.131" NAILS, (3) 3" x 14 GAGE STAPLES, 3/4" CROWN	
CEILING JOIST, LAP PARTITION, FACE NAIL - TABLE 2308.7.3.1	(3) 16d COMMON, (4) 3" x 0.131" NAILS, (4) 3" x 14 GAGE STAPLES, 3/4" CROWN	
CEILING JOISTS TO PARALLEL RAFTERS, FACE NAIL - TABLE 2308.7.3.1	PER TABLE 2308.7.3.1	
COLLAR TIE TO RAFTER, FACE NAIL	(3) 10d COMMON, (4) 3" x 0.131" NAILS, OR (4) 3" x 14 GAGE STAPLES	
RAFTER OR ROOF TRUSS TO PLATE, TOENAIL - TABLE 2308.7.5	(3) 10d COMMON, (4) 3" x 0.131" NAILS, OR (4) 3" x 14 GAGE STAPLES	
ROOF RAFTER TO 2X RIDGE BEAM, END NAIL	(2) 16d COMMON, (3) 3" x 0.131" NAILS, OR (3) 3" x 14 GAGE STAPLES	
ROOF RAFTER TO 2X RIDGE BEAM, TOE NAIL	(3) 10d COMMON, (4) 3" x 0.131" NAILS, OR (4) 3" x 14 GAGE STAPLES	
STUD TO STUD (NON-BRACED WALL PANELS), 24" O.C. FACE NAIL	16d COMMON ((3) 3/2" x .162)	
STUD TO STUD (NON-BRACED WALL PANELS), 16" O.C. FACE NAIL	3" x 0.131" NAILS, (3) 3" x 14 GAGE STAPLES	
STUD TO STUD AT INTERSECTING CORNER (BRACED), 16" O.C. FACE NAIL	16d COMMON ((3) 3/2" x .162)	
STUD TO STUD AT INTERSECTING CORNER (BRACED), 12" O.C. FACE NAIL	3" x 0.131" NAILS, (3) 3" x 14 GAGE STAPLES	
BUILT-UP HEADER (2" TO 2"), 16" O.C. EACH EDGE, FACE NAIL	16d COMMON ((3) 3/2" x .162)	
CONTINUOUS HEADER TO STUD, TOENAIL	(4) 8d COMMON	
TOP PLATE TO TOP PLATE, 16" O.C. FACE NAIL	16d COMMON	
TOP PLATE TO TOP PLATE, 12" O.C. FACE NAIL	3" x 0.131" NAILS, 3" x 14 GAGE STAPLES	
TOP PLATE TO TOP PLATE, AT END JOINTS, EACH SIDE OF END JOINT, FACE NAIL, MIN. 24" LAP SPICE LENGTH EACH SIDE OF END JOINT	(3) 16d COMMON, (12) 3" x 0.131" NAILS, (12) 3" x 14 GAGE STAPLES	
BOTTOM PLATE TO JOIST, RIM JOIST, OR BLOCKING AT NON-BRACED PANEL, 16" O.C. FACE NAIL	16d COMMON	
BOTTOM PLATE TO JOIST, RIM JOIST, OR BLOCKING AT NON-BRACED PANEL, 12" O.C. FACE NAIL	3" x 0.131" NAILS, 3" x 14 GAGE STAPLES	
BOTTOM PLATE TO JOIST, RIM JOIST, OR BLOCKING AT BRACED PANEL, 16" O.C. FACE NAIL	(2) 16d COMMON, (4) 3" x 0.131" NAILS, (4) 3" x 14 GAGE STAPLES	
STUD TO TOP OR BOTTOM PLATE, TOENAIL	(4) 8d COMMON, (4) 3" x 0.131" NAILS, (4) 3" x 14 GAGE STAPLES	
STUD TO TOP OR BOTTOM PLATE, END NAIL	(2) 16d COMMON, (3) 3" x 0.131" NAILS, (3) 3" x 14 GAGE STAPLES	
TOP OR BOTTOM PLATE TO STUD, END NAIL	(2) 16d COMMON, (3) 3" x 0.131" NAILS, (3) 3" x 14 GAGE STAPLES	
TOP PLATES, LAP AND INTERSECTIONS, FACE NAIL	(2) 16d COMMON, (3) 3" x 0.131" NAILS, OR (3) 3" x 14 GAGE STAPLES	
1" BRACE TO EACH STUD AND PLATE, FACE NAIL	(2) 8d COMMON, (2) 3" x 0.131" NAILS, OR (2) 3" x 14 GAGE STAPLES	
1" x 6" SHEATHING TO EACH BEARING, FACE NAIL	(2) 8d COMMON, (2) 3" x 0.128" NAILS	
1" x 8" AND WIDER SHEATHING TO EACH BEARING, FACE NAIL	(3) 8d COMMON, (3) 3" x 0.131" NAILS	
JOIST TO SILL, OR GIRDER, TOENAIL	(3) 8d COMMON, (3) 3" x 0.131" NAILS, OR (3) 3" x 14 GAGE STAPLES	
RIM JOIST, BLOCKING TO TOP PLATE, 16" O.C. FACE NAIL	8d (12" x 0.131" AT 6" o.c., 3" x 0.131" NAILS AT 6" o.c., OR 3" x 14 GAGE STAPLES AT 6" o.c.)	
1" x 6" SUBFLOOR OR LESS TO EACH JOIST, FACE NAIL	(2) 8d COMMON	
2" SUBFLOOR TO JOIST OR GIRDER, BLIND AND FACE NAIL	(2) 16d COMMON	
2" PLANKS	(2) 16d COMMON AT EACH BEARING	
BUILT-UP GIRDER AND BEAMS	20d COMMON AT 32" o.c., 3" x 0.131" NAILS AT 24" o.c., OR 3" x 14 GAGE STAPLES AT 24" o.c. AT TOP AND BOTTOM, STAGGERED	
LEDGER STRIP, EACH JOIST OR RAFTER, FACE NAIL	(3) 16d COMMON, (4) 3" x 0.131" NAILS, OR (4) 3" x 14 GAGE STAPLES	
JOIST TO BAND JOIST, TOENAIL	(3) 16d COMMON, (4) 3" x 0.131" NAILS, OR (4) 3" x 14 GAGE STAPLES	
BRIDGING TO JOIST, TOENAIL, EACH END	(2) 8d COMMON, (2) 3" x 0.131" NAILS, OR (2) 3" x 14 GAGE STAPLES	
BRIDGING TO JOIST, TOENAIL, EACH END	(2) 8d COMMON, (2) 3" x 0.131" NAILS, OR (2) 3" x 14 GAGE STAPLES	

EARTHWORK AND FOUNDATIONS

- GEOTECHNICAL REPORT: PERFORM SOILS WORK COMPLYING WITH FOUNDATION DESIGN BASED ON RECOMMENDATIONS IN SOILS REPORT. SEE STRUCTURAL COVER SHEET FOR SOILS REPORT NUMBER AND DATE.
- ALLOWABLE FOUNDATION DESIGN VALUES PER GEOTECHNICAL REPORT: VALUES BELOW MAY BE INCREASED 33 PERCENT FOR TRANSIENT LOADING.
 - BEARING CAPACITY: SEE PROJECT DESIGN CRITERIA
 - PASSIVE LATERAL BEARING PRESSURE: SEE PROJECT DESIGN CRITERIA
 - COEFFICIENT OF FRICTION: SEE PROJECT DESIGN CRITERIA
- GRADING, EXCAVATIONS, BACKFILL AND COMPACTION OF BACKFILL: COMPLY WITH GEOTECHNICAL REPORT AND REQUIREMENTS OF GOVERNING CODE AUTHORITY AND PERFORM ONLY UNDER CONTINUOUS SPECIAL INSPECTION OF GEOTECHNICAL ENGINEER.
- PREPARATION OF SOIL UNDER BUILDING PAD: SEE GEOTECHNICAL REPORT FOR OVER-EXCAVATION OF EXISTING SOIL AND INSTALLATION OF PROPERLY COMPACTED BACKFILL.
- FOUNDATION EXCAVATIONS: FOUNDATIONS ARE TO BEAR ON FIRM EXISTING SOIL, OR APPROVED COMPACTED FILL. INSIDE OF SHORE RETAINING WALLS DURING BACKFILL, EXCAVATIONS ARE TO BE INSPECTED BY GEOTECHNICAL ENGINEER PRIOR TO PLACEMENT OF REINFORCING STEEL AND FORMWORK. ENSURE EXCAVATIONS ARE CLEANS, DRY AND FREE OF DEBRIS OR LOOSE SOIL. SLOPE SIDES OF EXCAVATION NOT LESS THAN MINIMUM SLOPE INDICATED IN GEOTECHNICAL REPORT. CAST CONCRETE DIRECTLY AGAINST EXCAVATED SURFACES.
- BACKFILLING OF RETAINING WALLS: PLACE AFTER COMPLETION AND INSPECTION OF WATERPROOFING. ADEQUATELY SHORE RETAINING WALLS DURING BACKFILL OPERATION. UNLESS ADEQUATELY SHORED, DO NOT PLACE BACKFILL BEHIND BUILDING STRUCTURE RETAINING WALLS EXCLUDING SITE RETAINING WALLS UNTIL CONCRETE AT ELEVATED FLOOR LEVELS ADJACENT TO WALLS ARE COMPLETELY CURED (IN AREA) AND HAVE CURED FOR AT LEAST 7 DAYS.
- WATER EXPOSURE AT BUILDING PERIMETER FOOTINGS: AT AREAS WHERE SIDEWALKS OR PAVING DO NOT IMMEDIATELY ADJOIN STRUCTURE, PROVIDE POSITIVE DRAINAGE AWAY FROM STRUCTURE AT BUILDING PERIMETER. LANDSCAPE PAVING IS NOT PERMITTED WITHIN FIVE FEET OF BUILDING PERIMETER FOOTINGS EXCEPT WHEN ENCLOSED IN PROTECTED PLANTERS WITH DIRECT DRAINAGE AWAY FROM STRUCTURE OR WHICH COMPLY WITH APPLICABLE CODE. DISCHARGE FROM DOWN SPOUTS, PIPES, DRAINS AND SCOUTERS IS NOT PERMITTED ONTO UNPROTECTED SOILS WITHIN FIVE FEET OF BUILDING PERIMETER. REFER TO GEOTECHNICAL REPORT FOR COMPLETE REQUIREMENTS.

WOOD FRAMING

- SAWN LUMBER: ALL STRUCTURAL SAWN LUMBER SHALL BE DOUGLAS FIR LARCH WITH 19% MAXIMUM MOISTURE CONTENT OF THE FOLLOWING GRADES, CONFORMING TO STANDARD GRADING RULES FOR WEST COAST LUMBER NO. 17. UNLESS NOTED OTHERWISE, THE LUMBER GRADES AS SPECIFIED BELOW MEET MINIMUM REQUIREMENTS:

LUMBER GRADES		
CONDITION	GRADE	
PLATES & BLOCKING	STANDARD OR BETTER	
STUDS TO 10'-0" IN HEIGHT	STANDARD OR BETTER	
STUDS OVER 10'-0" IN HEIGHT	#2	
2x RAFTER JOISTS	#2	
4x6 THROUGH 4x12 BEAMS, HEADER & POSTS	#1	
4x14 BEAMS, HEADERS & POSTS	#1	
4x4 POSTS, HEADERS	#1	
6x AND LARGER POSTS, BEAMS, STRINGERS	#1	

- GRADE STAMPS: WHERE POSSIBLE ALL LUMBER GRADE STAMPS SHALL REMAIN ON LUMBER AFTER INSTALLATION. CONVENTIONAL LUMBER SHALL MEET DOC PS 20 REQ.
- PRESSURE TREATED LUMBER: ALL EXPOSED EXTERIOR WOOD AND WOOD BEARING ON CONCRETE OR MASONRY SHALL BE PRESSURE TREATED PER ALL NAILS TO PLATES TREATED w/ BORATE MAY BE STANDARD NAILS. FOR ALL OTHER PRESSURE TREATED PLATES, USE HOT DIP GALVANIZED NAILS.
- PLYWOOD/OSB: EACH WOOD-BASED STRUCTURAL-USE PANEL USED FOR DIAPHRAGM CONSTRUCTION SHALL BE IDENTIFIED BY A REGISTERED STAMP OR BRAND OF AN ICC-APPROVED CODE COMPLIANCE ASSURANCE AGENCY WOOD-BASED STRUCTURAL-USE PANELS SHALL MEET THE REQUIREMENTS OF DOC PS 1 OR PS 2. ALL PANELS SHALL BE GLUED WITH EXTERIOR TYPE ADHESIVE AND APPLIED TO ALL EXPOSED EDGES PERMANENTLY EXPOSED TO THE OUTDOORS SHALL BE EXTERIOR TYPE.

- METAL CONNECTORS: ALL METAL CONNECTORS SHALL BE THOSE MANUFACTURED BY SIMPSON STRONG TIE OR USP LUMBER CONNECTORS. THE NAILS FOR THESE CONNECTORS SHALL BE AS SPECIFIED BY THE MANUFACTURERS FOR CAPACITY OF THE HARDWARE. ALL CALCULATIONS REFER TO SIMPSON PRODUCT CODES AND NAMES. REFER TO CROSS REFERENCE TABLES PROVIDED BY USP IN THEIR PRODUCT CATALOGS.
- FIRE STOPS: PROVIDE FIRE STOPS AT ALL INTERSECTIONS OF STUD WALLS AT FLOOR, CEILING AND ROOF. FIRE STOPS SHALL BE 2x NOMINAL THICKNESS OF WOOD AND SHALL BE THE FULL WIDTH OF THE EXPOSED SPACE. PLACE FIRE STOPS AT A MAXIMUM SPACING OF 10'-0" IN THE VERTICAL DIRECTION. PROVIDE 2x FIRE STOPS IN ALL FURRED SPACES. ALL CALCULATIONS REFER TO SIMPSON PRODUCT CODES AND NAMES. REFER TO CROSS REFERENCE TABLES PROVIDED BY USP IN THEIR PRODUCT CATALOGS.

- BOLT HOLES: IN WOOD SHALL BE 1/32" TO 1/16" LARGER THAN THE NOMINAL BOLT DIAMETER. ALL BOLTS SHALL HAVE A STANDARD OUT WASHER UNDER HEAD AND NUT UNLESS NOTED OTHERWISE.
- BOLTS: ALL BOLTS USED FOR WOOD CONNECTIONS SHALL BE ASTM A307, U.S. N.O. ALL NUTS AND BOLTS SHALL BE RE-TIGHTENED PRIOR TO THE APPLICATION OF SHEATHING, PLASTER, ETC.

- NOTCHING & CUTTING: STRUCTURAL MEMBERS SHALL NOT BE CUT FOR PIPES, ETC. UNLESS SPECIFICALLY DETAILED. NOTCHING OF HORIZONTAL STRUCTURAL MEMBERS SHALL CONFORM TO THE BUILDING CODE. NOTCHING AND BORING OF STUDS AND TOP PLATES SHALL CONFORM TO THE BUILDING CODE.

- JOIST BLOCKING: PROVIDE 2x BLOCKING BETWEEN JOISTS AND RAFTERS AT ALL BEARING SUPPORTS UNLESS CROSS BRIDGING OR SOLID BLOCKING SHALL BE PROVIDED AT 8'-0" O.C. MAXIMUM FOR ALL JOISTS UNLESS BOTH EDGES ARE HELD IN LINE FOR THEIR ENTIRE LENGTH.
- JOIST HANGERS: FOR JOISTS, PROVIDE SIMPSON 'LUS' HANGER. FOR CONVENTIONAL JOIST, USE SIMPSON 'LUS' HANGER, OR EQUIVALENT.

- BEAM BEARING: ALL BEAMS TO BE SUPPORTED WITH FULL BEARING UNLESS NOTED OTHERWISE.

- CONVENTIONAL FRAMING: ALL CONVENTIONAL FRAMED PORTIONS OF THE STRUCTURE ARE TO BE CONSTRUCTED PER CBC SECTION 2308.
- WALLS ON WOOD FLOOR: PROVIDE SINGLE FLOOR JOIST BELOW NON-BEARING, PARALLEL WALLS 10'-0" OR LONGER.

- FINGER JOINTED STUDS: IT IS STRUCTURALLY ACCEPTABLE TO USE STRUCTURAL GLUED (FINGER JOINTED) LUMBER. ALL FINGER JOINTED LUMBER MUST BE 'GER EXT. JNTS' AND CONFORM WITH THE WWPA'S GLUED JOINTS PROPERTIES AND QUALITY CONTROL. FINGER JOINTED LUMBER IS TO BE STAMPED WITH 'GER EXT. JNTS' AND MAY BE USED IN DETACHED JOINTS WITH ANY SOLID-SAWN LUMBER PRODUCT OF THE SAME SPECIES AND GRADES. PLEASE REFER TO LUMBER SPECIFICATION IN THE STRUCTURAL GENERAL NOTES AND CALCULATIONS.

- PLATE WASHERS AT NON-SILL PLATE APPLICATION: MINIMUM SIZE FOR SQUARE PLATE WASHERS: REFER TO PLANS FOR SILL PLATE WASHER REQUIREMENTS.)

PLATE WASHERS-NOT SILL PLATE APPLICATION		
BOLT SIZE	PLATE WASHER SIZE	
3/8"	3" x 2" x 2"	
1/2"	3" x 2" x 2"	
5/8"	3" x 2" x 2"	
1"	3" x 2" x 2"	

MANUFACTURED LUMBER PRODUCTS

- MANUFACTURED LUMBER: ALL MANUFACTURED SHALL HAVE ICC APPROVAL FOR THE LATEST BUILDING CODE.
- SIZES & STRENGTH: THE FOLLOWING MINIMUM DESIGN VALUES MUST BE ACHIEVED FOR EACH TYPE OF MANUFACTURED LUMBER SPECIFIED ON THE STRUCTURAL PLANS.

STRUCTURAL COMPOSITE LUMBER			
BEAM TYPE	Fb (PSI)	Fv (PSI)	E (PSI x 10^-6)
PSL - PARALLAM	2,500	250	2.0
LVL - MICROLAM	2,600	285	1.9
LSL - TIMBERSTRAND	2,325	310	1.55
RIM - TIMBERSTRAND	1,700	400	1.55
1" x 6" SUBFLOOR OR LESS TO EACH JOIST, FACE NAIL	8d (12" x 0.131" AT 6" o.c., 3" x 0.131" NAILS AT 6" o.c., OR 3" x 14 GAGE STAPLES AT 6" o.c.)		
2" SUBFLOOR TO JOIST OR GIRDER, BLIND AND FACE NAIL	(2) 16d COMMON		
2" PLANKS	(2) 16d COMMON AT EACH BEARING		
BUILT-UP GIRDER AND BEAMS	20d COMMON AT 32" o.c., 3" x 0.131" NAILS AT 24" o.c., OR 3" x 14 GAGE STAPLES AT 24" o.c. AT TOP AND BOTTOM, STAGGERED		
LEDGER STRIP, EACH JOIST OR RAFTER, FACE NAIL	(3) 16d COMMON, (4) 3" x 0.131" NAILS, OR (4) 3" x 14 GAGE STAPLES		
JOIST TO BAND JOIST, TOENAIL	(3) 16d COMMON, (4) 3" x 0.131" NAILS, OR (4) 3" x 14 GAGE STAPLES		
BRIDGING TO JOIST, TOENAIL, EACH END	(2) 8d COMMON, (2) 3" x 0.131" NAILS, OR (2) 3" x 14 GAGE STAPLES		
BRIDGING TO JOIST, TOENAIL, EACH END	(2) 8d COMMON, (2) 3" x 0.131" NAILS, OR (2) 3" x 14 GAGE STAPLES		

WOOD HARDWARE NAILING SCHEDULE			
HOLD-DOWNS			
MODEL NAME	CAPACITY (LBS)	FASTENER SCHEDULE	APPLICATION
STH14	3,500	(24) 10d Nails (0.148" x 3-3/4")	HOLD-DOWN
HTH4	4,455	(10) 3/8" x 10-1/2"	HOLD-DOWN
HU4	4,565	(10) 3/8" x 2-3/8" S08	HOLD-DOWN
HU5	5,645	(14) 3/8" x 2-3/8" S08	HOLD-DOWN
HU8	6,795	(20) 3/8" x 2-3/8" S08	HOLD-DOWN
HU11	9,335	(30) 3/8" x 2-3/8" S08	HOLD-DOWN
HU14	10,770	(36) 3/8" x 2-3/8" S08	HOLD-DOWN

ANCHOR BOLTS			
MODEL NAME	CAPACITY (LBS)	FASTENER SCHEDULE	APPLICATION
SSTB20	4,785	3/4"	HOLD-DOWN ANCHOR
SSTB24	5,790	3/4"	HOLD-DOWN ANCHOR
SSTB28	11,645	3/4"	HOLD-DOWN ANCHOR
SB1x30	13,090	1"	HOLD-DOWN ANCHOR

HARDWARE			
MODEL NAME	CAPACITY (LBS)	FASTENER SCHEDULE	APPLICATION
A34	465	(8) 8d Nails (0.131" x 1-1/2")	AT BLOCKING OR RIM
A35	650	(12) 8d Nails (0.131" x 1-1/2")	AT BLOCKING OR RIM
LTP4	625	(12) 8d Nails (0.131" x 1-1/2")	AT BLOCKING OR RIM
LTP5	565	(12) 8d Nails (0.131" x 1-1/2")	AT BLOCKING OR RIM
L550	560	(8) 8d Nails (0.131" x 1-1/2")	AT BLOCKING OR RIM

STRAPS			
MODEL NAME	CAPACITY (LBS)	FASTENER SCHEDULE	APPLICATION
CS16	1,705	(22) 8d Nails (0.131" x 2-1/2")	DIRECTLY TO TIMBER
CS16	1,705	(22) 8d Nails (0.131" x 2-1/2")	THRU PLYWOOD
CS14	2,490	(30) 8d Nails (0.131" x 2-1/2")	DIRECTLY TO TIMBER
CMSTC16	4,690	(60) 10d Nails (0.148" x 3-3/4")	DIRECTLY TO TIMBER
CMST14	6,475	(66) 10d Nails (0.148" x 3-3/4")	DIRECTLY TO TIMBER
CMST12	9,215	(86) 10d Nails (0.148" x 3-3/4")	DIRECTLY TO TIMBER

NAIL TYPE	SHEAR WALL TYPE	NAIL SIZE
8d COMMON	SW 2, 3, 4	2-1/2" x .131"
10d COMMON	SW 2, 4	2-1/4" x .148"

CONCRETE EXPOSURE REQUIREMENTS

ACI 318-14 TABLE 19.3.1.1 - EXPOSURE CATEGORIES AND CLASSES		
CATEGORY	CLASS	CONDITION
F FREEZING AND THAWING	F0	CONCRETE NOT EXPOSED TO FREEZING-AND-THAWING CYCLES
	F1	CONCRETE EXPOSED TO FREEZING-AND-THAWING CYCLES WITH LIMITED EXPOSURE TO WATER
	F2	CONCRETE EXPOSED TO FREEZING-AND-THAWING CYCLES WITH FREQUENT EXPOSURE TO WATER
S SULFATE	S0	WATER SOLUBLE SULFATE (SO4) IN SOIL PERCENT BY WEIGHT
	S1	0.10 ≤ SO4 < 0.20
	S2	0.20 ≤ SO4 < 2.0
W IN CONTACT WITH WATER	W0	CONCRETE IN CONTACT WITH WATER AND LOW PERMEABILITY IS NOT REQUIRED
	W1	CONCRETE IN CONTACT WITH WATER AND LOW PERMEABILITY IS NOT REQUIRED
	W2	CONCRETE DRY OR PROTECTED FROM MOISTURE
C CORROSION PROTECTION OF REINFORCEMENT	C1	CONCRETE EXPOSED TO MOISTURE BUT NOT TO EXTERNAL SOURCES OF CHLORIDES
	C2	CONCRETE EXPOSED TO MOISTURE AND AN EXTERNAL SOURCE OF CHLORIDES FROM DEICING CHEMICALS, SALT, BRACKISH WATER, SEAWATER, OR SPRAY FROM THESE SOURCES

ACI 318-14 TABLE 19.3.2.1 - REQUIREMENTS FOR CONCRETE BY EXPOSURE CLASS		
EXPOSURE CLASS	MAX W/C/M	MIN f'c
F0	N/A	2500
F1	0.55	3500
F2	0.45	4500
F3	0.40	5000
S0	N/A	2500
S1	0.50	4000
S2	0.45	4500
S3	0.45	4500
W0	N/A	2500
W1	0.50	4000
W2	N/A	2500
C1	N/A	2500
C2	0.40	5000

- THE MAXIMUM W/C/M LIMITS IN TABLE 19.3.2.1 DO NOT APPLY TO LIGHTWEIGHT CONCRETE.
- FOR PLAIN CONCRETE, THE MAXIMUM W/C/M SHALL BE 0.45 AND THE MINIMUM f'c SHALL BE 4,500 PSI.
- ALTERNATIVE COMBINATIONS OF CEMENTITIOUS MATERIALS TO THOSE LISTED IN TABLE 19.3.2.1 ARE PERMITTED WHEN TESTED FOR SULFATE RESISTANCE AND MEETING THE CRITERIA IN 26.4.2.2(2).
- FOR SEAWATER EXPOSURE, OTHER TYPES OF PORTLAND CEMENTS WITH TRICALCIUM ALUMINATE (C3A) CONTENTS UP TO 10 PERCENT ARE PERMITTED IF THE W/C/M DOES NOT EXCEED 0.40.
- OTHER AVAILABLE TYPES OF CEMENT SUCH AS TYPE I OR TYPE II ARE PERMITTED IN EXPOSURE CLASS S1 OR LESS THAN 8 PERCENT FOR EXPOSURE CLASS S2.
- THE AMOUNT OF THE SPECIFIC SOURCE OF THE POZZOLAN OR SLAG CEMENT TO BE USED SHALL BE AT LEAST THE AMOUNT THAT HAS BEEN DETERMINED BY SERVICE RECORD TO IMPROVE SULFATE RESISTANCE WHEN USED IN CONCRETE CONTAINING TYPE I V CEMENT. ALTERNATIVELY, THE AMOUNT OF THE SPECIFIC SOURCE OF THE POZZOLAN OR SLAG CEMENT TO BE USED SHALL BE AT LEAST THE AMOUNT TESTED IN ACCORDANCE WITH ASTM C1102 AND MEETING THE CRITERIA IN 26.4.2.2(2).
- WATER-SOLUBLE CHLORIDE ION CONTENT THAT IS CONTRIBUTED FROM THE INGREDIENTS INCLUDING WATER, AGGREGATES, CEMENTITIOUS MATERIALS, AND ADDITIVES SHALL BE DETERMINED ON THE CONCRETE MIXTURE BY ASTM C1218 AT AGE BETWEEN 28 AND 42 DAYS.
- CONCRETE COVER SHALL BE IN ACCORDANCE WITH 20.6.

PROPRIETARY ANCHORAGES AND FASTENERS

- ANCHORAGES:
 - DRILL AND EPOXY ANCHORS: SIMPSON SET-XP EPOXY ADHESIVE SYSTEM USING 1/2" DIA. METAL ANCHORS. REFER TO ASTM F1554, GRADE 36, OR REINFORCING STEEL CONFORMING TO ASTM A615 OR A706, GRADE 60, COMPLYING WITH ICC ES ESR 2908. INSTALLERS TO BE CERTIFIED BY MANUFACTURER.
 - MECHANICAL ANCHORS:
 - HILTI KWIK BOLT-HI CARBON STEEL EXPANSION ANCHORS COMPLYING WITH ICC ESR-1385.
 - SIMPSON TITEN HD ANCHORS STEEL SCREW ANCHORS COMPLYING WITH ICC ESR-2713.
 - TITEN HD ANCHORS SHALL BE STAINLESS STEEL IN EXPOSED WET ENVIRONMENTS.
 - WELDED SHEAR STUDS: NELSON 3SL FLUX FILLED, HEADED STUD ANCHORS, 60,000 PSI MINIMUM ULTIMATE TENSILE STRENGTH, AUTOMATICALLY END WELDED IN FIELD CONFORMING TO ASTM A108 AND COMPLYING WITH ICC ES REPORT NO. 2814.
 - WELDED DEFORMED ANCHORS: NELSON D2L, COLD ROLLED, DEFORMED STEEL REINFORCING BARS CONFORMING TO ASTM A496 AND COMPLYING WITH ICC ES REPORT NO. 3217.
- FASTENERS:
 - POWDER ACTUATED FASTENERS: HILTI XCP, COMPLYING WITH CURRENT ICC ES REPORT NO. 2379. PROVIDE APPROPRIATE WASHER BETWEEN FASTENER HEAD AND SURFACE OF CONCRETE.
 - POWDER DRIVEN FASTENERS SHALL NOT BE USED TO ANCHOR SILL PLATES EXCEPT AT INTERIOR NON-BEARING WALL, NOT DESIGN AS SHEAR WALLS.
 - SELF-DRILLING METAL SCREWS (INDICATED 'SCREWS' ON DRAWINGS): MINIMUM 0.292-INCH HEAD DIAMETER SELF-DRILLING SELF-TAPPING STEEL SCREWS COMPLYING WITH ICC ES REPORT NO. 2379. MINIMUM YIELD STRESS, 77-88 KSI.
 - FASTENERS, INCLUDING NUTS AND WASHERS, IN CONTACT WITH PRESERVATIVE-TREATED WOOD SHALL BE HOT DIPPED ZINC-COATED GALVANIZED STEEL, STAINLESS STEEL, SILICON BRONZE OR COPPER. STAPLES SHALL BE OF STAINLESS STEEL.

REQUIRED INSPECTION OF STEEL CONSTRUCTION PER CBC 2019 - SECT. 1705.2 & AICI 360-14			
PRIOR TO WELDING STEEL - PER TABLE N5.4-1			
CHECK IF REQUIRED	TASK	CONTINUOUS	PERIODIC
X	WELDING QUALIFICATION RECORDS AND CONTINUITY RECORDS		X
X	WELDING PROCEDURES (WPSs) AVAILABLE	X	
X	MANUFACTURER CERTIFICATIONS FOR WELDING CONSUMABLES	X	
X	MATERIAL IDENTIFICATION (TYPE/GRADE)		X
--	WELDER IDENTIFICATION SYSTEM ⁽¹⁾	X	
	FIT-UP OF GROOVE WELDS (INCLUDING JOINT GEOMETRY)		
	• JOINT PREPARATION		
X	• DIMENSIONS (ALIGNMENT, ROOT OPENING, ROOT FACE, BEVEL)		
	• CLEANLINESS (CONDITION OF STEEL SURFACES)		
	• TACKING (TACK WELD QUALITY AND LOCATION)		
	• BACKING TYPE AND FIT (IF APPLICABLE)		
	FIT-UP OF GROOVE WELDS OF HSS T-, Y- AND K-JOINT WITHOUT BACKING (INCLUDING JOINT GEOMETRY)		
	• JOINT PREPARATION		
	• DIMENSIONS (ALIGNMENT, ROOT OPENING, ROOT FACE, BEVEL)		
	• CLEANLINESS (CONDITION OF STEEL SURFACES)		
	• TACKING (TACK WELD QUALITY AND LOCATION)		
X	CHECK WELDING EQUIPMENT		X
DURING WELDING STEEL - PER TABLE N5.4-2			
CHECK IF REQUIRED	TASK	CONTINUOUS	PERIODIC
X	CONTROL AND HANDLING OF WELDING CONSUMABLES		X
	• PACKAGING		
	• EXPOSURE CONTROL		
--	NO WELDING OVER CRACKED TACK WELDS		X
--	ENVIRONMENTAL CONDITIONS		X
	• WIND SPEED WITHIN LIMITS		
	• PRECIPITATION AND TEMPERATURE		
	WPS FOLLOWED		
	• SETTINGS ON WELDING EQUIPMENT		
X	• SHIELDING GAS FLOW RATE		
	• PREHEAT APPLIED		
	INTERPASS TEMPERATURE MAINTAINED (MIN./MAX.)		
	• PROPER POSITION (F, V, H, OH)		
X	WELDING TECHNIQUES		X
	• PREHEAT AND FINAL CLEANING		
	• EACH PASS WITHIN PROFILE LIMITATIONS		
	• EACH PASS MEETS QUALITY REQUIREMENTS		
--	PLACEMENT AND INSTALLATION OF STEEL HEADED STUD ANCHORS	X	
AFTER WELDING STEEL - PER TABLE N5.4-3			
CHECK IF REQUIRED	TASK	CONTINUOUS	PERIODIC
X	WELDS CLEANED		X
X	SIZE, LENGTH AND LOCATION OF WELDS	X	
	WELDS MEET VISUAL ACCEPTANCE CRITERIA		
	• CRACK PROHIBITION		
X	• WELD-BASE-METAL FUSION		
	• CRACKER CROSS SECTION		
	• WELD PROFILES		
	• WELD SIZE		
	• UNDERCUT		
	• POROSITY		
--	ARC STRIKES	X	
--	K-AREA ⁽²⁾	X	
--	WELD ACCESS HOLES IN ROLLED HEAVY SHAPES AND BUILT-UP HEAVY SHAPES ⁽³⁾	X	
--	BACKING REMOVED AND WELD TABS REMOVED (IF REQUIRED)	X	
--	REPAIR ACTIVITIES	X	
X	DOCUMENT ACCEPTANCE OR REJECTION OF WELDED JOINT OR MEMBER	X	
X	NO PROHIBITED WELDS HAVE BEEN ADDED WITHOUT THE APPROVAL OF THE EOR		X
FOOTNOTES:			
1. THE FABRICATOR OR ERECTOR, AS APPLICABLE, SHALL MAINTAIN A SYSTEM BY WHICH A WELDER WHO HAS WELDED A JOINT OR MEMBER CAN BE IDENTIFIED. STAMPS, IF USED, SHALL BE THE LOW-STRESS TYPE.			
2. WHEN WELDING OF DOUBLER PLATES, CONTINUITY PLATES OR STIFFENERS HAS BEEN PERFORMED IN THE K-AREA, VISUALLY INSPECT THE WELD K-AREA FOR CRACKS WITHIN 3 IN. (75 MM) OF THE WELD.			
3. AFTER ROLLED HEAVY SHAPES (SEE SECTION A5.10) AND BUILT-UP HEAVY SHAPES (SEE SECTION A5.14) ARE WELDED, VISUALLY INSPECT THE WELD ACCESS HOLE FOR CRACKS EXCEPT:			
SPECIAL INSPECTION OF THE STEEL FABRICATION PROCESS SHALL NOT BE REQUIRED WHERE THE FABRICATOR DOES NOT PERFORM ANY WELDING, THERMAL CUTTING OR HEATING OPERATION OF ANY KIND AS PART OF THE FABRICATION PROCESS. IN SUCH CASES, THE FABRICATOR SHALL BE REQUIRED TO SUBMIT A DETAILED PROCEDURE FOR MATERIAL CONTROL THAT DEMONSTRATES THE FABRICATOR'S ABILITY TO MAINTAIN SUITABLE RECORDS AND PROCEDURES SUCH THAT, AT ANY TIME DURING THE FABRICATION PROCESS, THE MATERIAL SPECIFICATION, AND GRADE FOR THE MAIN STRESS-CARRYING ELEMENTS ARE CAPABLE OF BEING DETERMINED. MILL TEST REPORTS SHALL BE IDENTIFIABLE TO THE MAIN STRESS-CARRYING ELEMENTS WHEN REQUIRED BY THE APPROVED CONSTRUCTION DOCUMENTS.			

REQUIRED SPECIAL INSPECTIONS AND TESTS OF CONCRETE CONSTRUCTION PER TABLE 1705.3			
CHECK IF REQUIRED	TYPE	CONTINUOUS	PERIODIC
X	INSPECT REINFORCEMENT, INCLUDING PRESTRESSING TENDONS, AND VERIFY PLACEMENT		X
	REINFORCING BAR WELDING:		
	• VERIFY WELDABILITY OF REINFORCING BARS OTHER THAN ASTM A706		X
	• INSPECT SINGLE-PASS FILLET WELDS, MAXIMUM 3/16"; AND		X
	• VERIFY USE OF PROPER MATERIALS, DENSITIES AND LIFT THICKNESS DURING PLACEMENT AND COMPACTION OF COMPACTED FILL		X
	PRIOR TO PLACEMENT OF COMPACTED FILL		
	• INSPECT SUBGRADE AND VERIFY THAT SITE HAS BEEN PREPARED PROPERLY		X
	EXCEPTIONS:		
	WHERE SECTION 1803 DOES NOT REQUIRE REPORTING OF MATERIALS AND PROCEDURES FOR FULL PLACEMENT, THE SPECIAL INSPECTOR SHALL VERIFY THAT THE IN-PLACE DRY DENSITY OF THE COMPACTED FILL IS NOT LESS THAN 90 PERCENT OF THE MAXIMUM DRY DENSITY AT OPTIMUM MOISTURE CONTENT DETERMINED IN ACCORDANCE WITH ASTM D1557.		
REQUIRED SPECIAL INSPECTIONS FOR SEISMIC RESISTANCE PER 1705.12			
CHECK IF REQUIRED	TYPE	CONTINUOUS	PERIODIC
	STRUCTURAL STEEL PER 1705.12.1		
	SPECIAL INSPECTIONS OF STRUCTURAL STEEL IN THE SEISMIC FORCE-RESISTING SYSTEMS IN BUILDINGS AND STRUCTURES ASSIGNED TO SEISMIC DESIGN CATEGORY B, C, D, E OR F SHALL BE PERFORMED IN ACCORDANCE WITH THE QUALITY ASSURANCE REQUIREMENTS OF AISI 341.		
	EXCEPTIONS:		
	1. IN BUILDINGS AND STRUCTURES ASSIGNED TO SEISMIC DESIGN CATEGORY B OR C, SPECIAL INSPECTIONS ARE NOT REQUIRED FOR STRUCTURAL STEEL SEISMIC FORCE-RESISTING SYSTEMS WHERE THE RESPONSE MODIFICATION COEFFICIENT, R, OF 3 OR GREATER IS USED.		
	2. IN STRUCTURES ASSIGNED TO SEISMIC DESIGN CATEGORY D, E, OR F, SPECIAL INSPECTIONS ARE NOT REQUIRED FOR STRUCTURAL STEEL SEISMIC FORCE-RESISTING SYSTEMS WHERE DESIGN AND DETAILING IN ACCORDANCE WITH AISI 360 IS PERMITTED BY ASCE 7, TABLE 15.4-1.		
	STRUCTURAL STEEL ELEMENTS PER 1705.12.2		
	INSPECTION OF STRUTS, COLLECTORS, CHORDS AND FOUNDATION ELEMENTS, SHALL BE PERFORMED IN ACCORDANCE WITH THE QUALITY ASSURANCE REQUIREMENTS OF AISI 341.		
	EXCEPTIONS:		
	1. IN BUILDINGS AND STRUCTURES ASSIGNED TO SEISMIC DESIGN CATEGORY B OR C, SPECIAL INSPECTIONS OF STRUCTURAL STEEL ELEMENTS ARE NOT REQUIRED FOR SEISMIC FORCE-RESISTING SYSTEMS WITH A RESPONSE MODIFICATION COEFFICIENT, R, OF 3 OR GREATER.		
	2. IN STRUCTURES ASSIGNED TO SEISMIC DESIGN CATEGORY D, E, OR F, SPECIAL INSPECTIONS OF STRUCTURAL STEEL ELEMENTS ARE NOT REQUIRED FOR SEISMIC FORCE-RESISTING SYSTEMS WHERE DESIGN AND DETAILING OTHER THAN AISI 341 IS PERMITTED BY ASCE 7, TABLE 15.4-1. SPECIAL INSPECTION SHALL BE IN ACCORDANCE WITH THE APPLICABLE REFERENCED STANDARD LISTED IN ASCE 7, TABLE 15.4-1.		
	STRUCTURAL WOOD PER 1705.12.2		
	INSPECTION DURING FIELD GLUING OPERATIONS OF ELEMENTS OF THE SEISMIC FORCE-RESISTING SYSTEM.		
	INSPECTION FOR NAILING, BOLTING, ANCHORING AND OTHER FASTENING OF ELEMENTS OF THE SEISMIC FORCE-RESISTING SYSTEM, INCLUDING WOOD SHEAR WALLS, WOOD DIAPHRAGMS, DRAG STRUTS, BRACES, SHEAR PANELS AND HOLD-DOWNS.		
	EXCEPTION:		
	SPECIAL INSPECTIONS ARE NOT REQUIRED FOR WOOD SHEAR WALLS, SHEAR PANELS AND DIAPHRAGMS, INCLUDING NAILING, BOLTING, ANCHORING AND OTHER FASTENING TO OTHER ELEMENTS OF THE SEISMIC FORCE-RESISTING SYSTEM, WHERE THE FASTENER SPACING OF THE SHEATHING IS MORE THAN 4 INCHES ON CENTER.		
COLD-FORMED STEEL LIGHT FRAME CONSTRUCTION PER 1705.11.2			
CHECK IF REQUIRED	TYPE	CONTINUOUS	PERIODIC
	INSPECTION FOR WELDING OPERATIONS OF ELEMENTS OF THE MAIN WINDFORCE-RESISTING SYSTEM.		
	INSPECTION FOR SCREW ATTACHMENT, BOLTING, ANCHORING AND OTHER FASTENING OF ELEMENTS OF THE MAIN WINDFORCE-RESISTING SYSTEM, INCLUDING SHEAR WALLS, BRACES, DIAPHRAGMS, COLLECTORS (DRAG STRUTS) AND HOLD-DOWNS.		
	EXCEPTION:		
	SPECIAL INSPECTIONS ARE NOT REQUIRED FOR COLD-FORMED STEEL LIGHT-FRAME SHEAR WALLS AND DIAPHRAGMS, INCLUDING SCREW INSTALLATION, BOLTING, ANCHORING AND OTHER FASTENING TO COMPONENTS OF THE SEISMIC FORCE-RESISTING SYSTEM, WHERE EITHER OF THE FOLLOWING APPLIES:		
	1. THE SHEATHING IS GYPSUM BOARD OR FIBERBOARD.		
	2. THE SHEATHING IS WOOD STRUCTURAL PANEL OR STEEL SHEETS ON ONLY ONE SIDE OF THE SHEAR WALL, SHEAR PANEL OR DIAPHRAGM ASSEMBLY AND THE FASTENER SPACING OF THE SHEATHING IS MORE THAN 4 INCHES ON CENTER.		
REQUIRED SPECIAL INSPECTIONS AND TESTS OF MASONRY CONSTRUCTION PER TABLE 1705.4 & TMS 602			
CHECK IF REQUIRED	TYPE	CONTINUOUS	PERIODIC
X	PRIOR TO CONSTRUCTION, VERIFICATION OF COMPLIANCE OF SUBMITTALS.		
	PRIOR TO CONSTRUCTION, VERIFICATION OF F_m AND $F_{m0.2}$ EXCEPT WHERE SPECIFICALLY EXEMPTED BY THE EOR.		
	DURING CONSTRUCTION, VERIFICATION OF SLUMP, FLOW AND VISUAL STABILITY INDEX (VSI) WHEN SELF-CONSOLIDATING GROUT IS DELIVERED TO THE PROJECT SITE.		
	DURING CONSTRUCTION, VERIFICATION OF F_m AND $F_{m0.2}$ FOR EVERY 5,000 SQ. FT. (460 SQ. Y).		
	DURING CONSTRUCTION, VERIFICATION OF PROPORTIONS OF MATERIALS AS DELIVERED TO THE PROJECT SITE FOR PREMIXED OR PRE-BLENDED MORTAR, PRESTRESSING GROUT, AND GROUT OTHER THAN SELF-CONSOLIDATING GROUT.		
	[1] R = REQUIRED, NR = NOT REQUIRED		
MASONRY LEVEL 1 INSPECTION REQUIREMENTS			
CHECK IF REQUIRED	TYPE	CONTINUOUS	PERIODIC
X	PRIOR TO CONSTRUCTION, VERIFICATION OF COMPLIANCE OF SUBMITTALS.		
	EXCEPTIONS: SPECIAL INSPECTIONS AND TESTS SHALL NOT BE REQUIRED FOR:		
	1. EMPIRICALLY DESIGNED MASONRY, GLASS UNIT MASONRY OR MASONRY VENEER DESIGNED IN ACCORDANCE WITH SECTION 2109, 2110 OR CHAPTER 14, RESPECTIVELY, WHERE THEY ARE PART OF A STRUCTURE CLASSIFIED AS RISK CATEGORY I, II OR III.		
	2. MASONRY FOUNDATION WALLS CONSTRUCTED IN ACCORDANCE WITH TABLE 1807.1.6.3(1), 1807.1.6.3(2), 1807.1.6.3(3) OR 1807.1.6.3(4).		
	3. MASONRY FIREPLACES, MASONRY HEATERS OR MASONRY CHIMNEYS INSTALLED OR CONSTRUCTED IN ACCORDANCE WITH SECTION 2111, 2112 OR 2113, RESPECTIVELY.		
MINIMUM VERIFICATION REQUIREMENTS OF MASONRY CONSTRUCTION PER TMS 602-TABLE 3			
MINIMUM VERIFICATION			
REQUIRED FOR QUALITY ASSURANCE ⁽¹⁾			
LEVEL 1	LEVEL 2	LEVEL 3	
R	R	R	
NR	R	R	
NR	NR	R	
NR	NR	R	
REQUIRED SPECIAL INSPECTIONS AND TESTS OF WIND RESISTANCE PER 1705.11			
CHECK IF REQUIRED	TYPE	CONTINUOUS	PERIODIC
	1. IN WIND EXPOSURE CATEGORY B, WHERE $V_{W0.2}$ AS DETERMINED IN ACCORDANCE WITH SECTION 1609.3.1 IS 120 MPH OR GREATER		X
	2. IN WIND EXPOSURE CATEGORY C OR D, WHERE $V_{W0.2}$ AS DETERMINED IN ACCORDANCE WITH SECTION 1609.3.1 IS 110 MPH OR GREATER		X
STRUCTURAL WOOD PER 1705.11.1			
CHECK IF REQUIRED	TYPE	CONTINUOUS	PERIODIC
	DURING FIELD GLUING OPERATIONS OF ELEMENTS OF THE MAIN WINDFORCE-RESISTING SYSTEM.		
	INSPECTION OF NAILING, BOLTING, ANCHORING AND OTHER FASTENING OF ELEMENTS OF THE MAIN WINDFORCE-RESISTING SYSTEM, INCLUDING SHEAR WALLS, WOOD DIAPHRAGMS, DRAG STRUTS, BRACES AND HOLD-DOWNS.		
	EXCEPTION:		
	SPECIAL INSPECTIONS ARE NOT REQUIRED FOR WOOD SHEAR WALLS, SHEAR PANELS AND DIAPHRAGMS, INCLUDING NAILING, BOLTING, ANCHORING AND OTHER FASTENING TO OTHER ELEMENTS OF THE MAIN WINDFORCE-RESISTING SYSTEM, WHERE EITHER OF THE FOLLOWING APPLIES:		
	1. THE SHEATHING IS GYPSUM BOARD OR FIBERBOARD.		
	2. THE SHEATHING IS WOOD STRUCTURAL PANEL OR STEEL SHEETS ON ONLY ONE SIDE OF THE SHEARWALL, SHEAR PANEL OR DIAPHRAGM ASSEMBLY AND THE FASTENER SPACING OF THE SHEATHING IS MORE THAN 4 INCHES ON CENTER.		
WIND RESISTING COMPONENTS PER 1705.11.3			
CHECK IF REQUIRED	TYPE	CONTINUOUS	PERIODIC
	ROOF COVERING, ROOF DECK AND ROOF FRAMING CONNECTIONS.		X
	EXTERIOR WALL COVERING AND WALL CONNECTIONS TO ROOF AND ROOF DIAPHRAGMS.		X

REQUIRED SPECIAL INSPECTIONS AND TESTS OF SOILS PER TABLE 1705.6			
CHECK IF REQUIRED	TYPE	CONTINUOUS	PERIODIC
X	VERIFY MATERIALS BELOW SHALLOW FOUNDATIONS ARE ADEQUATE TO ACHIEVE THE DESIGN BEARING CAPACITY		X
X	VERIFY EXCAVATIONS ARE EXTENDED TO PROPER DEPTH AND HAVE REACHED PROPER MATERIAL		X
X	PERFORM CLASSIFICATION AND TESTING OF COMPACTED FILL MATERIALS		X
X	PRIOR TO PLACEMENT OF COMPACTED FILL		
X	INSPECT SUBGRADE AND VERIFY THAT SITE HAS BEEN PREPARED PROPERLY		X
	EXCEPTIONS:		
	WHERE SECTION 1803 DOES NOT REQUIRE REPORTING OF MATERIALS AND PROCEDURES FOR FULL PLACEMENT, THE SPECIAL INSPECTOR SHALL VERIFY THAT THE IN-PLACE DRY DENSITY OF THE COMPACTED FILL IS NOT LESS THAN 90 PERCENT OF THE MAXIMUM DRY DENSITY AT OPTIMUM MOISTURE CONTENT DETERMINED IN ACCORDANCE WITH ASTM D1557.		
REQUIRED SPECIAL INSPECTIONS FOR SEISMIC RESISTANCE PER 1705.12			
CHECK IF REQUIRED	TYPE	CONTINUOUS	PERIODIC
	STRUCTURAL STEEL PER 1705.12.1		
	SPECIAL INSPECTIONS OF STRUCTURAL STEEL IN THE SEISMIC FORCE-RESISTING SYSTEMS IN BUILDINGS AND STRUCTURES ASSIGNED TO SEISMIC DESIGN CATEGORY B, C, D, E OR F SHALL BE PERFORMED IN ACCORDANCE WITH THE QUALITY ASSURANCE REQUIREMENTS OF AISI 341.		
	EXCEPTIONS:		
	1. IN BUILDINGS AND STRUCTURES ASSIGNED TO SEISMIC DESIGN CATEGORY B OR C, SPECIAL INSPECTIONS ARE NOT REQUIRED FOR STRUCTURAL STEEL SEISMIC FORCE-RESISTING SYSTEMS WHERE THE RESPONSE MODIFICATION COEFFICIENT, R, OF 3 OR GREATER IS USED.		
	2. IN STRUCTURES ASSIGNED TO SEISMIC DESIGN CATEGORY D, E, OR F, SPECIAL INSPECTIONS ARE NOT REQUIRED FOR STRUCTURAL STEEL SEISMIC FORCE-RESISTING SYSTEMS WHERE DESIGN AND DETAILING IN ACCORDANCE WITH AISI 360 IS PERMITTED BY ASCE 7, TABLE 15.4-1.		
	STRUCTURAL STEEL ELEMENTS PER 1705.12.2		
	INSPECTION OF STRUTS, COLLECTORS, CHORDS AND FOUNDATION ELEMENTS, SHALL BE PERFORMED IN ACCORDANCE WITH THE QUALITY ASSURANCE REQUIREMENTS OF AISI 341.		
	EXCEPTIONS:		
	1. IN BUILDINGS AND STRUCTURES ASSIGNED TO SEISMIC DESIGN CATEGORY B OR C, SPECIAL INSPECTIONS OF STRUCTURAL STEEL ELEMENTS ARE NOT REQUIRED FOR SEISMIC FORCE-RESISTING SYSTEMS WITH A RESPONSE MODIFICATION COEFFICIENT, R, OF 3 OR GREATER.		
	2. IN STRUCTURES ASSIGNED TO SEISMIC DESIGN CATEGORY D, E, OR F, SPECIAL INSPECTIONS OF STRUCTURAL STEEL ELEMENTS ARE NOT REQUIRED FOR SEISMIC FORCE-RESISTING SYSTEMS WHERE DESIGN AND DETAILING OTHER THAN AISI 341 IS PERMITTED BY ASCE 7, TABLE 15.4-1. SPECIAL INSPECTION SHALL BE IN ACCORDANCE WITH THE APPLICABLE REFERENCED STANDARD LISTED IN ASCE 7, TABLE 15.4-1.		
	STRUCTURAL WOOD PER 1705.12.2		
	INSPECTION DURING FIELD GLUING OPERATIONS OF ELEMENTS OF THE SEISMIC FORCE-RESISTING SYSTEM.		
	INSPECTION FOR NAILING, BOLTING, ANCHORING AND OTHER FASTENING OF ELEMENTS OF THE SEISMIC FORCE-RESISTING SYSTEM, INCLUDING WOOD SHEAR WALLS, WOOD DIAPHRAGMS, DRAG STRUTS, BRACES, SHEAR PANELS AND HOLD-DOWNS.		
	EXCEPTION:		
	SPECIAL INSPECTIONS ARE NOT REQUIRED FOR WOOD SHEAR WALLS, SHEAR PANELS AND DIAPHRAGMS, INCLUDING NAILING, BOLTING, ANCHORING AND OTHER FASTENING TO OTHER ELEMENTS OF THE SEISMIC FORCE-RESISTING SYSTEM, WHERE THE FASTENER SPACING OF THE SHEATHING IS MORE THAN 4 INCHES ON CENTER.		
COLD-FORMED STEEL LIGHT FRAME CONSTRUCTION PER 1705.11.2			
CHECK IF REQUIRED	TYPE	CONTINUOUS	PERIODIC
	INSPECTION FOR WELDING OPERATIONS OF ELEMENTS OF THE MAIN WINDFORCE-RESISTING SYSTEM.		
	INSPECTION FOR SCREW ATTACHMENT, BOLTING, ANCHORING AND OTHER FASTENING OF ELEMENTS OF THE MAIN WINDFORCE-RESISTING SYSTEM, INCLUDING SHEAR WALLS, BRACES, DIAPHRAGMS, COLLECTORS (DRAG STRUTS) AND HOLD-DOWNS.		
	EXCEPTION:		
	SPECIAL INSPECTIONS ARE NOT REQUIRED FOR COLD-FORMED STEEL LIGHT-FRAME SHEAR WALLS AND DIAPHRAGMS, INCLUDING SCREW INSTALLATION, BOLTING, ANCHORING AND OTHER FASTENING TO COMPONENTS OF THE SEISMIC FORCE-RESISTING SYSTEM, WHERE EITHER OF THE FOLLOWING APPLIES:		
	1. THE SHEATHING IS GYPSUM BOARD OR FIBERBOARD.		
	2. THE SHEATHING IS WOOD STRUCTURAL PANEL OR STEEL SHEETS ON ONLY ONE SIDE OF THE SHEAR WALL, SHEAR PANEL OR DIAPHRAGM ASSEMBLY AND THE FASTENER SPACING OF THE SHEATHING IS MORE THAN 4 INCHES ON CENTER.		
REQUIRED SPECIAL INSPECTIONS AND TESTS OF MASONRY CONSTRUCTION PER TABLE 1705.4 & TMS 602			
CHECK IF REQUIRED	TYPE	CONTINUOUS	PERIODIC
X	PRIOR TO CONSTRUCTION, VERIFICATION OF COMPLIANCE OF SUBMITTALS.		
	EXCEPTIONS: SPECIAL INSPECTIONS AND TESTS SHALL NOT BE REQUIRED FOR:		
	1. EMPIRICALLY DESIGNED MASONRY, GLASS UNIT MASONRY OR MASONRY VENEER DESIGNED IN ACCORDANCE WITH SECTION 2109, 2110 OR CHAPTER 14, RESPECTIVELY, WHERE THEY ARE PART OF A STRUCTURE CLASSIFIED AS RISK CATEGORY I, II OR III.		
	2. MASONRY FOUNDATION WALLS CONSTRUCTED IN ACCORDANCE WITH TABLE 1807.1.6.3(1), 1807.1.6.3(2), 1807.1.6.3(3) OR 1807.1.6.3(4).		
	3. MASONRY FIREPLACES, MASONRY HEATERS OR MASONRY CHIMNEYS INSTALLED OR CONSTRUCTED IN ACCORDANCE WITH SECTION 2111, 2112 OR 2113, RESPECTIVELY.		
MINIMUM VERIFICATION REQUIREMENTS OF MASONRY CONSTRUCTION PER TMS 602-TABLE 3			
MINIMUM VERIFICATION			
REQUIRED FOR QUALITY ASSURANCE ⁽¹⁾			
LEVEL 1	LEVEL 2	LEVEL 3	
R	R	R	
NR	R	R	
NR	NR	R	
NR	NR	R	
REQUIRED SPECIAL INSPECTIONS AND TESTS OF WIND RESISTANCE PER 1705.11			
CHECK IF REQUIRED	TYPE	CONTINUOUS	PERIODIC
	1. IN WIND EXPOSURE CATEGORY B, WHERE $V_{W0.2}$ AS DETERMINED IN ACCORDANCE WITH SECTION 1609.3.1 IS 120 MPH OR GREATER		X
	2. IN WIND EXPOSURE CATEGORY C OR D, WHERE $V_{W0.2}$ AS DETERMINED IN ACCORDANCE WITH SECTION 1609.3.1 IS 110 MPH OR GREATER		X
STRUCTURAL WOOD PER 1705.11.1			
CHECK IF REQUIRED	TYPE	CONTINUOUS	PERIODIC
	DURING FIELD GLUING OPERATIONS OF ELEMENTS OF THE MAIN WINDFORCE-RESISTING SYSTEM.		
	INSPECTION OF NAILING, BOLTING, ANCHORING AND OTHER FASTENING OF ELEMENTS OF THE MAIN WINDFORCE-RESISTING SYSTEM, INCLUDING SHEAR WALLS, WOOD DIAPHRAGMS, DRAG STRUTS, BRACES AND HOLD-DOWNS.		
	EXCEPTION:		
	SPECIAL INSPECTIONS ARE NOT REQUIRED FOR WOOD SHEAR WALLS, SHEAR PANELS AND DIAPHRAGMS, INCLUDING SCREW INSTALLATION, BOLTING, ANCHORING AND OTHER FASTENING TO COMPONENTS OF THE SEISMIC FORCE-RESISTING SYSTEM, WHERE EITHER OF THE FOLLOWING APPLIES:		
	1. THE SHEATHING IS GYPSUM BOARD OR FIBERBOARD.		
	2. THE SHEATHING IS WOOD STRUCTURAL PANEL OR STEEL SHEETS ON ONLY ONE SIDE OF THE SHEARWALL, SHEAR PANEL OR DIAPHRAGM ASSEMBLY AND THE FASTENER SPACING OF THE SHEATHING IS MORE THAN 4 INCHES ON CENTER.		
WIND RESISTING COMPONENTS PER 1705.11.3			
CHECK IF REQUIRED	TYPE	CONTINUOUS	PERIODIC
	ROOF COVERING, ROOF DECK AND ROOF FRAMING CONNECTIONS.		X
	EXTERIOR WALL COVERING AND WALL CONNECTIONS TO ROOF AND ROOF DIAPHRAGMS.		X

QUALITY ASSURANCE (STRUCTURAL OBSERVATION, MATERIALS TESTING, AND SPECIAL INSPECTION)

1. STRUCTURAL OBSERVATION:

A. COORDINATION RESPONSIBILITIES OF CONTRACTOR: NOTIFY ARCHITECT (STRUCTURAL ENGINEER) 48 HOURS IN ADVANCE OF CRITICAL STAGES OF CONSTRUCTION INDICATED BELOW. SCHEDULES MAY BE SCHEDULED BY STRUCTURAL OBSERVER. FAILURE BY CONTRACTOR TO MEET OBSERVATION SCHEDULE MAY REQUIRE REMOVAL OF SUBSEQUENT WORK FOR OBSERVATION. CONTRACTOR SHALL BE RESPONSIBLE FOR REPAIRS AND REPLACEMENT OF FINISHED WORK OR FRAMING DAMAGED BY REMOVAL PROCESS OR AS REQUIRED FOR CORRECTIVE ACTION.

B. PRE-CONSTRUCTION MEETING: OWNER MAY COORDINATE AND CALL FOR MEETING BETWEEN ARCHITECT (STRUCTURAL ENGINEER) RESPONSIBLE FOR STRUCTURAL DESIGN, STRUCTURAL OBSERVER, CONTRACTOR, AFFECTED SUBCONTRACTORS AND SPECIAL INSPECTOR. STRUCTURAL OBSERVER WILL PREPARE THIS MEETING. PURPOSE OF MEETING IS TO IDENTIFY MAJOR STRUCTURAL ELEMENTS AND CONNECTIONS THAT AFFECT VERTICAL AND LATERAL LOAD RESISTING SYSTEMS OF STRUCTURE AND TO REVIEW SCHEDULE OF STRUCTURAL OBSERVATION, MATERIALS TESTING, AND SPECIAL INSPECTION OF PROJECT.

C. CRITICAL STAGES OF CONSTRUCTION REQUIRING STRUCTURAL OBSERVATION: CASTING OF CONCRETE

II. COVERING OF FRAMING

2. MILL TEST REPORTS CERTIFYING MATERIALS: CONTRACTOR TO SUBMIT MILL TEST REPORTS CERTIFYING REINFORCING STEEL, STRESSING TENDONS, AND STRUCTURAL STEEL. ARE OF IDENTIFIABLE TESTED STOCK TO OWNER, SPECIAL INSPECTOR, ARCHITECT (STRUCTURAL ENGINEER) AND, UPON REQUEST, TO GOVERNING CODE AUTHORITY. ENSURE MATERIALS ARE PROPERLY TAGGED FOR IDENTIFICATION. IF MILL TEST REPORTS CANNOT BE MADE AVAILABLE OR IF MATERIAL CANNOT BE IDENTIFIED, TESTING LABORATORY WILL PERFORM TESTS AS DIRECTED BY ARCHITECT (STRUCTURAL ENGINEER). CONTRACTOR SHALL PAY TESTING RELATED TO TESTS AND INSPECTIONS OF UNIDENTIFIABLE MATERIALS FURNISHED WITHOUT MILL. LABORATORY FOR COSTS TEST REPORTS, MATERIALS SOUND IDENTIFY AFTER IDENTIFICATION. TESTING WAS CONDUCTED IN MATERIALS REPLACING DEFICIENT MATERIALS.

A. ULTRASONIC EXAMINATION OF HEAVY ROLLED SHAPES AND THICK PLATES AT PROPOSED WELDED JOINT CONNECTIONS, WHERE COMPLETE PENETRATION GROOVE WELDS OCCUR AT GROUPS 4 AND 5 STRUCTURAL STEEL SHAPES, AS DEFINED BY ASTM A5, AND PLATES EXCEEDING 1/2 INCHES THICK, SUBMIT MILL TEST REPORTS TO ARCHITECT (STRUCTURAL ENGINEER) AND, UPON REQUEST, TO GOVERNING CODE AUTHORITY. MILL TEST REPORTS SHALL CERTIFY THAT CHARPY V NOTCH TESTING WAS CONDUCTED IN COMPLIANCE WITH ASTM A6, SUPPLEMENTARY REQUIREMENT S8, INCLUDING IMPACT TEST COMPLYING WITH ASTM A674 AT FREQUENCY F WITH MINIMUM AVERAGE VALUE OF 20 FT-LBS. ABSORBED ENERGY AT 70 DEGREES FAHRENHEIT.

3. CERTIFICATE OF COMPLIANCE FOR OFFSITE FABRICATION: SUBMIT FOR STRUCTURAL STEEL, GLU-LAMS, AND PLYWOOD-WEB JOISTS, PRECAST CONCRETE IN COMPLIANCE WITH APPLICABLE CODE SECTION 1701.7. SUBMIT TO OWNER, TESTING LABORATORY, ARCHITECT (STRUCTURAL ENGINEER) AND GOVERNING CODE AUTHORITY.

4. WELD TESTING AND INSPECTION: TESTING LABORATORY WILL SUBMIT WELD TEST RESULTS TO OWNER, CONTRACTOR, ARCHITECT (STRUCTURAL ENGINEER) AND, UPON REQUEST, TO GOVERNING CODE AUTHORITY. SEE SPECIFICATIONS FOR TESTING REQUIREMENTS NOT INDICATED ON STRUCTURAL DRAWINGS.

A. STRUCTURAL STEEL WELDING NOT DESTRUCTIVE TESTING REQUIREMENTS: APART FROM VISUAL INSPECTION AND REVIEW OF CONSTRUCTION REPORTS OF FABRICATOR/ERECTOR'S OWN QUALITY CONTROL, TESTING AND INSPECTION, OWNERS TESTING LABORATORY WILL PERFORM INDICATED SHOP AND FIELD INSPECTION AND TESTING. TESTING LABORATORY WILL BE AWS CERTIFIED AND WILL PROVIDE INSPECTORS FOR CONTINUOUS INSPECTION OF STEEL FABRICATION AND ERECTION AND STRUCTURAL WELDING. SHOP AND FIELD TESTING OF MATERIALS AND WELDING WILL BE AS FOLLOWS:

I. COMPLETE JOINT PENETRATION WELDS: FOR STRUCTURES IN RISK CATEGORY I, II OR IV ULTRASONIC TESTING MUST BE PERFORMED BY QA ON ALL CUP GROOVE WELDS SUBJECT TO TRANSVERSELY APPLIED TENSION LOADING IN BUTT, T- AND CORNER JOINTS, IN MATERIALS 5/16 IN. THICK OR GREATER, FOR STRUCTURES IN RISK CATEGORY I, NOT OF CUP GROOVE WELDS TO C/P GROOVE WELDS IN BUTT, T- AND CORNER JOINTS SUBJECT TO TRANSVERSELY APPLIED TENSION LOADING, IN MATERIALS 5/16 IN THICK OR GREATER, FOR STRUCTURES IN RISK CATEGORY I, NOT OF CUP GROOVE WELDS IS NOT REQUIRED, FOR ALL STRUCTURES IN ALL RISK CATEGORIES, NOT OF CUP GROOVE WELDS IN MATERIALS LESS THAN 5/16 IN THICK IS NOT REQUIRED.

II. ACCESS HOLES: THERMALLY CUT SURFACES OF ACCESS HOLES SHALL BE TESTED BY QA USING MT OR PT, WHEN THE FLANGE THICKNESS EXCEEDS 2 IN. (50 MM) FOR ROLLED SHAPES, OR WHEN THE WEB THICKNESS EXCEEDS 2 IN. (50 MM) FOR BUILT-UP SHAPES. ANY CRACK SHALL BE DEEMED UNACCEPTABLE REGARDLESS OF SIZE OR LOCATION.

5. CONTINUOUS SPECIAL INSPECTION: UNLESS OTHERWISE INDICATED, CONTINUOUS SPECIAL INSPECTION WILL BE PERFORMED BY SPECIAL INSPECTOR COMPLYING WITH APPLICABLE CODE SECTION 1701 AND SPECIFICALLY APPROVED BY GOVERNING CODE AUTHORITY FOR EACH INSPECTION CATEGORY BELOW. FOR INSPECTION CATEGORY 1, SPECIAL INSPECTION SHALL BE A PART OF THE PROGRAM OR OTHERWISE ACCEPTED BY ARCHITECT (STRUCTURAL ENGINEER). SEE SPECIFICATIONS FOR ADDITIONAL SPECIAL INSPECTION REQUIREMENTS.

ENGINEER OF RECORD - STRUCTURAL OBSERVATION PROGRAM

STRUCTURAL OBSERVATIONS FOR SEISMIC & WIND RESISTANCE:

1. THE OWNER SHALL EMPLOY THE ENGINEER OR ARCHITECT REGISTERED/LICENSED IN THE STATE OF CALIFORNIA WHO IS RESPONSIBLE FOR THE STRUCTURAL DESIGN TO PERFORM STRUCTURAL OBSERVATIONS(S).

ENGINEER IN CHARGE/ENGINEER OF RECORD:

NAME: SHAWN LOTHROP, SE

LIC #: S5627

OBSERVER DESIGNATED BY E.O.R. RESPONSIBLE FOR STRUCTURAL OBSERVATIONS:

NAME: SHAWN LOTHROP, SE

LIC #: S5627


2. STRUCTURAL OBSERVATIONS SHALL BE PROVIDED BY THE DESIGNATED STRUCTURAL OBSERVER FOR ALL BUILDINGS AT THE FOLLOWING STAGES OF CONSTRUCTION, UNLESS OTHERWISE AUTHORIZED OR REQUESTED IN WRITING BY THE BUILDING OFFICIAL:

A. PRE-CONCRETE CURB REBAR OBSERVATION

B. WOOD FRAMING OBSERVATION PRIOR TO COVERING W/ FINISH & AFTER FLOOR LOAD

3. PRIOR TO COMMENCEMENT OF OBSERVATION, THE STRUCTURAL OBSERVER SHALL SUBMIT TO THE BUILDING DEPARTMENT A WRITTEN STATEMENT OF COMPLIANCE WITH THE PROGRAM REQUIREMENTS FOR STRUCTURAL OBSERVATION.

4. AT THE CONCLUSION OF WORK, THE STRUCTURAL OBSERVER SHALL SUBMIT TO THE BUILDING DEPARTMENT A WRITTEN STATEMENT THAT THE STRUCTURAL OBSERVATION VISITS HAVE BEEN MADE AND IDENTIFY ANY REPORTED DEFICIENCIES WHICH HAVE NOT BEEN RESOLVED.

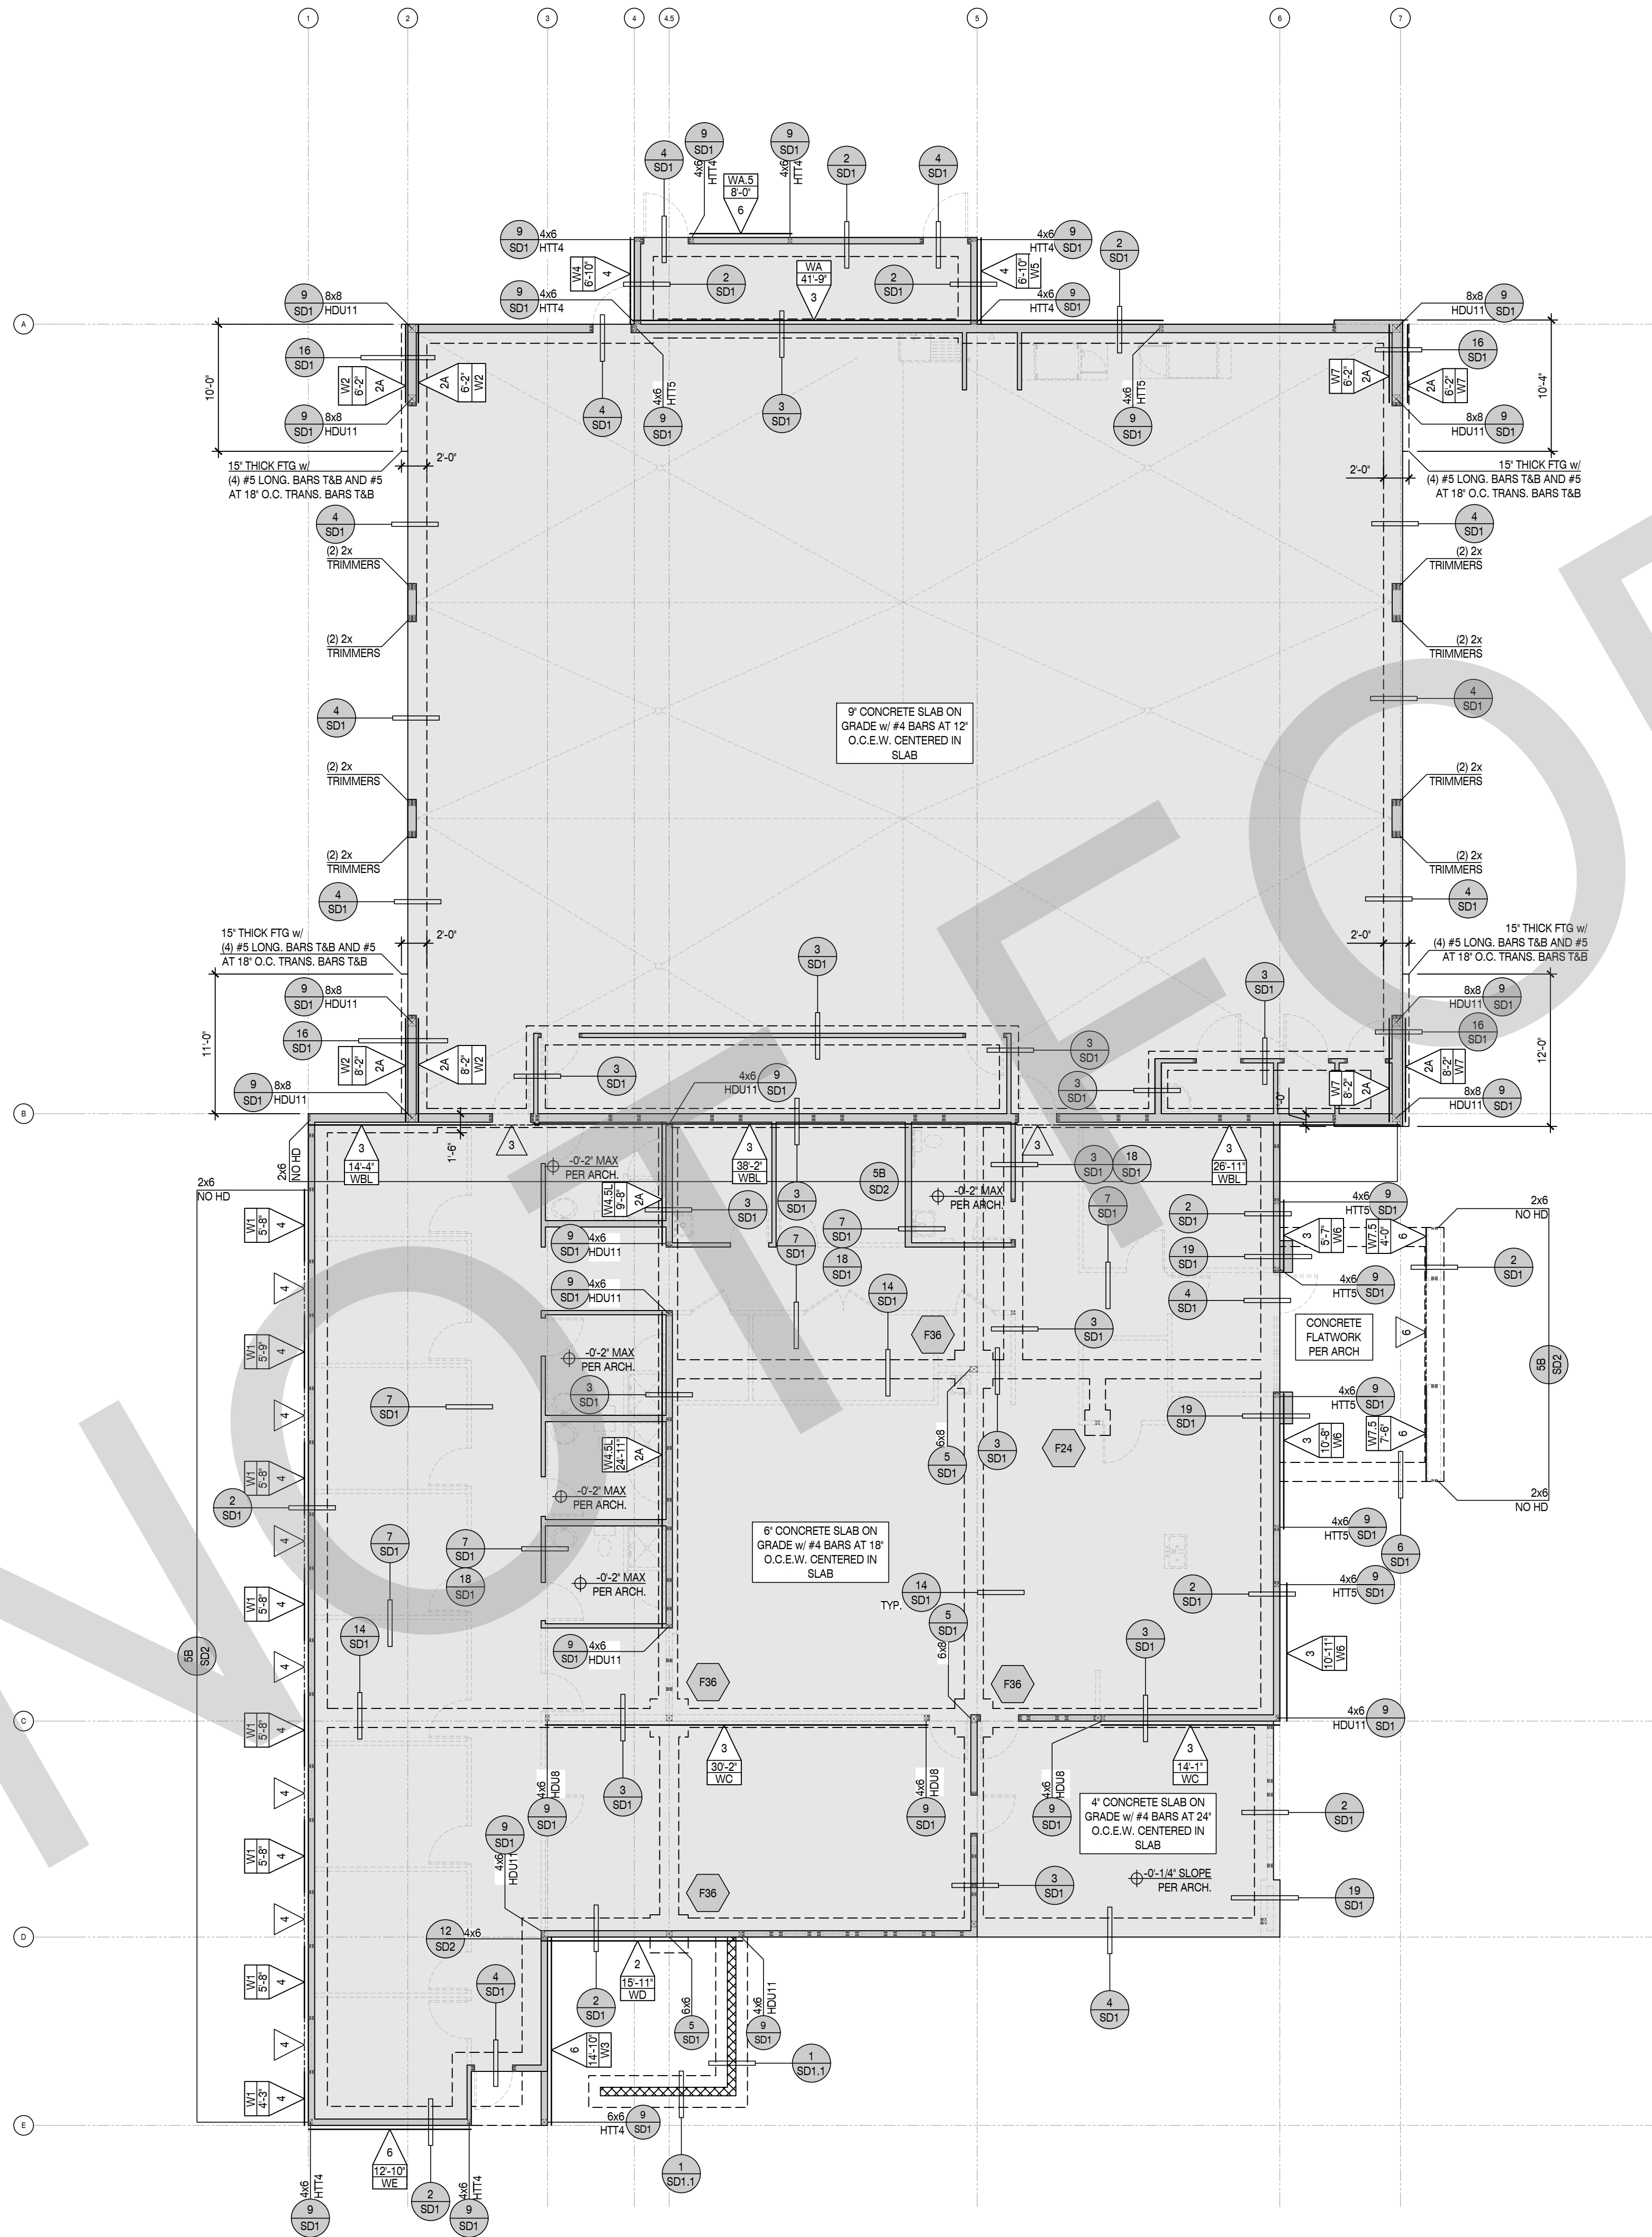

FOUNDATION PLAN

DO NOT SCALE PLANS FOR CONSTRUCTION DIMENSIONS. ALL CONSTRUCTION DIMENSIONS SHOULD BE VERIFIED WITH THE ARCHITECTURAL SET OF PLANS

SCALE : 1/8" = 1'-0"

GEOTECHNICAL INFORMATION

- REFER TO STRUCTURAL COVER SHEET (SCS) FOR ASSUMED SOIL VALUES OR VALUES BASED ON THE PROVIDED GEOTECHNICAL (SOILS) REPORT.
- PRIOR TO REQUESTING A BUILDING DEPARTMENT FOUNDATION INSPECTION, THE SOILS ENGINEER SHALL CERTIFY IN WRITING THAT:
 - THE BUILDING PAD WAS PREPARED IN ACCORDANCE WITH THE RECOMMENDATIONS IN THE SOILS REPORT,
 - THE FOOTINGS EXTEND TO THE PROPER DEPTH OR BEARING STRATA,
 - UTILITY TRENCHES ARE PROPERLY BACKFILLED AND COMPACTED,
 - AND THAT THE CONDITIONS FOUND MATCH THOSE ASSUMED IN THE SOILS REPORT.
- THE OWNER/DEVELOPER AND SUBCONTRACTORS ARE TO REVIEW THE SOILS REPORT PRIOR TO COMMENCING CONSTRUCTION AND VERIFY THE PLANS COMPLY WITH THE CURRENT SOILS REPORT RECOMMENDATIONS. THE STRUCTURAL ENGINEER SHALL BE NOTIFIED IF THE SOILS REPORT DATE SHOWN ON SHEET (SCS) DOES NOT MATCH THE CURRENT REPORT DATE. THE OWNER/DEVELOPER IS RESPONSIBLE FOR UPDATING THE STRUCTURAL ENGINEER WITH CURRENT GEOTECHNICAL ENGINEERING REQUIREMENTS.

FOUNDATION NOTES

- INSTALL HOLD-DOWN ANCHOR BOLTS PER 9/SD1. PROVIDE AND INSTALL ALL U.S.P. OR SIMPSON LUMBER CONNECTORS (OR EQUAL) FOUNDATION HARDWARE PER MANUFACTURERS RECOMMENDATIONS. DEEPEN FOOTING WHERE NECESSARY TO PROVIDE ANCHOR EMBEDMENT AT HOLD-DOWN LOCATIONS.
- REFER TO SHEARWALL SCHEDULE 8/SD1 FOR ANCHOR BOLT SPACING AND FOR ANCHOR BOLT INSTALLATION.
- REFER TO DETAIL PACKAGE FOR TYPICAL CONDITIONS NOT SPECIFICALLY CALLED OUT OR NOTED ON PLANS.
- ALL DIMENSIONS SHALL BE PER THE CURRENT APPROVED STAMPED SET OF ARCHITECTURAL PLANS. OUR OFFICE SHOULD BE NOTIFIED IMMEDIATELY IF DISCREPANCIES EXIST BETWEEN THE ARCHITECTURAL & STRUCTURAL PLANS.
- CONSTRUCT CONTINUOUS FOOTINGS AT CORNERS AND INTERSECTIONS PER DETAIL 11/SD1.
- FOUNDATION SIZES, DEPTHS, AND REINFORCEMENT SHOULD BE COORDINATED WITH THE OWNER/DEVELOPERS SOILS ENGINEERS REPORT. SOILS ENGINEER REPORT MAY REQUIRE ADDITIONAL ITEMS NOT NOTED ON THE STRUCTURAL PLANS.
- CLIENT/TOWNER SHALL ADDRESS CORROSIVE SOIL CONDITIONS. FOR HIGH SULFATE SOIL CONDITIONS, MITIGATE PER ACI TABLE 4.3.1. THE CLIENT/TOWNER SHALL HAVE A CORROSION ENGINEER PROVIDE MITIGATION RECOMMENDATIONS FOR ALL OTHER CORROSIVE SOIL CONDITIONS. CLIENT IS RESPONSIBLE TO REVIEW STRUCTURAL PLANS AND DETAILS FOR COMPLIANCE TO CORROSION ENGINEERS RECOMMENDATIONS PRIOR TO CONSTRUCTION.

FOUNDATION LEGEND & SYMBOLS

	CONCRETE SLAB & FOOTING. FOOTING SIZE AND REINFORCING PER DETAIL SHEET SD1
	CONCRETE CURB PER ARCH. FOOTING SIZE AND REINFORCING PER DETAIL SHEET SD1
	INDICATES: CONCRETE, CMU WALL FOOTING. FOOTING SIZE AND REINFORCING PER PLAN.
	INDICATES: DETAIL CUT LOCATION. REFER TO DETAIL, # AND STRUCTURAL SHEET NUMBER FOR MORE INFORMATION. TEXT ABOVE BUBBLE INDICATES REVISED HARDWARE OTHER THAN NOTED IN DETAIL.
	INDICATES: WOOD SHEAR WALL LOCATION. REFER TO DETAIL 8/SD1 FOR ANCHOR BOLT SIZE & SPACING AT EACH SHEAR WALL TYPE. PROVIDE 3" SQ X 0.225" ANGLE SLOTTED PLATE WASHERS AT EACH ANCHOR BOLT. REDUCE BOLT SPACING BY HALF AT DOUBLE SIDED SHEAR WALLS.
	INDICATES PAD FOOTING PER DETAIL 5/SD1 W/ REINFORCEMENT PER SPREAD FOOTING SCHEDULE.

SPREAD FOOTING SCHEDULE

FOOTING MARK	CONCRETE FOOTING SIZE		STEEL REINFORCING
	WIDTH X LENGTH	EMBEDMENT	
F24	24" x 24"	12"	(2)-#5 BARS EACH WAY AT TOP & BTM
F36	36" x 36"	12"	(3)-#5 BARS EACH WAY AT TOP & BTM


STRUCTURAL OBSERVATION REQUIREMENTS

STRUCTURAL OBSERVATION IS REQUIRED BY THE ENGINEER OF RECORD. OUR OFFICE SHOULD BE NOTIFIED TO PERFORM STRUCTURAL OBSERVATION AT THE FOLLOWING STAGES OF CONSTRUCTION:

- PRIOR TO POUR OF CONCRETE TO OBSERVE REINFORCING & EMBEDS
- WOOD FRAMING OBSERVATION PRIOR TO COVERING W/ FINISH & AFTER ROOF LOAD



CONSULTANT:

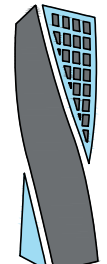

INNOVATIVE
STRUCTURAL ENGINEERING
2739 VIA INDUSTRIAL
TEMECULA, CA 92590
TEL: 951.490.0032
WWW.ISEENGINEERS.COM
SOCAL | NORCAL | COLORADO
ISE PROJECT NO.: 22-7067

PROJECT MANAGER:
SANDY FONG EXT. 1016
SANDY@ISEENGINEERS.COM

PROJECT ADMINISTERED BY:
SAN BERNARDINO COUNTY
REAL ESTATE SERVICES
DEPARTMENT -
PROJECT MANAGEMENT
DIVISION

385 N. ARROWHEAD AVE.
SAN BERNARDINO, CA 92415

PROJECT NAME:
SAN BERNARDINO
COUNTY FIRE
DEPARTMENT:
FIRE STATION 226

PROJECT # 10.1032
CIP # _____
CAFM # _____

1920 DEL ROSA AVE N.
SAN BERNARDINO,
CA 92404

ISSUE INFORMATION:

DATE:	INFORMATION:
10-03-2022	PLAN CHECK

SHEET INFORMATION:

STK PROJECT NO.: 374-154-21
SCALE: AS NOTED
DATE: SEPTEMBER 2022
PLOT DATE: 09-28-2022
DRAWING NAME:

SEAL:



SHEET TITLE:

FOUNDATION PLAN


SHEET NO.:

S1

LOW ROOF FRAMING PLAN

DO NOT SCALE PLANS FOR CONSTRUCTION DIMENSIONS. ALL CONSTRUCTION DIMENSIONS SHOULD BE VERIFIED WITH THE ARCHITECTURAL SET OF PLANS

SCALE : 1/8" = 1'-0"

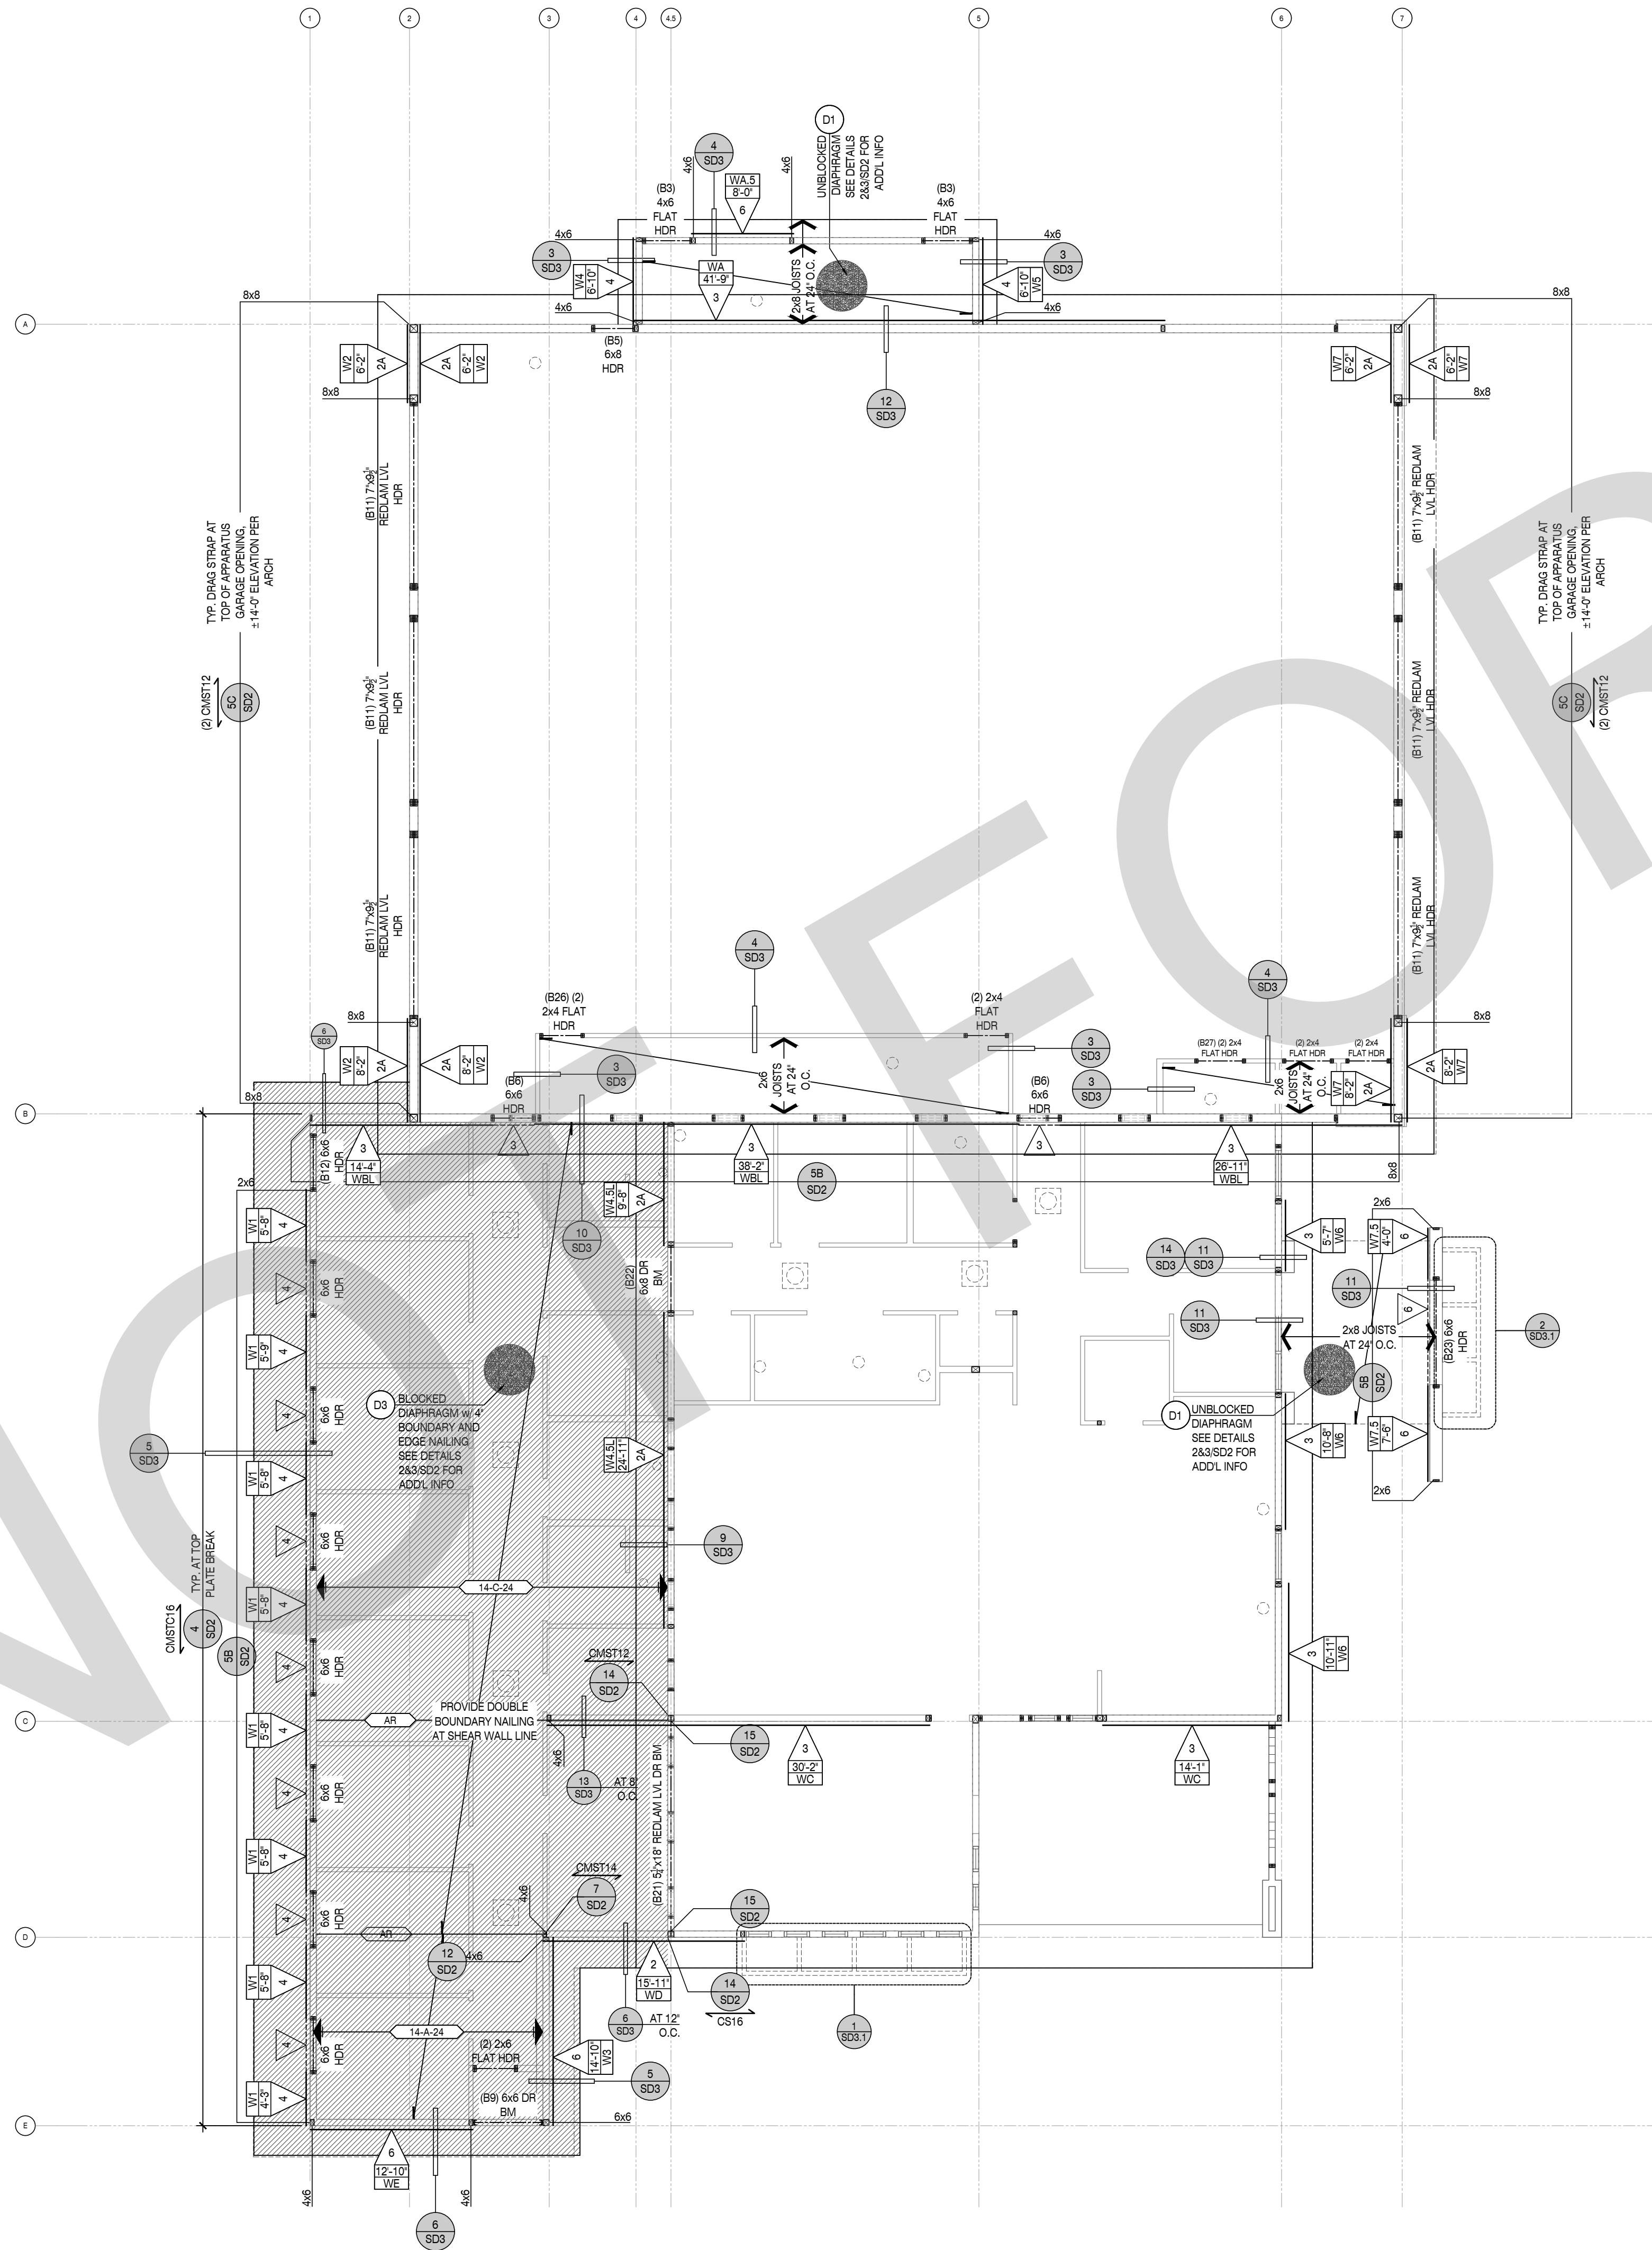

FRAMING NOTES


- REFER TO STRUCTURAL GENERAL NOTE SHEET (GN SERIES) AND DETAILS (SD SERIES) FOR INFORMATION NOT SHOWN ON THE MAIN FRAMING PLANS.
- REFER TO MAIN FRAMING PLAN FOR ALL INFORMATION NOT SHOWN ON THE ALTERNATE ELEVATIONS AND OPTIONS.
- FRAMER & TRUSS MANUFACTURER TO COORDINATE JOIST AND TRUSS SPACING WITH M.E.P. DESIGNS. FRAMER TO REVIEW MECH. AND ELECTRIC PLANS BEFORE FINAL PLACEMENT OF JOISTS AND/OR TRUSSES. WHERE ALIGNED JOIST AND/OR TRUSS INTERFERES W/ FUTURE INSTALLATION OF M.E.P. INSTALLATION, CONTACT STRUCTURAL ENGINEER.
- SPLICE ALL EXTERIOR WALL AND INTERIOR SHEAR WALL TOP PLATE BREAKS PER DETAIL 4/SD2, TYP.
- ROOF SHOULD BE FULLY LOADED PRIOR TO NAILING THE TOP PLATE HARDWARE TO ROOF TRUSS BOTTOM CHORD.

FRAMING LEGEND & SYMBOLS

AT XX' O.C. REQUIRED ANCHOR/SPACING DETAIL # SHEET #	INDICATES DETAIL CUT LOCATION. REFER TO DETAIL # AND STRUCTURAL SHEET NUMBER FOR MORE INFORMATION. TEXT ABOVE BUBBLE INDICATES REVISED HARDWARE OTHER THAN NOTED IN DETAIL.
INDICATES 2x8 STUD WALL PER PLAN & DETAIL 5/SD2. COORDINATE STUD WALL SIZE WITH ARCH. PLANS.	
INDICATES 2x8 STUD WALL PER PLAN & DETAIL 5/SD2. COORDINATE STUD WALL SIZE WITH ARCH. PLANS.	
INDICATES: 1. WALL OPENING HEADER PER FRAMING SCHEDULE BELOW 2. PROVIDE (1) 2x4 TRIMMER EACH SIDE U.N.O. ON PLAN. 3. PROVIDE KING STUDS EACH SIDE PER DETAIL 5/SD2 U.N.O. ON PLAN.	
INDICATES: 1. BEAM AS NOTED ON PLANS 2. PROVIDE BEARING STUDS OR POST EACH END TO MATCH WIDTH OF BEAM AND SUPPORT WALL, U.N.O. 3. (1) 2x WALL STUD ALIGNED AT 1 1/2" WIDE LSL BEAMS IS ACCEPTABLE 4. BEAM SHOULD BE INSTALLED WITH BOTTOM ON TOP PLATE U.N.O.	
INDICATES: BLOCKED ROOF SHEATHING LOCATIONS (HATCHED AREA) PER DETAILS 2 & 3/SD2, TYPICAL.	
JOIST DEPTH (IN.) JOIST SPAG. (IN. O.C.) XX-XX-XX JOIST TYPE (SEE SHT. 5N1)	INDICATES ROOF I-JOIST SPAN, DIRECTION, DEPTH, SPACING AND TYPE OF FLOOR I-JOISTS PER TABLE AT RIGHT. REFER TO 'ROOF JOIST SPECIFICATIONS' ON SHEET 5N1 FOR MANUF. ALT.
I-JOIST SPECIFICATIONS TYPE MANF TYPE SIZE DEPTH (IN.) A REDBUILT I45 14 B REDBUILT I65 14 C REDBUILT I90 14	
AR	INDICATES ALIGNED ROOF RAFTER W/ ROOF DIAPHRAGM BOUNDARY NAILING
END POST W/ HOLDOWN TYPE WALL CALC ID	INDICATES: 1. WOOD SHEAR WALL PANEL LOCATION PER PLAN INSTALLED FULL HEIGHT OF WALL 2. REFER TO DETAIL 1/SD2 SHEAR WALL SCHEDULE FOR ADDITIONAL REQUIREMENTS 3. PROVIDE POST AND STRAPHOLDOWN EACH END OF WALL MIN AS INDICATED PER PLAN 4. AT UPPER FLOORS WHERE WALL SHEATHING DOES NOT EXTEND AND EDGE NAIL TO FLOOR RIM PROVIDE SILL PLATE NAILING OR SCREWS PER DETAIL 1/SD2
INDICATES SHEAR TYPE ABV & BLW OPENING TYPE LENGTH WALL CALC ID	INDICATES: 1. WOOD SHEAR WALL PANEL LOCATION PER PLAN INSTALLED FULL HEIGHT OF WALL AND SHEAR PANEL ABOVE AND BELOW OPENING REFER TO DETAIL 1/SD2 SHEAR WALL SCHEDULE FOR ADDITIONAL REQUIREMENTS 2. PROVIDE POST AND STRAPHOLDOWN EACH END OF WALL MIN AS INDICATED PER PLAN 3. AT UPPER FLOORS WHERE WALL SHEATHING DOES NOT EXTEND AND EDGE NAIL TO FLOOR RIM PROVIDE SILL PLATE NAILING OR SCREWS PER DETAIL 1/SD2 4. REFER TO DETAIL 5B/SD2 FOR PERFORATED SHEAR WALL CONDITION (SHEAR ABV AND BLW OPENING W/O STRAP) 5. REFER TO DETAIL 5C/SD2 FOR FORCE TRANSFER SHEAR WALL CONDITION (SHEAR ABV AND BLW OPENING W/ STRAP)
TENSION STRAP L-X-XX	INDICATES: DRAG TIE STRAP TO ROOF BLK'G LENGTH SHOWN INDICATES STRAP LENGTH OFF WALL
MF X	INDICATES STEEL MOMENT FRAMES AS OCCURS PER PLAN. MOMENT FRAME ELEVATIONS TO BE PROVIDED AFTER ARCHITECTURAL COORDINATION/APPROVAL.
	INDICATES WIDE FLANGE AS OCCURS PER PLAN.

STRUCTURAL OBSERVATION REQUIREMENTS

- STRUCTURAL OBSERVATION IS REQUIRED BY THE ENGINEER OF RECORD. OUR OFFICE SHOULD BE NOTIFIED TO PERFORM STRUCTURAL OBSERVATION AT THE FOLLOWING STAGES OF CONSTRUCTION:
- PRIOR TO POUR OF CONCRETE TO OBSERVE REINFORCING & EMBEDS
 - WOOD FRAMING OBSERVATION PRIOR TO COVERING W/ FINISH & AFTER ROOF LOAD

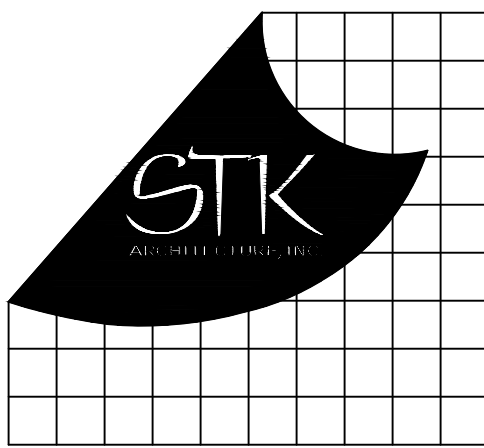

4055 DEVO DR. TEMECULA, CALIFORNIA 92590-3760
Phone: 951.296.8110 Fax: 951.296.6079 Email: sk@stkinc.com

CONSULTANT:



INNOVATIVE
STRUCTURAL ENGINEERING
27189 VIA INDUSTRIAL
TEMECULA, CA 92590
TEL: 951.490.0032
WWW.ISEENGINEERS.COM
SOCAL | NORCAL | COLORADO
ISE PROJECT NO.: 22-7067

PROJECT MANAGER:
SANDY FONG EXT. 1016
SANDY@ISEENGINEERS.COM

PROJECT ADMINISTERED BY:
SAN BERNARDINO COUNTY
REAL ESTATE SERVICES
DEPARTMENT -
PROJECT MANAGEMENT
DIVISION

385 N. ARROWHEAD AVE.
SAN BERNARDINO, CA 92415

PROJECT NAME:

SAN BERNARDINO
COUNTY FIRE
DEPARTMENT:
FIRE STATION 226

PROJECT # 10.10.1032

CIP # _____

CAFM # _____

1920 DEL ROSA AVE N.
SAN BERNARDINO,
CA 92404

ISSUE INFORMATION:

DATE:	INFORMATION:
10-03-2022	PLAN CHECK

SHEET INFORMATION:

STK PROJECT NO.: 374-154-21
SCALE: AS NOTED
DATE: SEPTEMBER 2022
PLOT DATE: 09-28-2022
DRAWING NAME:

SEAL:



SHEET TITLE:

LOW ROOF FRAMING
PLAN

SHEET NO.:

S2

DO NOT SCALE PLANS FOR CONSTRUCTION DIMENSIONS. ALL CONSTRUCTION DIMENSIONS SHOULD BE VERIFIED WITH THE ARCHITECTURAL SET OF PLANS

SCALE : 1/8" = 1'-0"

STRUCTURAL OBSERVATION IS REQUIRED BY THE ENGINEER OF RECORD. OUR OFFICE SHOULD BE NOTIFIED TO PERFORM STRUCTURAL OBSERVATION AT THE FOLLOWING STAGES OF CONSTRUCTION:


1. PRIOR TO POUR OF CONCRETE TO OBSERVE REINFORCING & EMBEDS
2. WOOD FORMING OBSERVATION PRIOR TO COVERING w/ FINISH & AFTER ROOF LOAD



STORAGE BUILDNG (SB) - ROOF FRAMING PLAN

DO NOT SCALE PLANS FOR CONSTRUCTION DIMENSIONS. ALL CONSTRUCTION DIMENSIONS SHOULD BE VERIFIED WITH THE ARCHITECTURAL SET OF PLANS


SCALE : 1/4" = 1'-0"

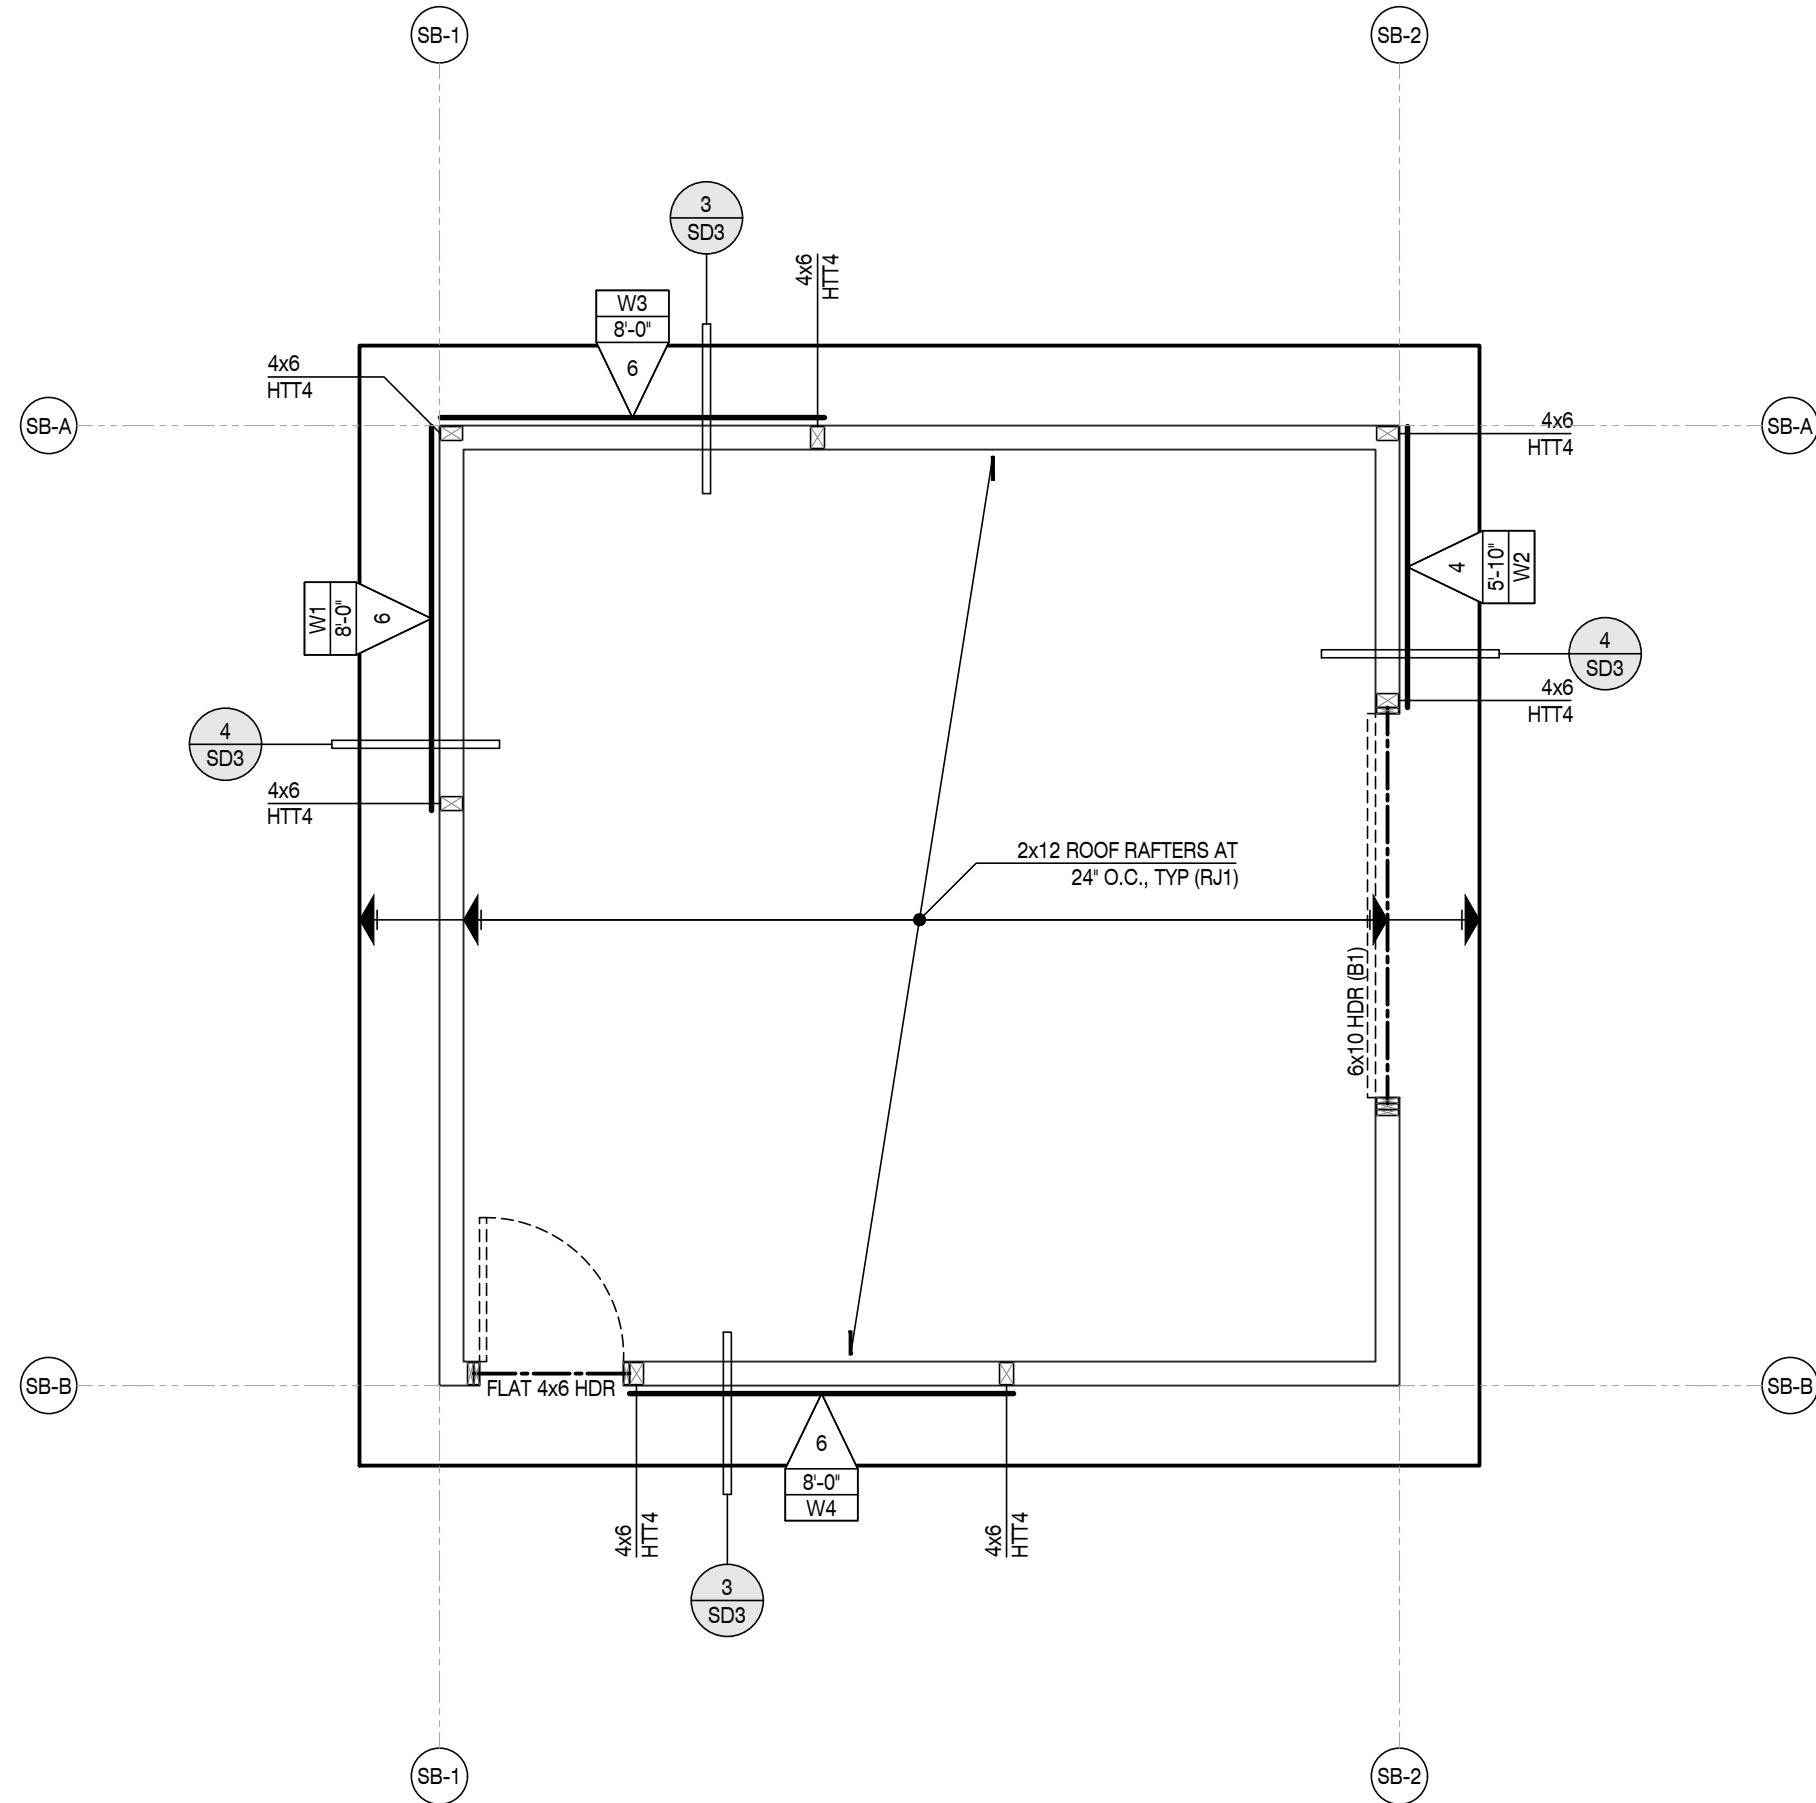

TRASH ENCLOSURE (TE) - ROOF FRAMING PLAN

DO NOT SCALE PLANS FOR CONSTRUCTION DIMENSIONS. ALL CONSTRUCTION DIMENSIONS SHOULD BE VERIFIED WITH THE ARCHITECTURAL SET OF PLANS


SCALE : 1/4" = 1'-0"

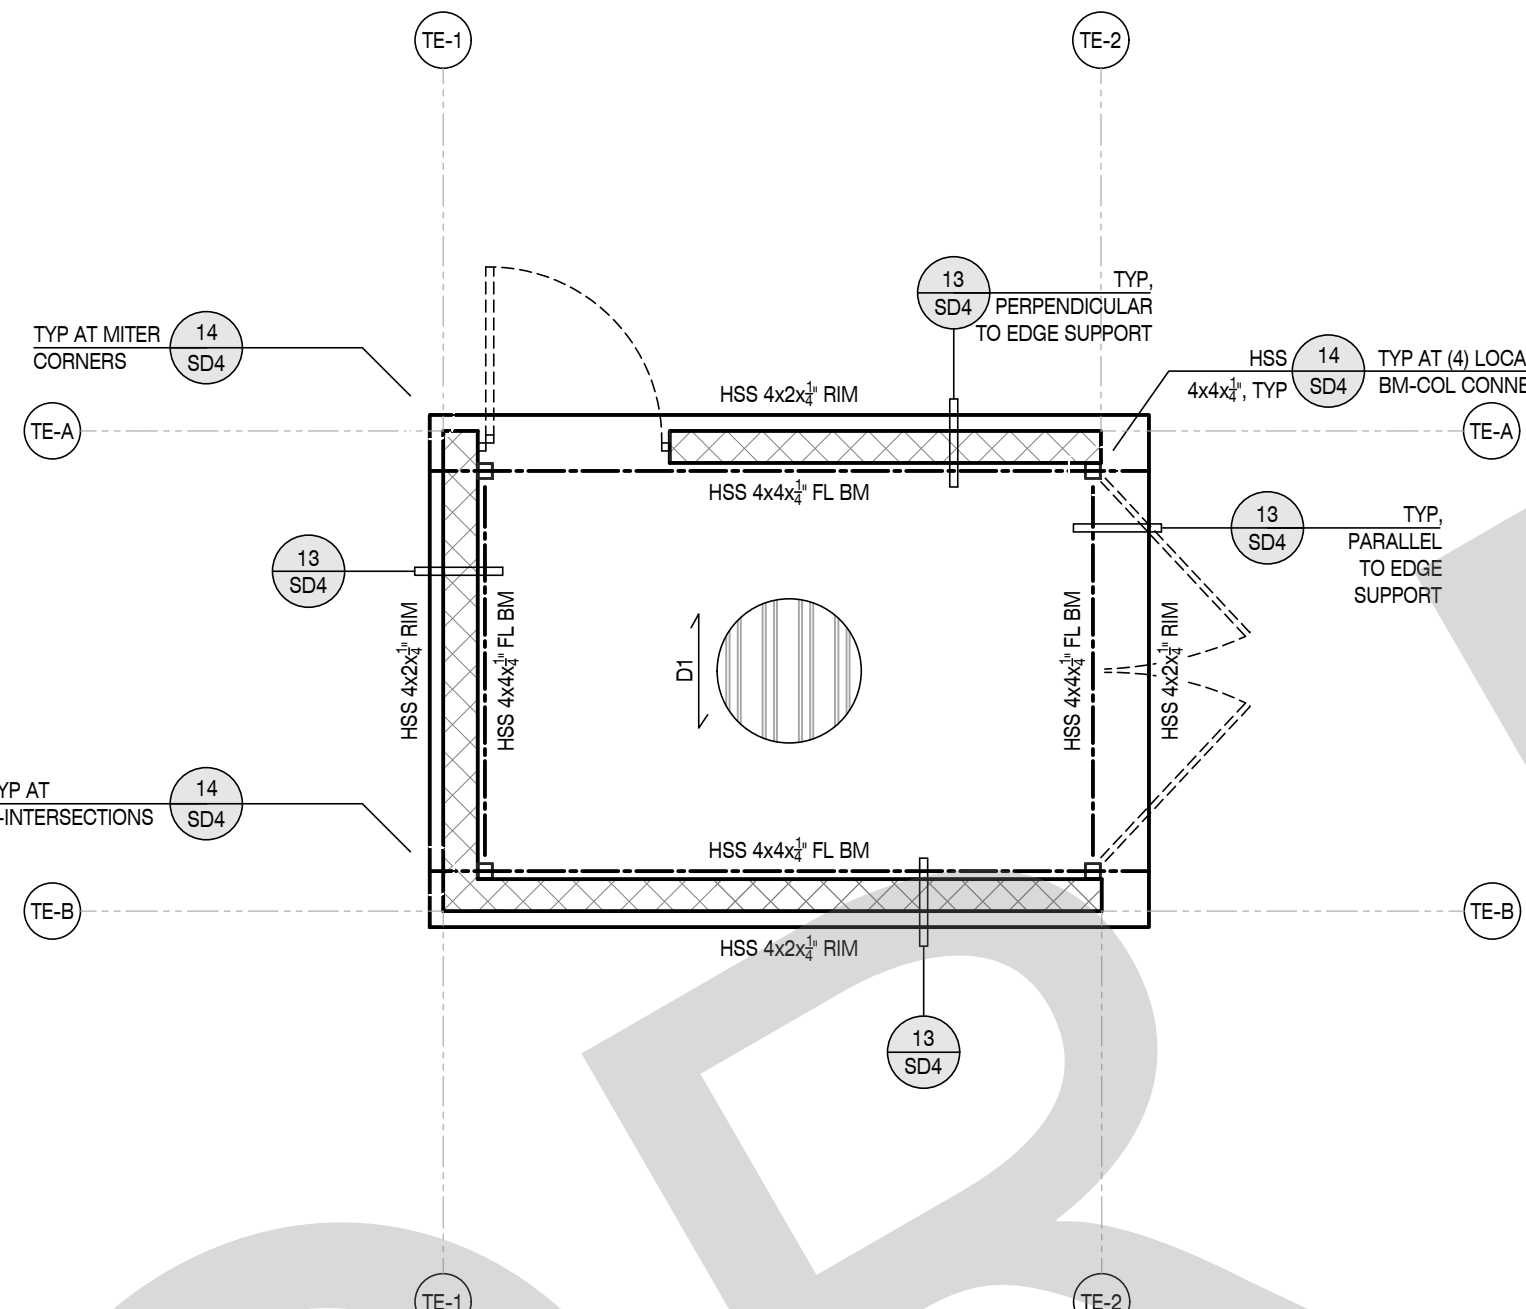

STORAGE BUILDNG (SB) - FOUNDATION PLAN

DO NOT SCALE PLANS FOR CONSTRUCTION DIMENSIONS. ALL CONSTRUCTION DIMENSIONS SHOULD BE VERIFIED WITH THE ARCHITECTURAL SET OF PLANS


SCALE : 1/4" = 1'-0"

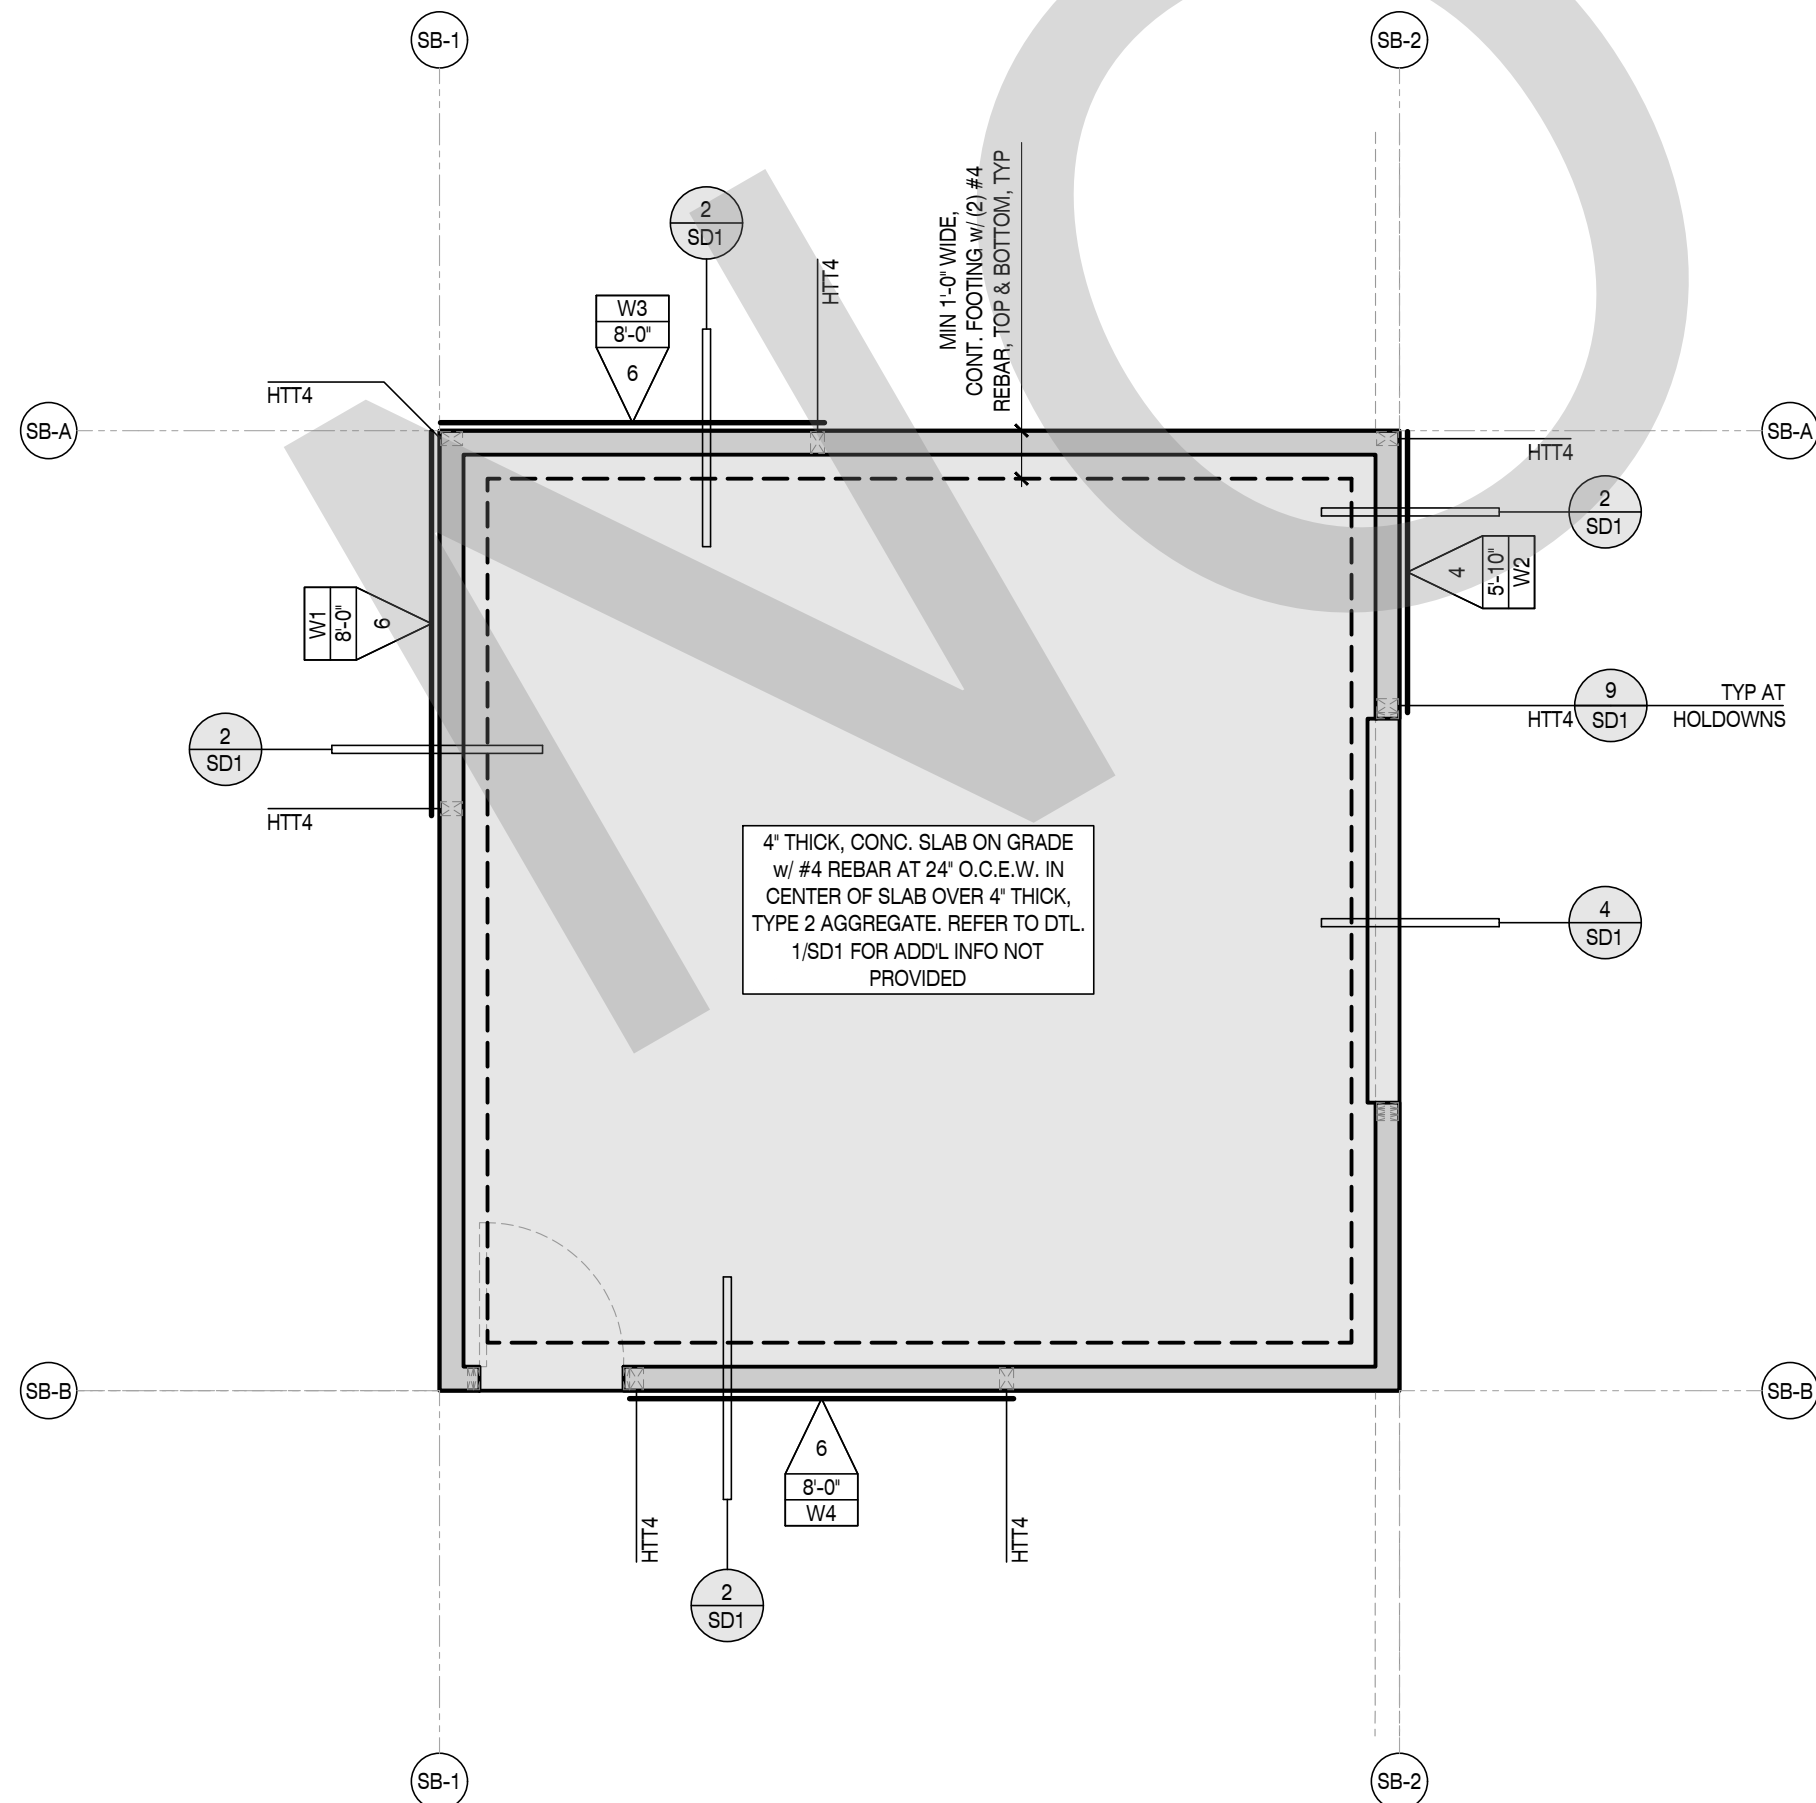

TRASH ENCLOSURE (TE) - FOUNDATION PLAN

DO NOT SCALE PLANS FOR CONSTRUCTION DIMENSIONS. ALL CONSTRUCTION DIMENSIONS SHOULD BE VERIFIED WITH THE ARCHITECTURAL SET OF PLANS

SCALE : 1/4" = 1'-0"

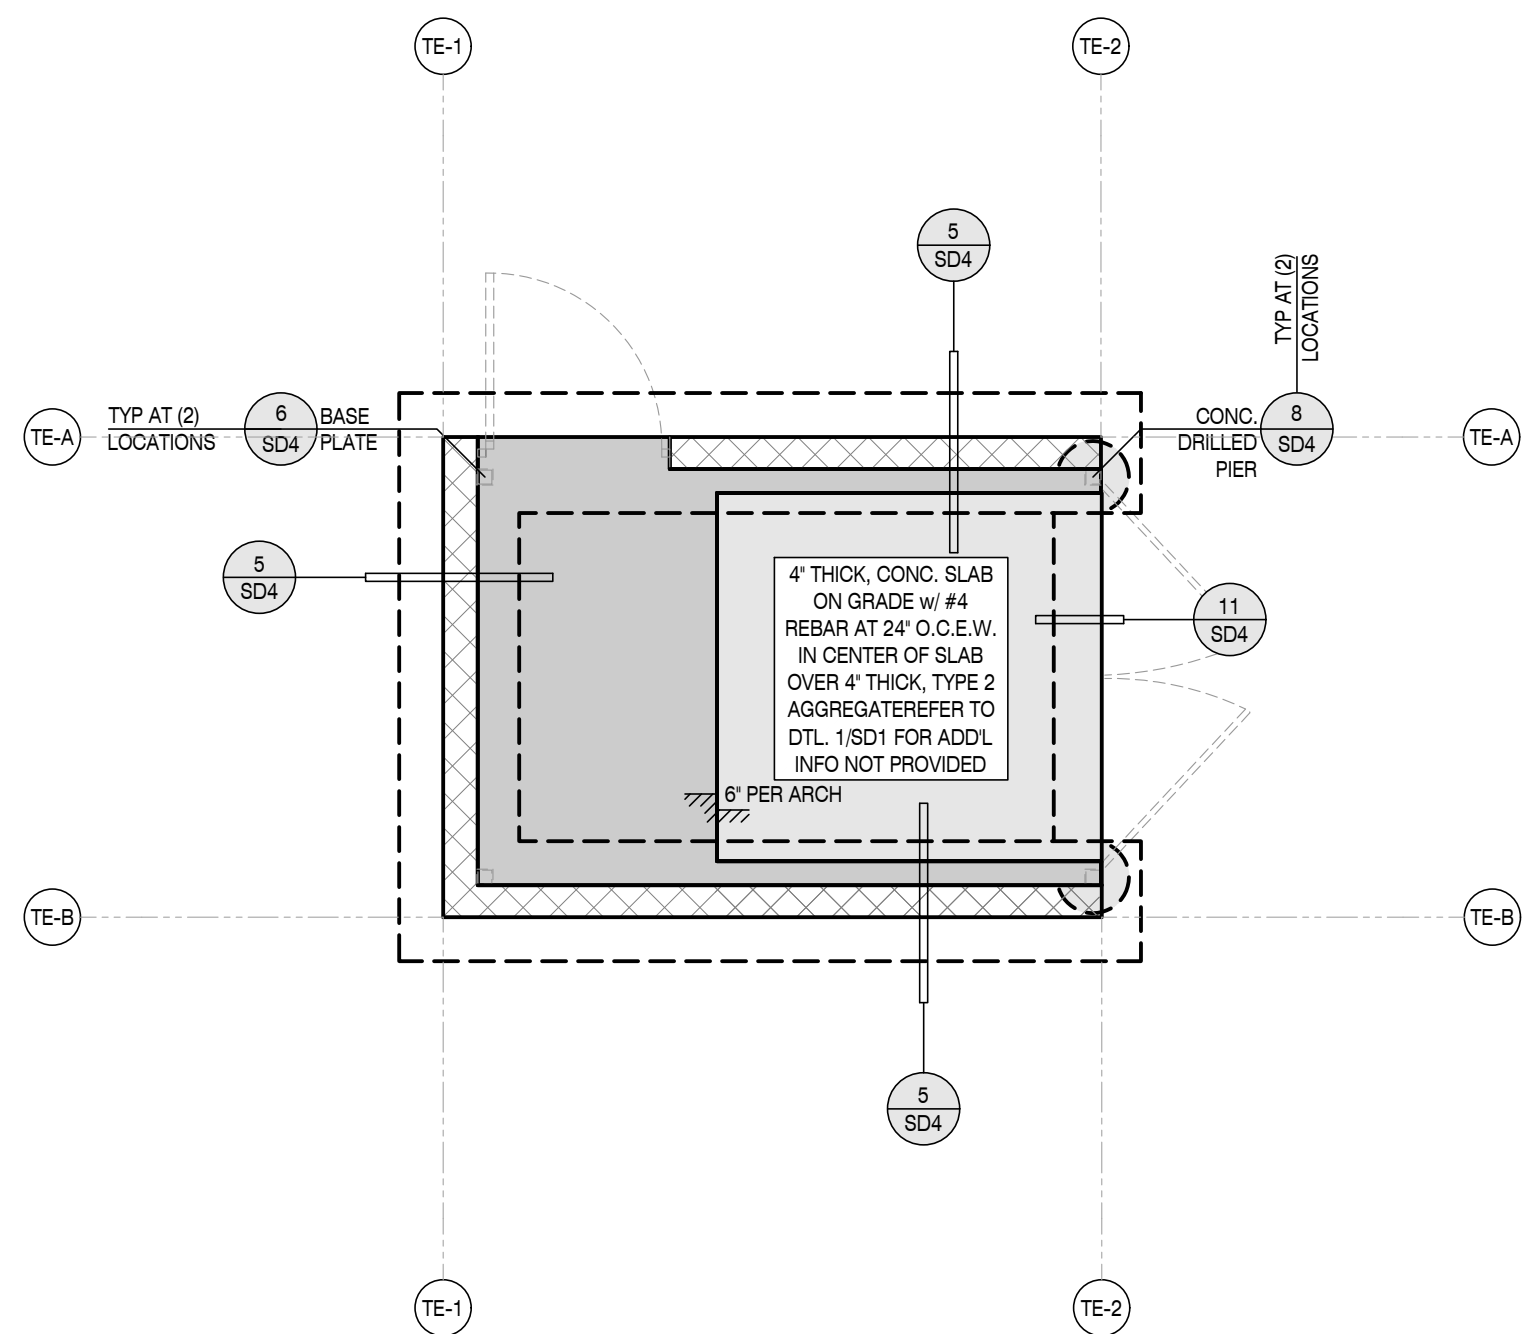

FRAMING NOTES

- REFER TO STRUCTURAL GENERAL NOTE SHEET (SN SERIES) AND DETAILS (SD SERIES) FOR INFORMATION NOT SHOWN ON THE MAIN FRAMING PLANS.
- FRAMER TO COORDINATE JOIST SPACING WITH M.E.P. DESIGNS. FRAMER TO REVIEW MECH. AND ELECTRIC PLANS BEFORE FINAL PLACEMENT OF JOISTS. WHERE ALIGNED JOIST INTERFERES W/ FUTURE INSTALLATION OF M.E.P. INSTALLATION, CONTACT STRUCTURAL ENGINEER.
- SPLICE ALL EXTERIOR WALL AND INTERIOR SHEAR WALL TOP PLATE BREAKS PER DETAIL 4/SD2, TYP.
- ROOF SHOULD BE FULLY LOADED PRIOR TO NAILING THE TOP PLATE HARDWARE TO ROOF JOIST BOTTOM CHORD.
- WATERPROOFING & DRAINAGE SHALL BE PROVIDED BY OTHERS.

FRAMING LEGEND & SYMBOLS

AT XX' O.C. REQUIRED ANCHOR/SPACING DETAIL # SHEET #	INDICATES DETAIL CUT LOCATION. REFER TO DETAIL # AND STRUCTURAL SHEET NUMBER FOR MORE INFORMATION. TEXT ABOVE BUBBLE INDICATES REVISED HARDWARE OTHER THAN NOTED IN DETAIL.
INDICATES 2x6 STUD WALL PER PLAN & DETAIL 5/SD2. COORDINATE STUD WALL SIZE WITH ARCH. PLANS.	
INDICATES: 8\"/>	
INDICATES: 1. WALL OPENING HEADER PER FRAMING SCHEDULE BELOW 2. PROVIDE (1) 2x TRIMMER EACH SIDE U.N.O. ON PLAN. 3. PROVIDE KING STUDS EACH SIDE PER DETAIL 5/SD2 U.N.O. ON PLAN.	
INDICATES ALIGNED ROOF RAFTER W/ ROOF DIAPHRAGM EDGE NAILING	
INDICATES SPAN AND DIRECTION OF ROOF RAFTERS. RAFTER SIZE AND SPACING PER PLANS.	
INDICATES: 1. BEAM AS NOTED ON PLANS	
INDICATES METAL ROOF DECK PER PLAN. REFER TO DETAIL 12/SD4 FOR ADDITIONAL INFORMATION INCLUDING DECK TYPES.	
INDICATES: 1. WOOD SHEAR WALL PANEL LOCATION PER PLAN INSTALLED FULL HEIGHT OF WALL 2. REFER TO DETAIL 1/SD2 SHEAR WALL SCHEDULE FOR ADDITIONAL REQUIREMENTS 3. PROVIDE POST AND STRAP/HOLDOWN EACH END OF WALL MIN AS INDICATED PER PLAN 4. AT UPPER FLOORS WHERE WALL SHEATHING DOES NOT EXTEND AND EDGE NAIL TO FLOOR RIM PROVIDE SILL PLATE NAILING OR SCREWS PER DETAIL 1/SD2	
INDICATES: 1. WOOD SHEAR WALL PANEL LOCATION PER PLAN INSTALLED FULL HEIGHT OF WALL AND SHEAR PANEL ABOVE AND BELOW OPENING 2. REFER TO DETAIL 1/SD2 SHEAR WALL SCHEDULE FOR ADDITIONAL REQUIREMENTS 3. PROVIDE POST AND STRAP/HOLDOWN EACH END OF WALL MIN AS INDICATED PER PLAN 4. AT UPPER FLOORS WHERE WALL SHEATHING DOES NOT EXTEND AND EDGE NAIL TO FLOOR RIM PROVIDE SILL PLATE NAILING OR SCREWS PER DETAIL 1/SD2 5. REFER TO DETAIL 5B/SD2 FOR PERFORATED SHEAR WALL CONDITION (SHEAR ABV AND BLW OPENING W/O STRAP) 6. REFER TO DETAIL 5C/SD2 FOR FORCE TRANSFER SHEAR WALL CONDITION (SHEAR ABV AND BLW OPENING W/ STRAP)	
INDICATES: DRAG TIE STRAP PER PLAN OR DETAIL SHOWN ON PLANS.	

GEOTECHNICAL INFORMATION

- REFER TO STRUCTURAL COVER SHEET (SCS) FOR ASSUMED SOIL VALUES OR VALUES BASED ON THE PROVIDED GEOTECHNICAL (SOILS) REPORT.
- THE OWNER/DEVELOPER AND SUBCONTRACTORS ARE TO REVIEW THE SOILS REPORT PRIOR TO COMMENCING CONSTRUCTION AND VERIFY THE PLANS COMPLY WITH THE CURRENT SOILS REPORT RECOMMENDATIONS. THE STRUCTURAL ENGINEER SHALL BE NOTIFIED IF THE SOILS REPORT DATE SHOWN ON SHEET (SCS) DOES NOT MATCH THE CURRENT REPORT DATE. THE OWNER/DEVELOPER IS RESPONSIBLE FOR UPDATING THE STRUCTURAL ENGINEER WITH CURRENT GEOTECHNICAL ENGINEERING REQUIREMENTS.

FOUNDATION NOTES


- INSTALL HOLDOWN ANCHOR BOLTS PER 9/SD1. PROVIDE AND INSTALL ALL U.S.P. OR SIMPSON LUMBER CONNECTORS (OR EQUAL) FOUNDATION HARDWARE PER MANUFACTURERS RECOMMENDATIONS. DEEPEN FOOTING WHERE NECESSARY TO PROVIDE ANCHOR EMBEDMENT AT HOLDOWN LOCATIONS.
- REFER TO SHEARWALL SCHEDULE 8/SD1 FOR ANCHOR BOLT SPACING AND FOR ANCHOR BOLT INSTALLATION.
- REFER TO DETAIL PACKAGE FOR TYPICAL CONDITIONS NOT SPECIFICALLY CALLED OUT OR NOTED ON PLANS.
- ALL DIMENSIONS SHALL BE PER THE CURRENT APPROVED STAMPED SET OF ARCHITECTURAL PLANS. OUR OFFICE SHOULD BE NOTIFIED IMMEDIATELY IF DISCREPANCIES EXIST BETWEEN THE ARCHITECTURAL & STRUCTURAL PLANS.
- CONSTRUCT CONTINUOUS FOOTINGS AT CORNERS AND INTERSECTIONS PER DETAIL 11/SD1.
- CENTER CONTINUOUS FOOTINGS UNDER WALLS U.N.O. CENTER DRILLED PIER FOOTINGS UNDER COLUMNS U.N.O.
- FOUNDATION SIZES, DEPTHS, AND REINFORCEMENT SHOULD BE COORDINATED WITH THE OWNER/DEVELOPER'S SOILS ENGINEERS REPORT. SOILS ENGINEER REPORT MAY REQUIRE ADDITIONAL ITEMS NOT NOTED ON THE STRUCTURAL PLANS.
- CLIENT/OWNER SHALL ADDRESS CORROSIVE SOIL CONDITIONS. FOR HIGH SULFATE SOIL CONDITIONS, MITIGATE PER ACI TABLE 19.3.2.1. THE CLIENT/OWNER SHALL HAVE A CORROSION ENGINEER PROVIDE MITIGATION RECOMMENDATIONS FOR ALL OTHER CORROSIVE SOIL CONDITIONS. CLIENT IS RESPONSIBLE TO REVIEW STRUCTURAL PLANS AND DETAILS FOR COMPLIANCE TO CORROSION ENGINEERS RECOMMENDATIONS PRIOR TO CONSTRUCTION.
- IN NO CASE SHALL PIPES, CONDUITS, OR SLEEVES BE EMBEDDED IN SPREAD FOOTINGS UNLESS SPECIFICALLY DETAILED ON THE STRUCTURAL DRAWINGS.

FOUNDATION LEGEND & SYMBOLS

CONCRETE SLAB & FOOTING. FOOTING SIZE AND REINFORCING PER DETAIL SHEET SD1, U.N.O. PER PLAN.	
INDICATES: CONCRETE, CMU WALL FOOTING. FOOTING SIZE AND REINFORCING PER DETAIL SHEET SD4, U.N.O. PER PLAN.	
INDICATES: CONCRETE, DRILLED PIER FOOTING. FOOTING SIZE AND REINFORCING PER DETAIL SHEET SD4, U.N.O. PER PLAN.	
AT XX' O.C. ANCHOR SPACING DETAIL # SHEET #	INDICATES: DETAIL CUT LOCATION. REFER TO DETAIL # AND STRUCTURAL SHEET NUMBER FOR MORE INFORMATION. TEXT ABOVE BUBBLE INDICATES REVISED HARDWARE OTHER THAN NOTED IN DETAIL.
END POST W/ HOLDOWN TYPE WALL CALC ID	INDICATES: WOOD SHEAR WALL LOCATION. REFER TO DETAIL 8/SD1 FOR ANCHOR BOLT SIZE & SPACING AT EACH SHEAR WALL TYPE. PROVIDE 3\"/>
END POST W/ HOLDOWN TYPE WALL CALC ID	


STRUCTURAL OBSERVATION REQUIREMENTS

- STRUCTURAL OBSERVATION IS REQUIRED BY THE ENGINEER OF RECORD. OUR OFFICE SHOULD BE NOTIFIED TO PERFORM STRUCTURAL OBSERVATION AT THE FOLLOWING STAGES OF CONSTRUCTION:
- PRIOR TO POUR OF CONCRETE TO OBSERVE REINFORCING & EMBEDS
 - WOOD FRAMING OBSERVATION PRIOR TO COVERING W/ FINISH & AFTER ROOF LOAD

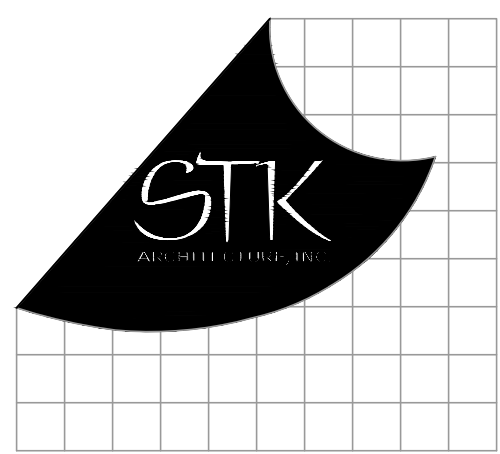

43055 DEVIS DR. TEMECULA, CALIFORNIA 92590-3760
Phone: 951.296.8110 Fax: 951.296.6079 Email: sk@stkinc.com

CONSULTANT:

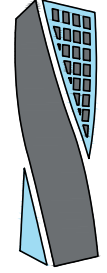

INNOVATIVE

STRUCTURAL ENGINEERING
27789 VIA INDUSTRIAL
TEMECULA, CA 92590
TEL: 951.490.2593
WWW.ISEENGINEERS.COM
SOCAL | NORCAL | COLORADO
ISE PROJECT NO.: 22-7067

PROJECT MANAGER:
SANDY FONG EXT. 1016
SANDY@ISEENGINEERS.COM

PROJECT ADMINISTERED BY:
SAN BERNARDINO COUNTY
REAL ESTATE SERVICES
DEPARTMENT -
PROJECT MANAGEMENT
DIVISION

385 N. ARROWHEAD AVE.
SAN BERNARDINO, CA 92415

PROJECT NAME:

SAN BERNARDINO
COUNTY FIRE
DEPARTMENT:
FIRE STATION 226

PROJECT # 10.10.1032

CIP # _____

CAFM # _____

1920 DEL ROSA AVE N.
SAN BERNARDINO,
CA 92404

ISSUE INFORMATION:

DATE:	INFORMATION:
10-03-2022	PLAN CHECK

SHEET INFORMATION:

STK PROJECT NO.: 374-154-21
SCALE: AS NOTED
DATE: SEPTEMBER 2022
PLOT DATE: 09-28-2022
DRAWING NAME:

SEAL:



SHEET TITLE:

SITE STRUCTURES,
STORAGE BUILDING &
TRASH ENCLOSURE -
ROOF FRAMING &
FOUNDATION PLANS


SHEET NO.:

S4

FUEL CANOPY (FC) - ROOF FRAMING PLAN

DO NOT SCALE PLANS FOR CONSTRUCTION DIMENSIONS. ALL CONSTRUCTION DIMENSIONS SHOULD BE VERIFIED WITH THE ARCHITECTURAL SET OF PLANS.

SCALE : 1/4" = 1'-0"

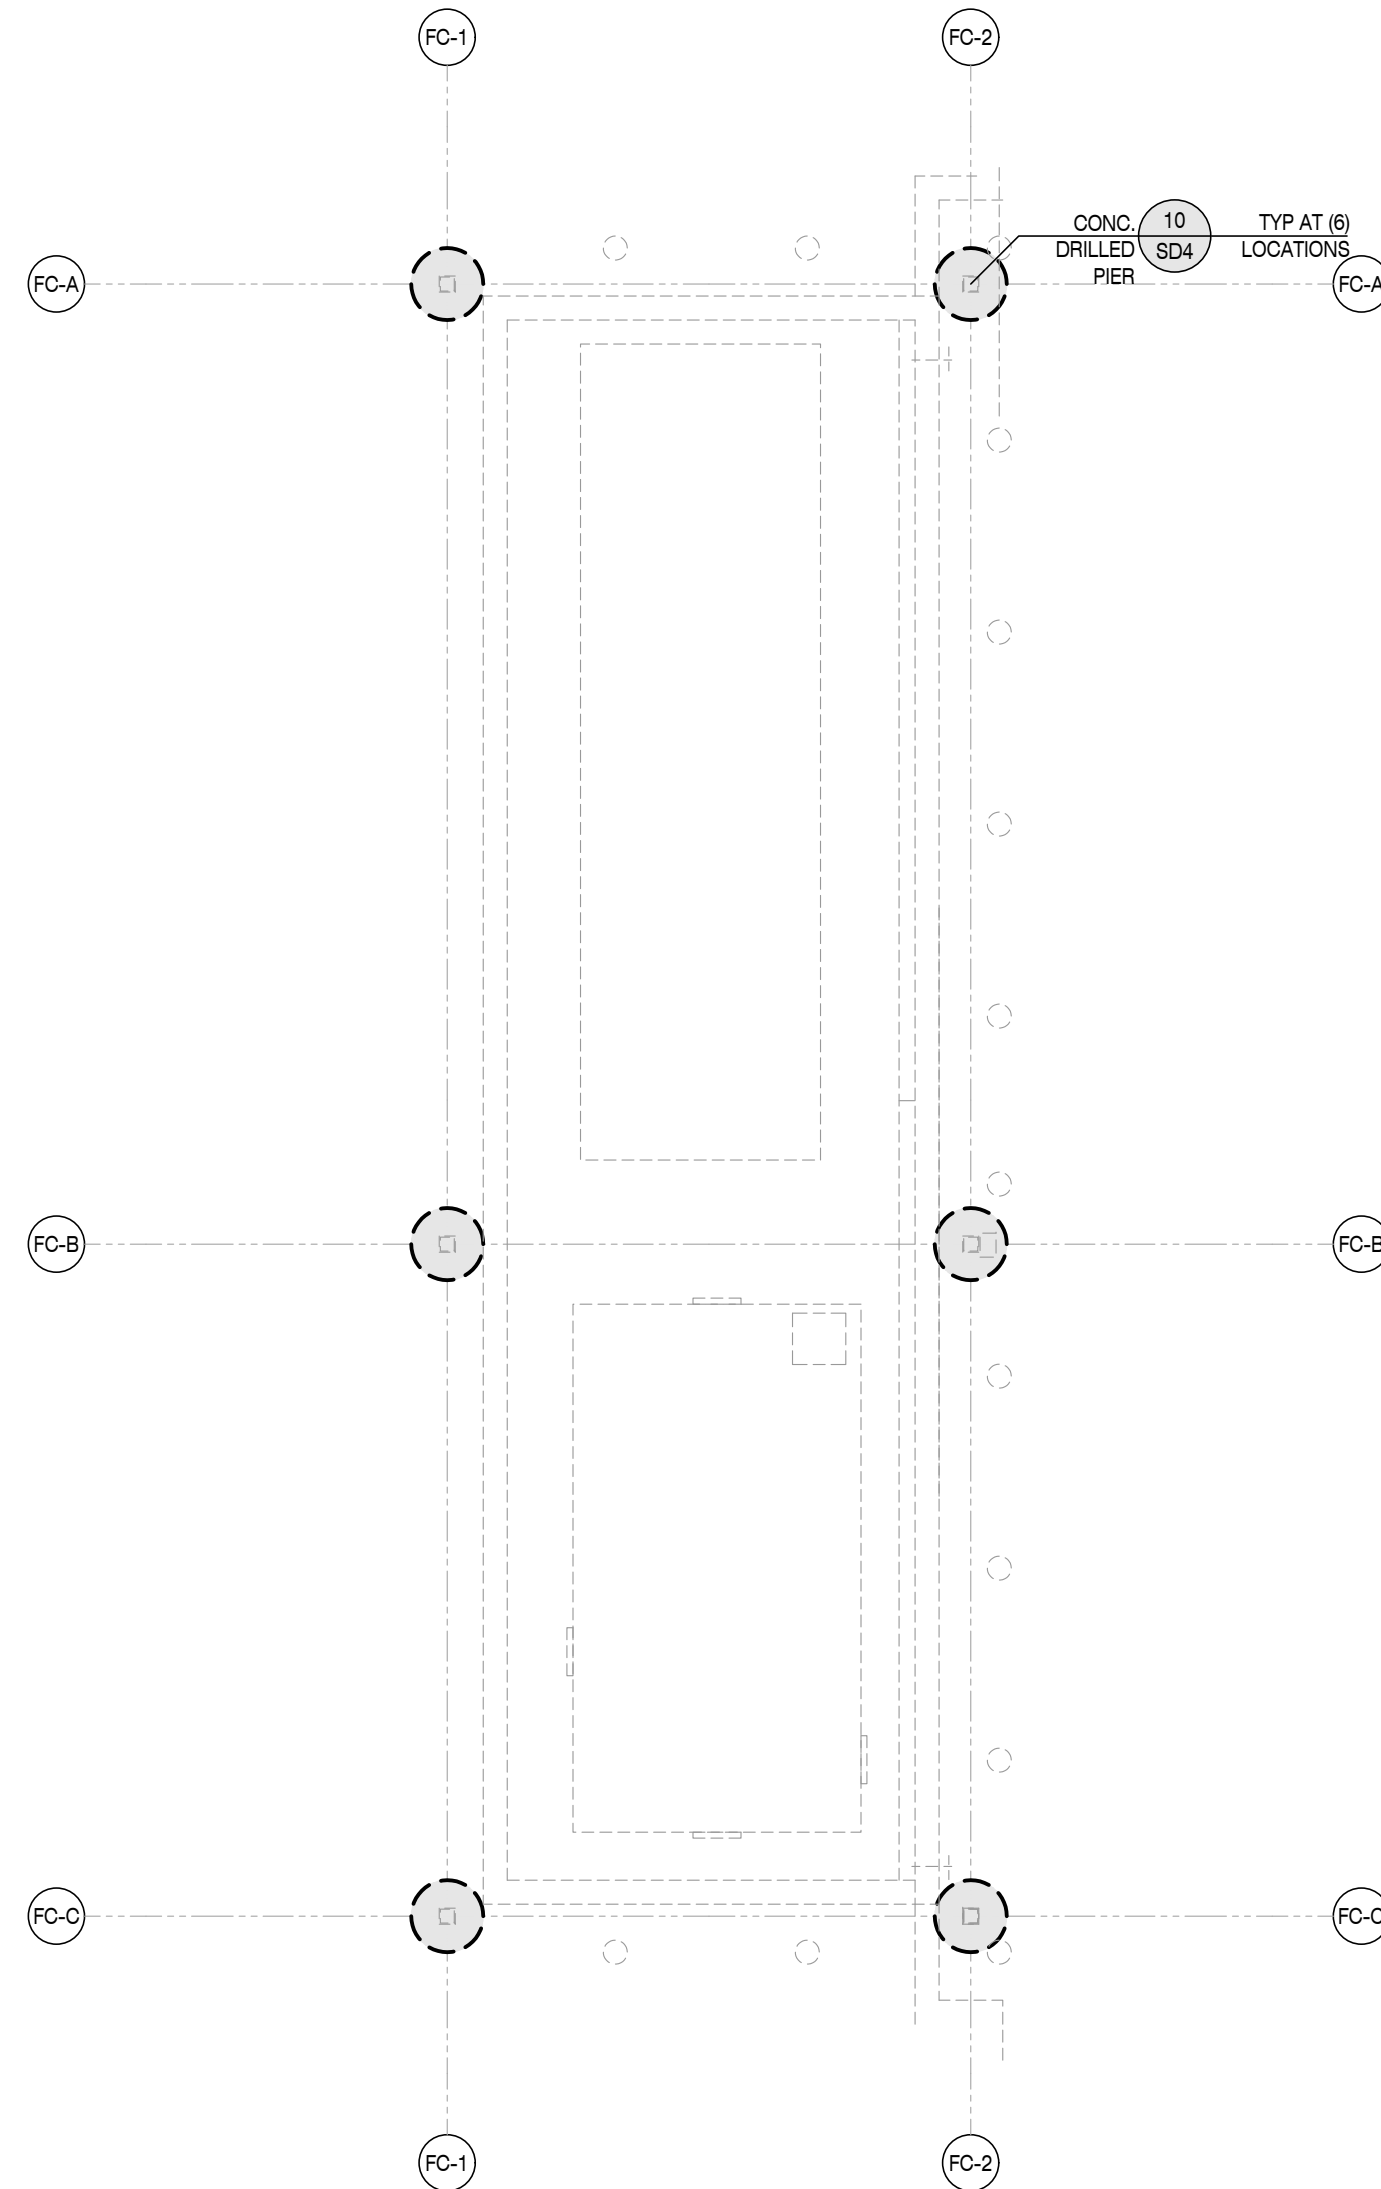

FUEL CANOPY (FC) - FOUNDATION PLAN

DO NOT SCALE PLANS FOR CONSTRUCTION DIMENSIONS. ALL CONSTRUCTION DIMENSIONS SHOULD BE VERIFIED WITH THE ARCHITECTURAL SET OF PLANS.

SCALE : 1/4" = 1'-0"

FRAMING NOTES

1. REFER TO STRUCTURAL GENERAL NOTE SHEET (SN SERIES) AND DETAILS (SD SERIES) FOR INFORMATION NOT SHOWN ON THE MAIN FRAMING PLANS.
2. FRAMER TO COORDINATE JOIST SPACING WITH M.E.P. DESIGNS. FRAMER TO REVIEW MECH. AND ELECTRIC PLANS BEFORE FINAL PLACEMENT OF JOISTS. WHERE ALIGNED JOIST INTERFERES W/ FUTURE INSTALLATION OF M.E.P. INSTALLATION, CONTACT STRUCTURAL ENGINEER.
3. SPLICE ALL EXTERIOR WALL AND INTERIOR SHEAR WALL TOP PLATE BREAKS PER DETAIL 4/S/D2, TYP.
4. ROOF SHOULD BE FULLY LOADED PRIOR TO NAILING THE TOP PLATE HARDWARE TO ROOF JOIST BOTTOM CHORD.
5. WATERPROOFING & DRAINAGE SHALL BE PROVIDED BY OTHERS.

FRAMING LEGEND & SYMBOLS

AT XX' O.C. REQUIRED ANCHOR/SPACING DETAIL # SHEET #	INDICATES DETAIL CUT LOCATION. REFER TO DETAIL # AND STRUCTURAL SHEET NUMBER FOR MORE INFORMATION. TEXT ABOVE BUBBLE INDICATES REVISED HARDWARE OTHER THAN NOTED IN DETAIL.
INDICATES 2x6 STUD WALL PER PLAN & DETAIL 5/S/D2. COORDINATE STUD WALL SIZE WITH ARCH. PLANS.	
INDICATES: 8" CMU (m = 1500 psi) WALL WITH #4 AT 16" O.C. VERTICAL & #4 AT 24" O.C. HORIZONTAL WITH SOLID GROUT. REFER TO PLANS & DETAILS FOR ADD'L INFORMATION.	
INDICATES: 1. WALL OPENING HEADER PER FRAMING SCHEDULE BELOW 2. PROVIDE (1) 2x TRIMMER EACH SIDE U.N.O. ON PLAN. 3. PROVIDE KING STUDS EACH SIDE PER DETAIL 5/S/D2 U.N.O. ON PLAN.	
INDICATES ALIGNED ROOF RAFTER W/ ROOF DIAPHRAGM EDGE NAILING	
INDICATES SPAN AND DIRECTION OF ROOF RAFTERS. RAFTER SIZE AND SPACING PER PLANS.	
INDICATES: 1. BEAM AS NOTED ON PLANS	
INDICATES METAL ROOF DECK PER PLAN. REFER TO DETAIL 12/SD4 FOR ADDITIONAL INFORMATION INCLUDING DECK TYPES.	
INDICATES: 1. WOOD SHEAR WALL PANEL LOCATION PER PLAN INSTALLED FULL HEIGHT OF WALL. 2. REFER TO DETAIL 1/S/D2 SHEAR WALL SCHEDULE FOR ADDITIONAL REQUIREMENTS 3. PROVIDE POST AND STRAP/HOLDOWN EACH END OF WALL MIN AS INDICATED PER PLAN 4. AT UPPER FLOORS WHERE WALL SHEATHING DOES NOT EXTEND AND EDGE NAIL TO FLOOR RIM PROVIDE SILL PLATE NAILING OR SCREWS PER DETAIL 1/S/D2	
INDICATES: 1. WOOD SHEAR WALL PANEL LOCATION PER PLAN INSTALLED FULL HEIGHT OF WALL AND SHEAR PANEL ABOVE AND BELOW OPENING 2. REFER TO DETAIL 1/S/D2 SHEAR WALL SCHEDULE FOR ADDITIONAL REQUIREMENTS 3. PROVIDE POST AND STRAP/HOLDOWN EACH END OF WALL MIN AS INDICATED PER PLAN 4. AT UPPER FLOORS WHERE WALL SHEATHING DOES NOT EXTEND AND EDGE NAIL TO FLOOR RIM PROVIDE SILL PLATE NAILING OR SCREWS PER DETAIL 1/S/D2 5. REFER TO DETAIL 5B/S/D2 FOR PERFORATED SHEAR WALL CONDITION (SHEAR ABV AND BLW OPENING W/O STRAP) 6. REFER TO DETAIL 5C/S/D2 FOR FORCE TRANSFER SHEAR WALL CONDITION (SHEAR ABV AND BLW OPENING W/ STRAP)	
INDICATES: DRAG TIE STRAP PER PLAN OR DETAIL SHOWN ON PLANS.	

GEOTECHNICAL INFORMATION

1. REFER TO STRUCTURAL COVER SHEET (SCS) FOR ASSUMED SOIL VALUES OR VALUES BASED ON THE PROVIDED GEOTECHNICAL (SOILS) REPORT.
2. THE OWNER/DEVELOPER AND SUBCONTRACTORS ARE TO REVIEW THE SOILS REPORT PRIOR TO COMMENCING CONSTRUCTION AND VERIFY THE PLANS COMPLY WITH THE CURRENT SOILS REPORT RECOMMENDATIONS. THE STRUCTURAL ENGINEER SHALL BE NOTIFIED IF THE SOILS REPORT DATE SHOWN ON SHEET (SCS) DOES NOT MATCH THE CURRENT REPORT DATE. THE OWNER/DEVELOPER IS RESPONSIBLE FOR UPDATING THE STRUCTURAL ENGINEER WITH CURRENT GEOTECHNICAL ENGINEERING REQUIREMENTS.

FOUNDATION NOTES


1. INSTALL HOLDOWN ANCHOR BOLTS PER 9/S/D1. PROVIDE AND INSTALL ALL U.S.P. OR SIMPSON LUMBER CONNECTORS (OR EQUAL) FOUNDATION HARDWARE PER MANUFACTURERS RECOMMENDATIONS. DEEPEN FOOTING WHERE NECESSARY TO PROVIDE ANCHOR EMBEDMENT AT HOLDOWN LOCATIONS.
2. REFER TO DETAIL PACKAGE FOR TYPICAL CONDITIONS NOT SPECIFICALLY CALLED OUT OR NOTED ON PLANS.
3. ALL DIMENSIONS SHALL BE PER THE CURRENT APPROVED STAMPED SET OF ARCHITECTURAL PLANS. OUR OFFICE SHOULD BE NOTIFIED IMMEDIATELY IF DISCREPANCIES EXIST BETWEEN THE ARCHITECTURAL & STRUCTURAL PLANS.
4. CLIENT/OWNER SHALL ADDRESS CORROSIVE SOIL CONDITIONS. FOR HIGH SULFATE SOIL CONDITIONS, MITIGATE PER ACI TABLE 19.3.2.1. THE CLIENT/OWNER SHALL HAVE A CORROSION ENGINEER PROVIDE MITIGATION RECOMMENDATIONS FOR ALL OTHER CORROSIVE SOIL CONDITIONS. CLIENT IS RESPONSIBLE TO REVIEW STRUCTURAL PLANS AND DETAILS FOR COMPLIANCE TO CORROSION ENGINEERS RECOMMENDATIONS PRIOR TO CONSTRUCTION.
5. IN NO CASE SHALL PIPES, CONDUITS, OR SLEEVES BE EMBEDDED IN SPREAD FOOTINGS UNLESS SPECIFICALLY DETAILED ON THE STRUCTURAL DRAWINGS.

FOUNDATION LEGEND & SYMBOLS


CONCRETE SLAB & FOOTING. FOOTING SIZE AND REINFORCING PER DETAIL SHEET SD1, U.N.O. PER PLAN.	
INDICATES: CONCRETE, CMU WALL FOOTING. FOOTING SIZE AND REINFORCING PER DETAIL SHEET SD4, U.N.O. PER PLAN.	
INDICATES: CONCRETE, DRILLED PIER FOOTING. FOOTING SIZE AND REINFORCING PER DETAIL SHEET SD4, U.N.O. PER PLAN.	
INDICATES: DETAIL CUT LOCATION. REFER TO DETAIL # AND STRUCTURAL SHEET NUMBER FOR MORE INFORMATION. TEXT ABOVE BUBBLE INDICATES REVISED HARDWARE OTHER THAN NOTED IN DETAIL.	
INDICATES: WOOD SHEAR WALL LOCATION. REFER TO DETAIL 8/S/D1 FOR ANCHOR BOLT SIZE & SPACING AT EACH SHEAR WALL TYPE. PROVIDE 3" SQ X 0.229" ANGLE SLOTTED PLATE WASHERS AT EACH ANCHOR BOLT. REDUCE BOLT SPACING BY HALF AT DOUBLE SIDED SHEAR WALLS.	

STRUCTURAL OBSERVATION REQUIREMENTS

- STRUCTURAL OBSERVATION IS REQUIRED BY THE ENGINEER OF RECORD. OUR OFFICE SHOULD BE NOTIFIED TO PERFORM STRUCTURAL OBSERVATION AT THE FOLLOWING STAGES OF CONSTRUCTION:
1. PRIOR TO POUR OF CONCRETE TO OBSERVE REINFORCING & EMBEDS
 2. WOOD FRAMING OBSERVATION PRIOR TO COVERING W/ FINISH & AFTER ROOF LOAD

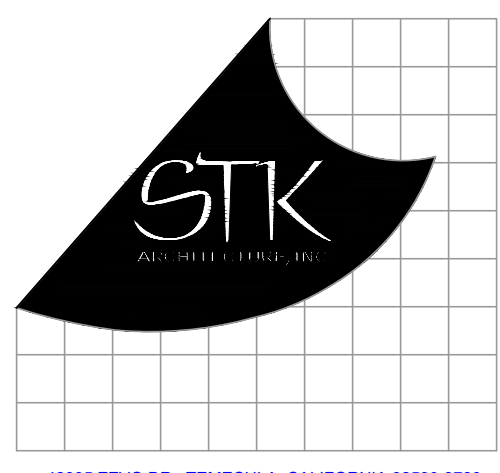

CONSULTANT:

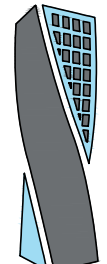

INNOVATIVE
STRUCTURAL ENGINEERING
27189 VIA INDUSTRIAL
TEMECULA, CA 92592
TEL: 951.460.0233
WWW.ISEENGINEERS.COM
SOCAL | NORCAL | COLORADO
ISE PROJECT NO.: 22-7067

PROJECT MANAGER:
SANDY FONG EXT. 1016
SANDY@ISEENGINEERS.COM

PROJECT ADMINISTERED BY:
SAN BERNARDINO COUNTY
REAL ESTATE SERVICES
DEPARTMENT -
PROJECT MANAGEMENT
DIVISION

385 N. ARROWHEAD AVE.
SAN BERNARDINO, CA 92415

PROJECT NAME:

SAN BERNARDINO
COUNTY FIRE
DEPARTMENT:
FIRE STATION 226

PROJECT # 10.10.1032

CIP # _____

CAFM # _____

1920 DEL ROSA AVE N.
SAN BERNARDINO,
CA 92404

ISSUE INFORMATION:

DATE:	INFORMATION:
10-03-2022	PLAN CHECK

SEAL:


















SHEET TITLE:





SITE STRUCTURES, FUEL
GENERATOR/TANK
CANOPY - ROOF FRAMING
& FOUNDATION PLANS

SHEET NO.:

S5

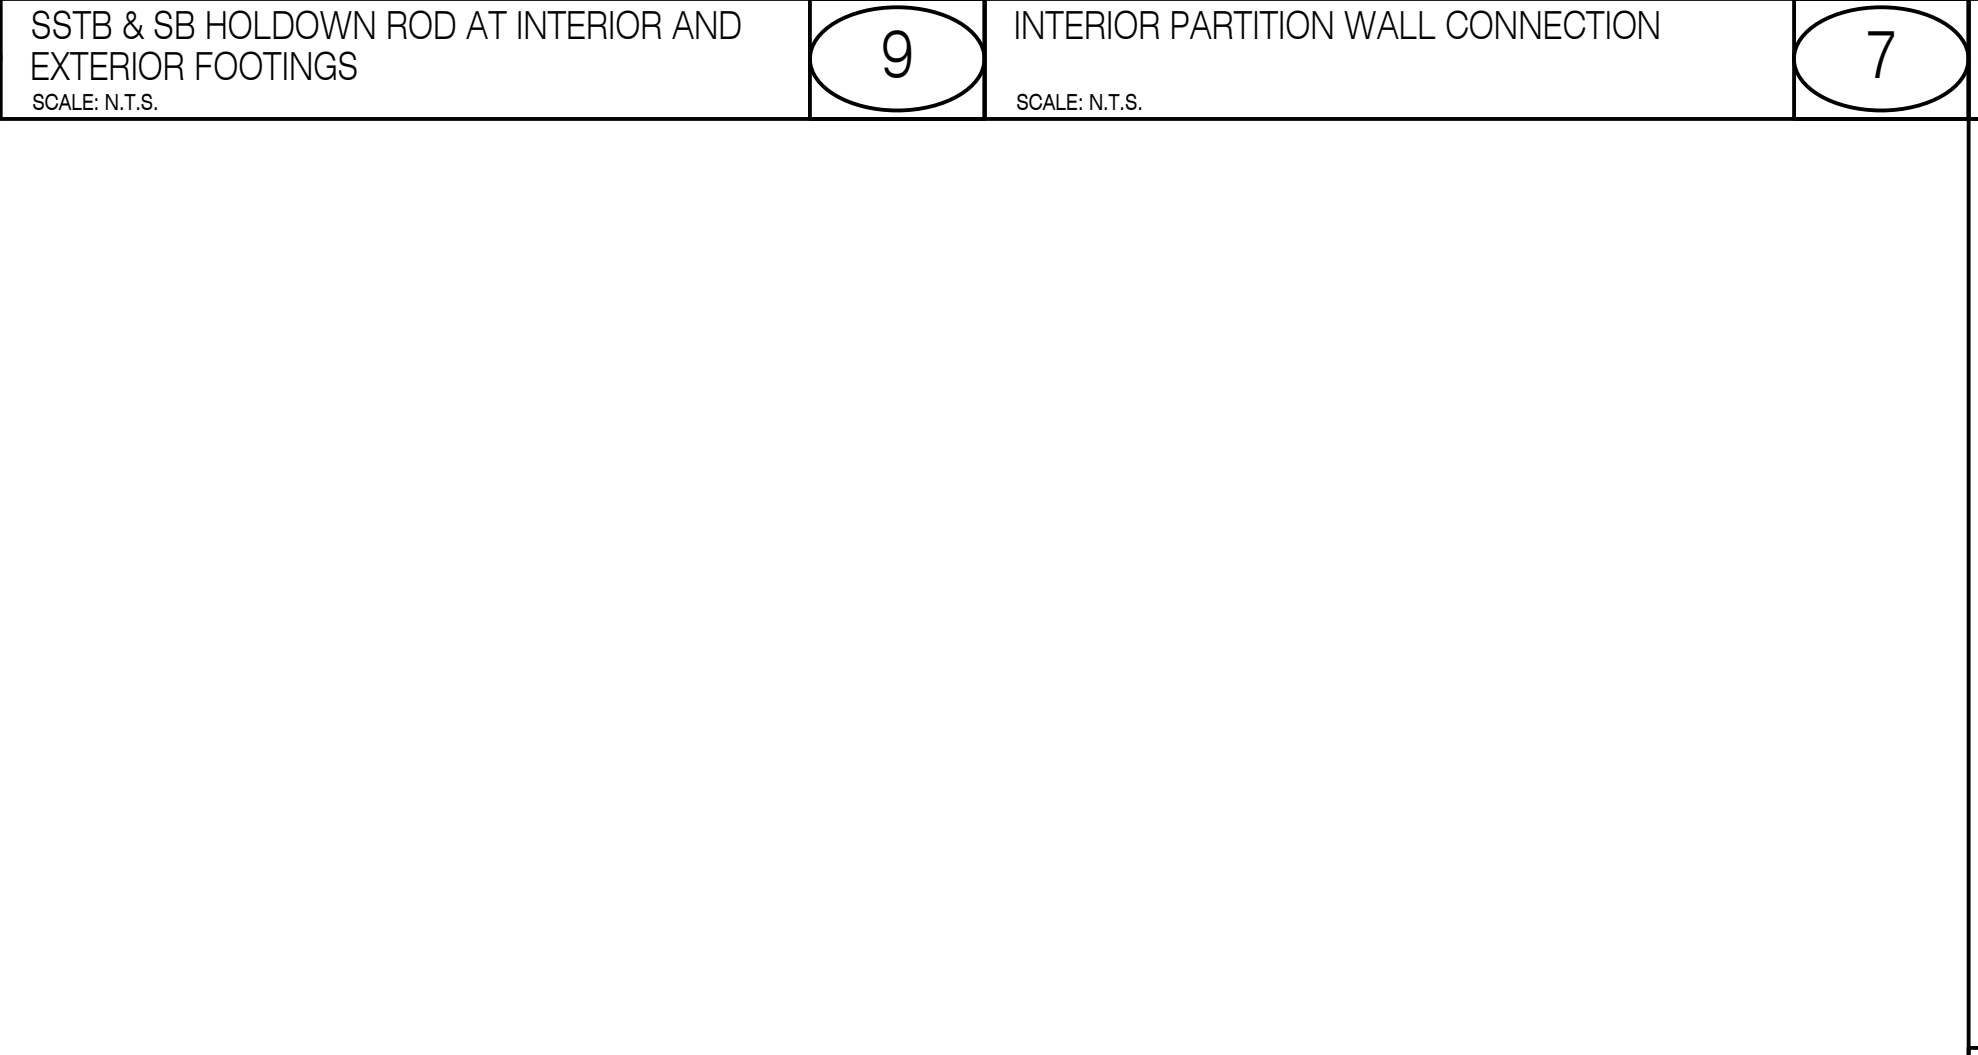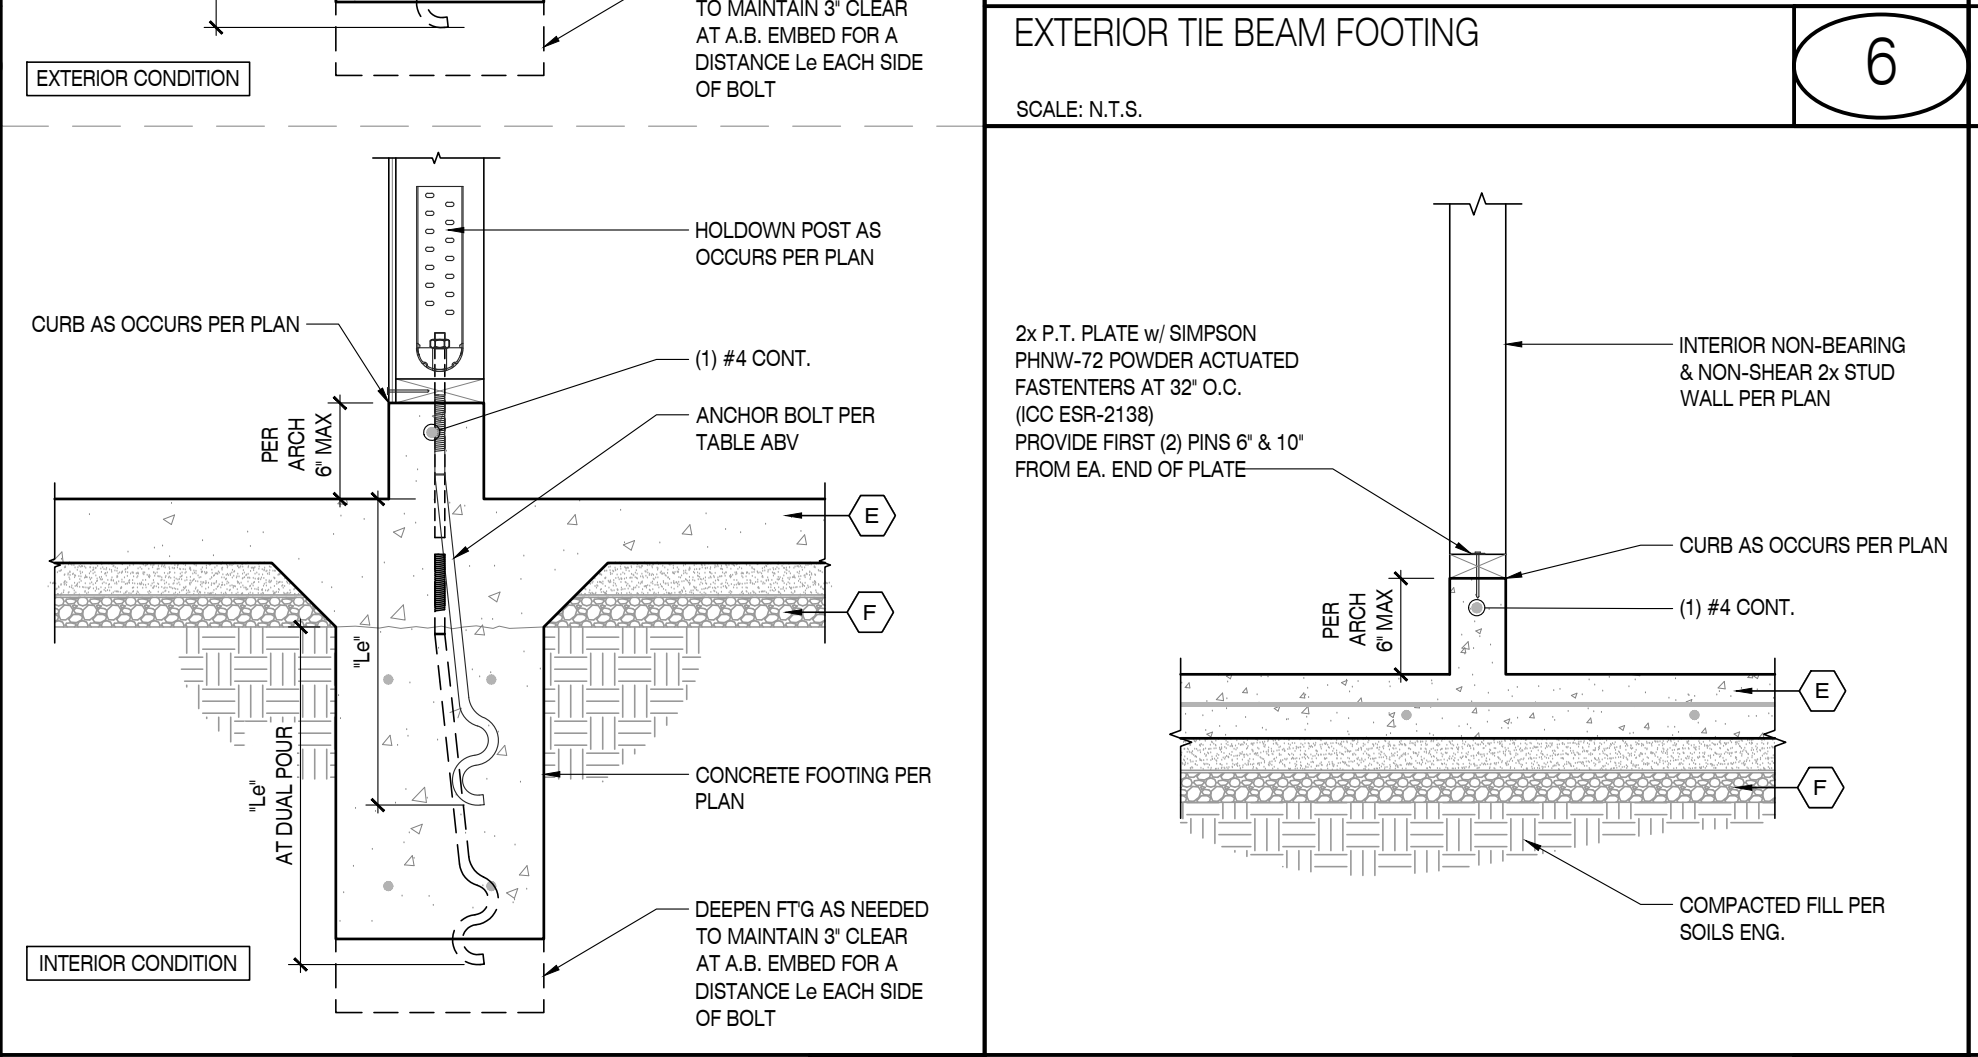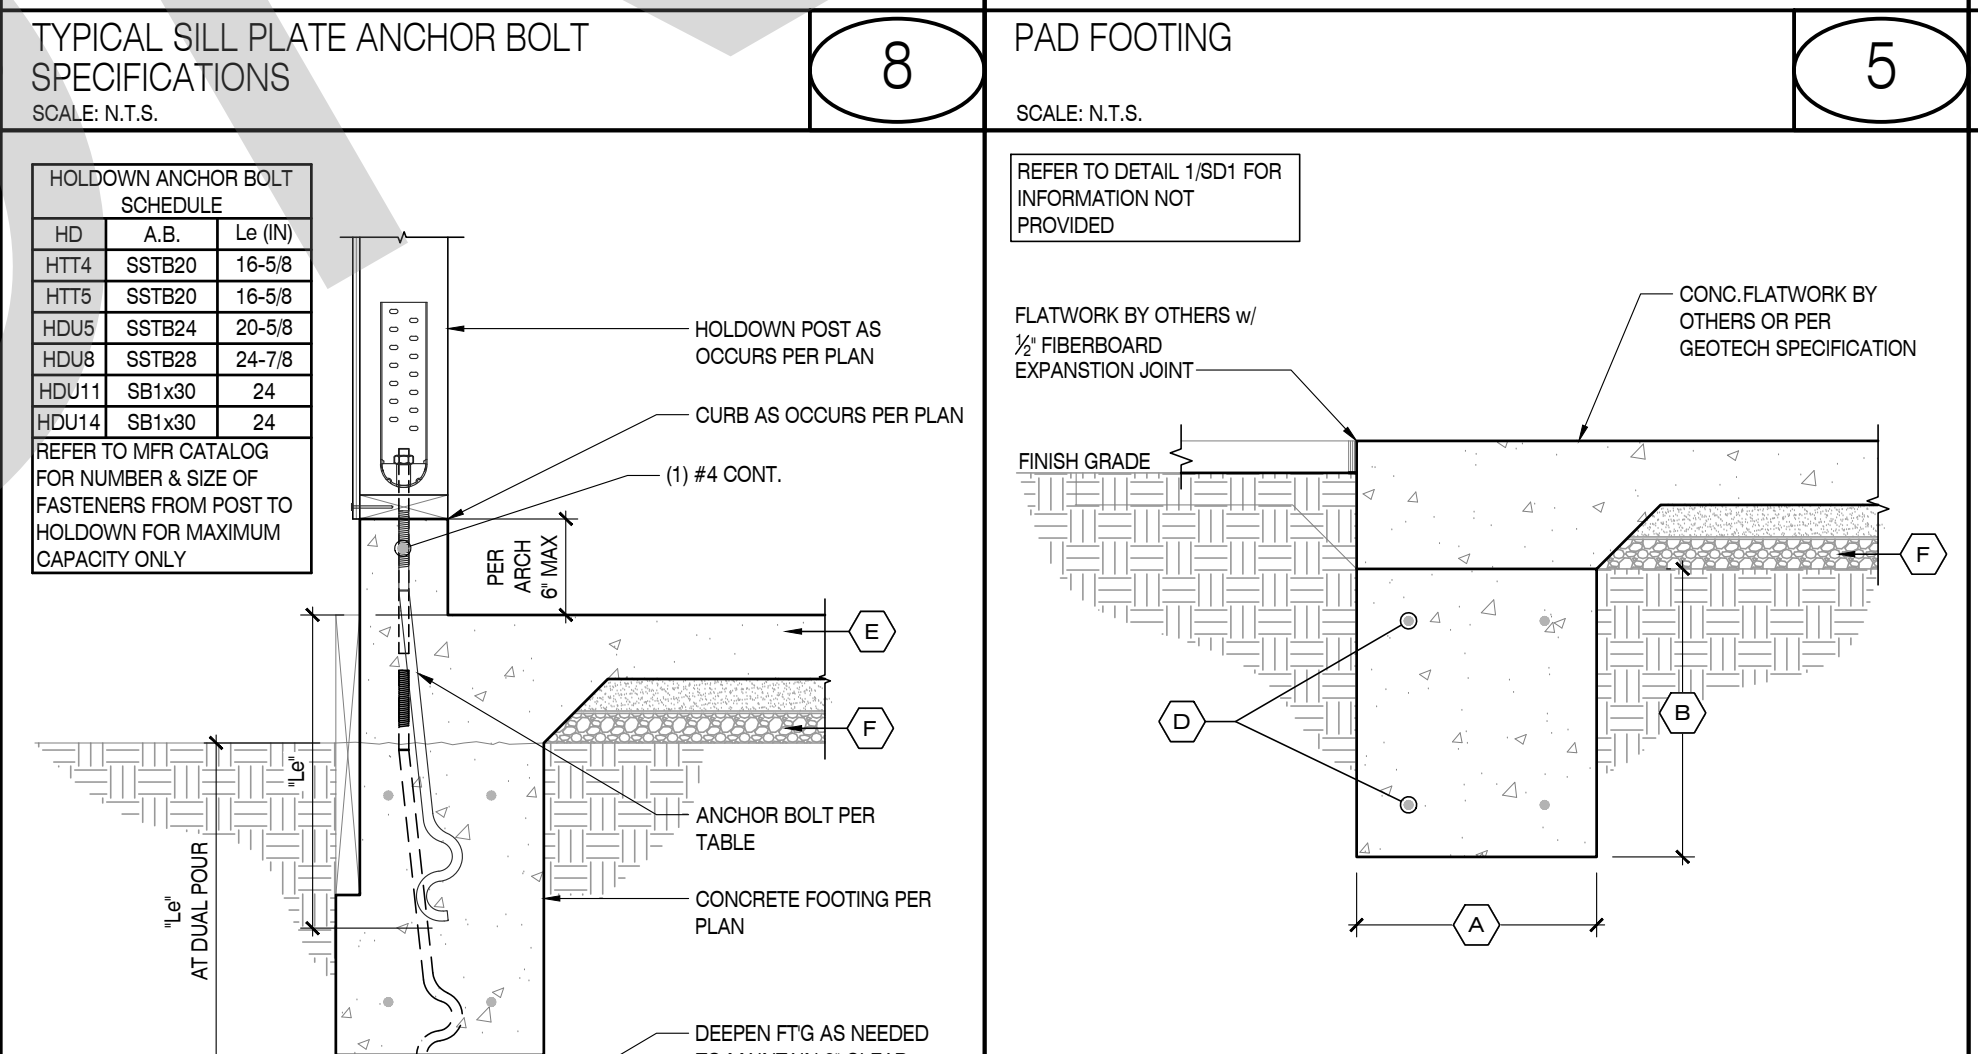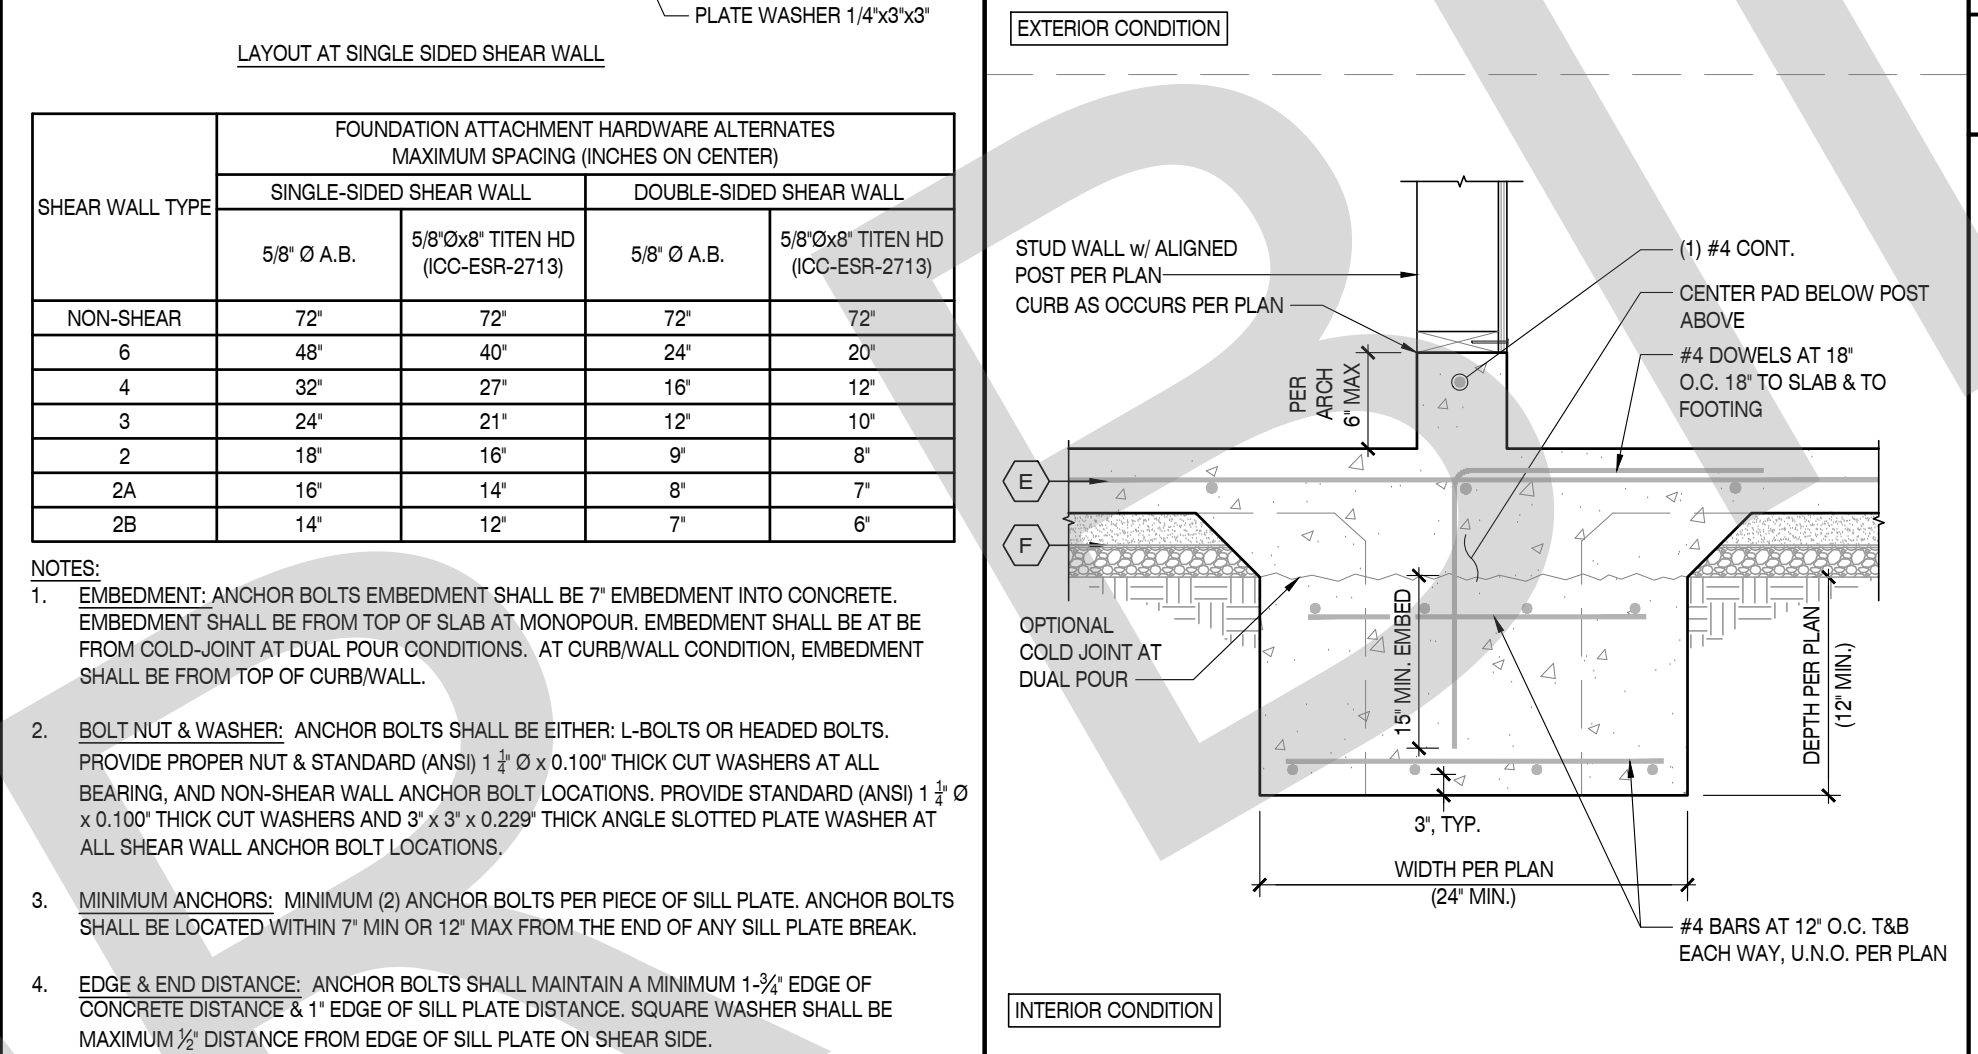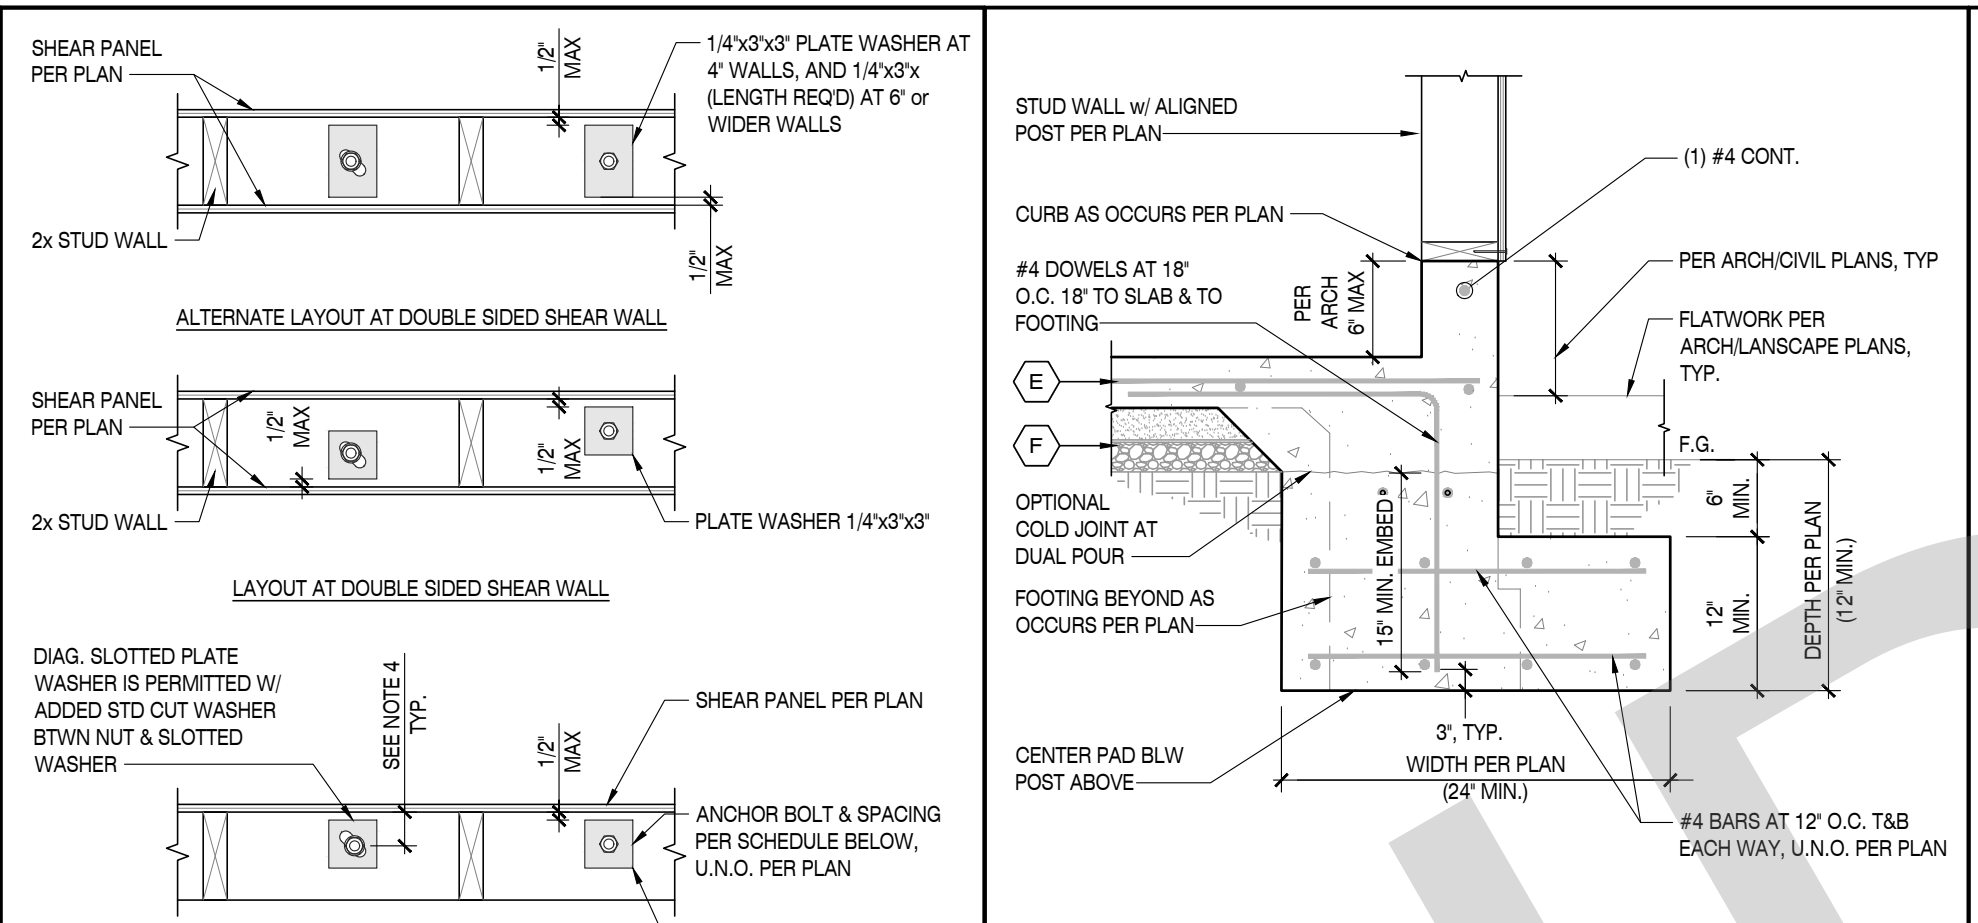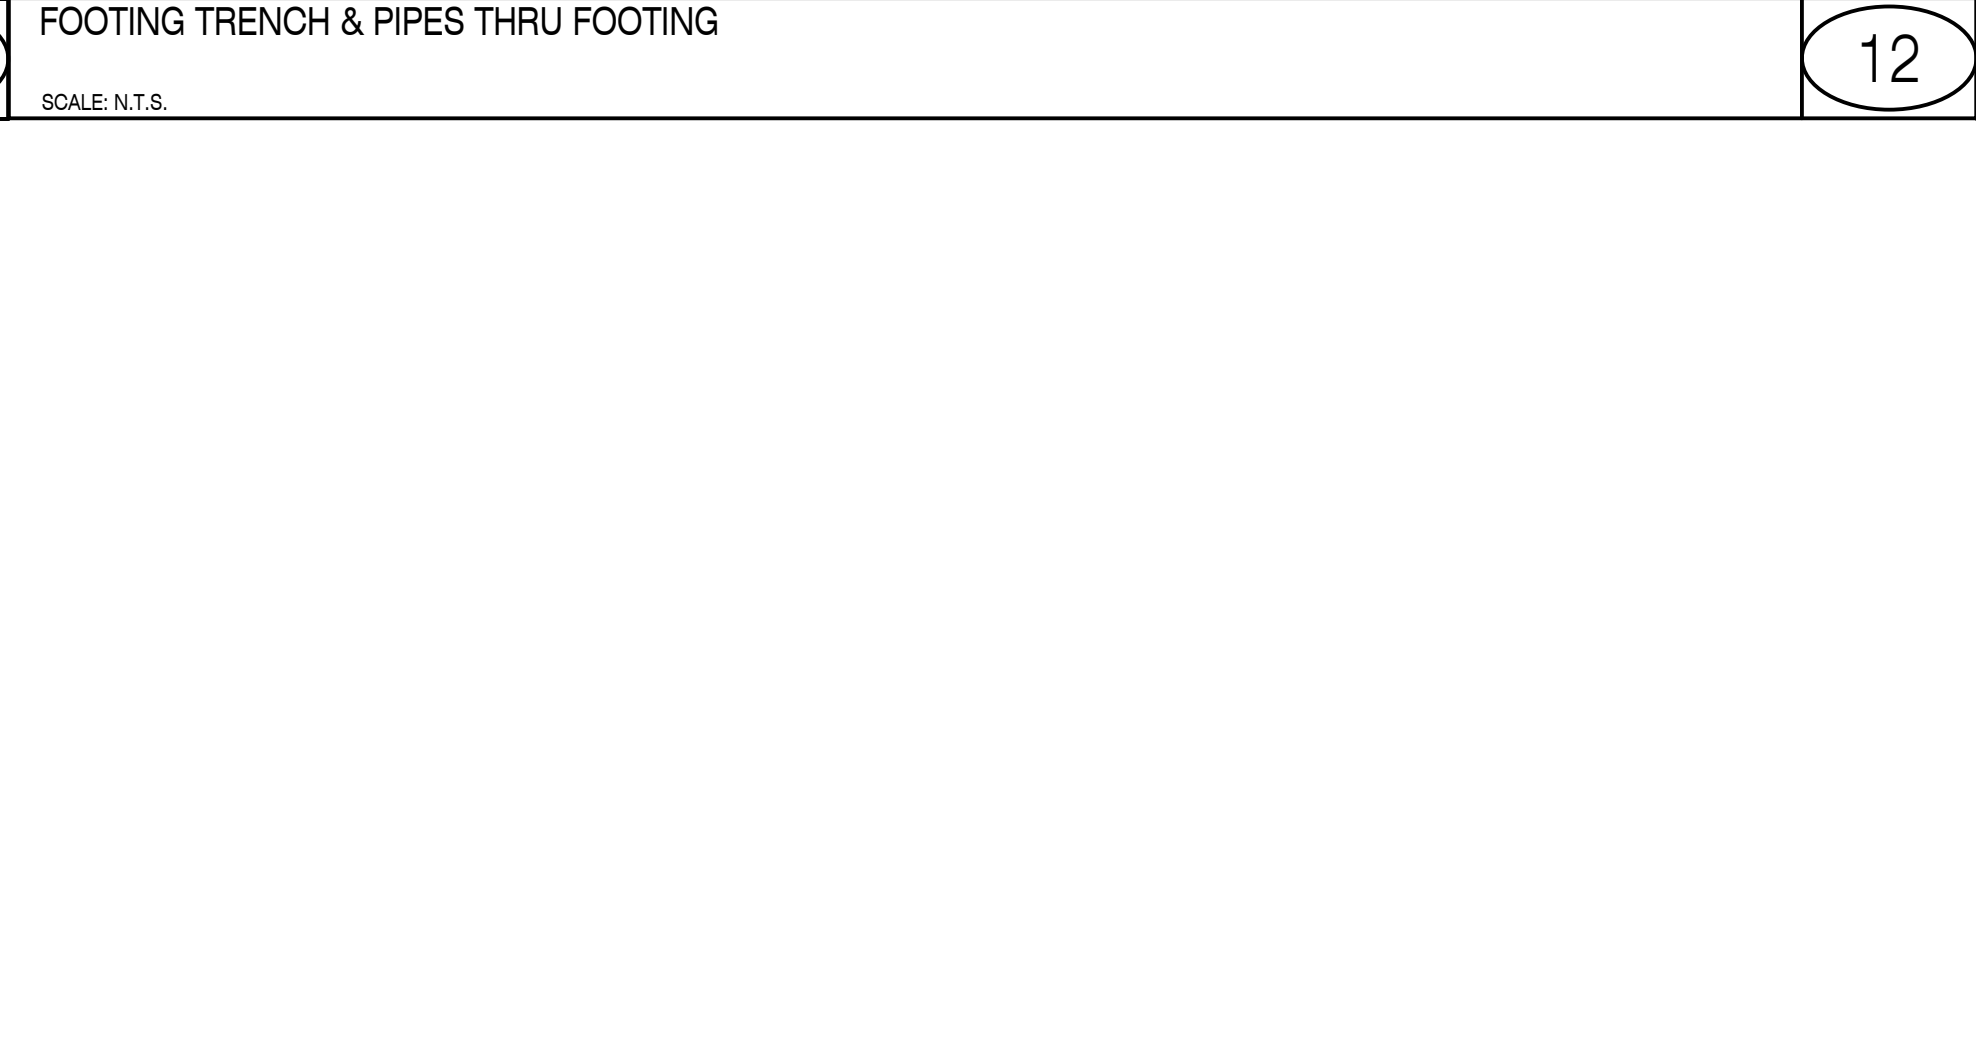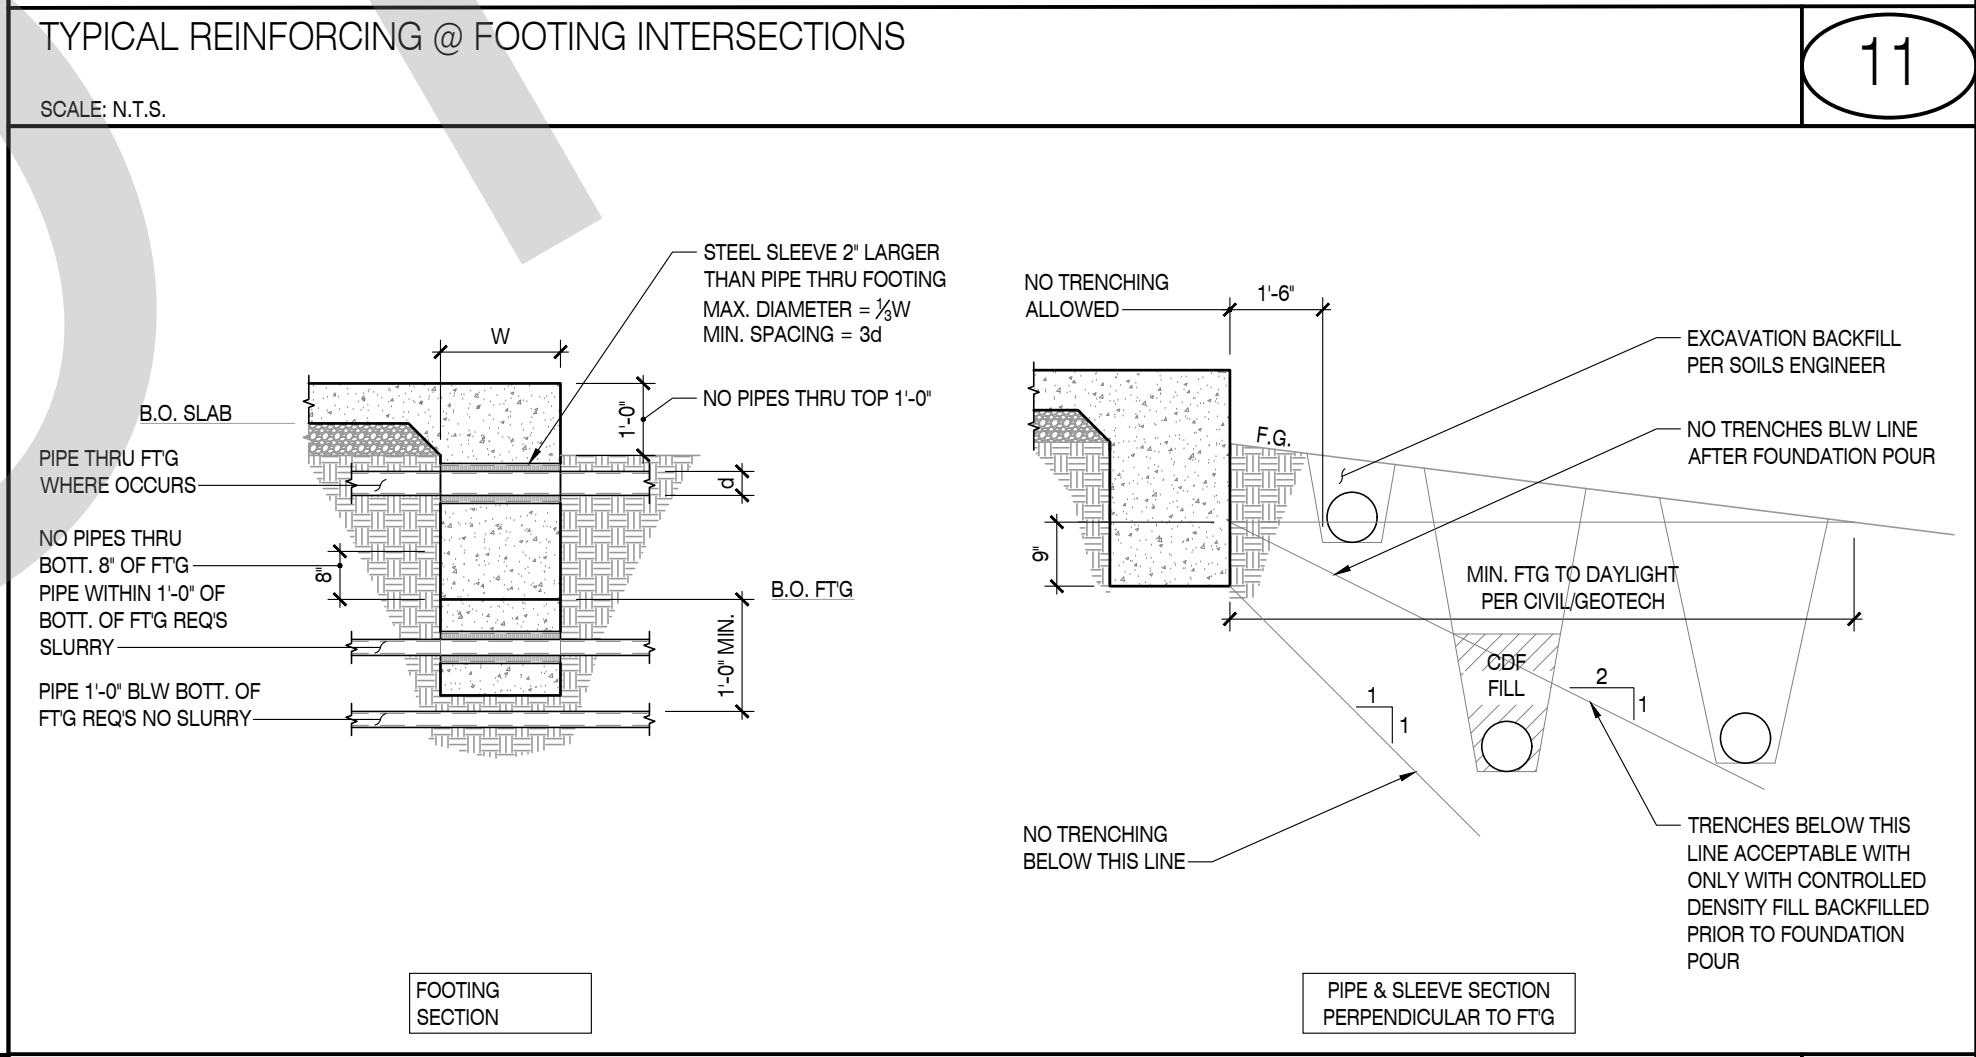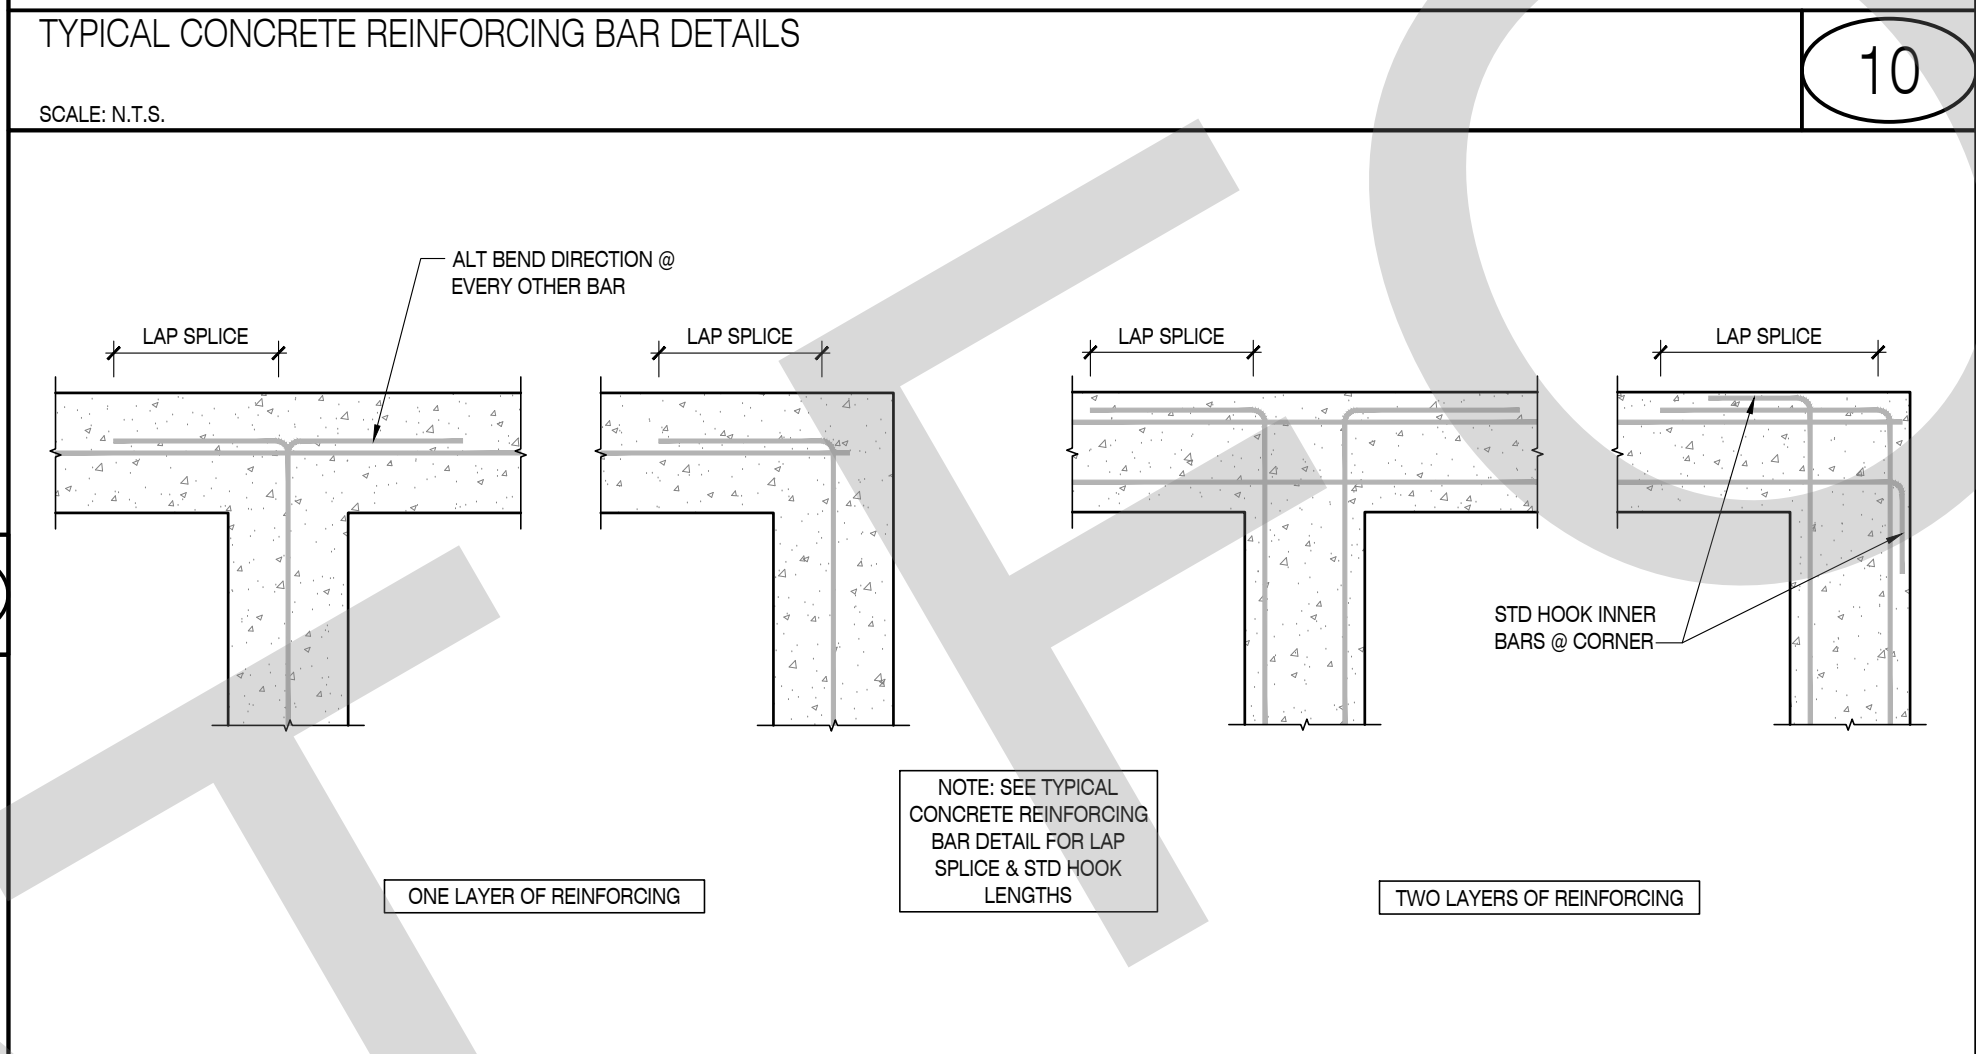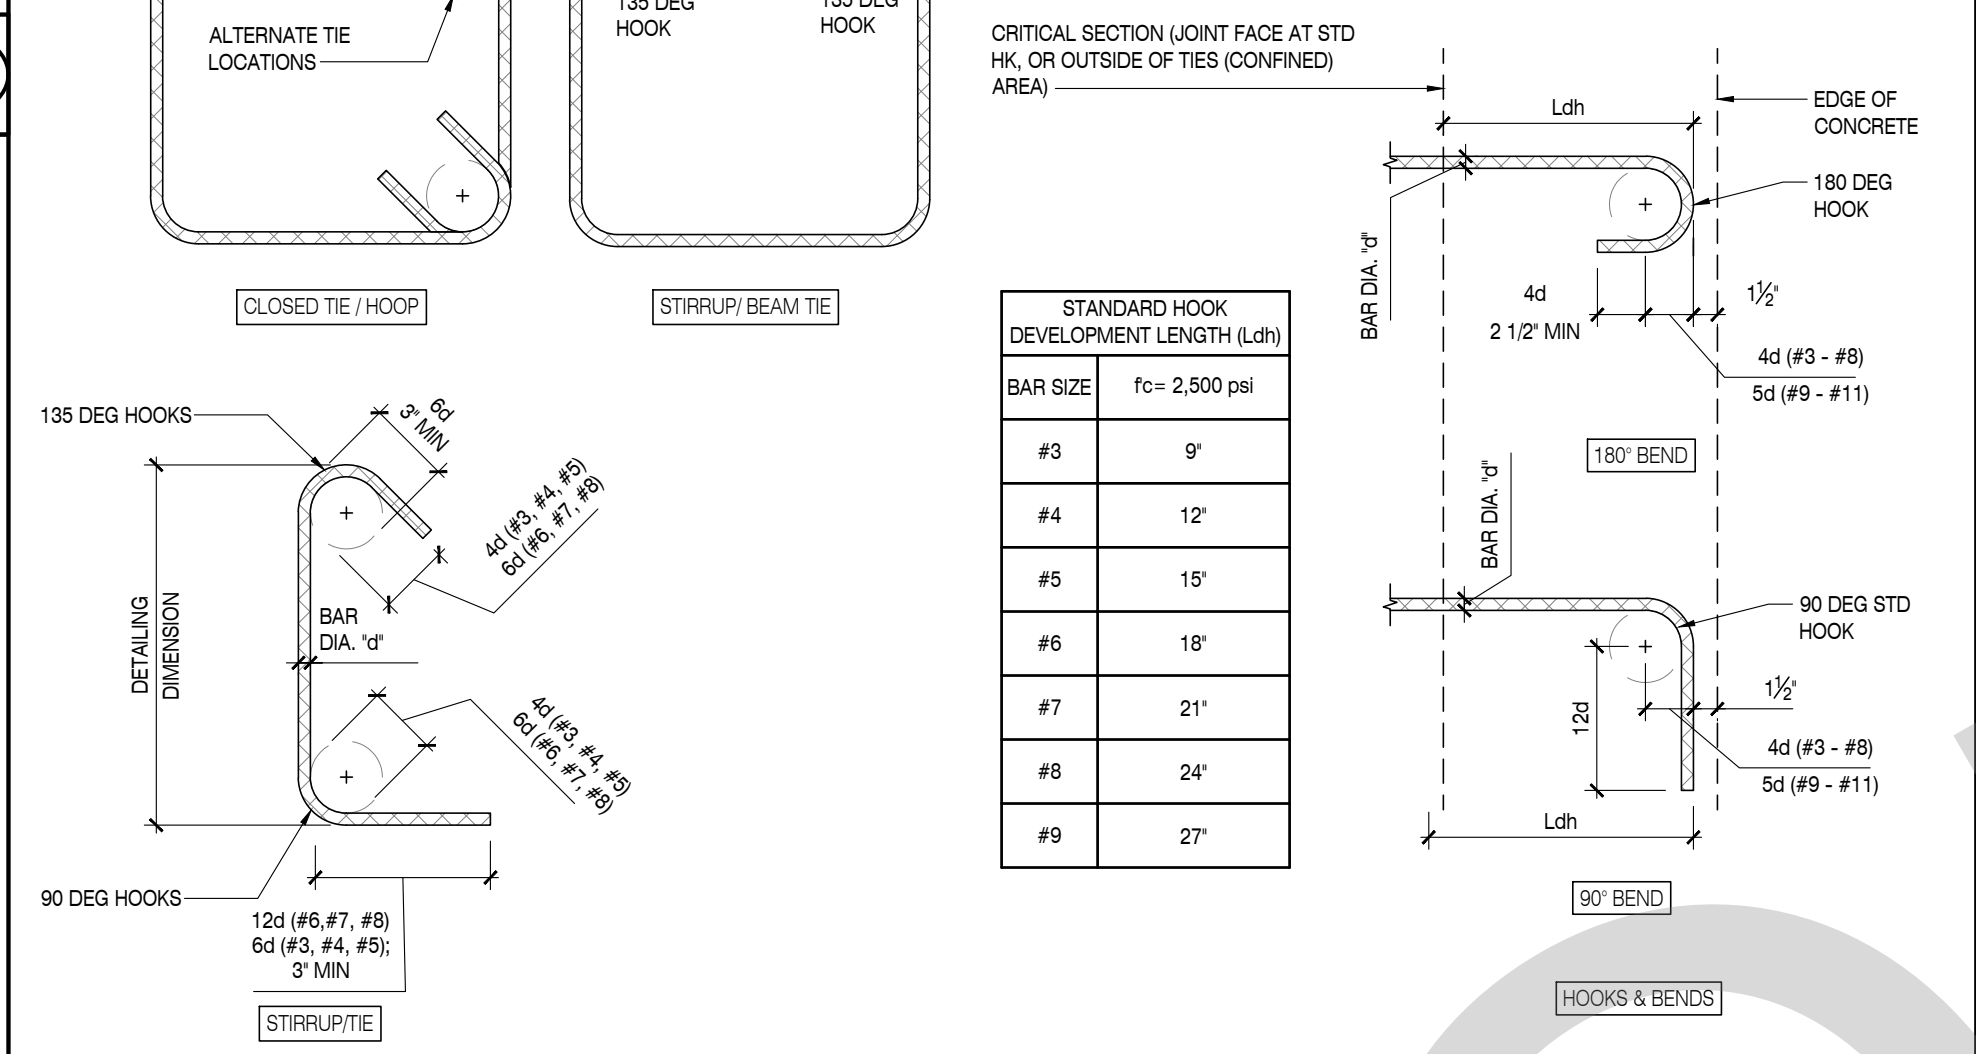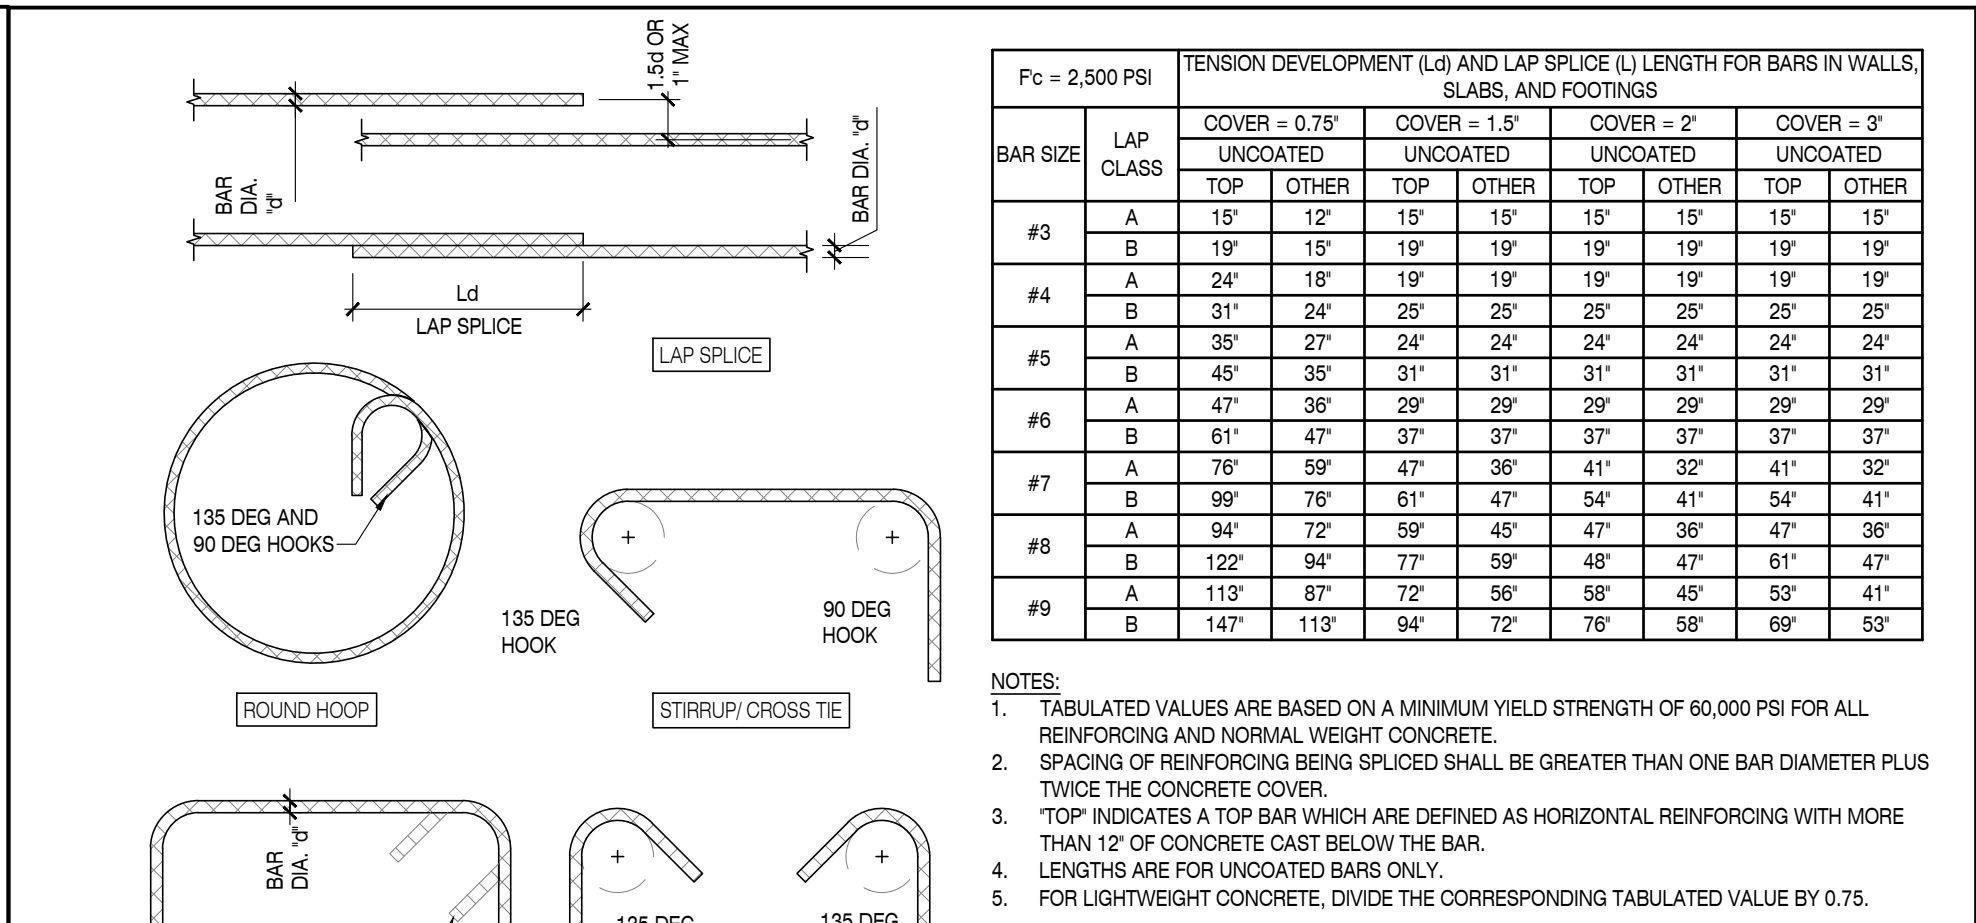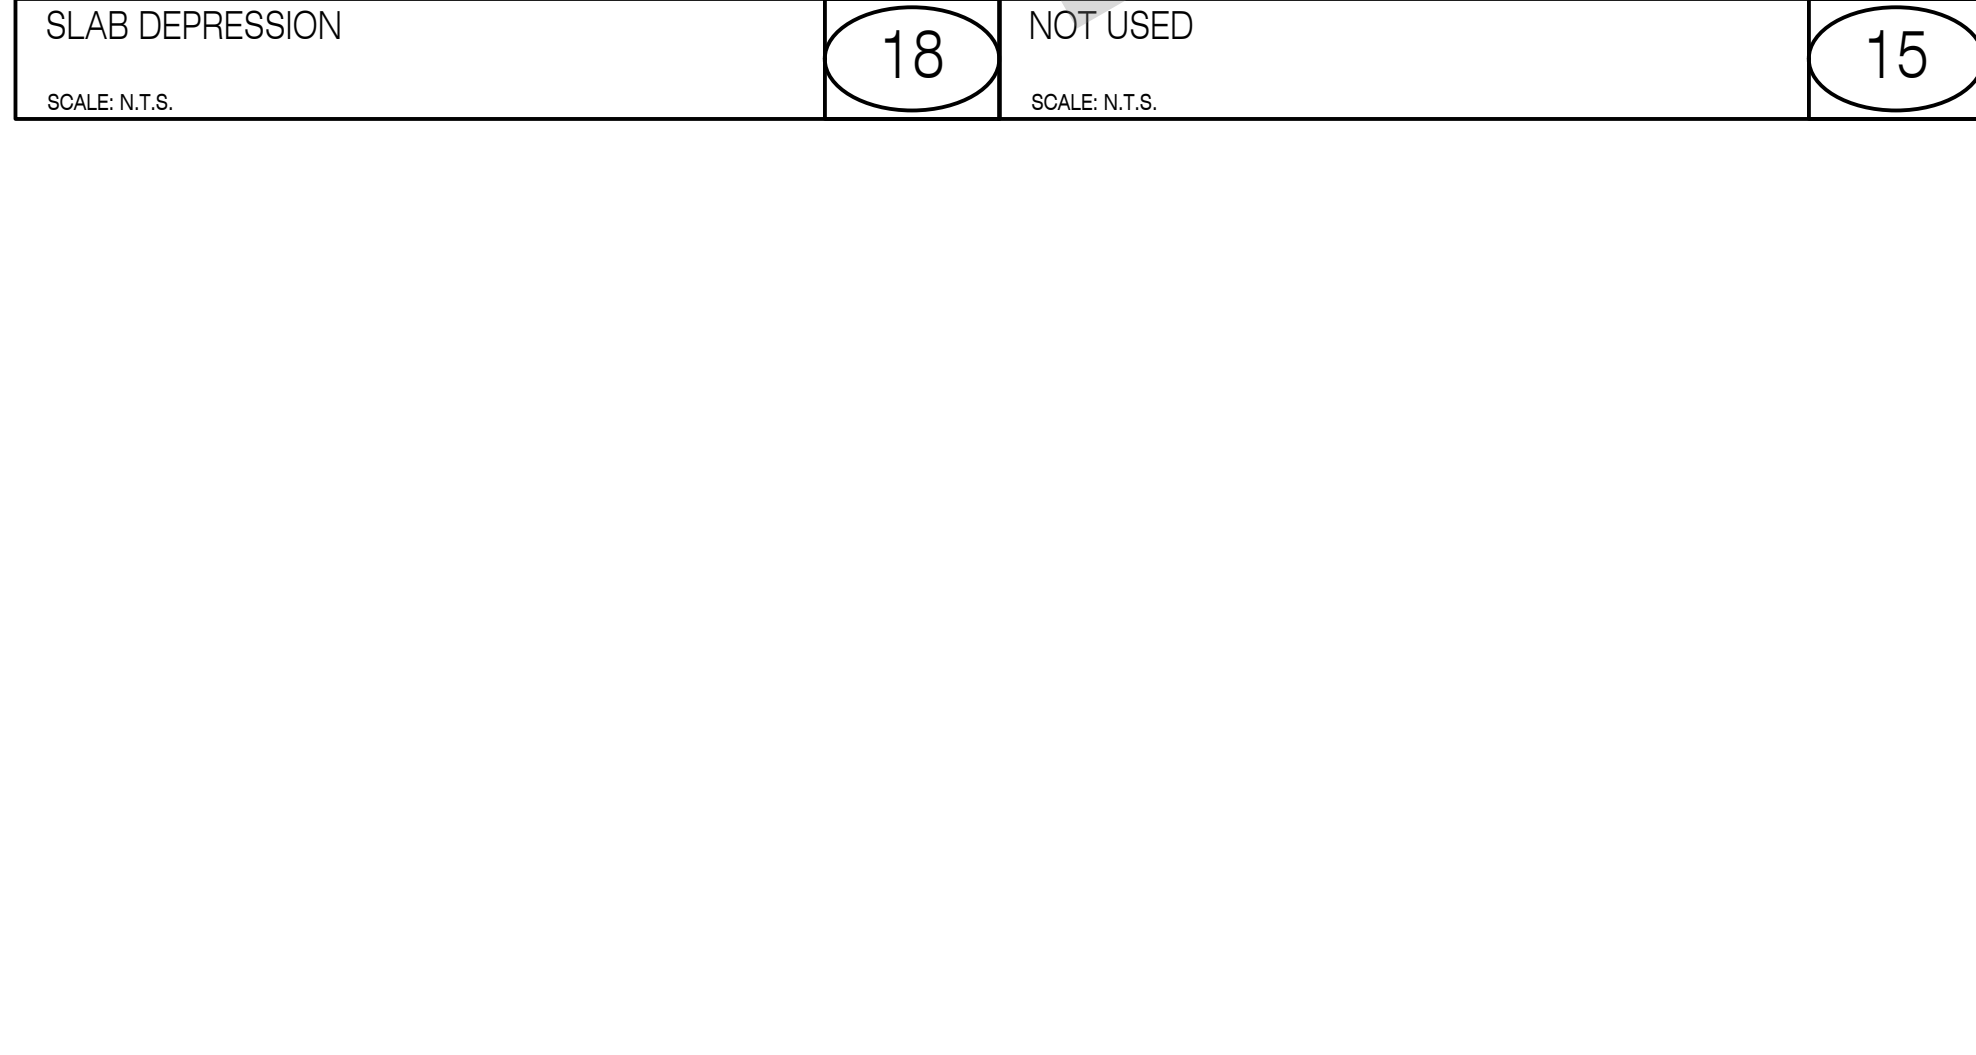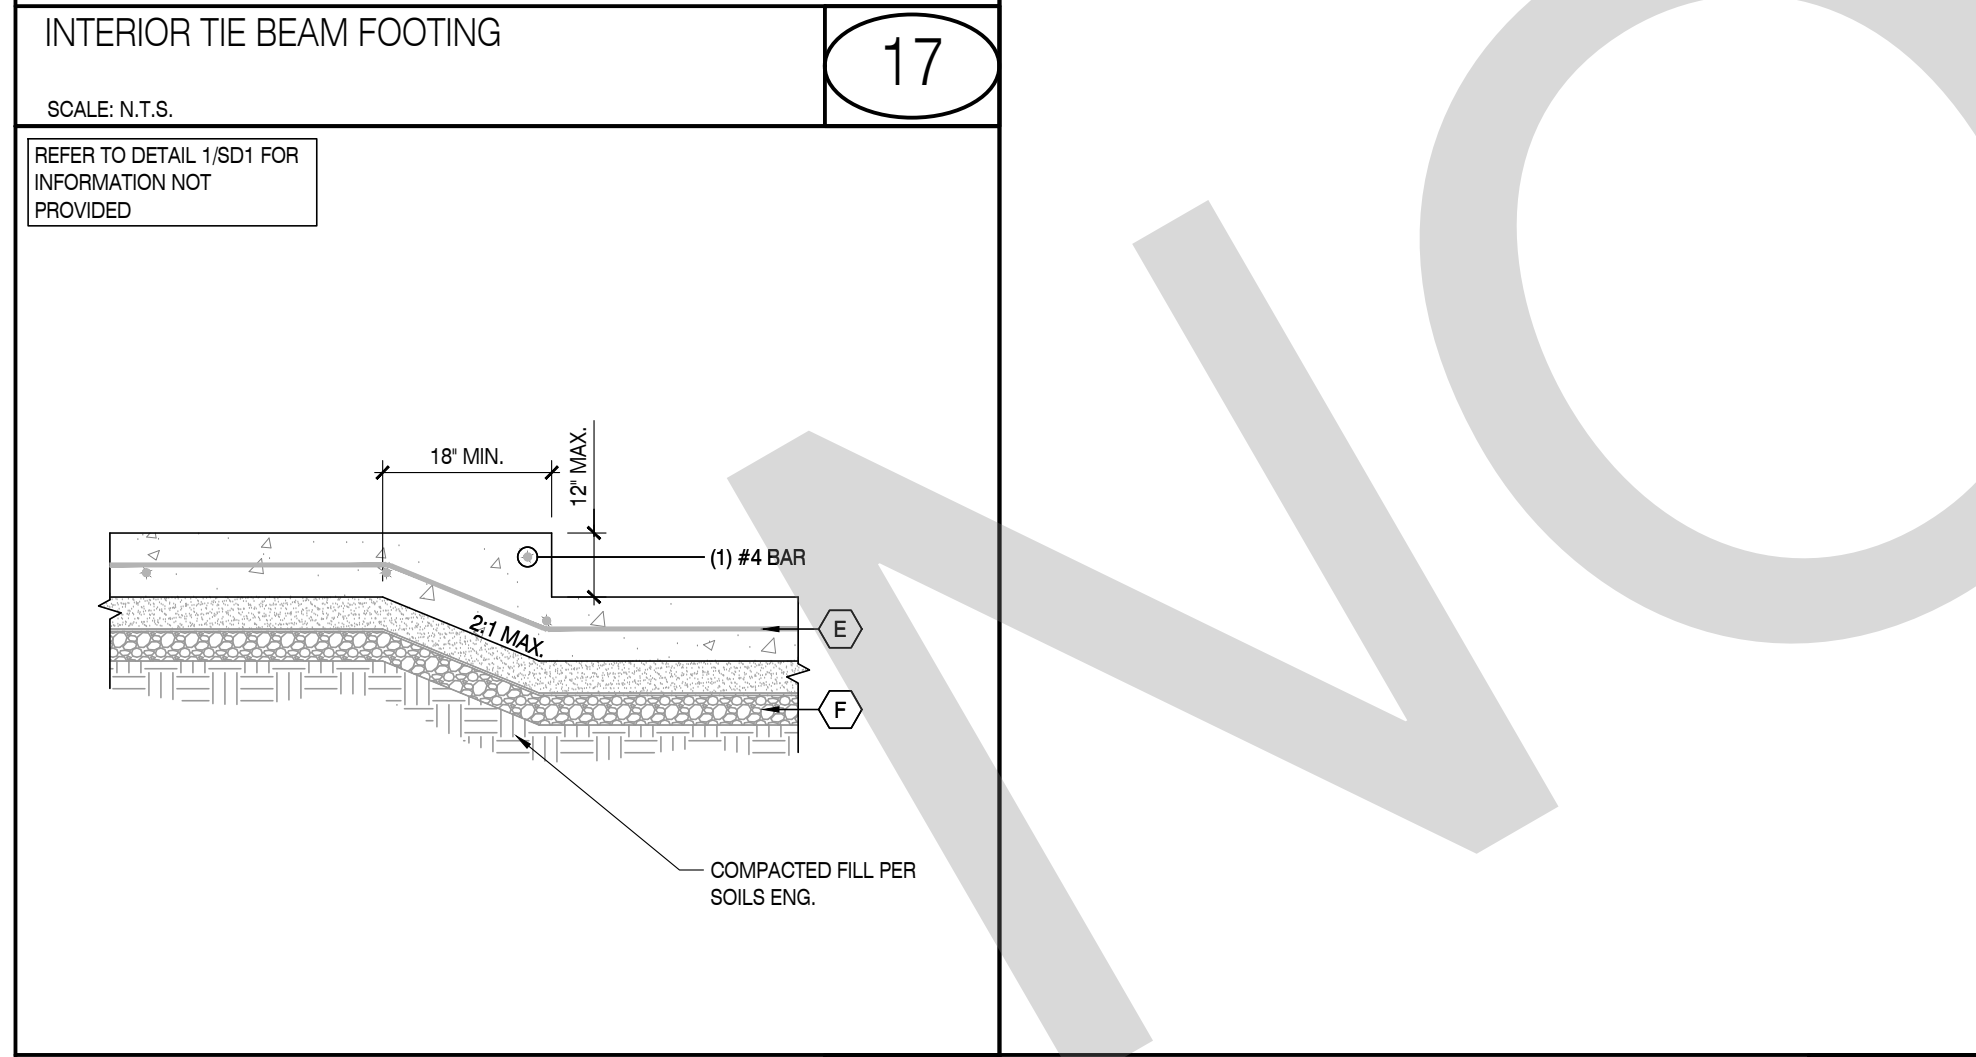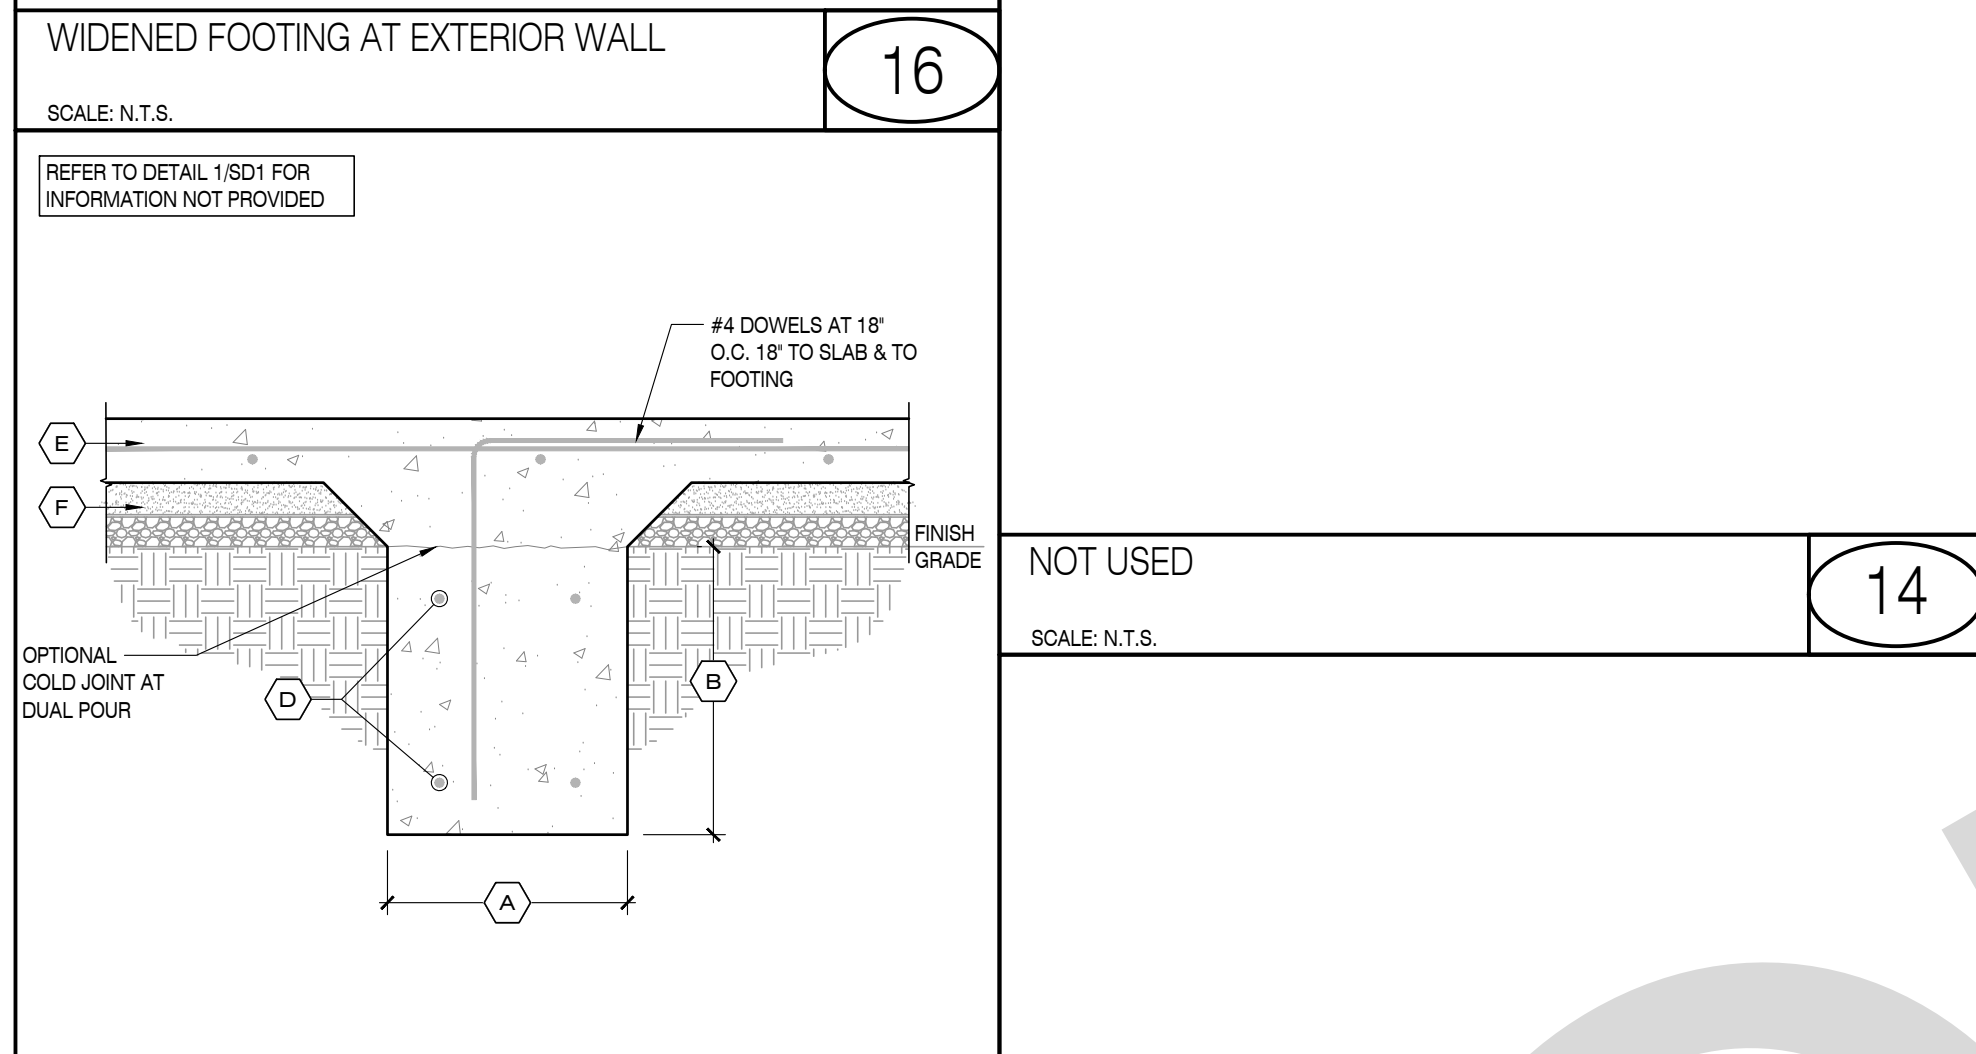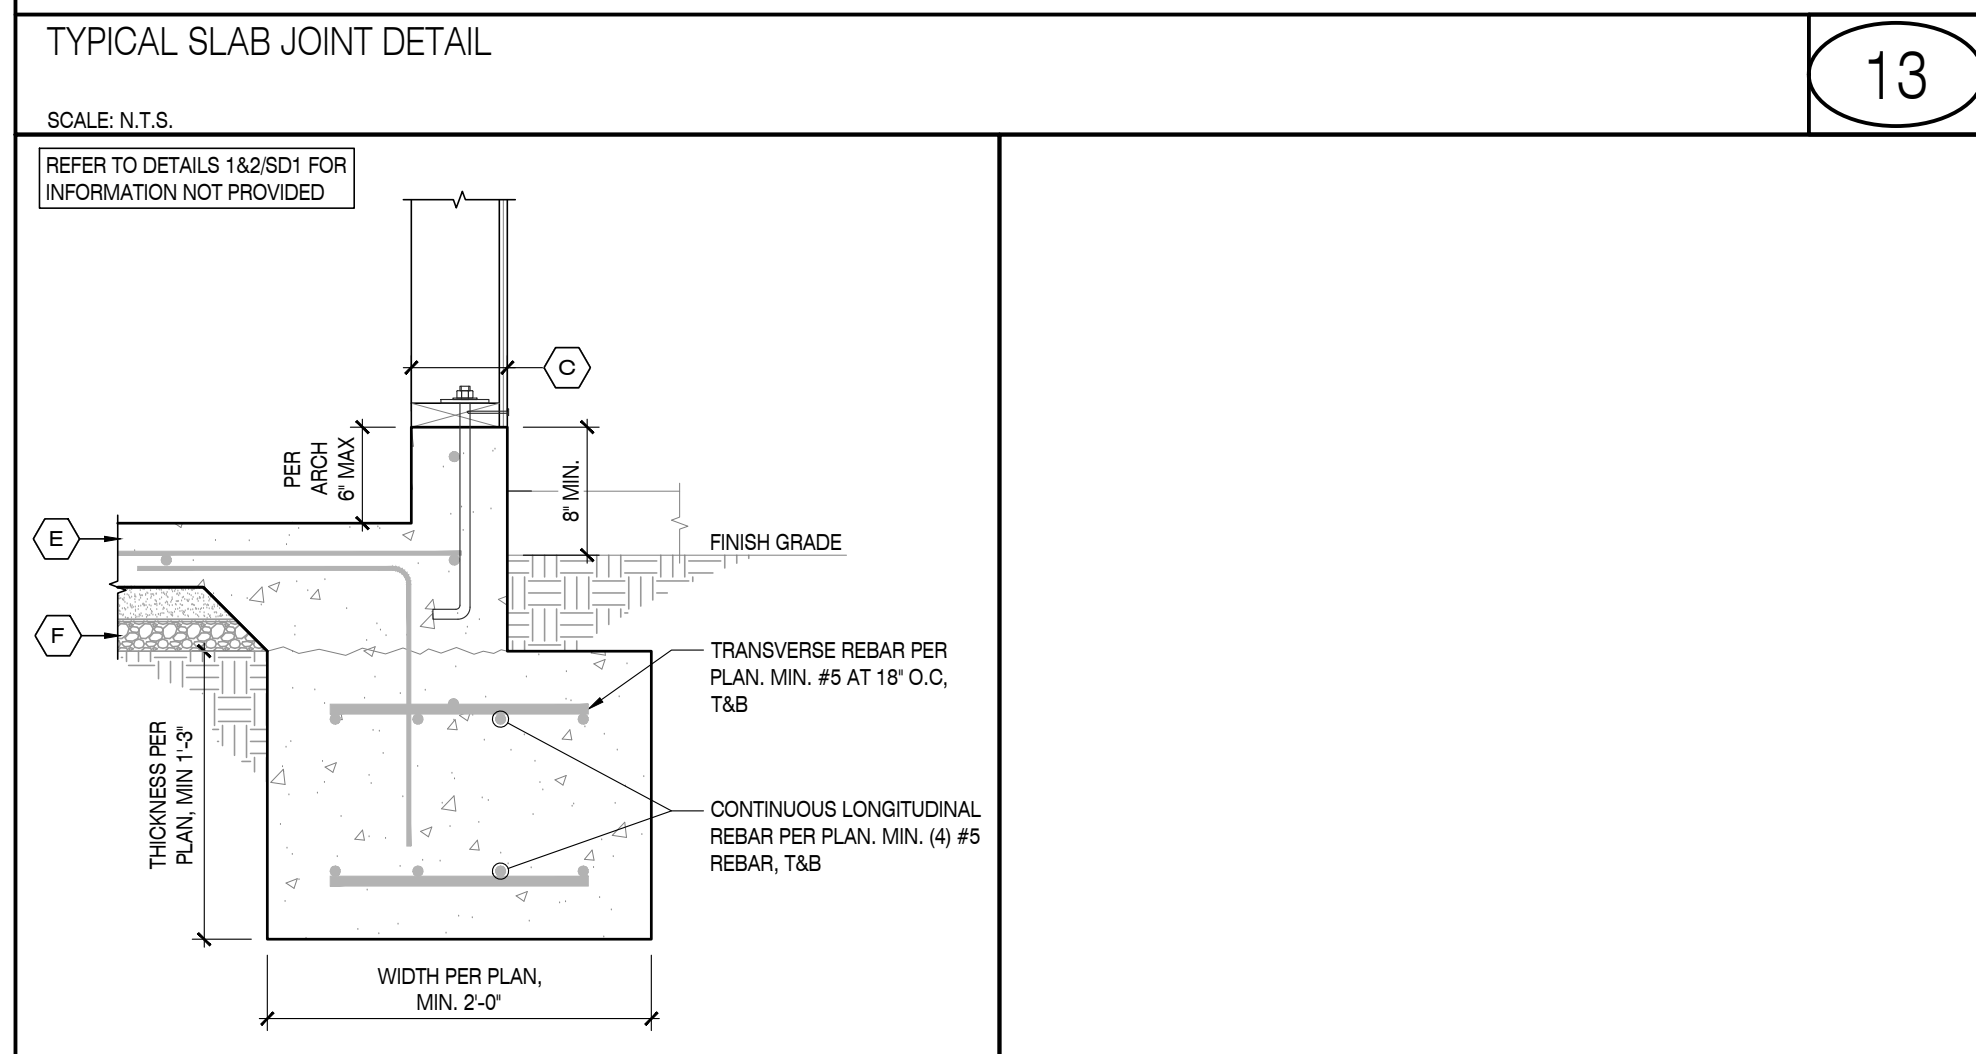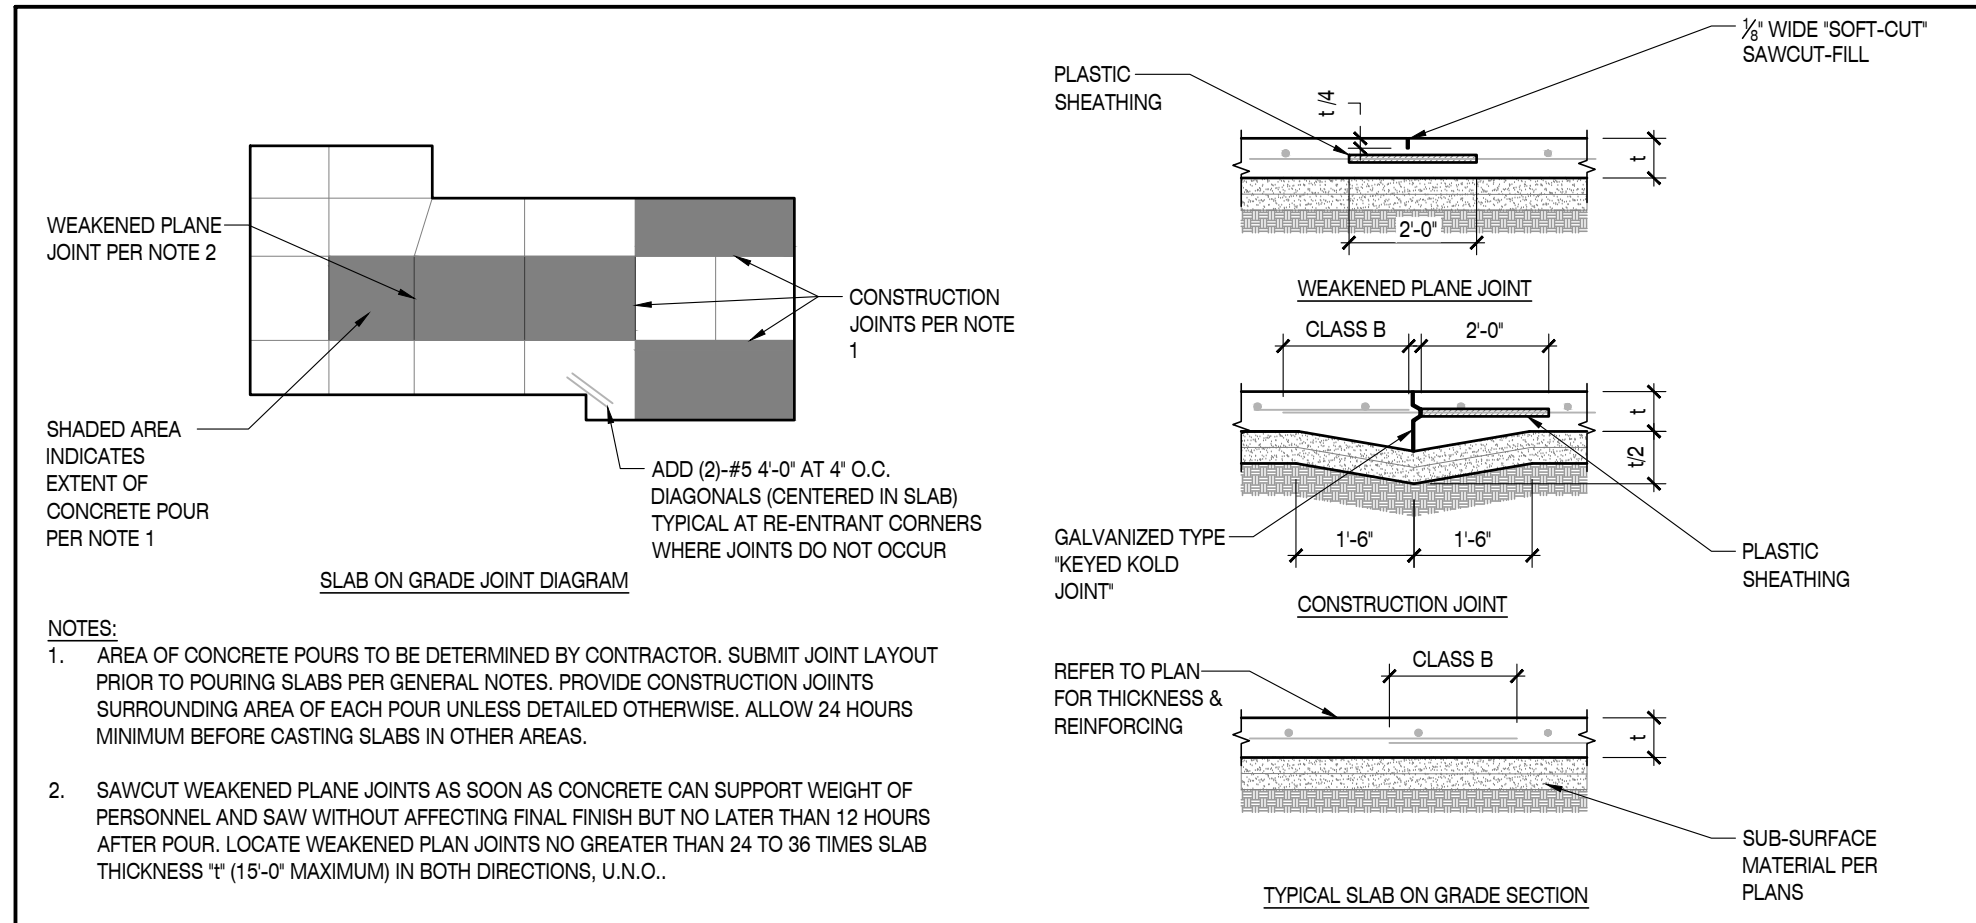

SLAB & FOOTING SPECIFICATIONS FOR LOW EXPANSIVE SOILS	
*LOW - PER GEOTECHNICAL ENGINEER	
LABEL	DESCRIPTION
(A)	1 STORY FOUND.
(B)	15' U.N.O. PER PLAN
(C)	12' BELOW LOWEST ADJACENT GRADE
(D)	4" (2x4 WALL PER PLAN)
(E)	6" (2x6 WALL PER PLAN)
(F)	2" THICK CLEAN SAND OVER 10 MIL VAPOR BARRIER OVER 2" THICK, CLEAN SAND BASE

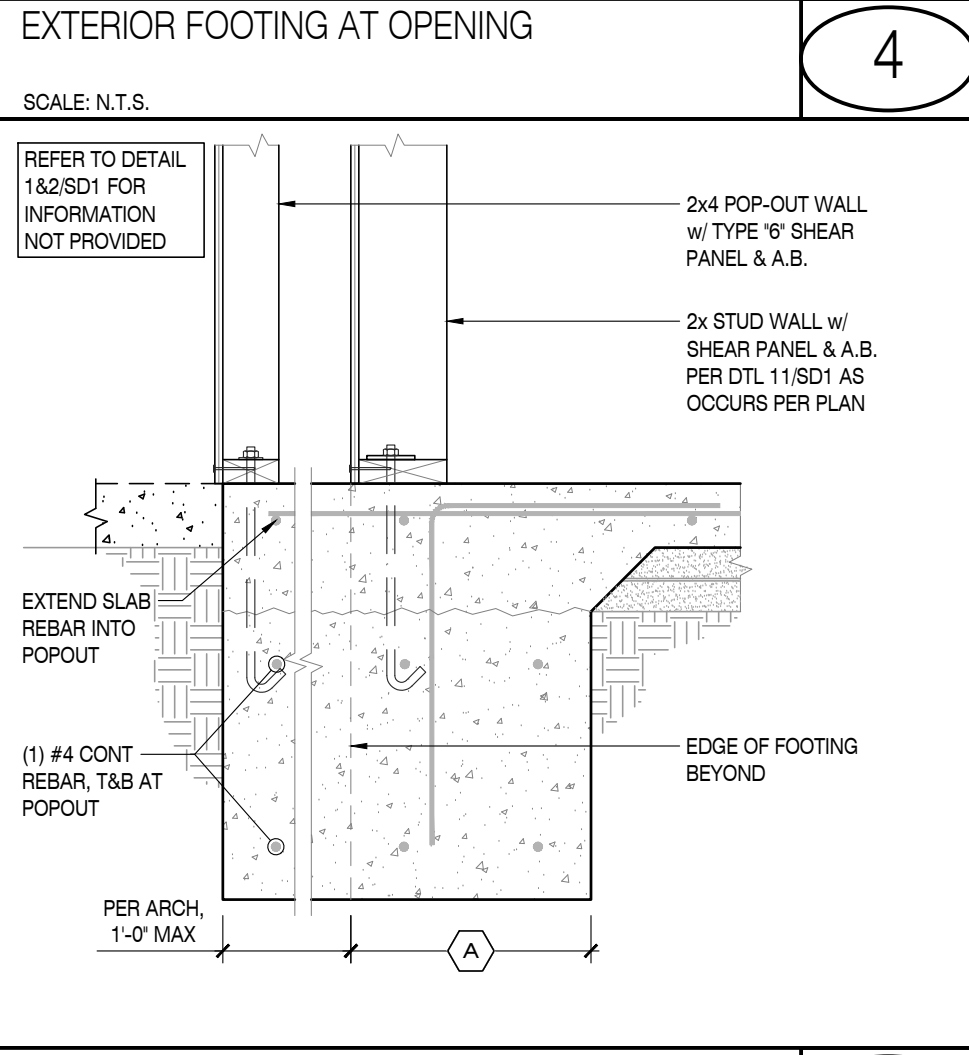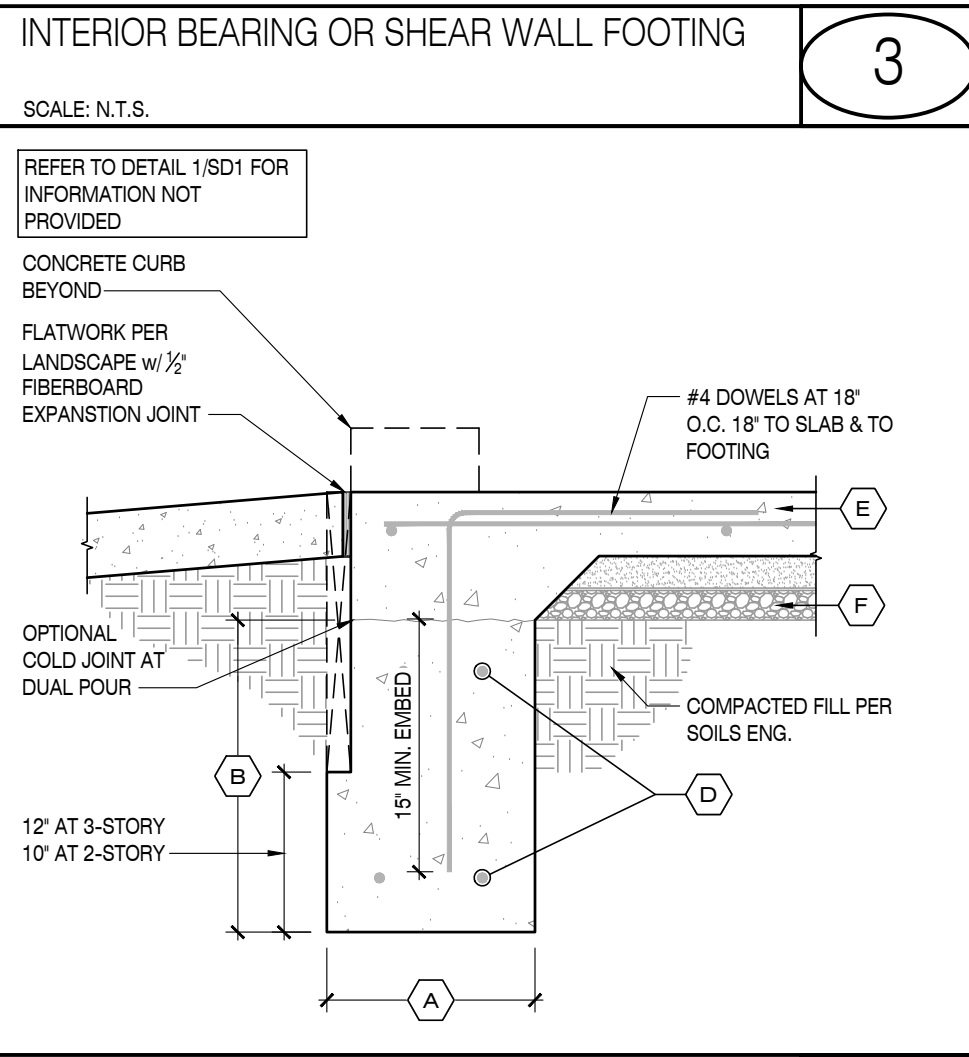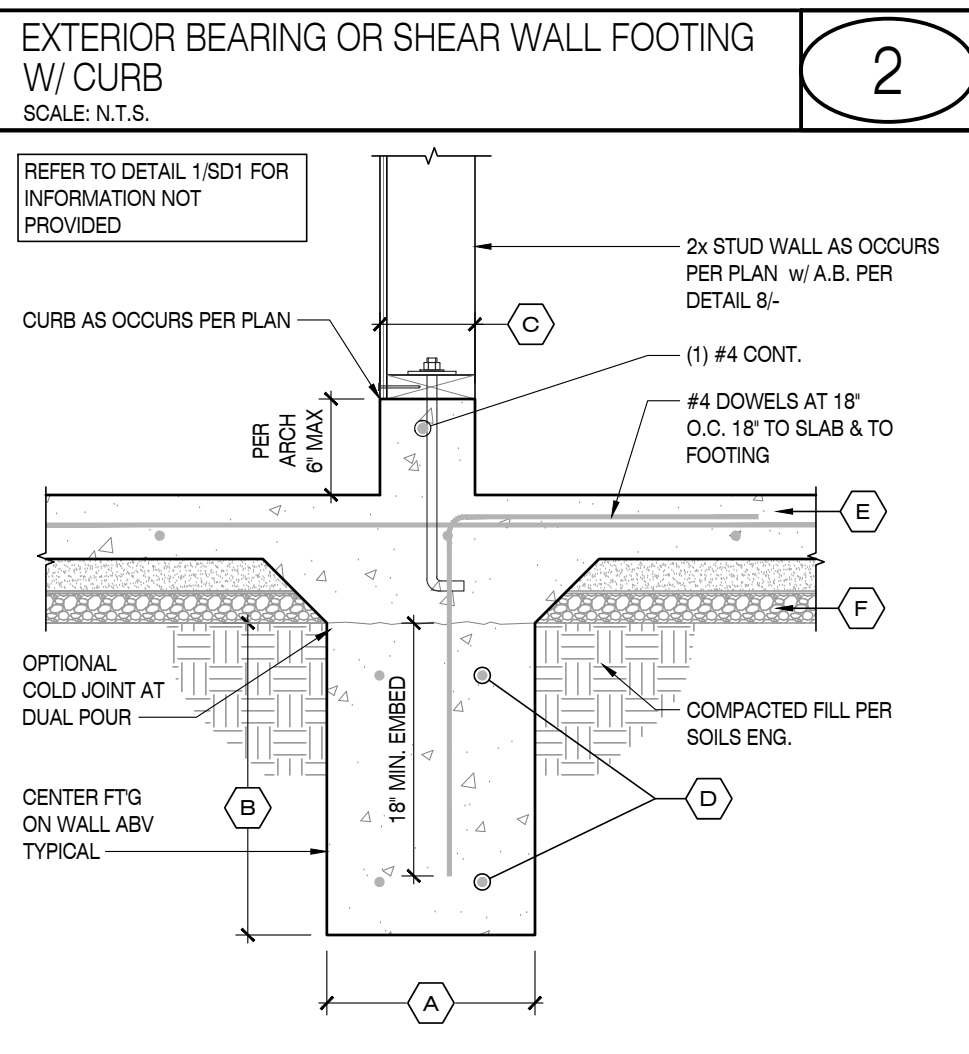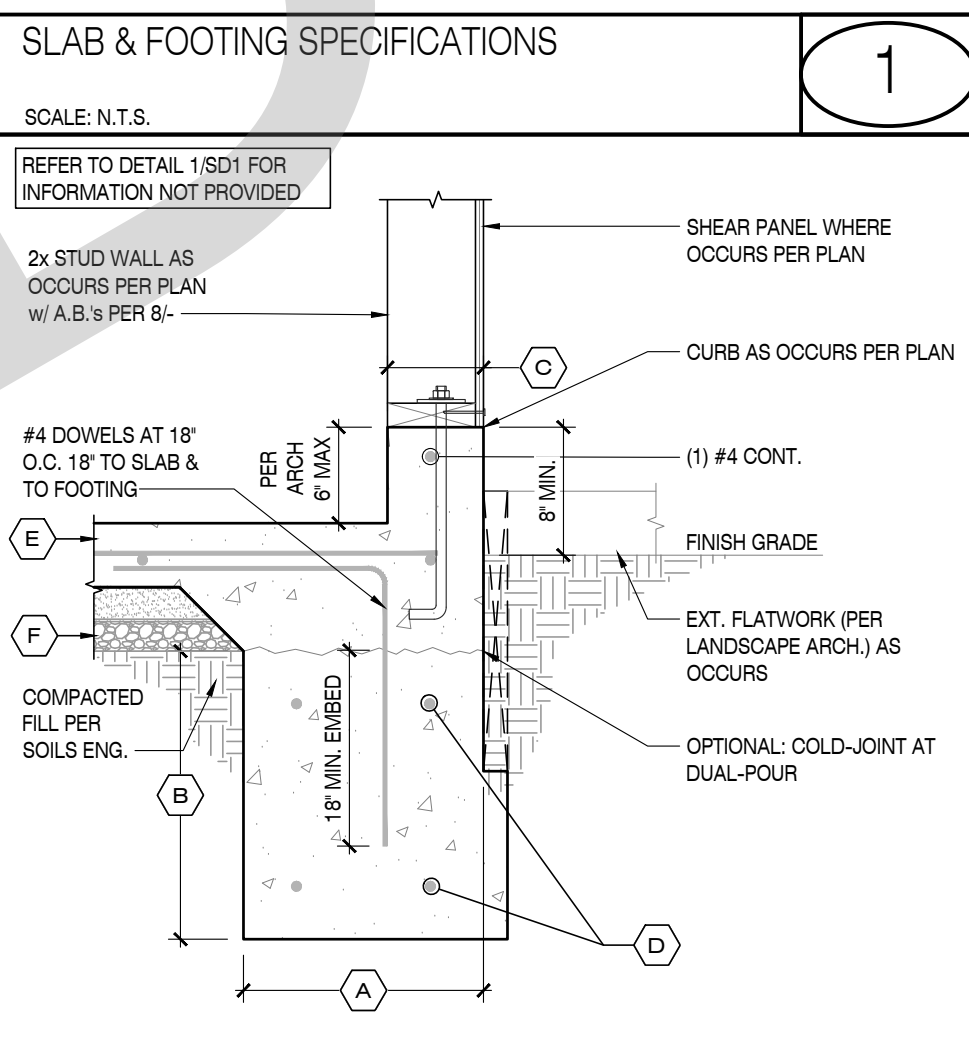

4095 DEVO DR. TEMECULA, CALIFORNIA 92590-3760
Phone: 951.266.8110 Fax: 951.266.6079 Email: stk@stke.com

CONSULTANT:

INNOVATIVE
STRUCTURAL ENGINEERING
27389 VIA INDUSTRIAL
TEMECULA, CA 92590
WWW.ISEENGINEERS.COM
SOCAL | NORCAL | COLORADO
ISE PROJECT NO.: 22-7067

PROJECT ADMINISTERED BY:
SAN BERNARDINO COUNTY
REAL ESTATE SERVICES
DEPARTMENT -
PROJECT MANAGEMENT
DIVISION

385 N. ARROWHEAD AVE.
SAN BERNARDINO, CA 92415

PROJECT NAME:
SAN BERNARDINO
COUNTY FIRE
DEPARTMENT:
FIRE STATION 226

PROJECT # 10.1032
CIP # _____
CAFM # _____

1920 DEL ROSA AVE N.
SAN BERNARDINO,
CA 92404

ISSUE INFORMATION:
DATE: 10-03-2022 INFORMATION: PLAN CHECK

SHEET INFORMATION:
STK PROJECT NO.: 374-154-21
SCALE: AS NOTED
DATE: SEPTEMBER 2022
PLOT DATE: 09-28-2022
DRAWING NAME:

SEAL:

SHEET TITLE:
FOUNDATION
DETAILS

SHEET NO.:
SD1



43095 DEVO DR., TEMECULA, CALIFORNIA 92590-3760
Phone: 951.296.8110 Fax: 951.296.6079 Email: sk@stkinc.com

CONSULTANT:



INNOVATIVE
STRUCTURAL ENGINEERING
27389 VIA INDUSTRIAL
TEMECULA, CA 92590
TEL: 951.296.8110
WWW.ISEENGINEERS.COM
SOCAL | NORCAL | COLORADO
ISE PROJECT NO.: 22-7067

PROJECT MANAGER:
SANDY FONG EXT. 1016
SANDY@ISEENGINEERS.COM

PROJECT ADMINISTERED BY:
SAN BERNARDINO COUNTY
REAL ESTATE SERVICES
DEPARTMENT -
PROJECT MANAGEMENT
DIVISION

385 N. ARROWHEAD AVE.
SAN BERNARDINO, CA 92415

PROJECT NAME:

SAN BERNARDINO
COUNTY FIRE
DEPARTMENT:
FIRE STATION 226

PROJECT # 10.10.1032

CIP # _____

CAFM # _____

1920 DEL ROSA AVE N.
SAN BERNARDINO,
CA 92404

ISSUE INFORMATION:

DATE:	INFORMATION:
10-03-2022	PLAN CHECK

SHEET INFORMATION:

STK PROJECT NO.:	374-154-21
SCALE:	AS NOTED
DATE:	SEPTEMBER 2022
PLOT DATE:	09-28-2022
DRAWING NAME:	

SEAL:




SHEET TITLE:

SITE & RETAINING
WALL DETAILS

SHEET NO.:

SD1.1

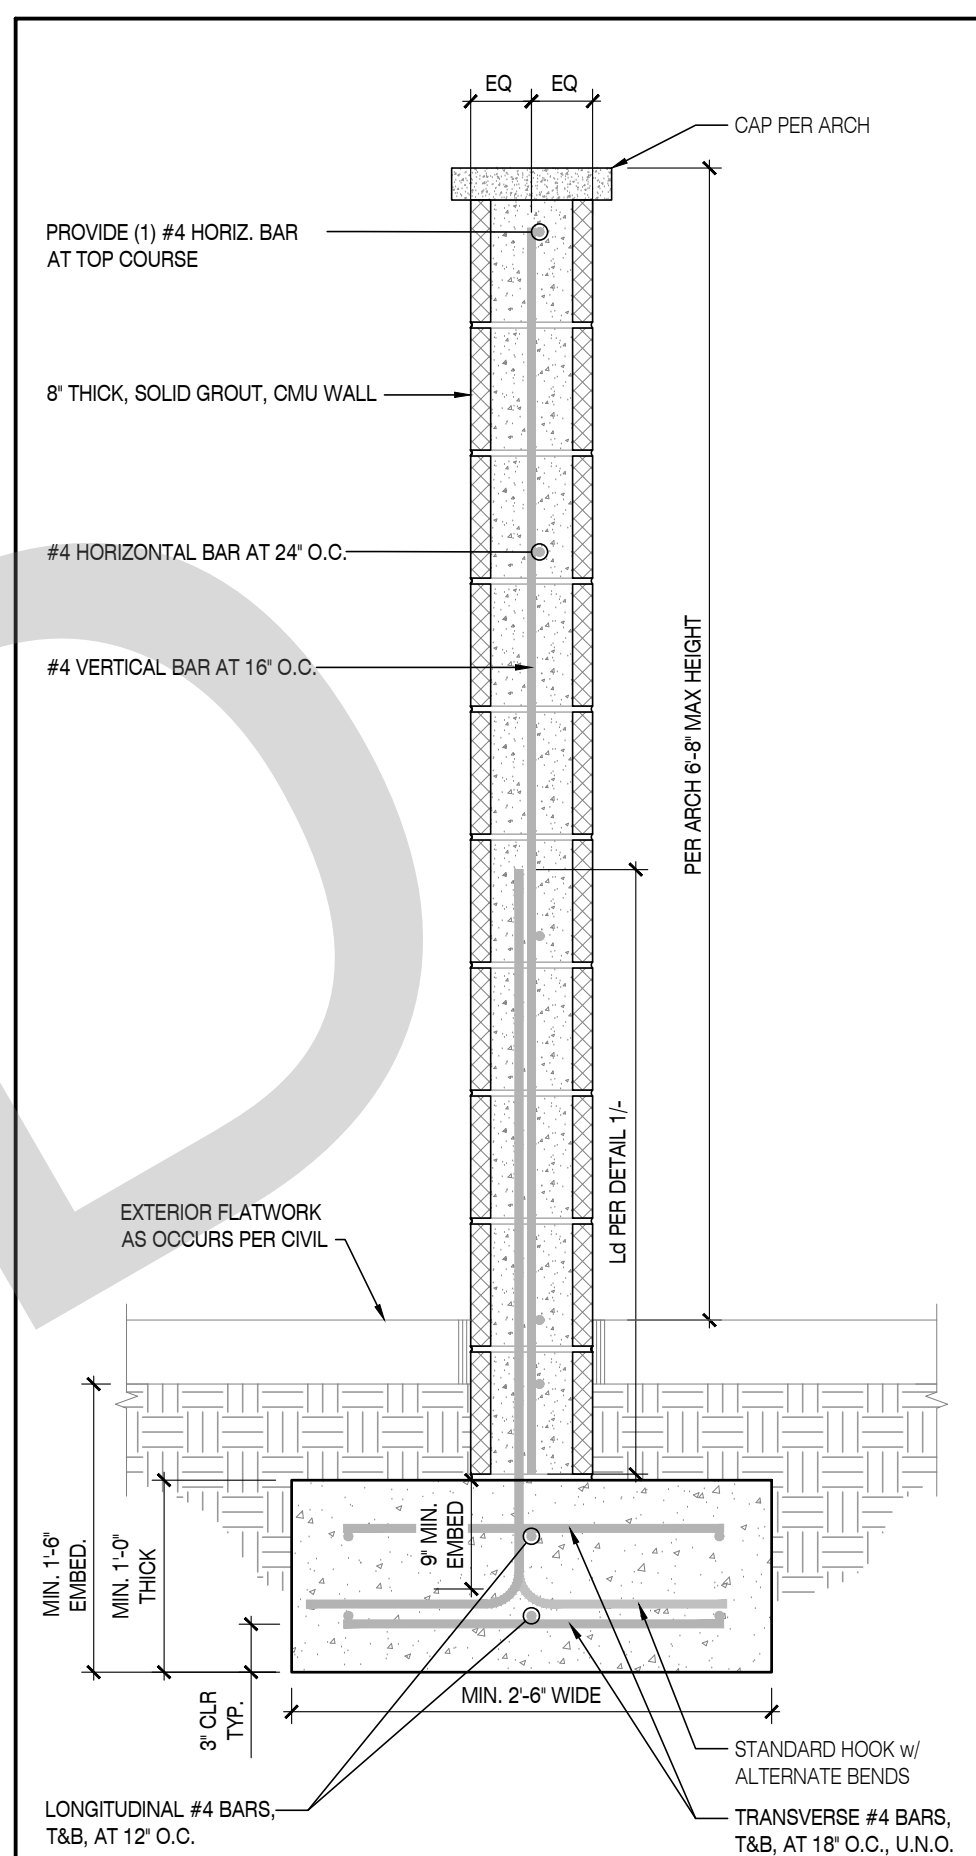

MECHANICAL ENCLOSURE CMU WALL & FOOTING

SCALE: N.T.S.

1

TABLE 1 - RETAINING WALL & FOOTING DIMENSIONS & REINFORCING																			
UPPER RETAINING WALL					LOWER RETAINING WALL					CONT. CONC. WALL FOOTING									
RET. WALL HEIGHT H _{max}	RET. SOIL HEIGHT H _{min}	WALL DEPTH D _{max}	WALL HEIGHT H _{min}	WALL REBAR F _{max}	WALL DEPTH D _{min}	WALL HEIGHT H _{min}	WALL REBAR F _{min}	FOOTING DIMENSIONS	FOOTING REBAR	FOOTING KEY DIMS.	KEY KEY	KEY KEY	KEY KEY	KEY KEY	KEY KEY	KEY KEY	KEY KEY	KEY KEY	KEY KEY
VERT. HORIZ.	VERT. HORIZ.	VERT. HORIZ.	VERT. HORIZ.	VERT. HORIZ.	VERT. HORIZ.	VERT. HORIZ.	VERT. HORIZ.	FOOTING DIMENSIONS	FOOTING REBAR	FOOTING KEY DIMS.	KEY KEY	KEY KEY	KEY KEY	KEY KEY	KEY KEY	KEY KEY	KEY KEY	KEY KEY	KEY KEY
13'-0"	4'-6"	8'	13'-0"	#6 AT 18"	12'	4'-6"	#6 AT 18"	13'-0"	4'-6"	8'	13'-0"	#6 AT 18"	12'	4'-6"	#6 AT 18"	13'-0"	4'-6"	8'	13'-0"
13'-0"	4'-6"	8'	13'-0"	#6 AT 18"	12'	4'-6"	#6 AT 18"	13'-0"	4'-6"	8'	13'-0"	#6 AT 18"	12'	4'-6"	#6 AT 18"	13'-0"	4'-6"	8'	13'-0"

* NOTE: WHERE LOWER RETAINING WALL INFORMATION IS NOT PROVIDED, USE UPPER RETAINING WALL INFORMATION FOR THE ENTIRE WALL HEIGHT.


** NOTE: WHERE KEY INFORMATION IS NOT PROVIDED, A SHEAR KEY IS NOT REQUIRED AT THE CONT. WALL FOOTING.

RETAINING WALL DESIGN CRITERIA:
ACTIVE EARTH PRESSURE = 40 PSF/FT (E.F.P. PER SOLS REPORT)

SEISMIC EARTH PRESSURE = 30 PSF/FT (INV. TRIANGULAR DISTRIB.)
PER SOL REPORT ADDENDUM LATERAL EARTH PRESSURE, ISSUED JUNE 28, 2022, BY INLAND FOUNDATION ENGINEERING, INC.

SEISMIC WALL WEIGHT:
Cs = 0.457, (SPECIAL REINFORCED MASONRY SHEAR WALL)
Vs = 38.4 PSF (8" THICK, SOLID GROUT WALL)
Vh = 60.8 PSF (12" THICK, SOLID GROUT WALL)

WIND PRESSURE:
Pw = 31.7 PSF (FREE-STANDING WALL, H = 6'-0")
Pw = 11.8 PSF (OTHER STRUCTURES, OPEN LATTICE, H=2'-0")
Pw = 23.1 PSF
AVERAGE WIND PRESSURE ON CMU WALL AND ANTI-CLIMB FENCE

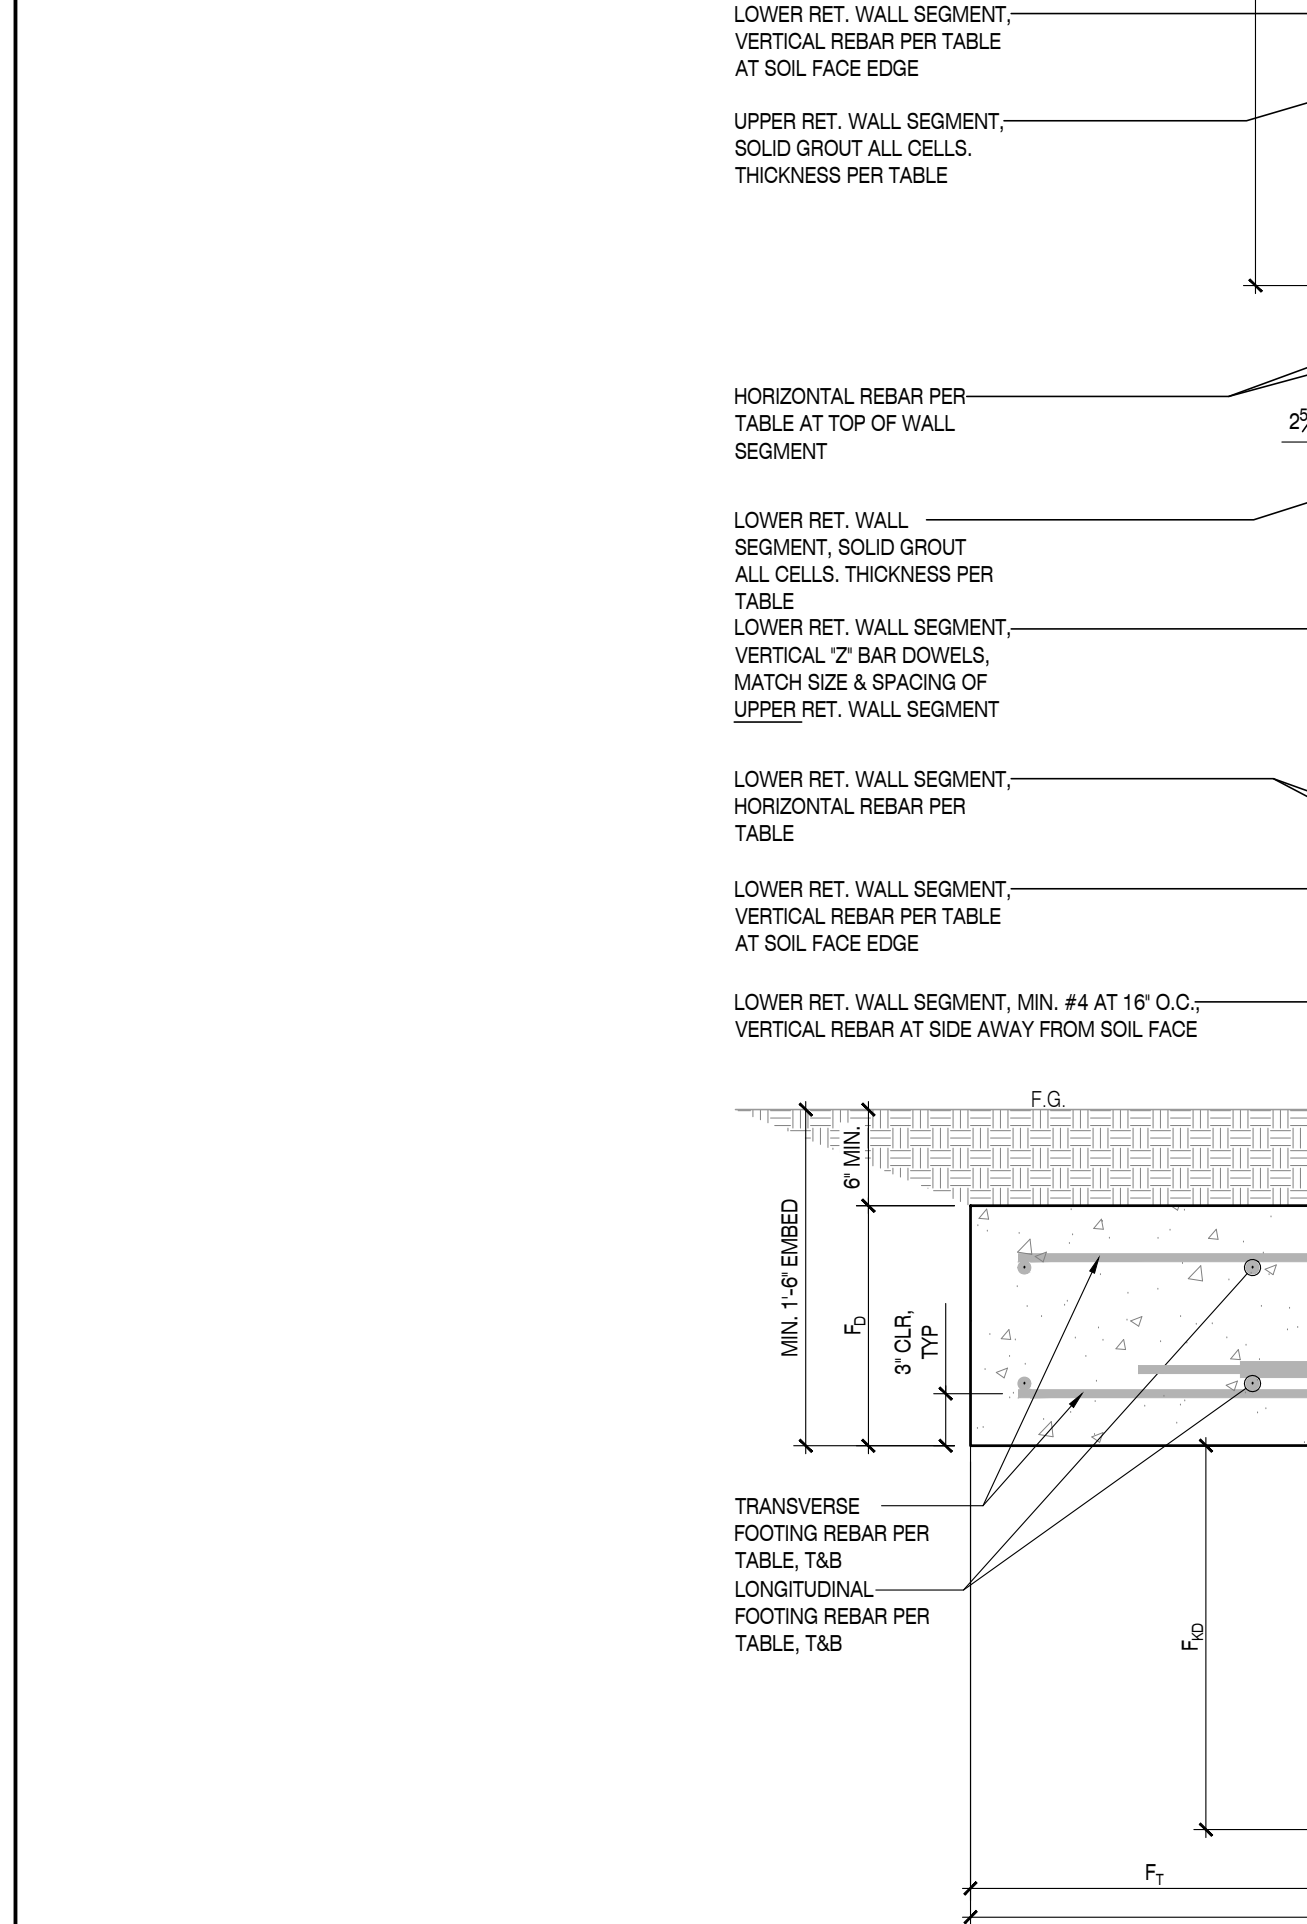

SITE RETAINING WALL PER DETAIL 1/A1.4, TYPICAL

SCALE: N.T.S.

TABLE 1 - RETAINING WALL & FOOTING DIMENSIONS & REINFORCING																			
UPPER RETAINING WALL					LOWER RETAINING WALL					CONT. CONC. WALL FOOTING									
RET. WALL HEIGHT H _{max}	RET. SOIL HEIGHT H _{min}	WALL DEPTH D _{max}	WALL HEIGHT H _{min}	WALL REBAR F _{max}	WALL DEPTH D _{min}	WALL HEIGHT H _{min}	WALL REBAR F _{min}	FOOTING DIMENSIONS	FOOTING REBAR	FOOTING KEY DIMS.	KEY KEY	KEY KEY	KEY KEY	KEY KEY	KEY KEY	KEY KEY	KEY KEY	KEY KEY	KEY KEY
VERT. HORIZ.	VERT. HORIZ.	VERT. HORIZ.	VERT. HORIZ.	VERT. HORIZ.	VERT. HORIZ.	VERT. HORIZ.	VERT. HORIZ.	FOOTING DIMENSIONS	FOOTING REBAR	FOOTING KEY DIMS.	KEY KEY	KEY KEY	KEY KEY	KEY KEY	KEY KEY	KEY KEY	KEY KEY	KEY KEY	KEY KEY
13'-0"	4'-6"	8'	13'-0"	#6 AT 18"	12'	4'-6"	#6 AT 18"	13'-0"	4'-6"	8'	13'-0"	#6 AT 18"	12'	4'-6"	#6 AT 18"	13'-0"	4'-6"	8'	13'-0"
13'-0"	4'-6"	8'	13'-0"	#6 AT 18"	12'	4'-6"	#6 AT 18"	13'-0"	4'-6"	8'	13'-0"	#6 AT 18"	12'	4'-6"	#6 AT 18"	13'-0"	4'-6"	8'	13'-0"

* NOTE: WHERE LOWER RETAINING WALL INFORMATION IS NOT PROVIDED, USE UPPER RETAINING WALL INFORMATION FOR THE ENTIRE WALL HEIGHT.


** NOTE: WHERE KEY INFORMATION IS NOT PROVIDED, A SHEAR KEY IS NOT REQUIRED AT THE CONT. WALL FOOTING.

RETAINING WALL DESIGN CRITERIA:
ACTIVE EARTH PRESSURE = 40 PSF/FT (E.F.P. PER SOLS REPORT)

SEISMIC EARTH PRESSURE = 30 PSF/FT (INV. TRIANGULAR DISTRIB.)
PER SOL REPORT ADDENDUM LATERAL EARTH PRESSURE, ISSUED JUNE 28, 2022, BY INLAND FOUNDATION ENGINEERING, INC.

SEISMIC WALL WEIGHT:
Cs = 0.457, (SPECIAL REINFORCED MASONRY SHEAR WALL)
Vs = 38.4 PSF (8" THICK, SOLID GROUT WALL)
Vh = 60.8 PSF (12" THICK, SOLID GROUT WALL)


WIND PRESSURE:
Pw = 31.7 PSF (FREE-STANDING WALL, H = 6'-0")
Pw = 11.8 PSF (OTHER STRUCTURES, OPEN LATTICE, H=2'-0")
Pw = 23.1 PSF
AVERAGE WIND PRESSURE ON CMU WALL AND ANTI-CLIMB FENCE

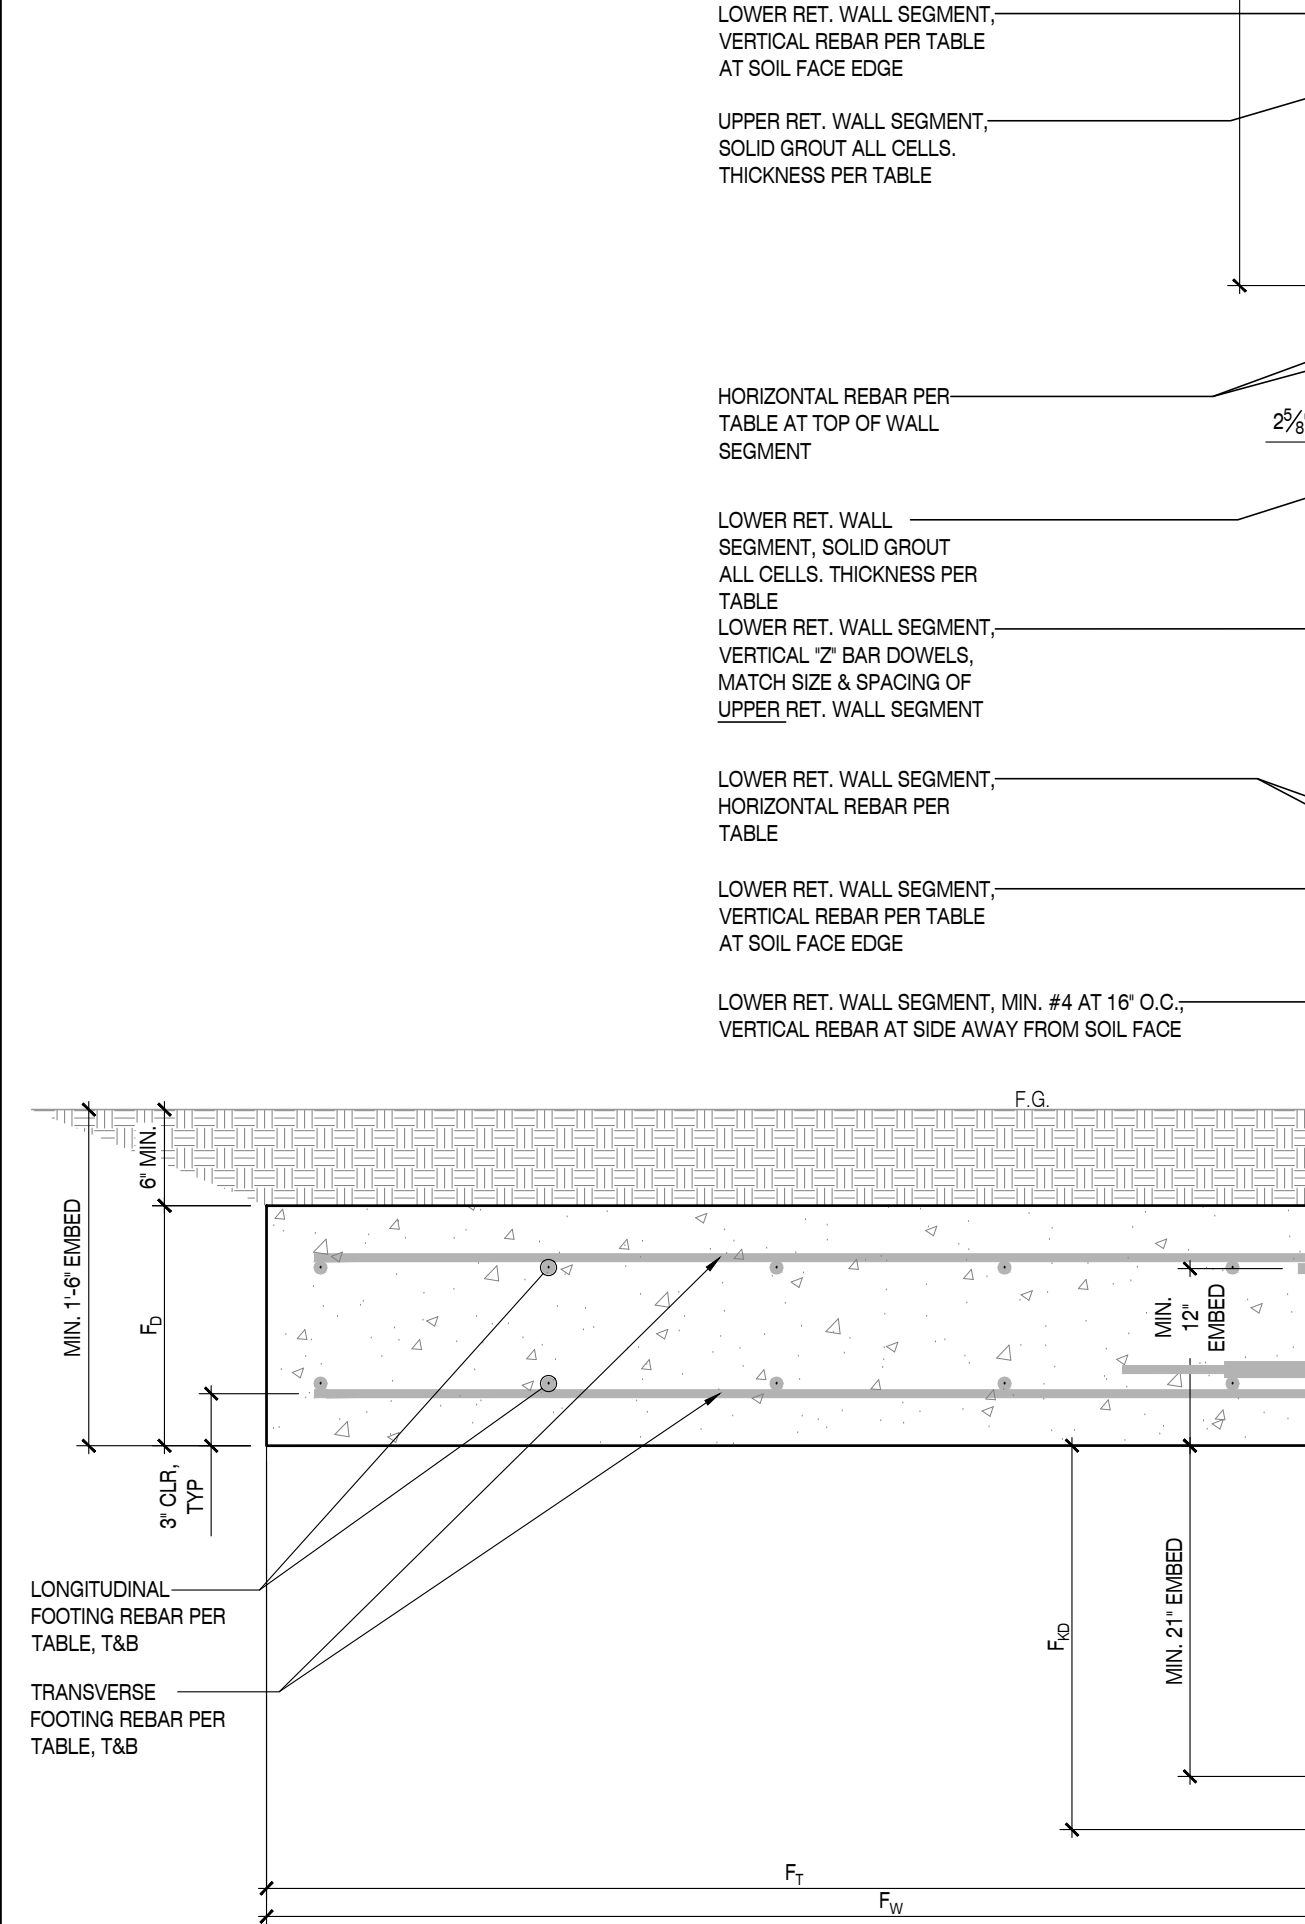

SITE RETAINING WALL PER DETAIL 1/A1.4, PROPERTY LINE CONDITION

SCALE: N.T.S.

2

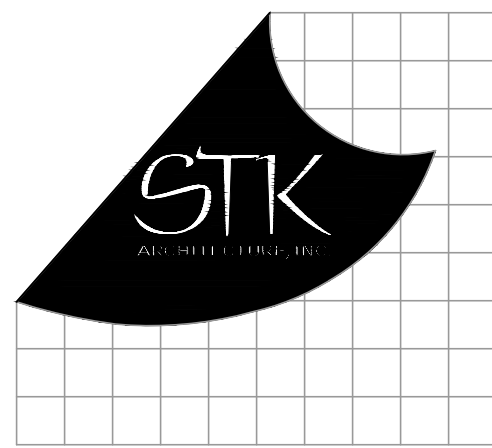

43095 DEVIS DR. TEMECULA, CALIFORNIA 92590-3760
Phone: 951.296.8110 Fax: 951.296.6079 Email: info@stk.com

CONSULTANT:



INNOVATIVE

STRUCTURAL ENGINEERING
27789 VIA INDUSTRIAL
TEMECULA, CA 92590
TEL: 951.490.0033
WWW.ISEENGINEERS.COM
SOCAL | NORCAL | COLORADO
ISE PROJECT NO.: 22-7067

PROJECT MANAGER:
SANDY FONG EXT. 1016
SANDY@ISEENGINEERS.COM

PROJECT ADMINISTERED BY:
SAN BERNARDINO COUNTY
REAL ESTATE SERVICES
DEPARTMENT -
PROJECT MANAGEMENT
DIVISION

385 N. ARROWHEAD AVE.
SAN BERNARDINO, CA 92415

PROJECT NAME:

SAN BERNARDINO
COUNTY FIRE
DEPARTMENT:
FIRE STATION 226

PROJECT # 10.1032

CIP # _____
CAF# # _____

1920 DEL ROSA AVE N.
SAN BERNARDINO,
CA 92404

ISSUE INFORMATION:

DATE:	INFORMATION:
10-03-2022	PLAN CHECK

SHEET INFORMATION:

STK PROJECT NO.:	374-154-21
SCALE:	AS NOTED
DATE:	SEPTEMBER 2022
PLOT DATE:	09-28-2022
DRAWING NAME:	

SEAL:





SHEET TITLE:

ROOF FRAMING
DETAILS


SHEET NO.:

SD3

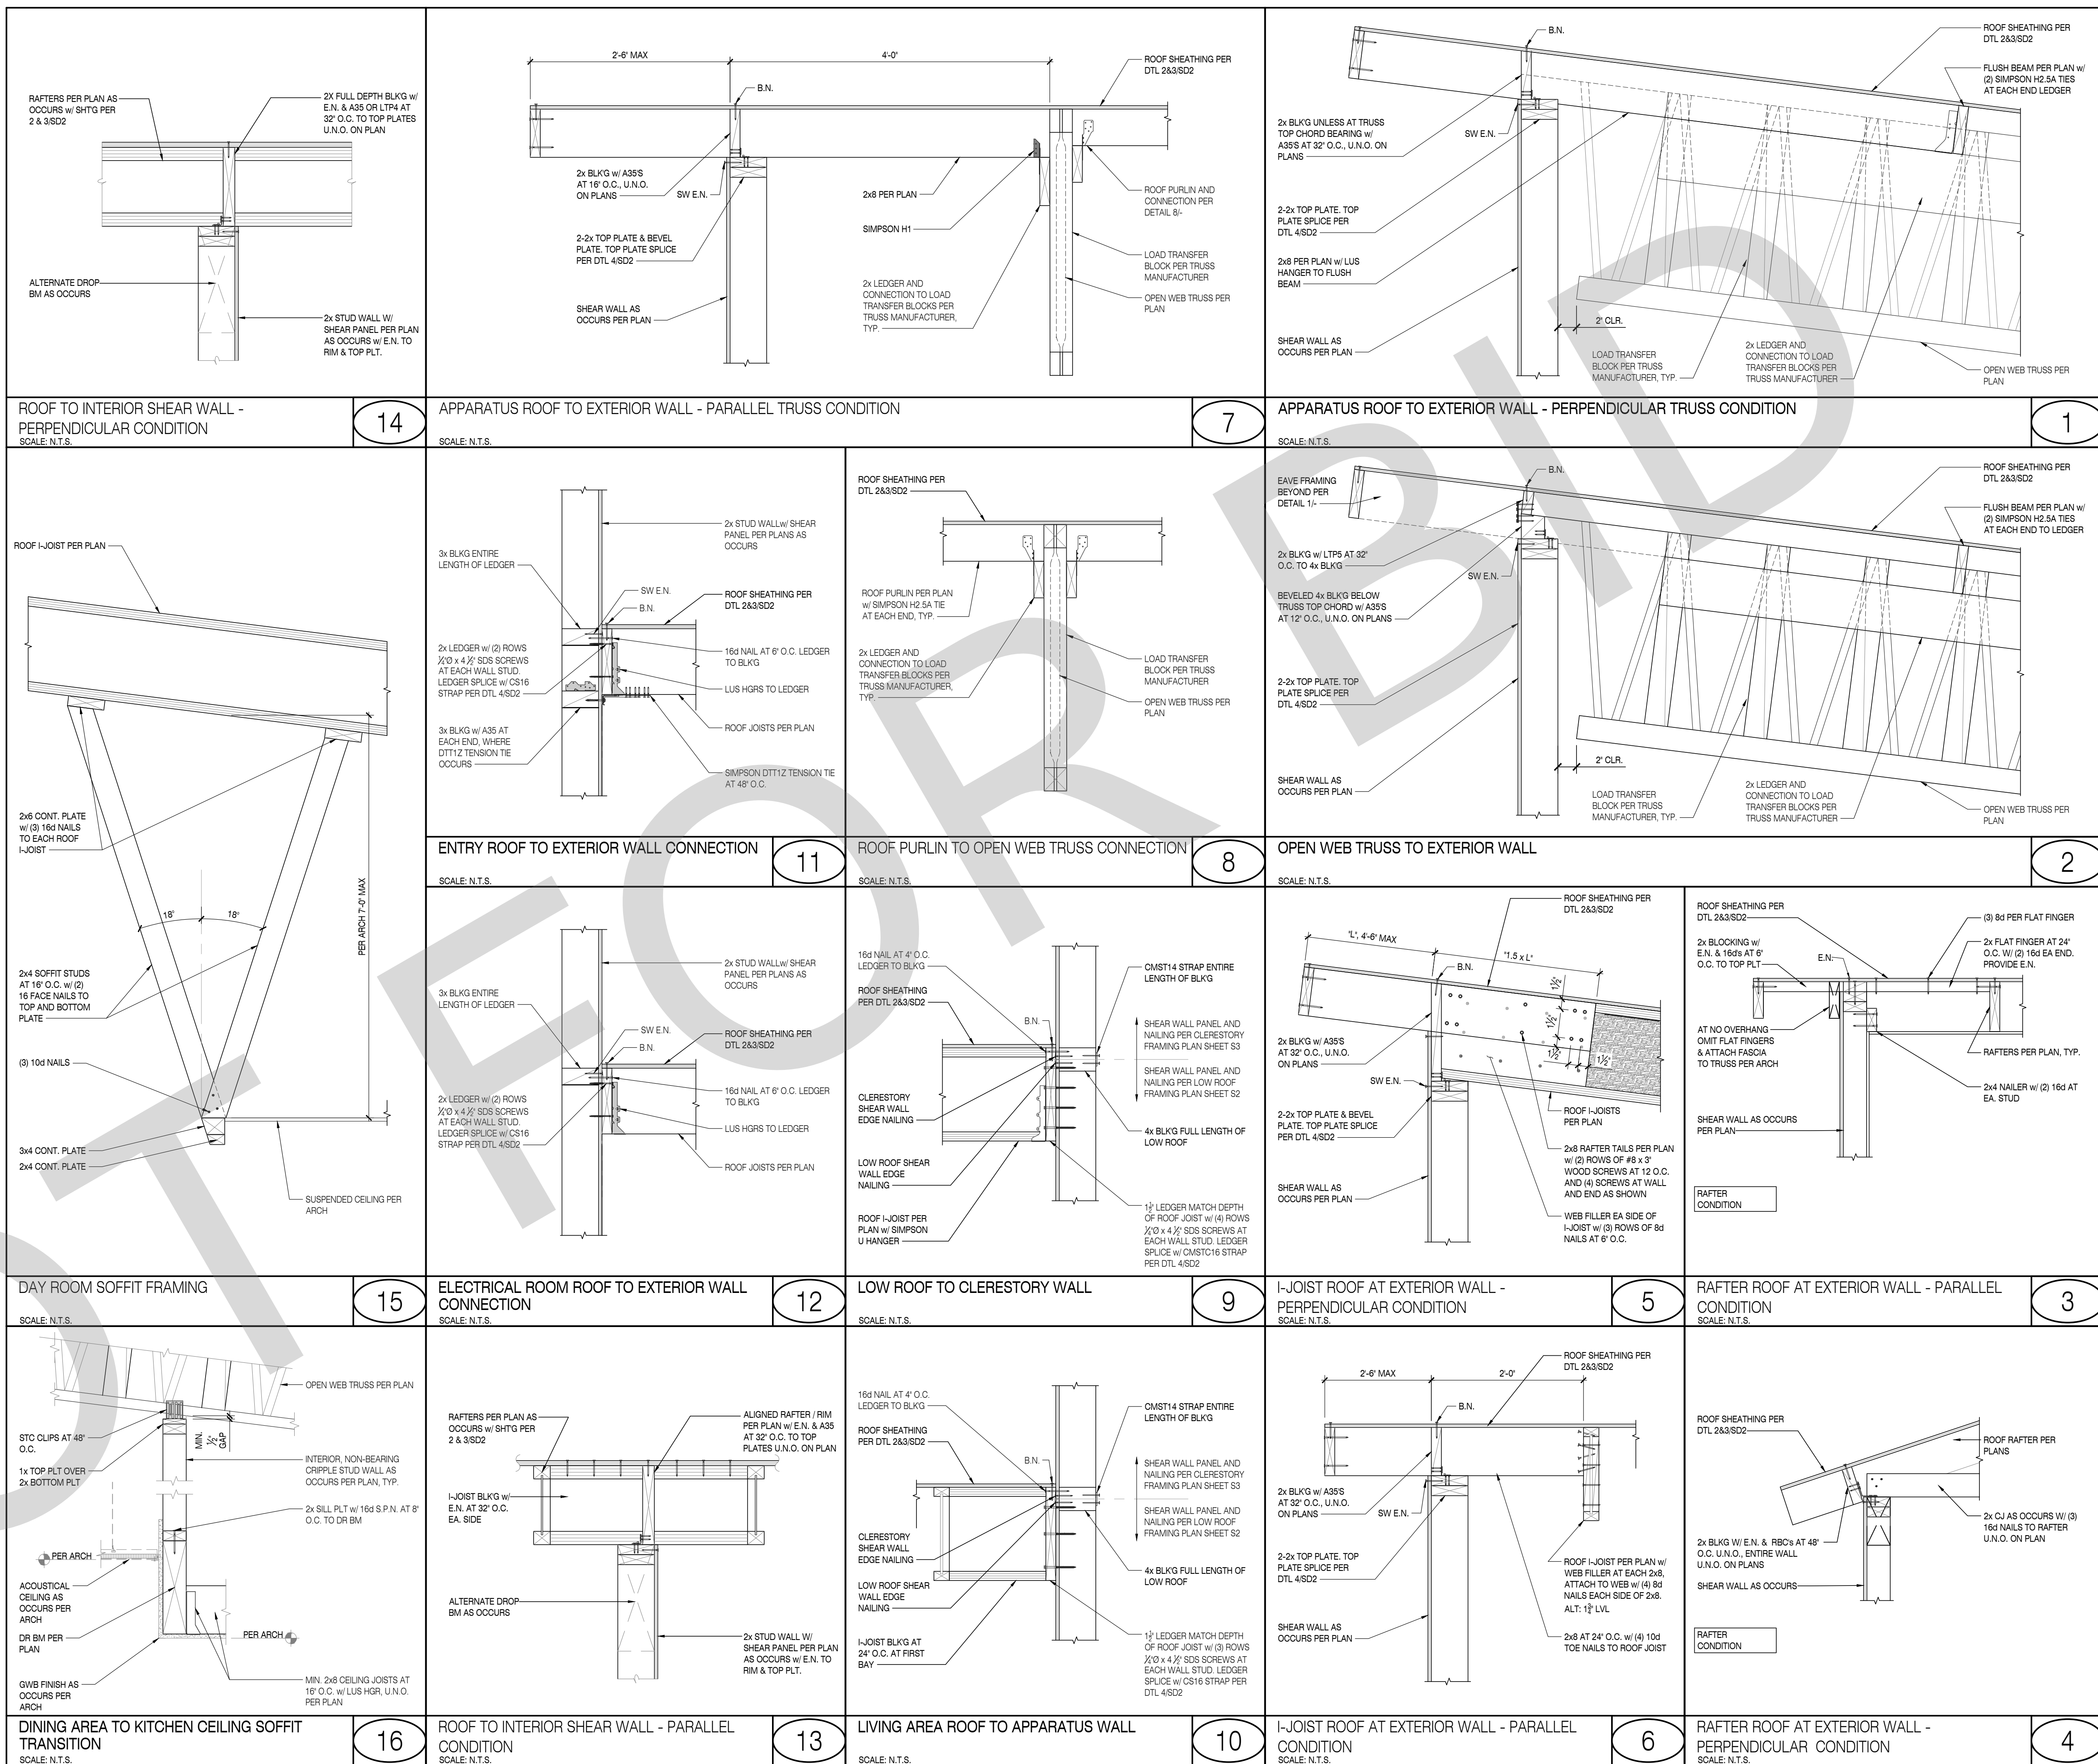


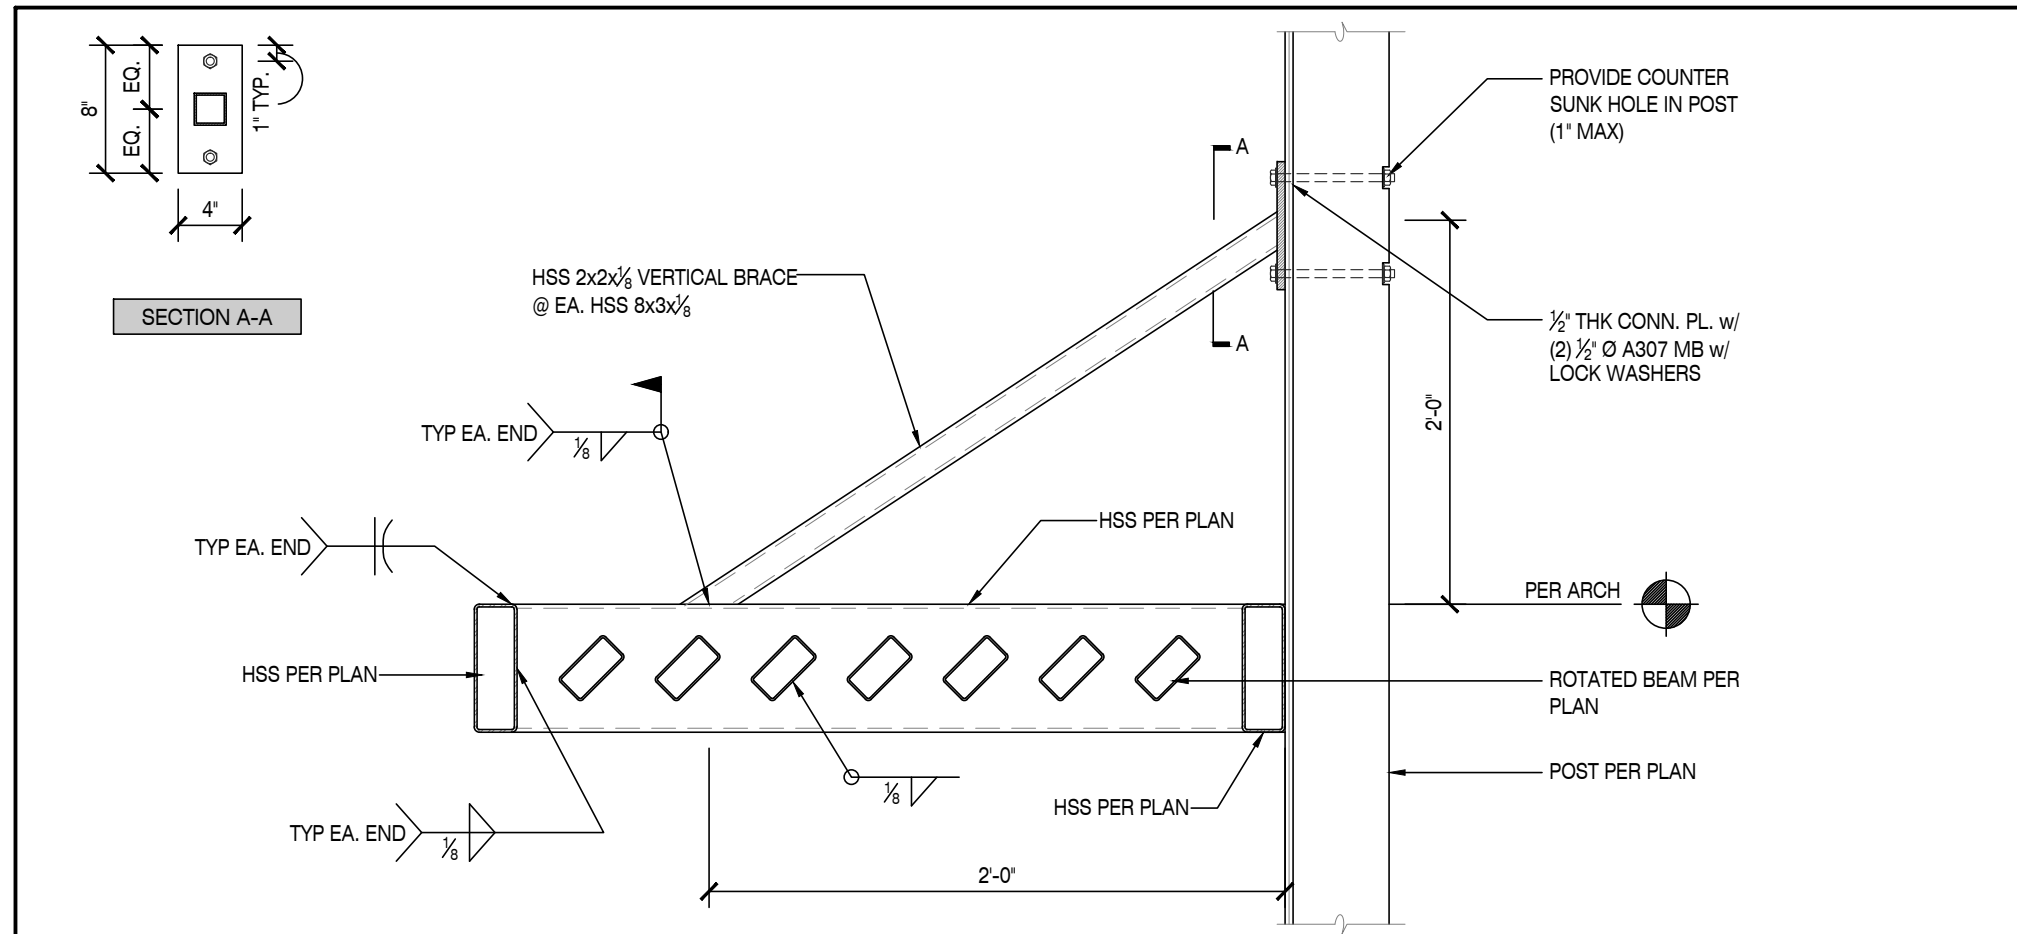


AWNING SECTION
SCALE: N.T.S.

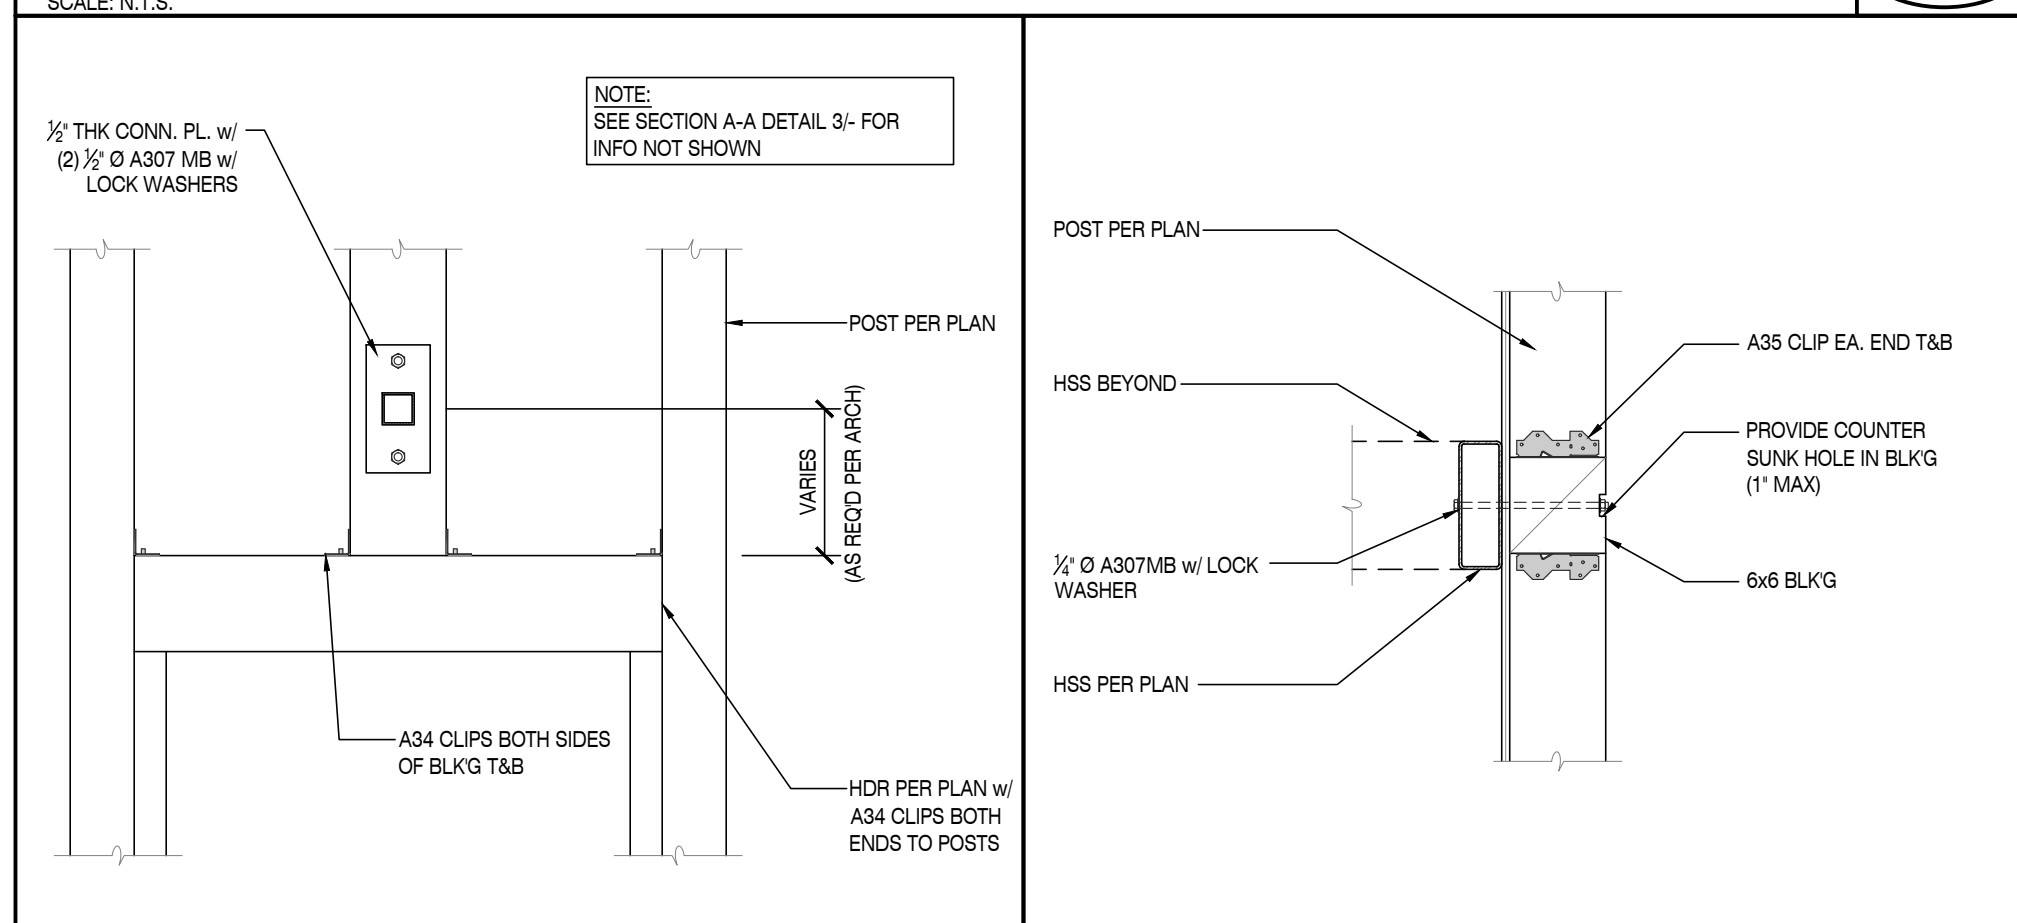


FRAMING AT AWNING BRACE CONNECTION
ABOVE WINDOW/DOOR HEADER
SCALE: N.T.S.

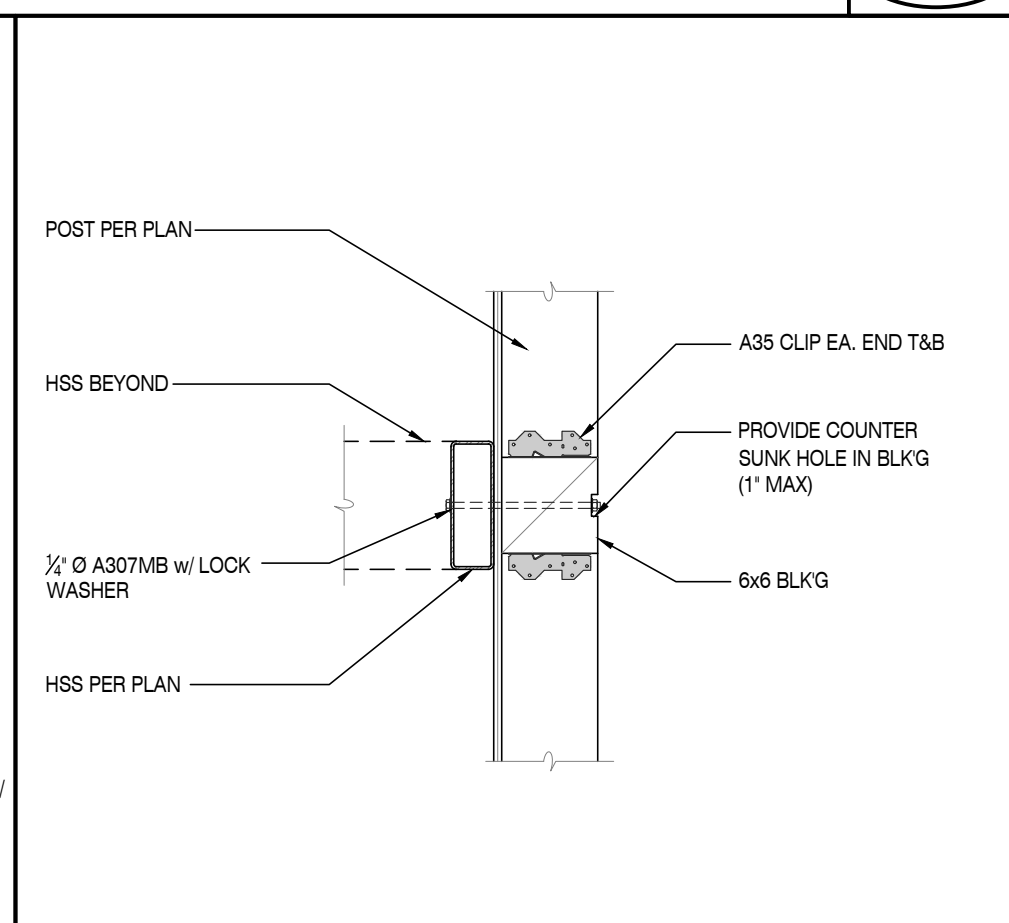


AWNING CONNECTION TO WALL
SCALE: N.T.S.

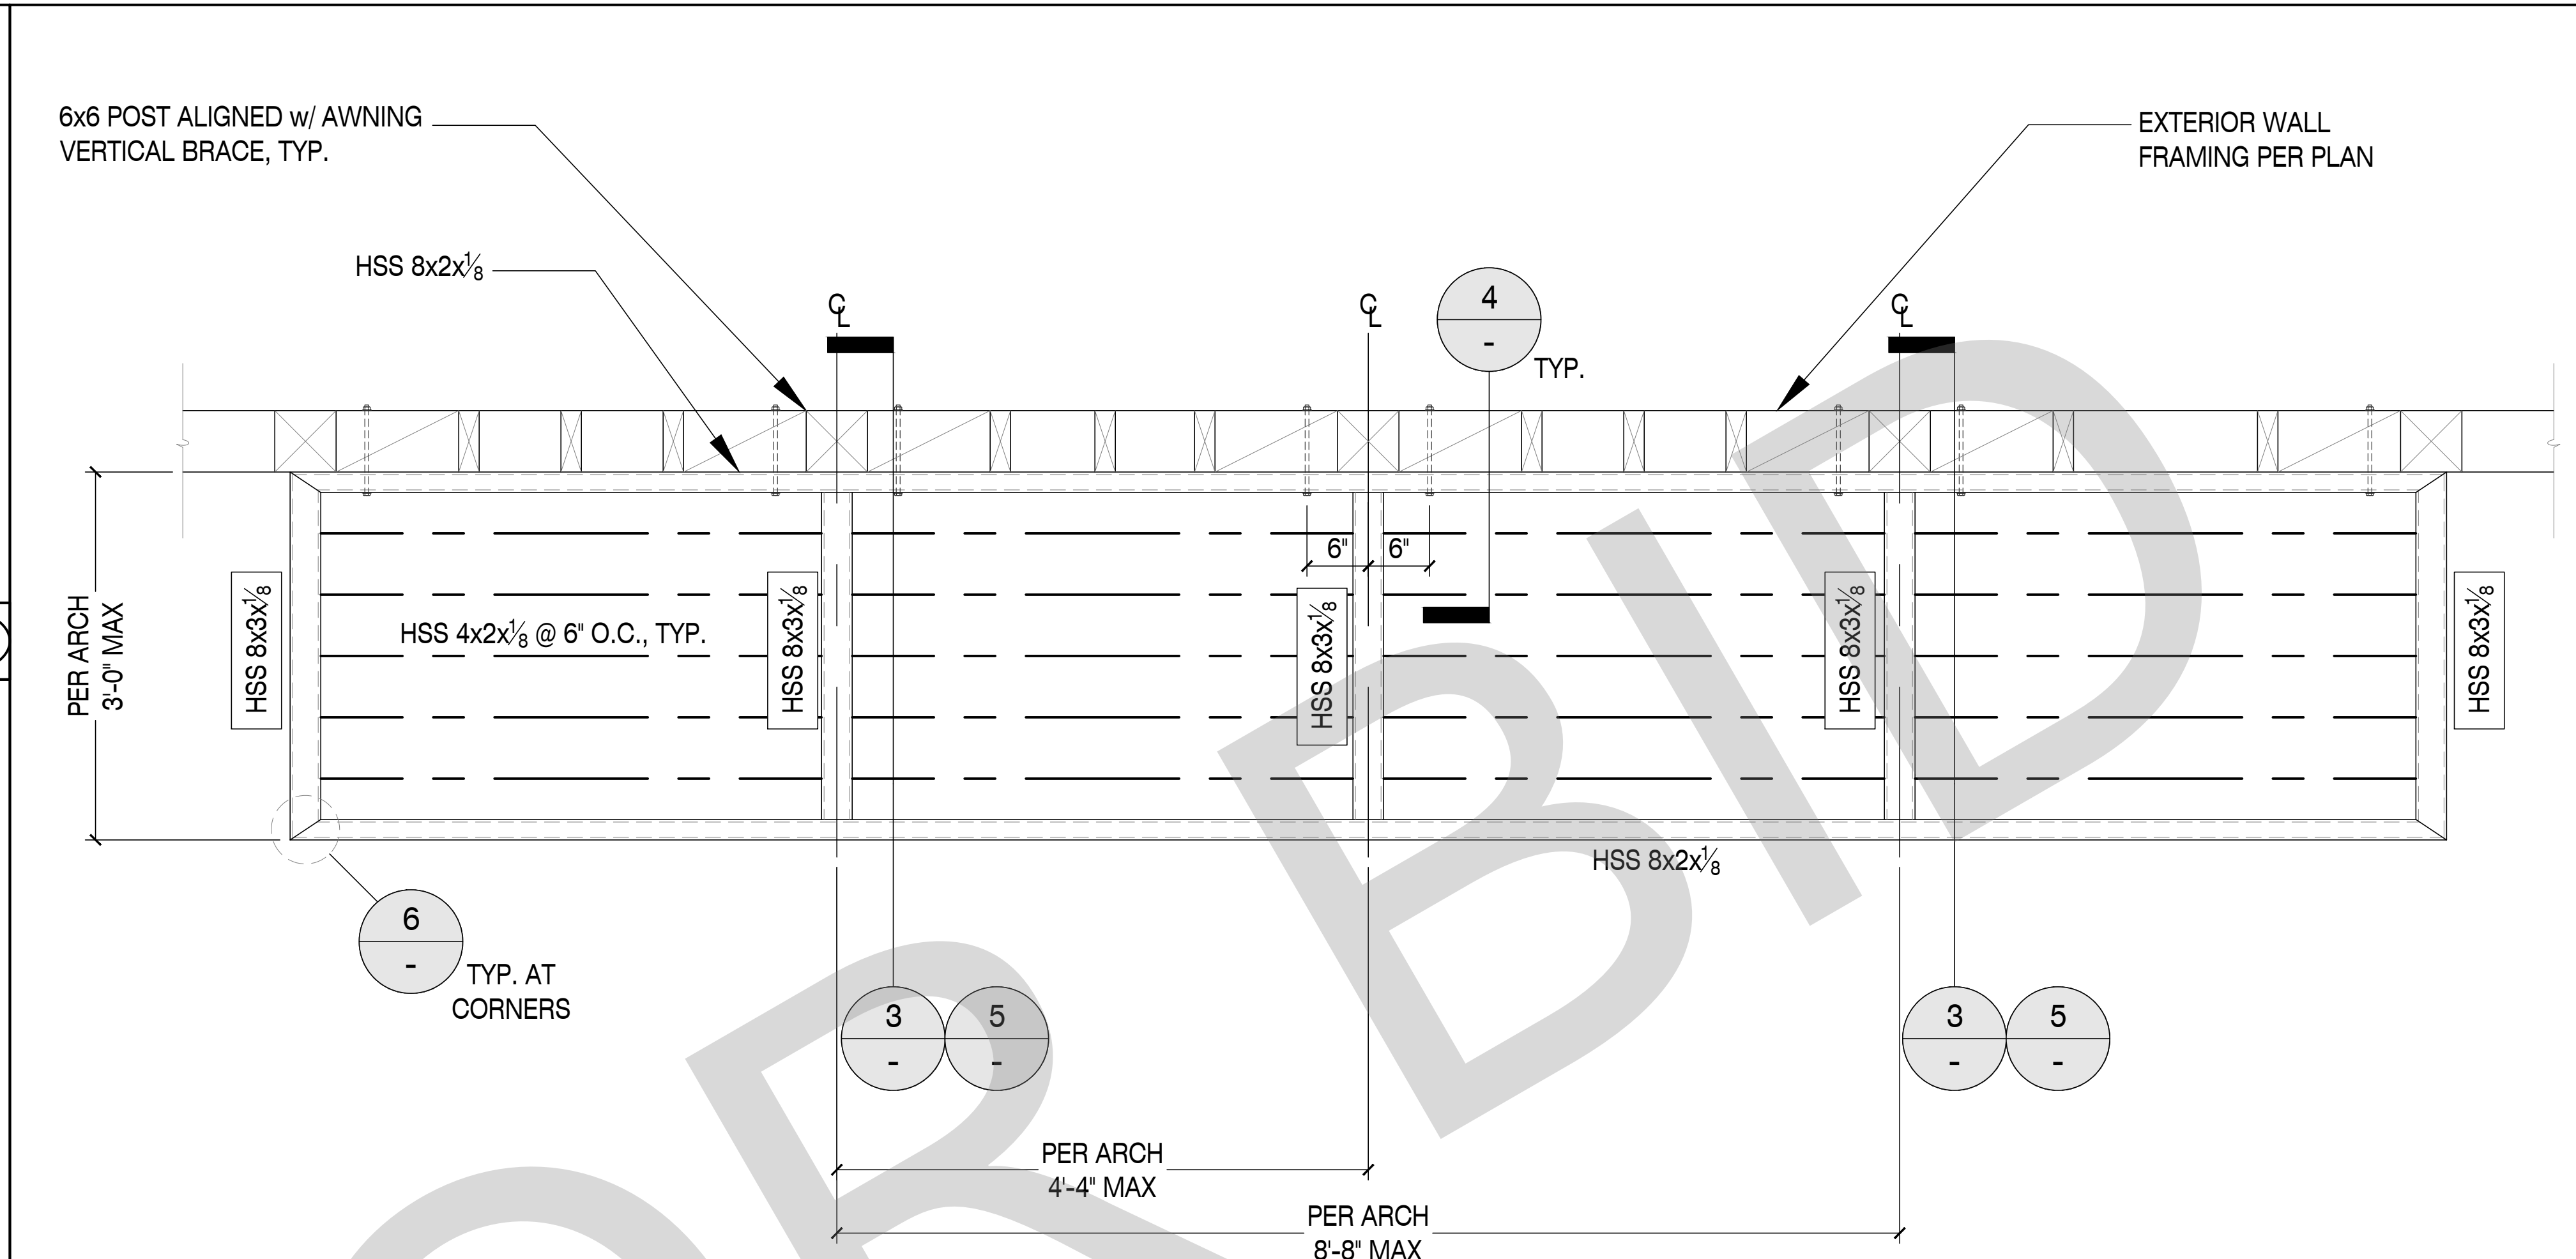


AWNING FRAMING AT FITNESS CENTER WALL
SCALE: N.T.S.

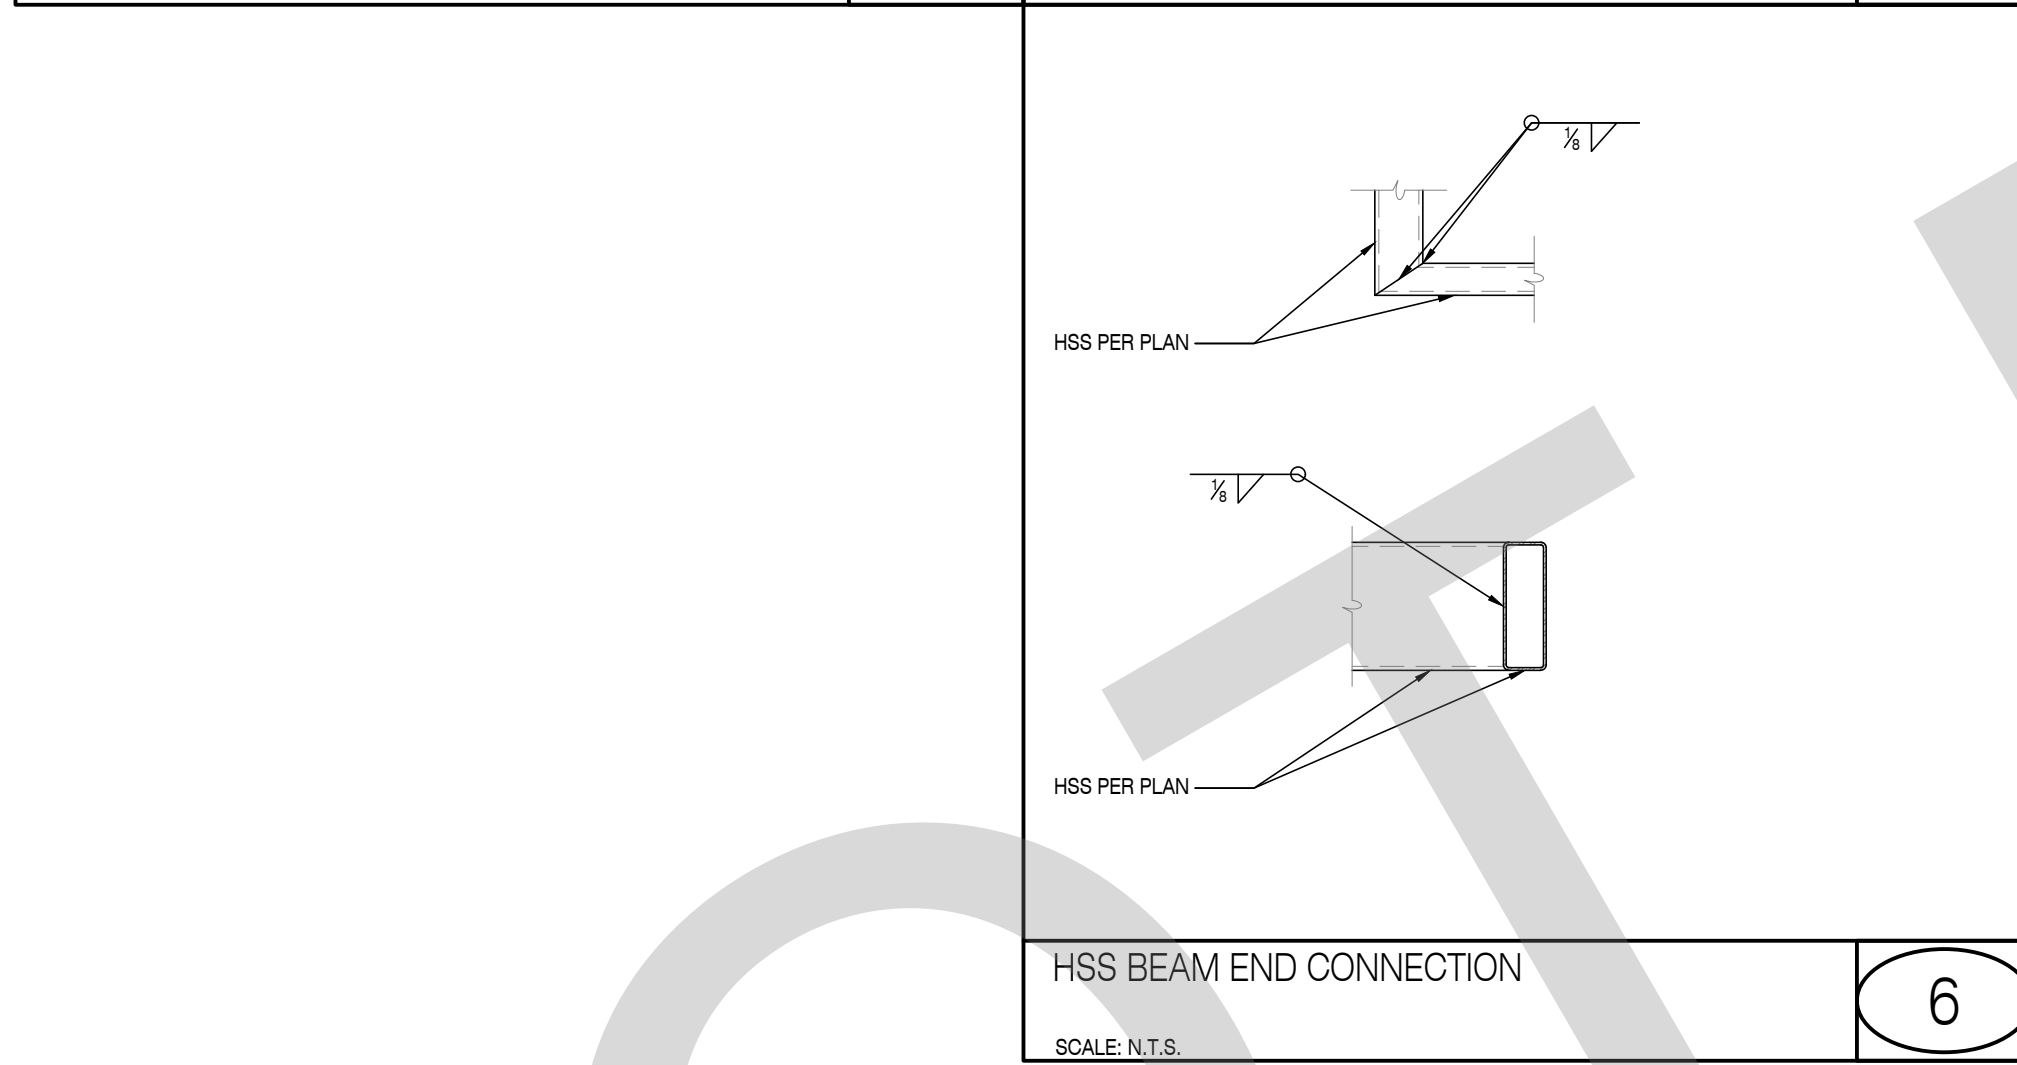

HSS BEAM END CONNECTION
SCALE: N.T.S.

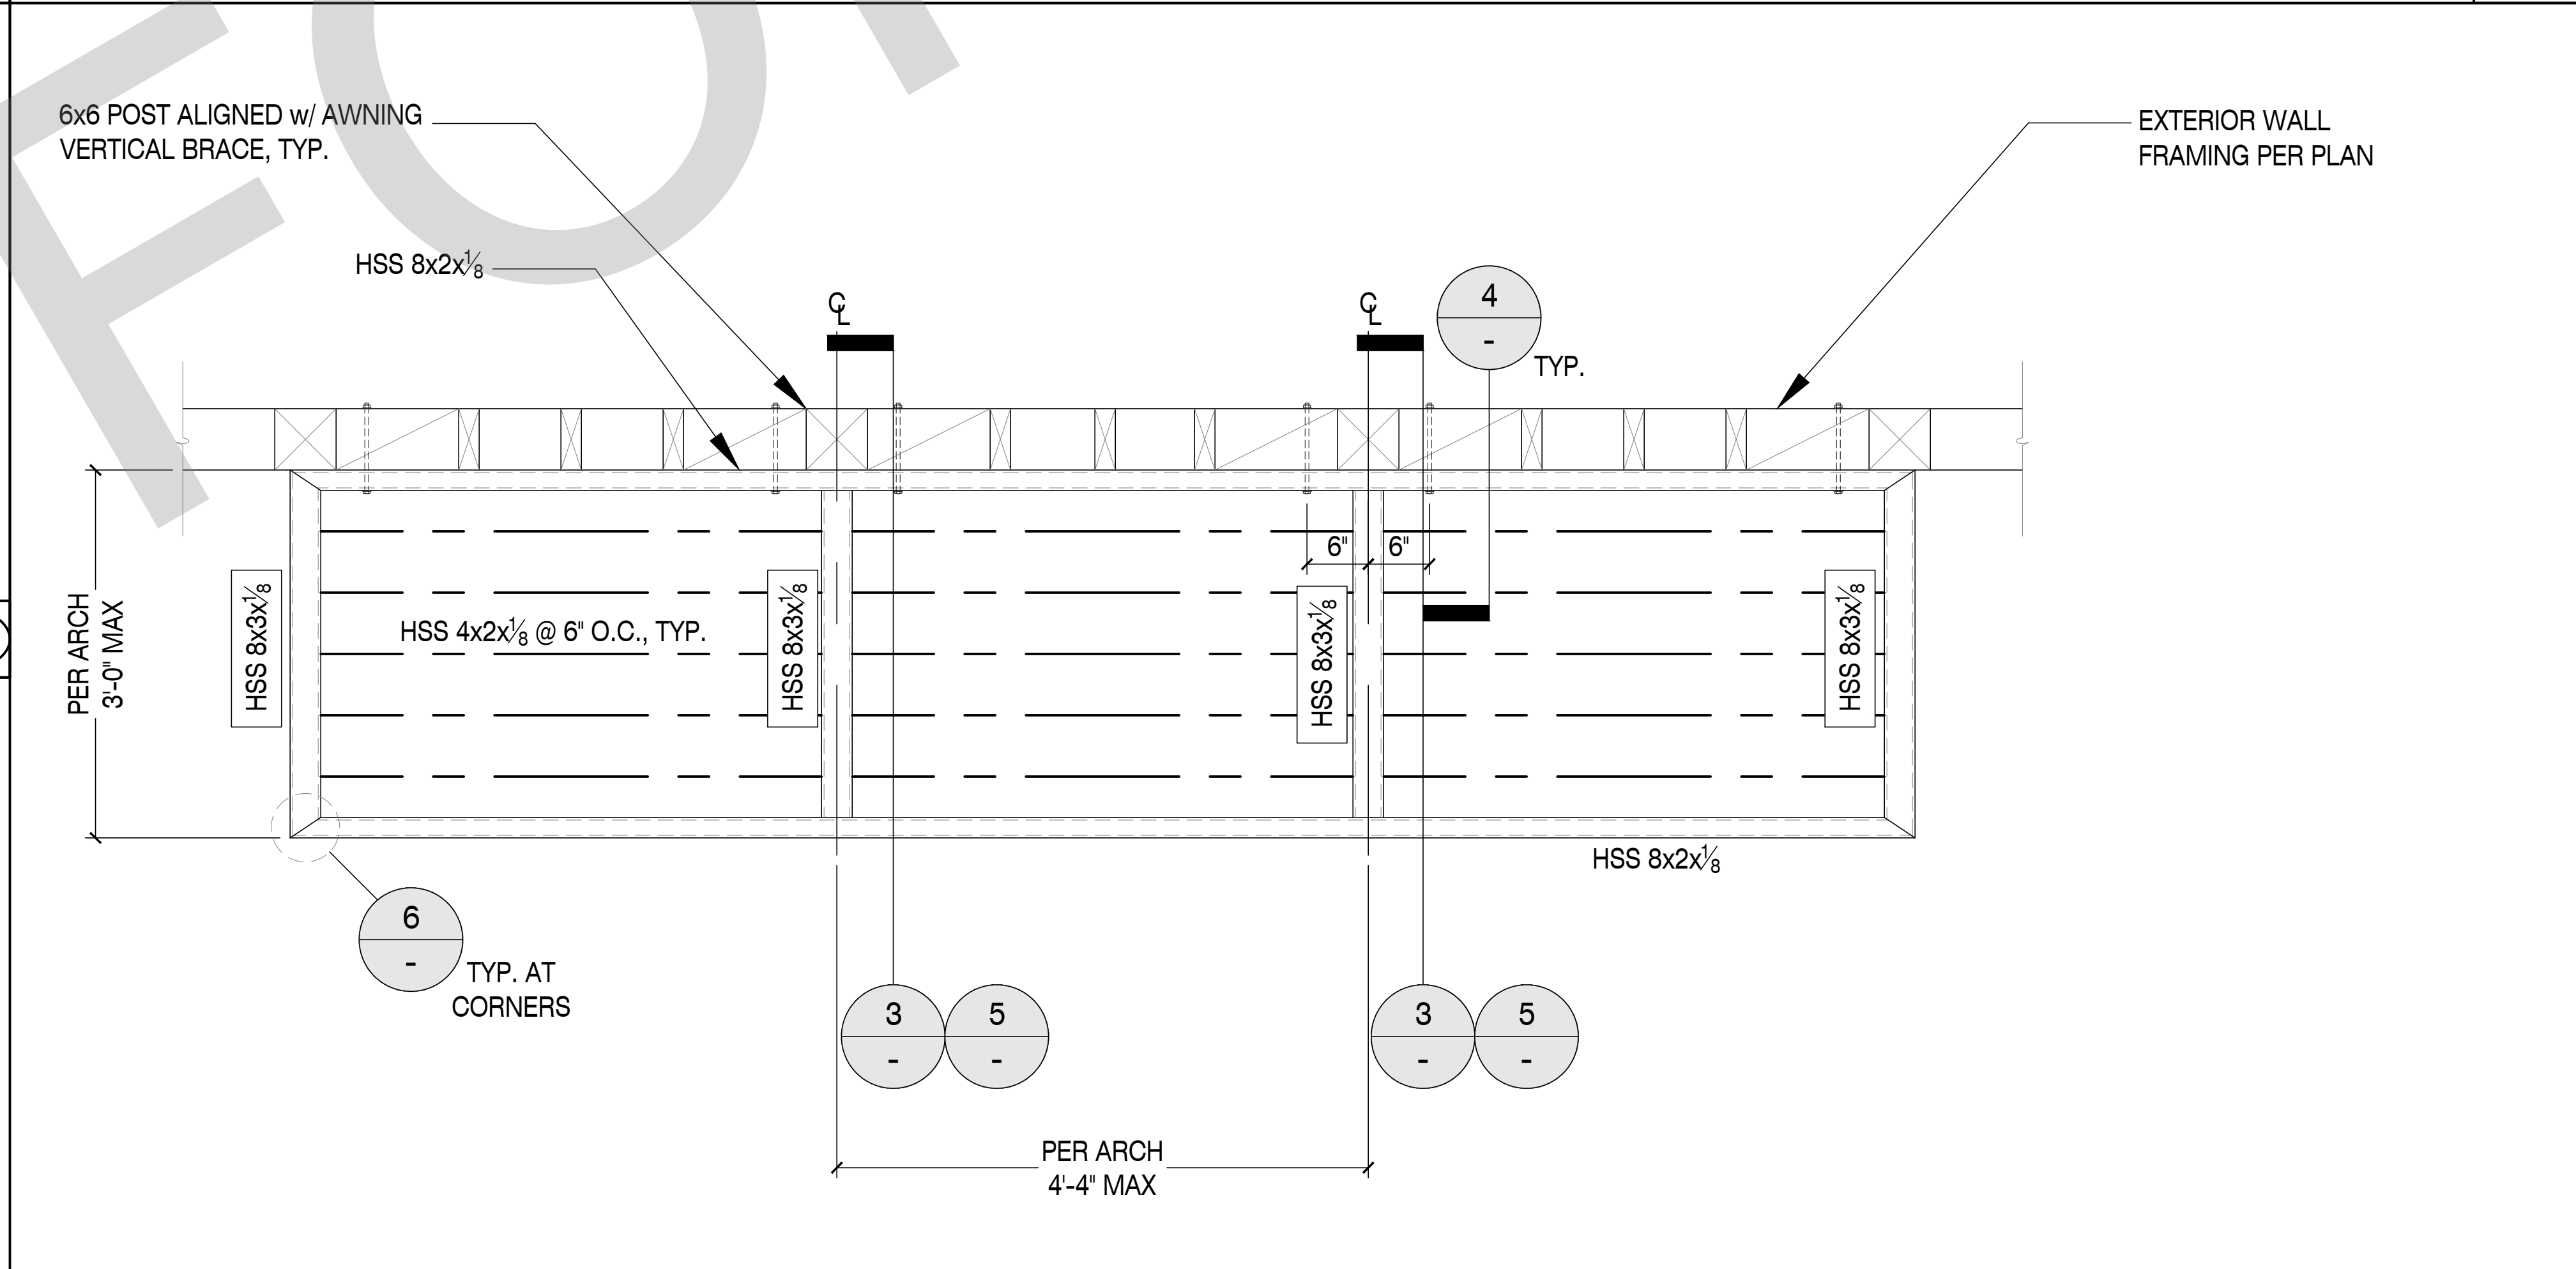


AWNING FRAMING AT ENTRANCE
SCALE: N.T.S.

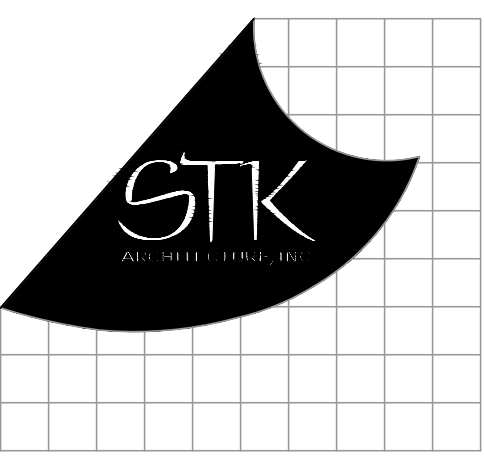

4305 DEVO DR. TEMECULA, CALIFORNIA 92590-3760
Phone: 951.296.8110 Fax: 951.296.6079 Email: stk@stke.com

CONSULTANT:

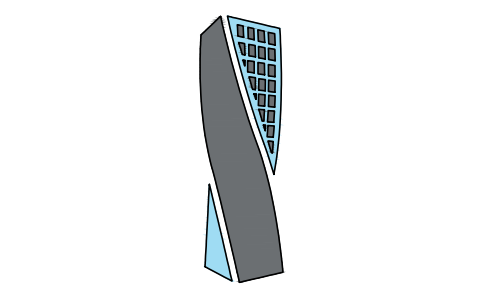

STRUCTURAL ENGINEERING
27189 VIA INDUSTRIAL
TEMECULA, CA 92590
TEL: 951.400.0033
WWW.ISEENGINEERS.COM
SOCAL | NORCAL | COLORADO
ISE PROJECT NO.: 22-7067

PROJECT MANAGER:
SANDY FONG EXT. 1016
SANDY@ISEENGINEERS.COM

PROJECT ADMINISTERED BY:
SAN BERNARDINO COUNTY
REAL ESTATE SERVICES
DEPARTMENT -
PROJECT MANAGEMENT
DIVISION

385 N. ARROWHEAD AVE.
SAN BERNARDINO, CA 92415

PROJECT NAME:
SAN BERNARDINO
COUNTY FIRE
DEPARTMENT:
FIRE STATION 226

PROJECT # 10.10.1032

CIP #

CAFM #

1920 DEL ROSA AVE N.
SAN BERNARDINO,
CA 92404

ISSUE INFORMATION:

DATE:	INFORMATION:
10-03-2022	PLAN CHECK

SHEET INFORMATION:

STK PROJECT NO.:	374-154-21
SCALE:	AS NOTED
DATE:	SEPTEMBER 2022
PLOT DATE:	09-28-2022
DRAWING NAME:	

SEAL:




SHEET TITLE:


AWNING FRAMING
DETAILS

SHEET NO.:


SD3.1

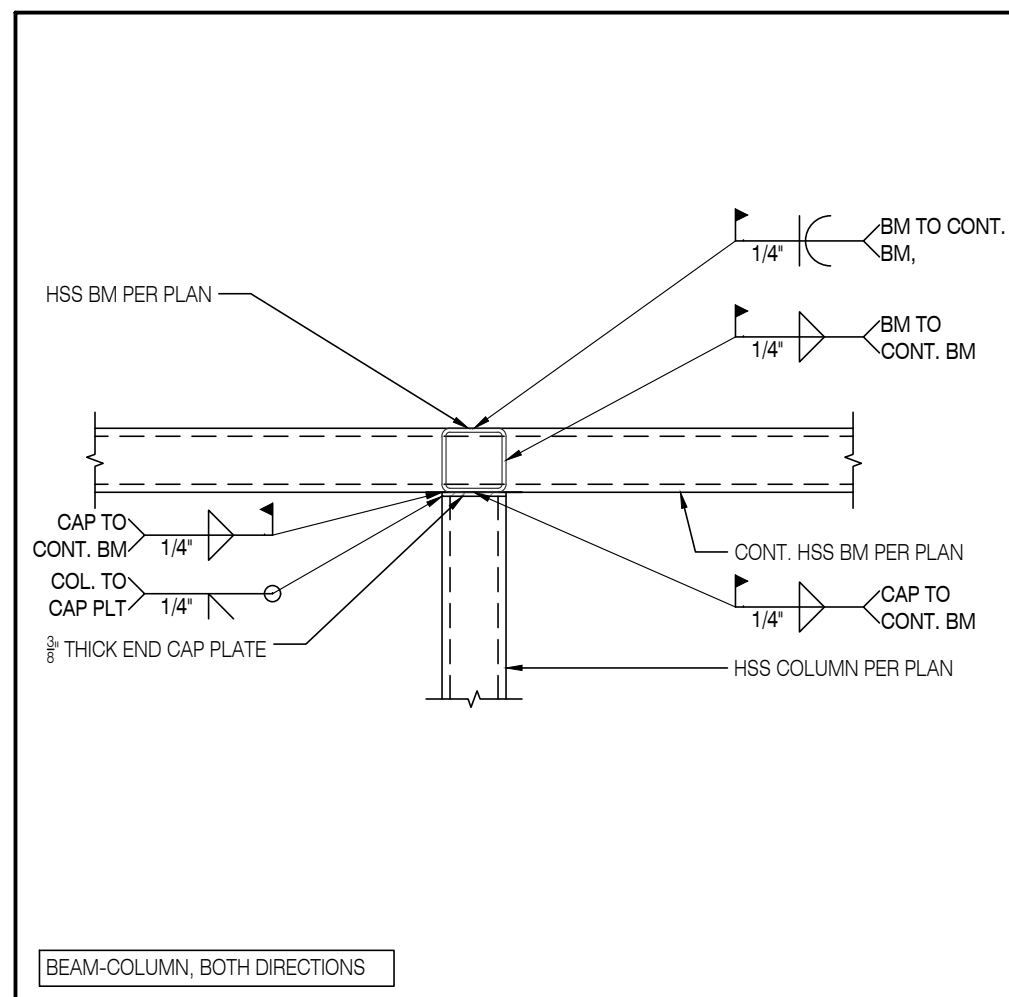

BEAM-COLUMN, BOTH DIRECTIONS

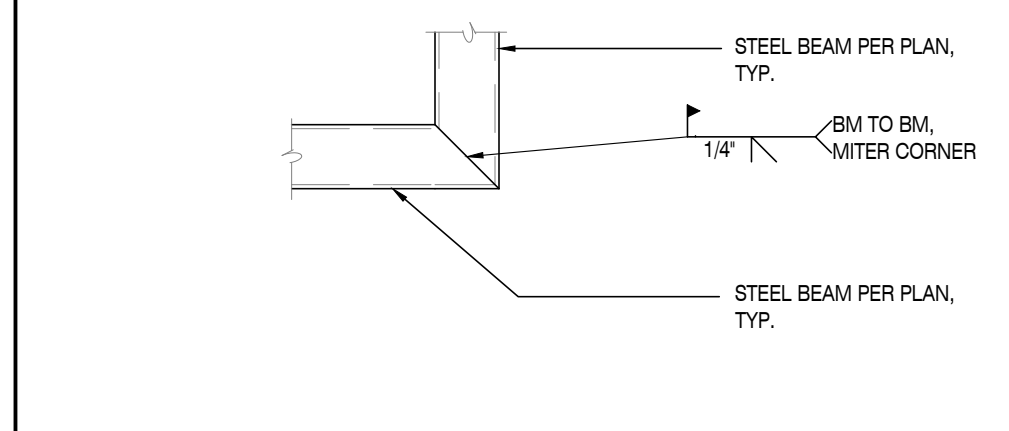

BEAM-BEAM, MITERED CORNER

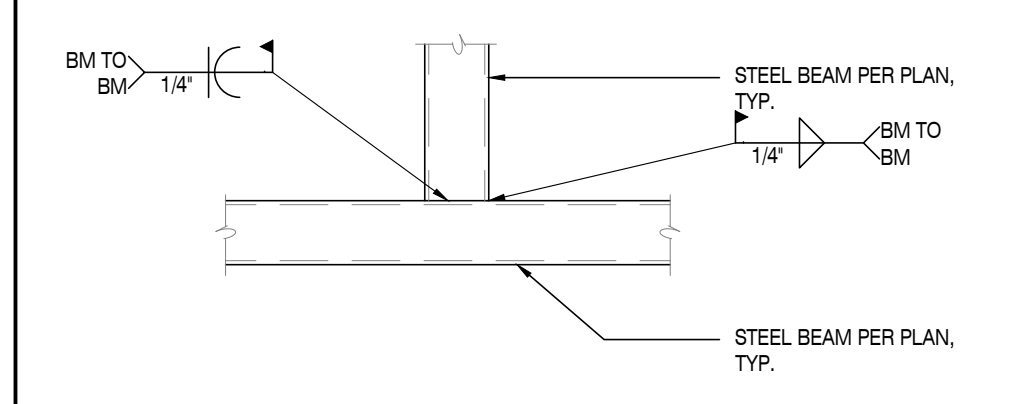


BEAM-BEAM, T INTERSECTION

HSS TO HSS WELDED CONNECTIONS

SCALE: N.T.S.


METAL DECK DIAPHRAGM SCHEDULE									
DECK MARK	GALVANIZED G90 VERO DECK TYPE	ALLOWABLE SPAN	DECK PROPERTIES			DECK ATTACHMENT			ALLOWABLE DIAPHRAGM LATERAL BEAR LOAD
			CASE	MIN. L (ft)	MIN. t (in)	MIN. S (in)	MIN. S (in)	MIN. S (in)	
D1	HSS-36-SS	6'-4"	15	0.302	0.314	0.351	24"	12"	353 PLF
D2	HSS-36-SS	11'-0"	22	0.721	0.353	0.405	24"	8"	182 PLF

- REFER TO FRAMING PLANS FOR APPLICATION LOCATIONS.
- ROOF DECK ATTACHMENTS TO SUPPORTS (MIN. 0.0385 INCHES THICK) SHALL BE MADE BY #12 SELF-DRILLING, SELF-TAPPING, SDI RECOGNIZED SCREWS FROM BULDEX, ELOD, HLT, AND SIMPSON STRONG TIE PER THE SCHEDULE ABOVE & AS INDICATED BELOW.
- ALL DECKS SHALL BE CONTINUOUS OVER SINGLE SPANS AND CANTILEVERS.
- THE DIMENSION FROM THE FIRST AND LAST SIDELAP CONNECTION WITHIN EACH SPAN IS TO BE NO MORE THAN ONE-HALF OF THE SPECIFIED SPACING.

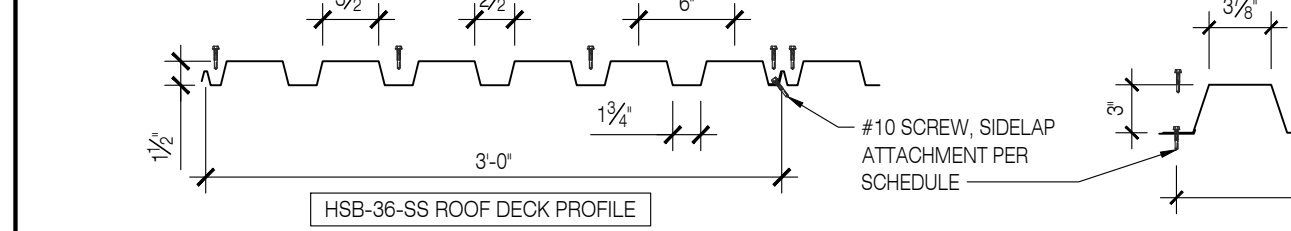


METAL DECK DIAPHRAGM SCHEDULE

SCALE: N.T.S.

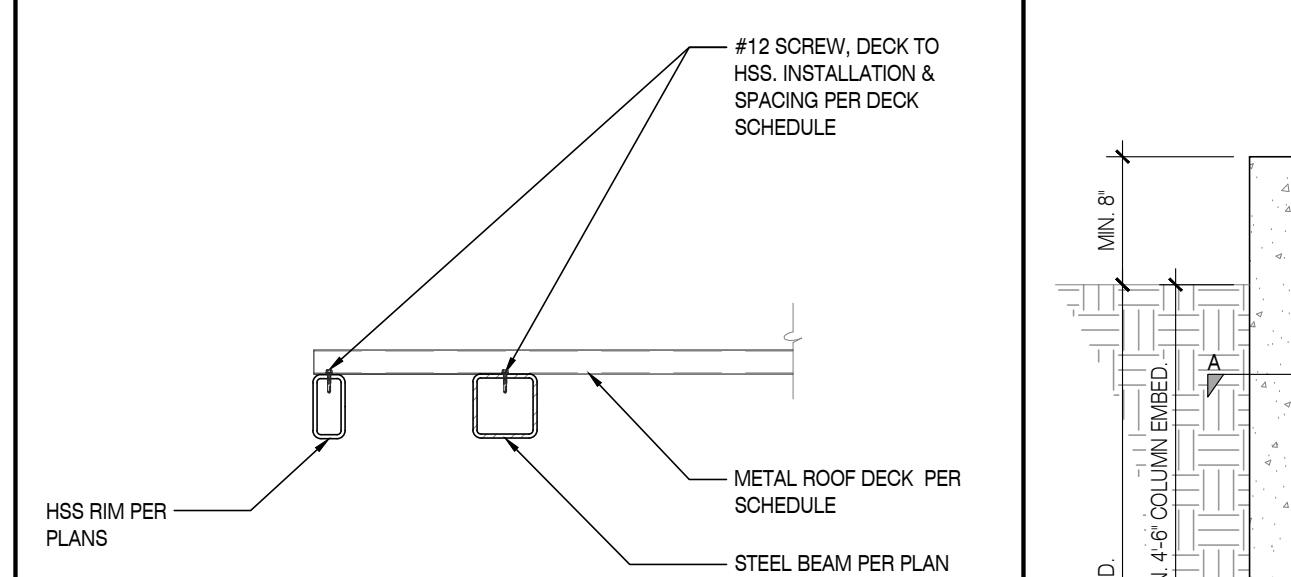


DECK RISER PERPENDICULAR TO EDGE SUPPORT

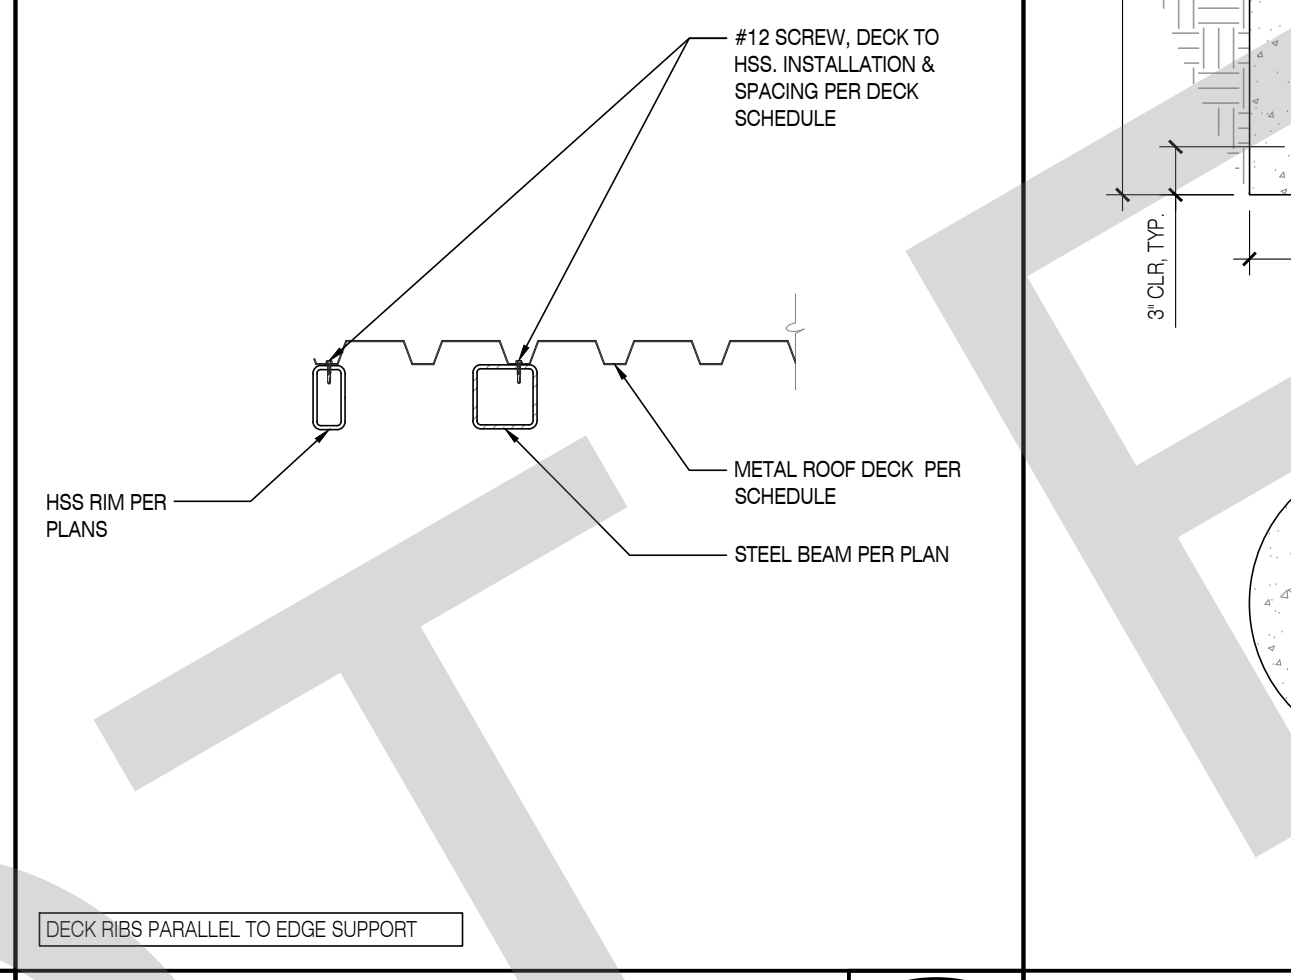

DECK RISER PARALLEL TO EDGE SUPPORT


METAL DECK TO HSS

SCALE: N.T.S.

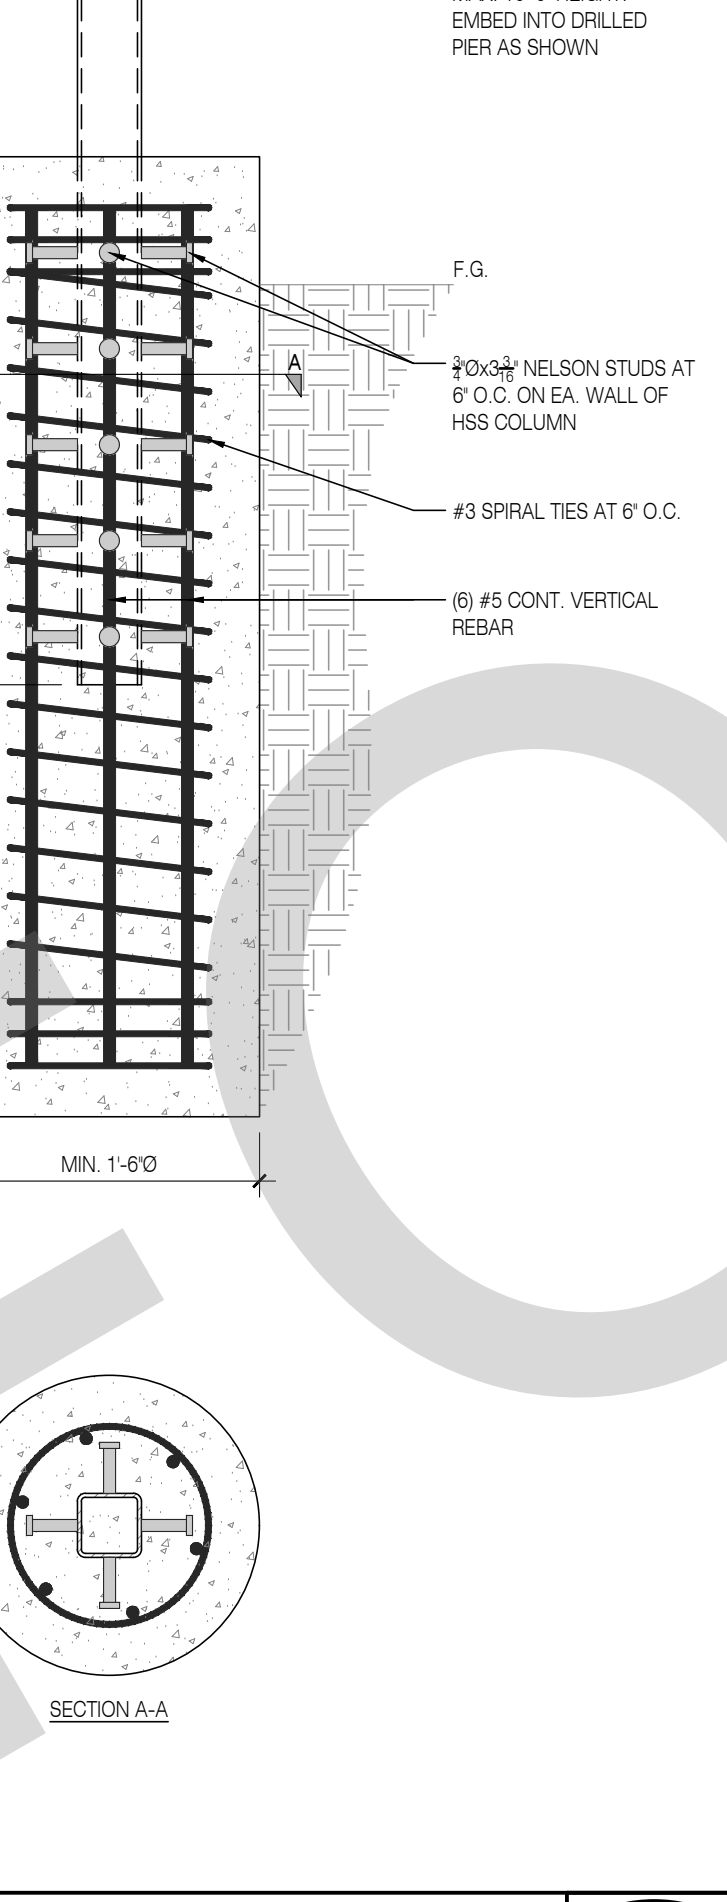


FUEL GENERATOR/TANK CANOPY, DRILLED PIER

SCALE: N.T.S.

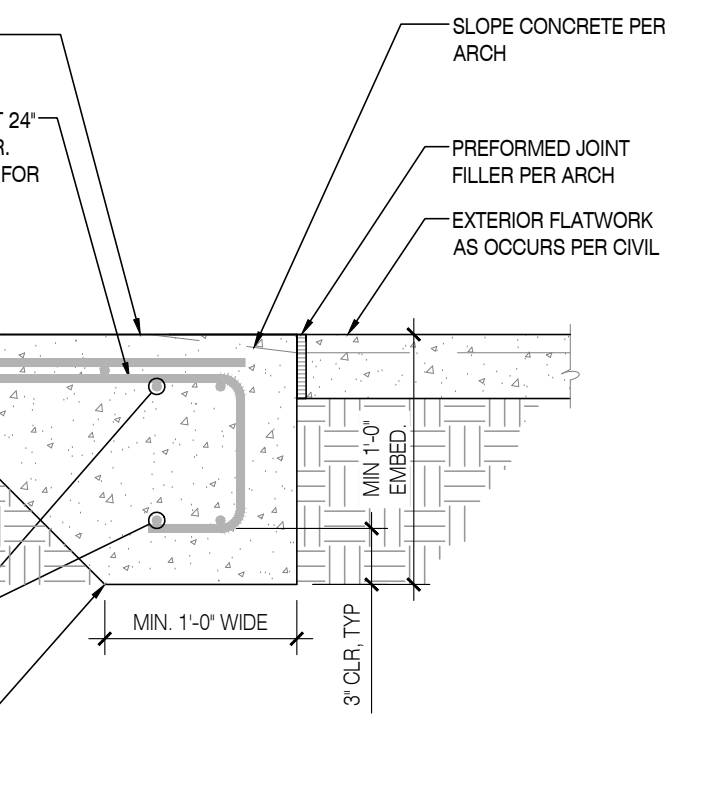


TRASH ENCLOSURE, CONCRETE TURN-DOWN FOOTING

SCALE: N.T.S.

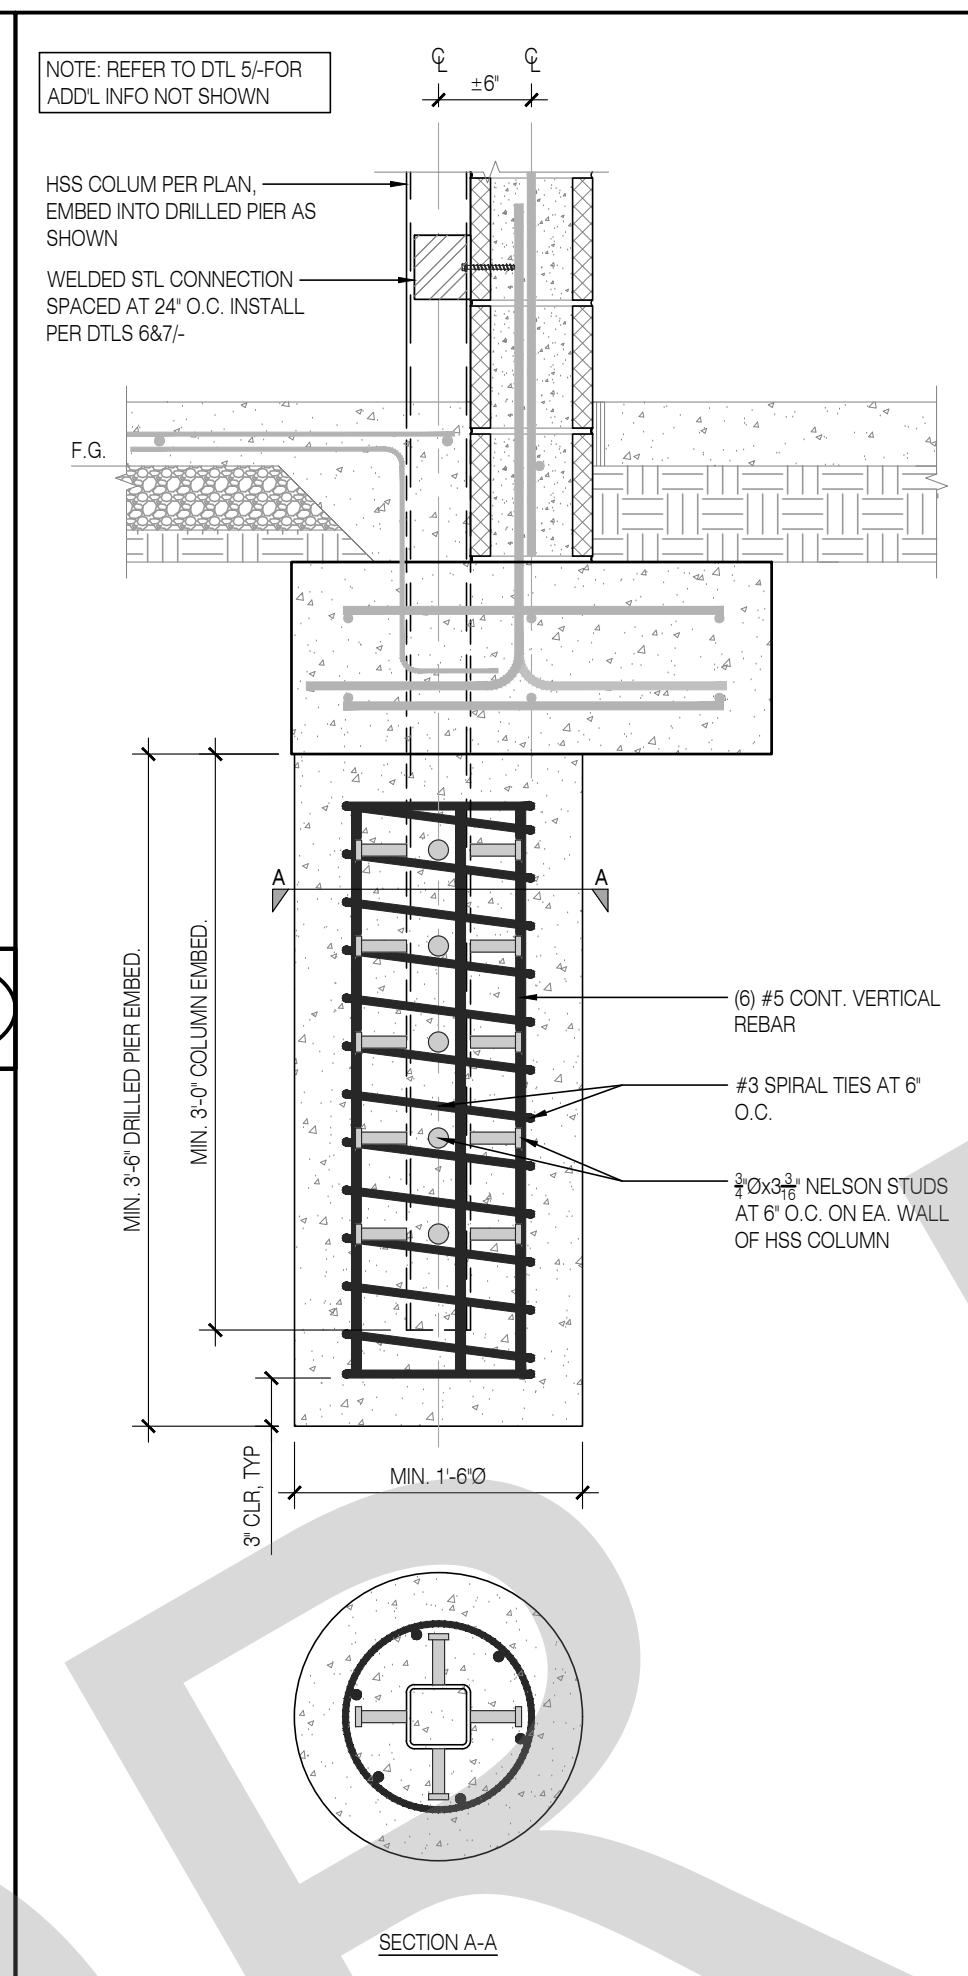


TRASH ENCLOSURE, HSS POST AT CMU WALL, POST EMBED W/ DRILLED PIER

SCALE: N.T.S.

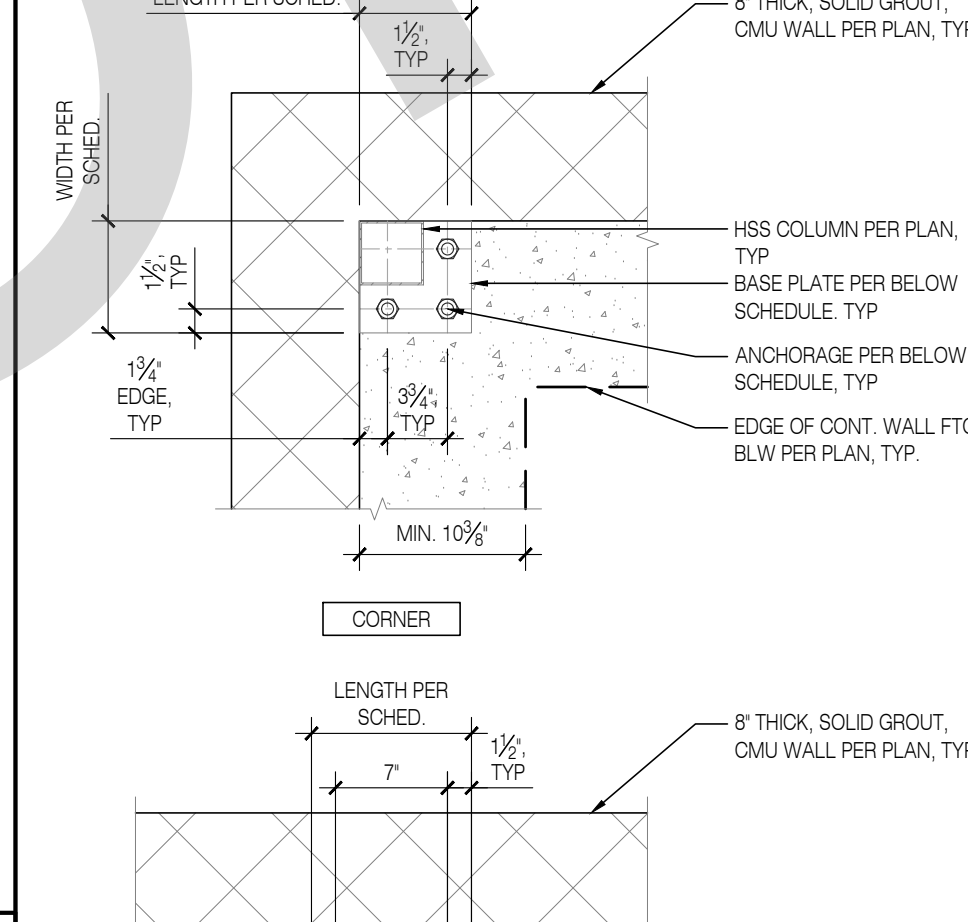


TRASH ENCLOSURE, TYP COLUMN & BASE PLATE

SCALE: N.T.S.

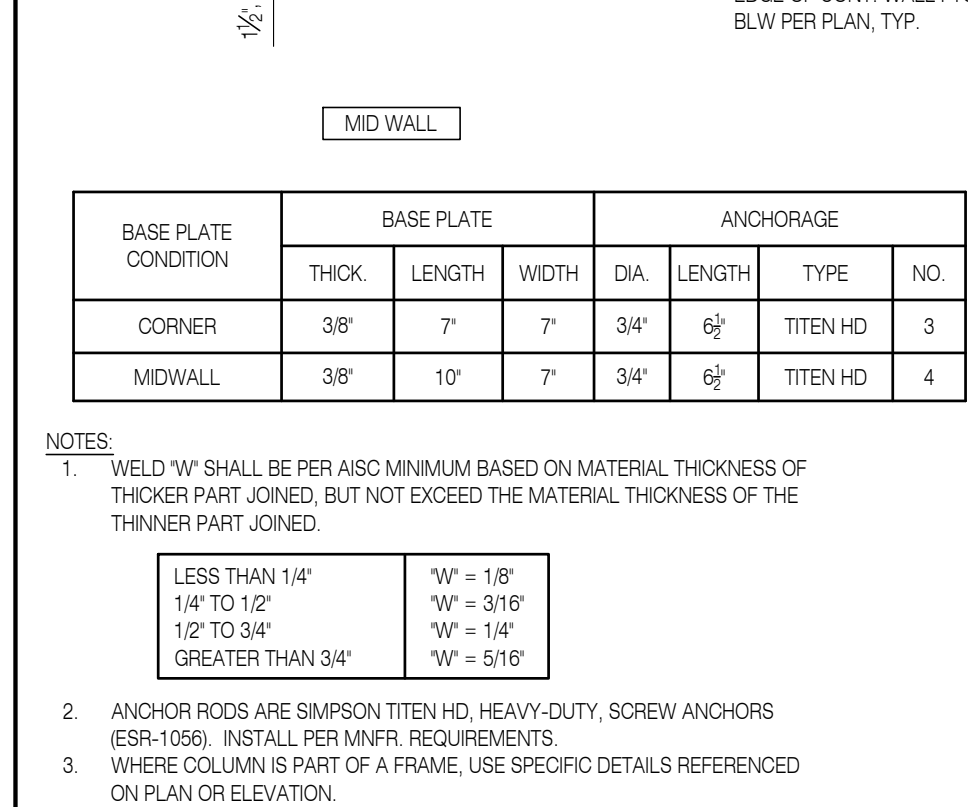


TRASH ENCLOSURE, TYP COLUMN & BASE PLATE

SCALE: N.T.S.

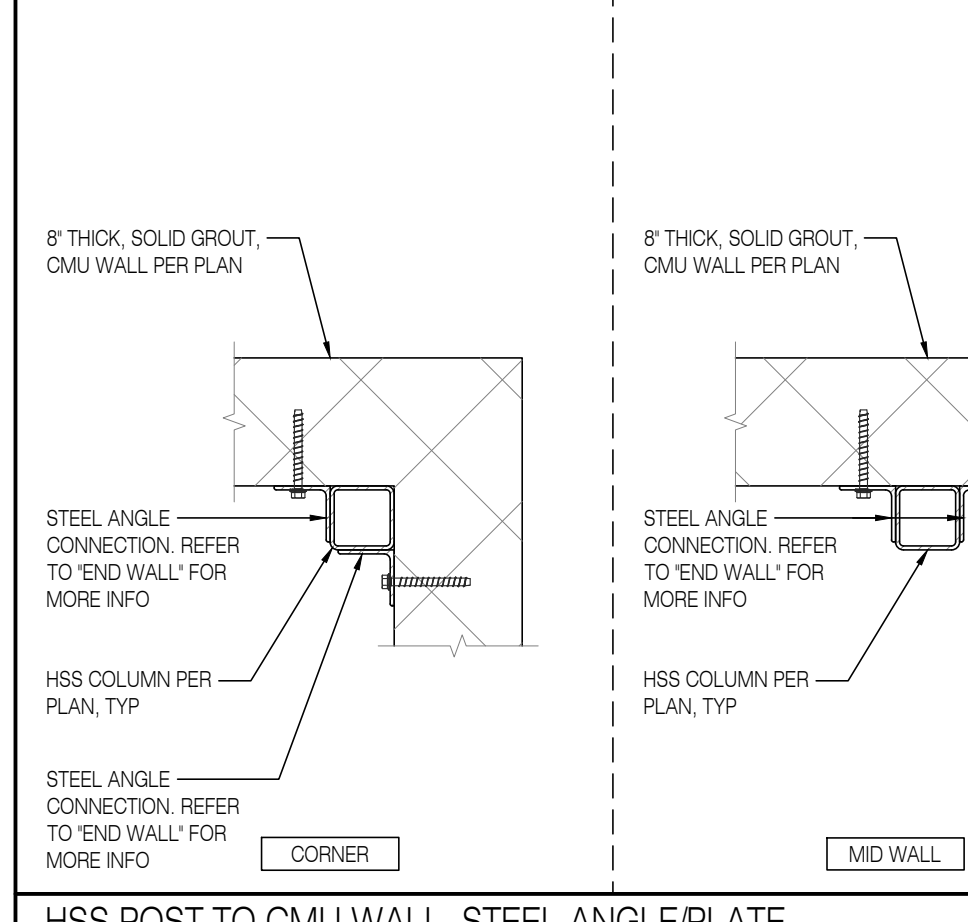


HSS POST TO CMU WALL, STEEL ANGLE/PLATE CONNECTIONS

SCALE: N.T.S.

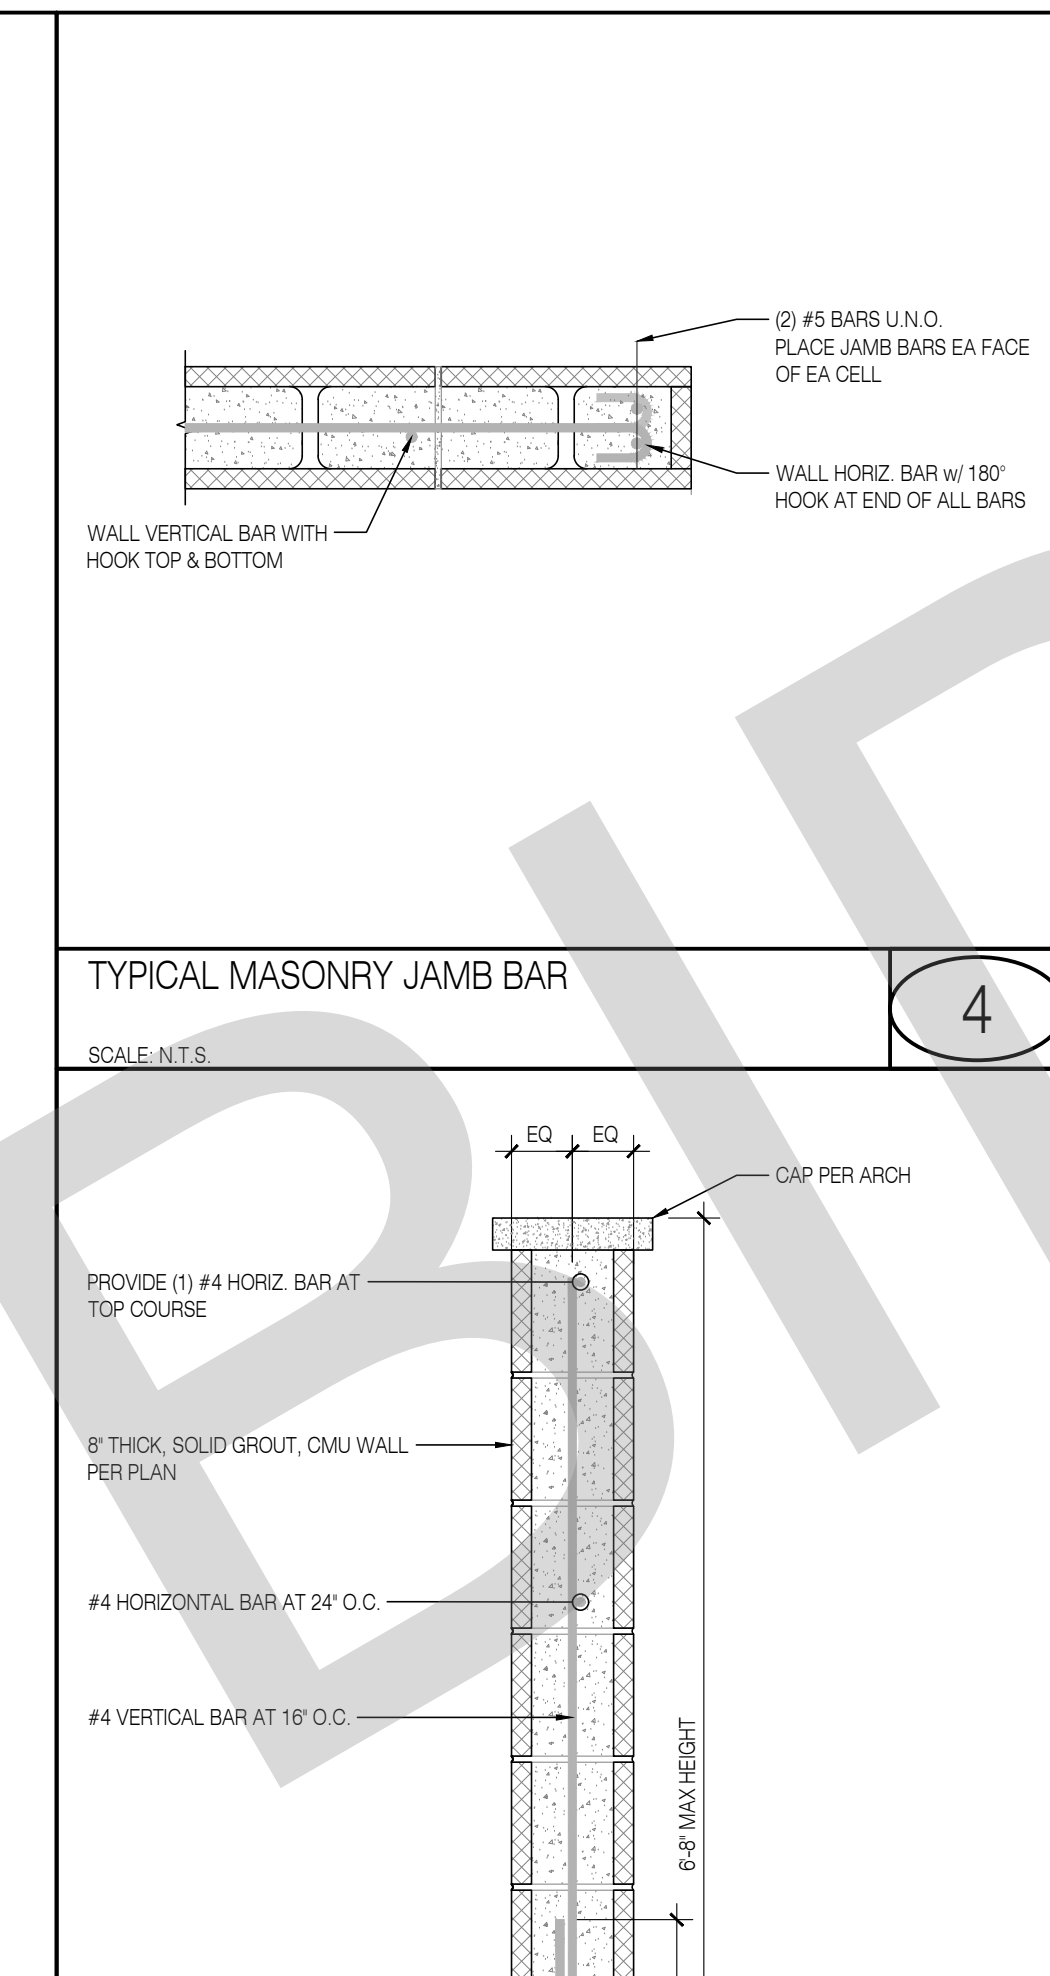


TRASH ENCLOSURE, HSS POST AT CMU WALL, BASE PLATE

SCALE: N.T.S.

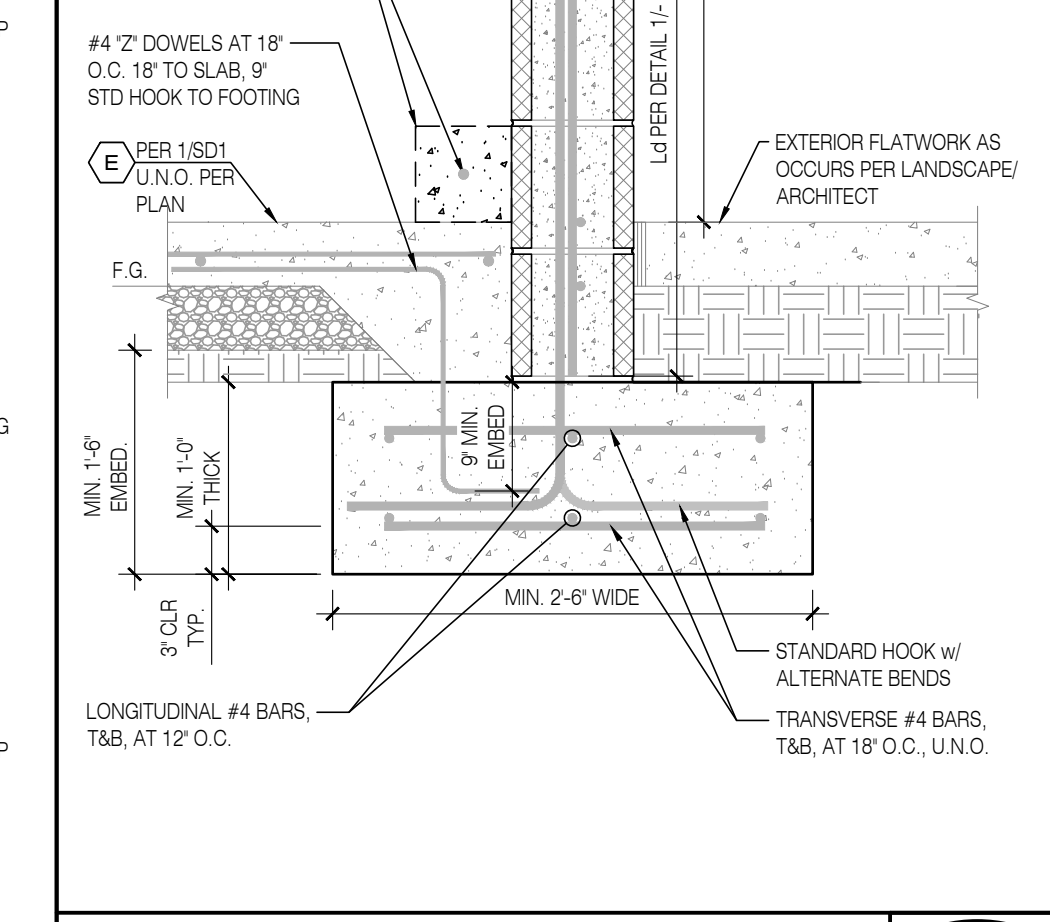


TRASH ENCLOSURE, TYP FREE-STANDING CMU WALL FOOTING

SCALE: N.T.S.

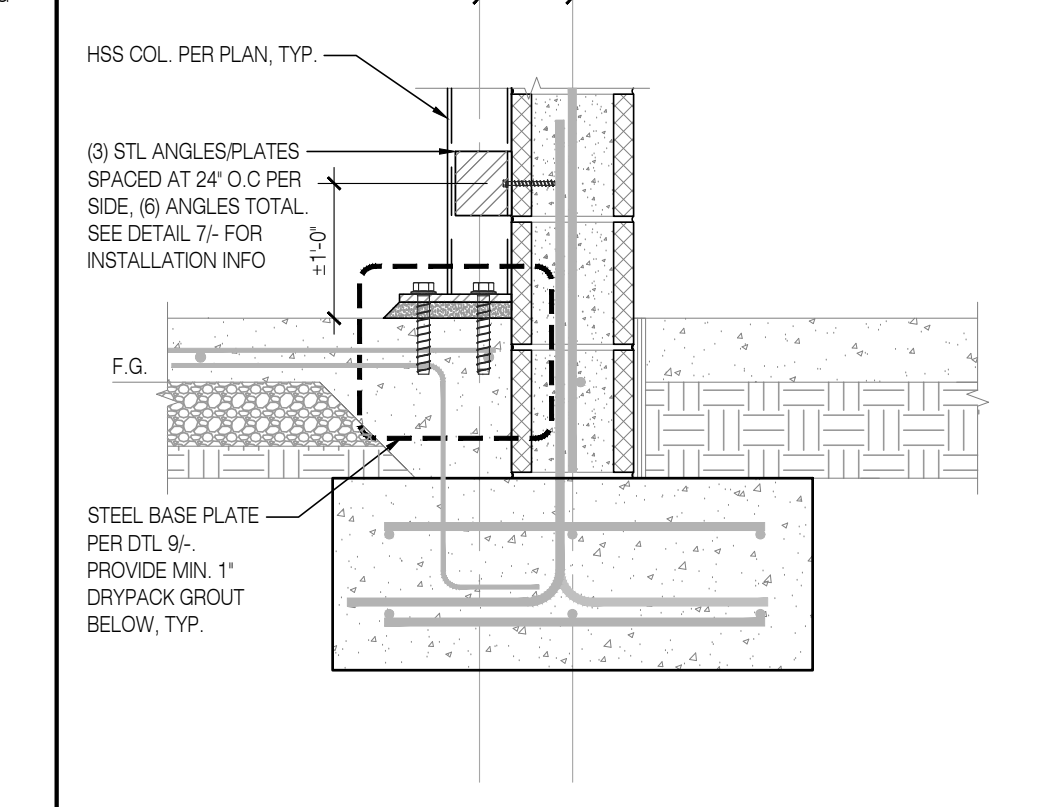


TRASH ENCLOSURE, HSS POST AT CMU WALL, BASE PLATE

SCALE: N.T.S.

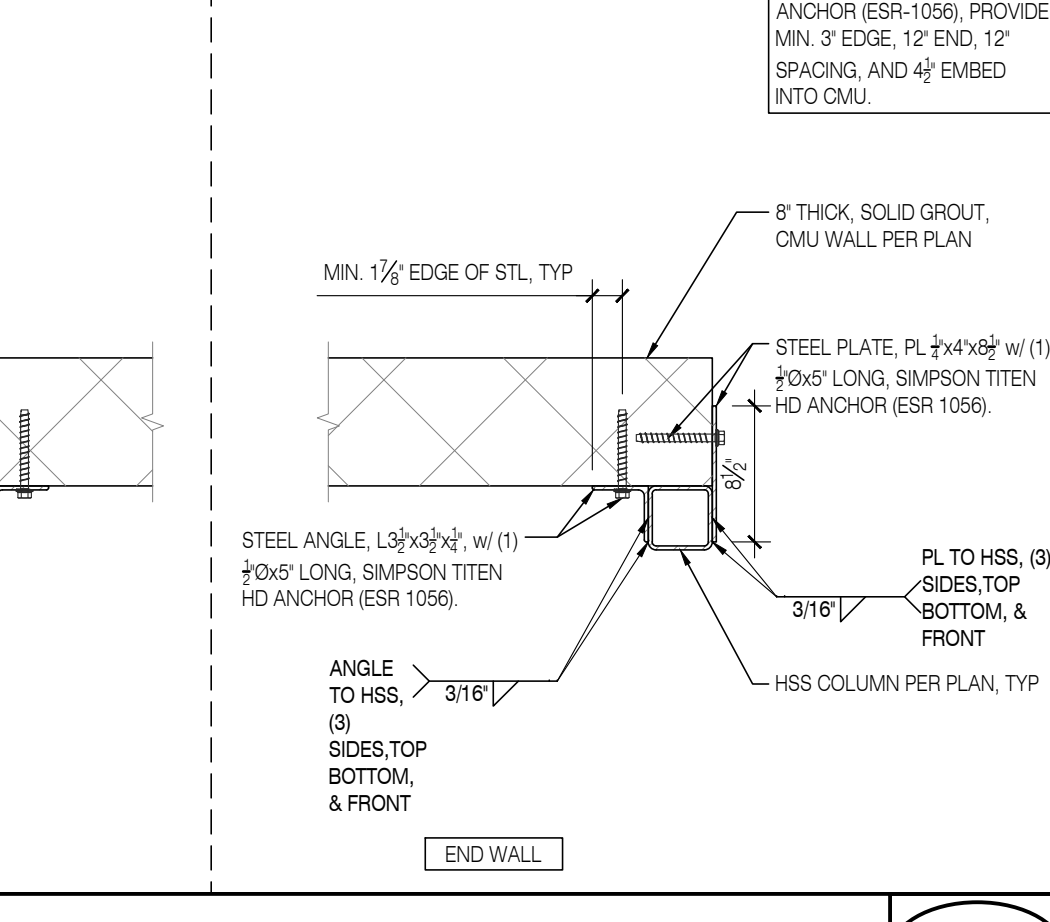


HSS POST TO CMU WALL, STEEL ANGLE/PLATE CONNECTIONS

SCALE: N.T.S.

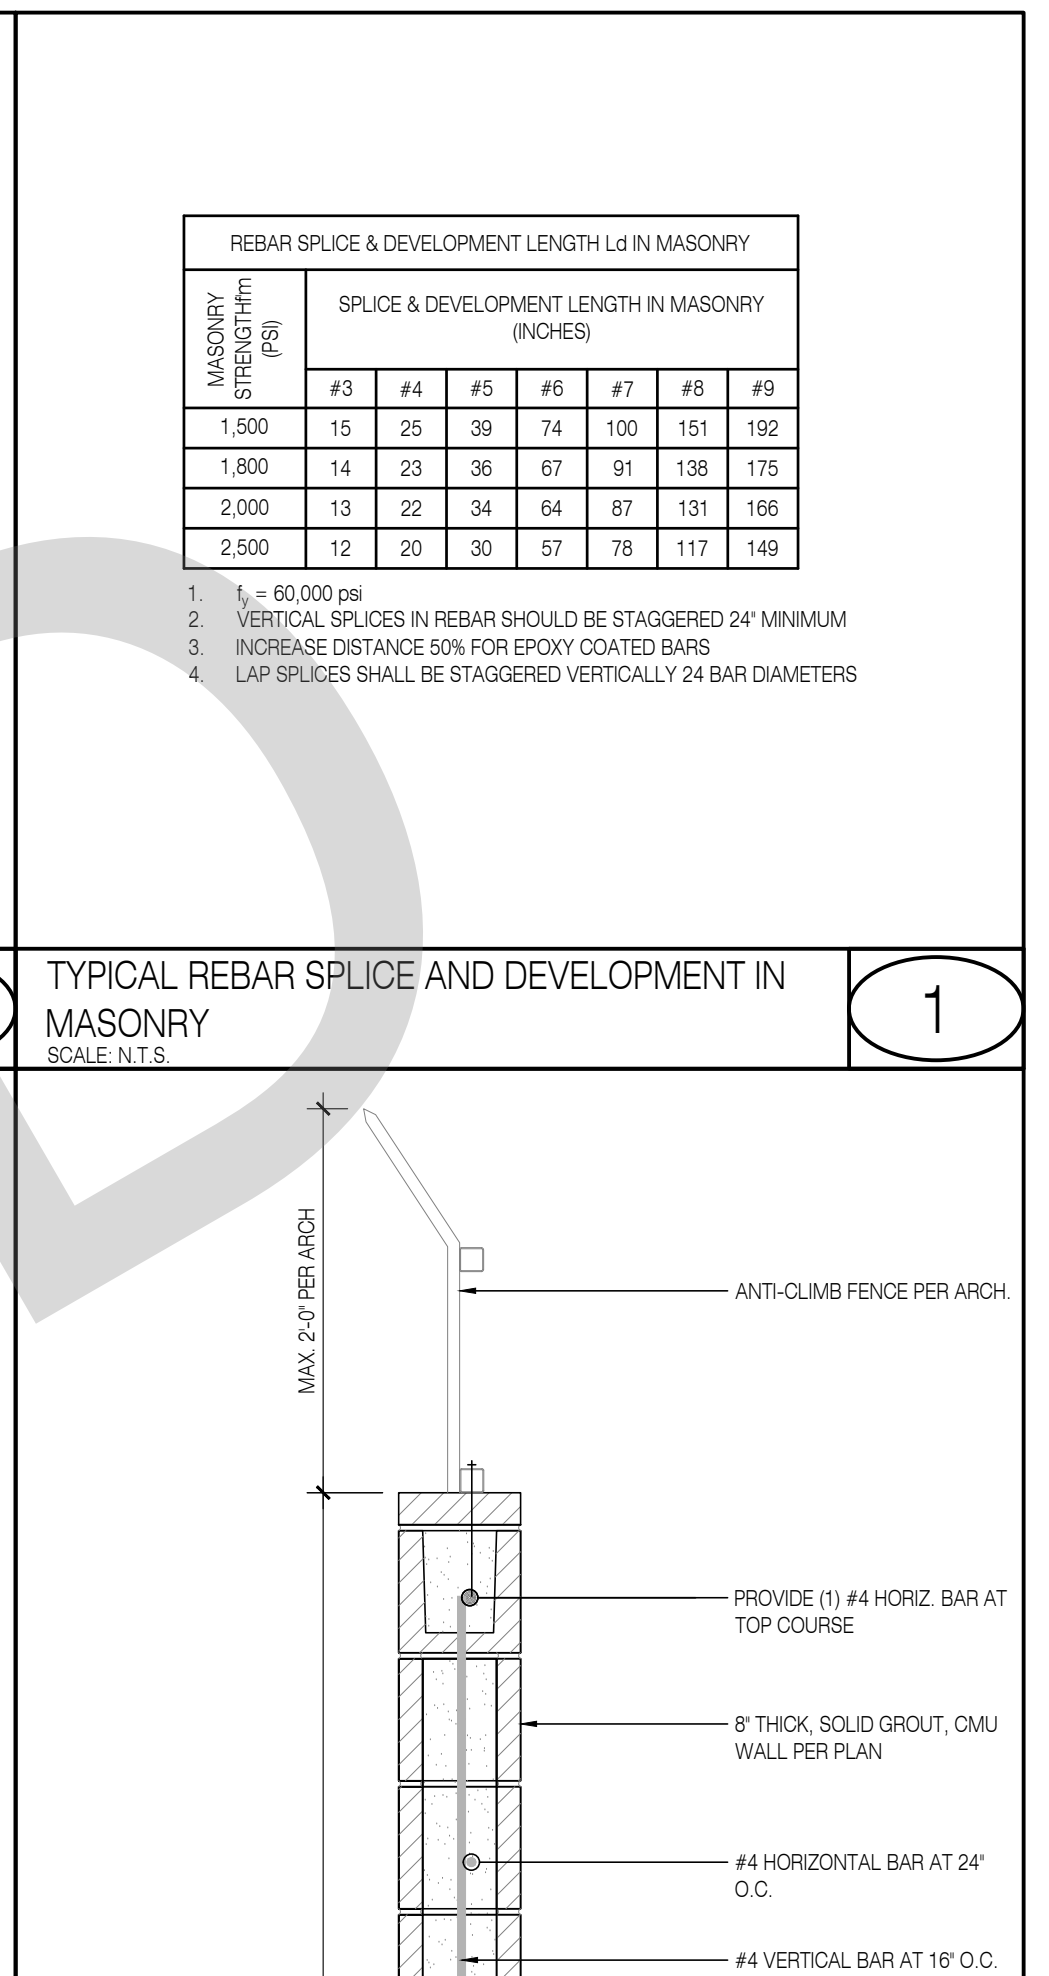


TRASH ENCLOSURE, HSS POST AT CMU WALL, BASE PLATE

SCALE: N.T.S.

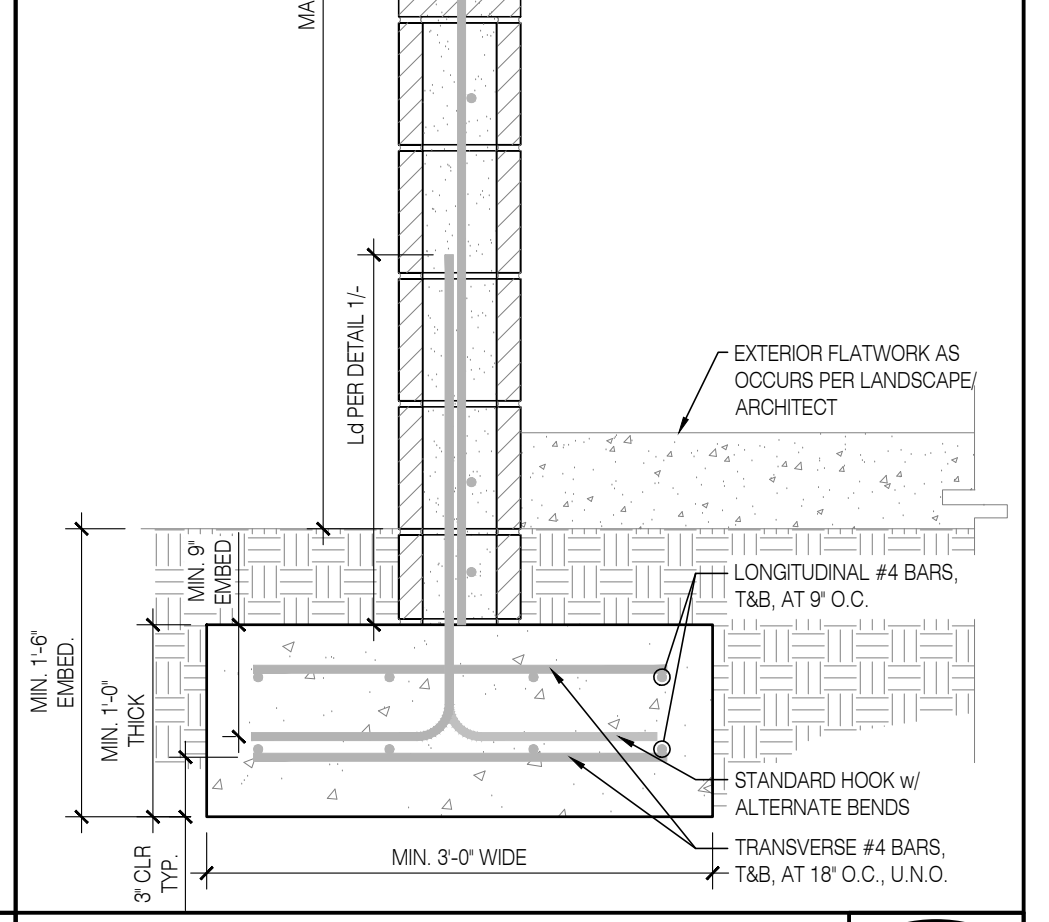


TRASH ENCLOSURE, TYP FREE-STANDING CMU WALL FOOTING

SCALE: N.T.S.

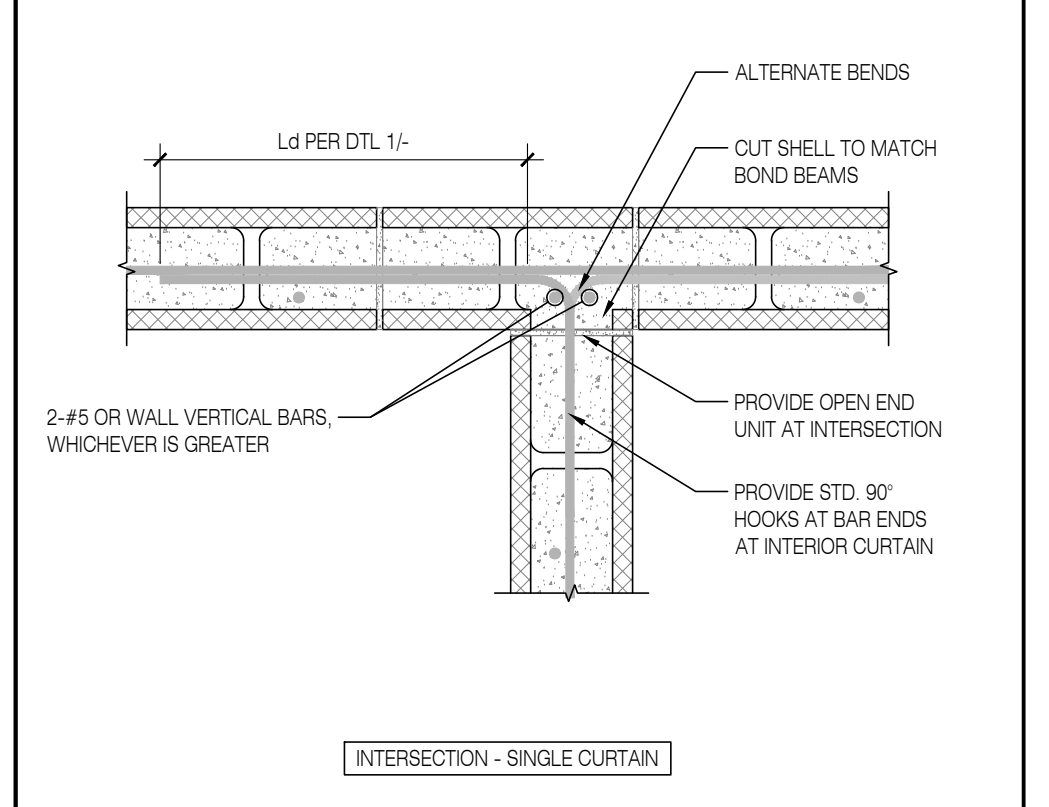

TRASH ENCLOSURE, HSS POST AT CMU WALL, BASE PLATE

SCALE: N.T.S.

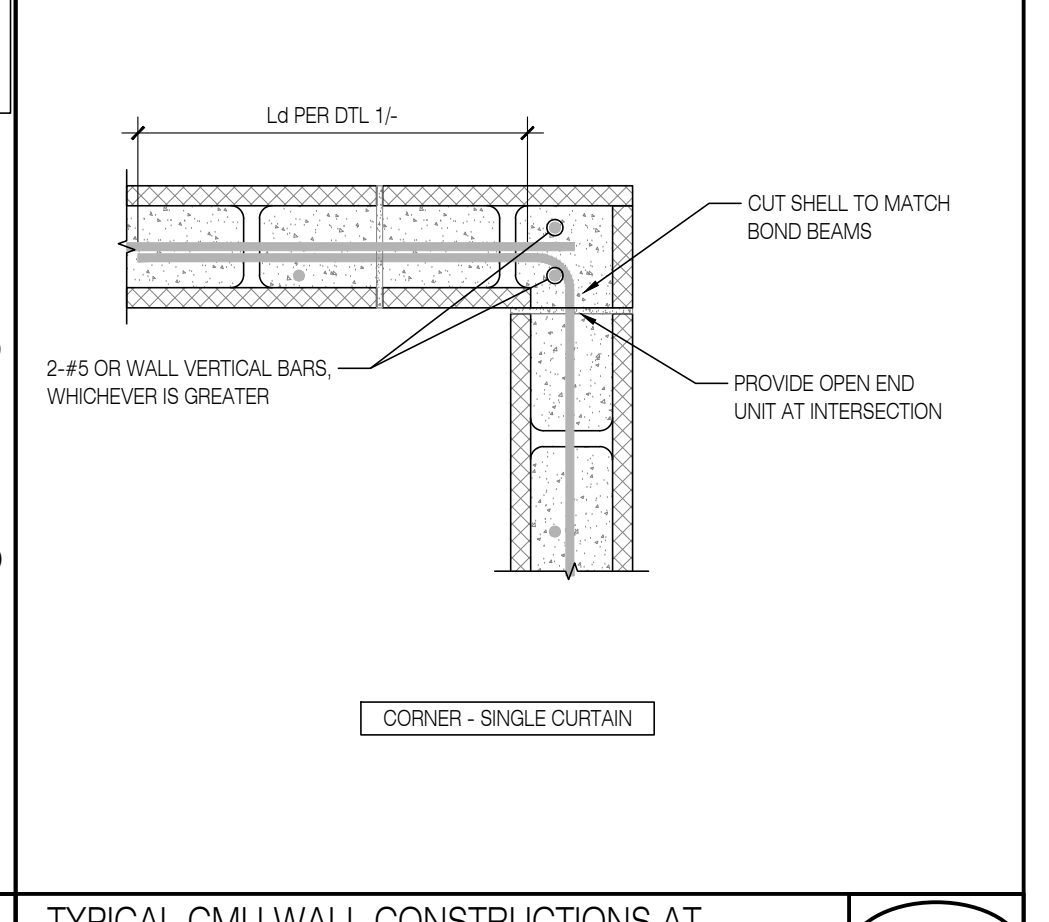

HSS POST TO CMU WALL, STEEL ANGLE/PLATE CONNECTIONS


SCALE: N.T.S.

TYPICAL CMU WALL CONSTRUCTIONS AT CORNERS & INTERSECTIONS

SCALE: N.T.S.



CONSULTANT:

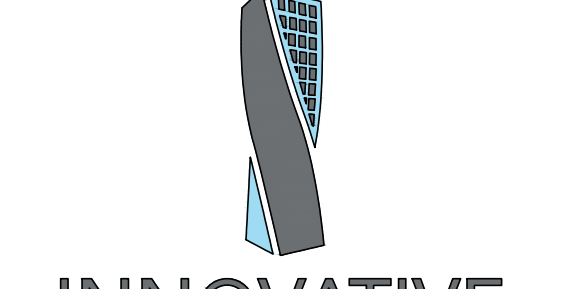

PROJECT NAME:

PROJECT MANAGER:

PROJECT ADMINISTERED BY:

385 N. ARROWHEAD AVE.

PROJECT # 10.10.1032

SAN BERNARDINO COUNTY FIRE DEPARTMENT:

PROJECT # 10.10.1032

CIP #

CAFM #

1920 DEL ROSA AVE N.

ISSUE INFORMATION:

DATE: 10-03-2022

INFORMATION: PLAN CHECK

DATE: SEPTEMBER 2022

PLOT DATE: 09-28-2022

DRAWING NAME:

SHEET INFORMATION:

STK PROJECT NO.: 374-154-21

SCALE: AS NOTED

DATE: SEPTEMBER 2022

PLOT DATE: 09-28-2022

DRAWING NAME:

SHEET TITLE:

SITE STRUCTURES - ADDITIONAL DETAILS

SHEET NO.:

SD4

GENERAL NOTES

1. THESE DOCUMENTS MAY NOT BE USED FOR ANY REPRODUCTION, BIDDING, OR CONSTRUCTION UNLESS AUTHORIZED, IN WRITING, BY SALAS O'BRIEN AND THE ENGINEER OF RECORD RESPONSIBLE FOR THEIR PREPARATION.
2. ALL BRANCH DUCTS SHALL HAVE BALANCE DAMPERS WITH QUADRANT LOCKS.
3. ALL DUCT SIZES SHOWN ARE NET INSIDE DIMENSIONS.
4. DUCTWORK SHALL BE GALVANIZED SHEET METAL IN COMPLETE CONFORMANCE WITH C.M.C., AND SMACNA HVAC DUCT CONSTRUCTION STANDARDS. FLEXIBLE DUCTS MAY BE USED TO CONNECT INTO AIR OUTLETS AND INLETS. MAXIMUM LENGTH OF FLEXIBLE DUCTWORK SHALL BE 9'-0".
- DUCTWORK ON ROOF SHALL BE INTERNALLY LINED AND PAINTED. ALL JOINTS AND SEAMS SHALL BE WEATHERPROOF.
- ALL BRACING OF DUCTS AND PIPING SHALL BE INSTALLED IN ACCORDANCE WITH SMACNA GUIDELINES.
- DUCTS SERVING TYPE 1 KITCHEN HOODS SHALL BE CONSTRUCTED OF MINIMUM 16 GAUGE CARBON STEEL OR MINIMUM 18 GAUGE STAINLESS STEEL WITH FULLY WELDED JOINTS. DISHWASHER EXHAUST SHALL BE MINIMUM 18 GAUGE STAINLESS STEEL.
5. ALL FLEXIBLE DUCTS SHALL BE INSULATED. MINIMUM BEND RADIUS SHALL BE TWICE THE DUCT DIAMETER.
6. SUPPLY AND RETURN DROPS SHALL BE LINED SHEET METAL PLENUMS.
7. DUCT AND PLENUM INSULATION SHALL BE IN ACCORDANCE WITH THE 2019 CALIFORNIA CODE OF REGULATIONS, TITLE-24, PART 6, ENERGY EFFICIENCY STANDARDS (E.E.S.), TABLE 150.1-A AND THE 2019 CALIFORNIA MECHANICAL CODE (C.M.C.) SECTION 604.0.
8. ALL SHEET METAL DUCTS SHALL BE INSULATED BY MEANS OF FOIL WRAP, 3/4 LB. DENSITY FIBERGLASS INSULATION. INSULATION SHALL BE UL LISTED. DUCT LINERS SHALL BE NON-FIBERGLASS TYPE WITH THICKNESS AS REQUIRED TO MEET T-24 REQUIREMENTS.
9. THERMOSTATS SHALL BE LOCATED AT 4' - 0" ABOVE FINISHED FLOOR (46" MAX. IF MOUNTED OVER CASEWORK OR OTHER OBSTRUCTION) IN ACCORDANCE WITH A.D.A. REQUIREMENTS, UNLESS NOTED OTHERWISE.
10. CONDENSATE DRAIN PIPING SHALL BE COPPER TYPE "L", AND SHALL BE ROUTED TO AN APPROVED RECEPTOR.
11. PROVIDE FLEXIBLE CONNECTIONS AT THE INLET AND OUTLET OF ALL FANS.
12. COORDINATE FINAL LOCATIONS OF AIR DISTRIBUTION DEVICES WITH THE ARCHITECTURAL REFLECTED CEILING PLANS, I.E. LIGHTS, SPEAKERS, TILES AND SPRINKLER HEADS.
13. ALL SUPPLY CEILING DIFFUSERS SHALL HAVE 4-WAY AIR FLOW DISTRIBUTION PATTERNS, UNLESS INDICATED OTHERWISE.
14. COORDINATE FINAL LOCATIONS OF THERMOSTATS WITH ARCHITECT AND OWNER'S REPRESENTATIVE PRIOR TO INSTALLATION. FIELD COORDINATE LOCATIONS WITH OTHER TRADES INCLUDING ELECTRICAL, TELEPHONE, ETC.
15. FIRE/SMOKE DAMPERS SHALL BE INSTALLED ON ALL DUCTWORK PASSING THROUGH FIRE SEPARATING WALLS, AND SHALL BE INSTALLED AS PER 2019 CMC SECTION 605.0, 2019 CBC SECTION 717, AND U.L., LOCAL, STATE, AND N.F.P.A. FIRE CODES.
16. ALL ROOF PENETRATIONS, CUTTING, PATCHING, BLOCKOUTS, STRUCTURAL SUPPORT, ROOF OPENINGS, LEVELING OF PRE-FAB CURBS SHALL BE BY GENERAL CONTRACTOR. CONTRACTOR SHALL VERIFY EXACT ROOF OPENING SIZES WITH UNIT MANUFACTURER PRIOR TO START OF WORK AND SHALL MAKE ALL NECESSARY ADJUSTMENTS AT NO EXTRA COST TO OWNER.
17. LOCATION OF ALL MECHANICAL EQUIPMENT SHOWN ARE SCHEMATIC. CONTRACTOR SHALL FIELD COORDINATE EXACT LOCATIONS AND REQUIRED SERVICE/MAINTENANCE CLEARANCES PRIOR TO START OF WORK.
18. CONTRACTOR SHALL VERIFY WEIGHTS OF ALL MECHANICAL EQUIPMENT WITH THEIR MANUFACTURER PRIOR TO START OF WORK. IF DIFFERENT THAN THE WEIGHTS INDICATED ON DRAWINGS, CONTRACTOR SHALL INFORM THE ARCHITECT AND STRUCTURAL ENGINEER PRIOR TO START OF WORK.
19. CONTRACTOR SHALL VERIFY ALL ELECTRICAL LOADS W/MFR. AND COORDINATE WITH THE ELECTRICAL CONTRACTOR AND THE MANUFACTURER PRIOR TO START OF WORK. NOTIFY THE ARCHITECT, IN WRITING, IN CASE OF ANY DISCREPANCIES, PRIOR TO START OF WORK.
20. ALL HVAC EQUIPMENT, APPLIANCES, AND DUCTWORK SHALL CONFORM TO THE LATEST GUIDELINES OF U.L., A.G.A., N.F.P.A., C.M.C., C.P.C., AND ALL OTHER LOCAL CODES HAVING JURISDICTION.
21. TEST AND BALANCE THE HVAC SYSTEM AS PER REQUIREMENTS OF THE MANDATORY HVAC MEASURES INDICATED ON THIS SHEET.
22. CONTRACTOR SHALL FIELD VERIFY EXACT CEILING SPACE AVAILABLE FOR ROUTING OF DUCT, PRIOR TO START OF WORK, INFORM ARCHITECT, IN WRITING, IN CASE OF ANY DISCREPANCY OR POTENTIAL CONFLICTS PRIOR TO FABRICATING AND/OR PURCHASE OF ANY DUCTWORK.
23. ALL HVAC UNITS SYSTEMS WITH 2000 CFM OR MORE OR SERVING A COMMON AIR SPACE MUST BE INTERCONNECTED TO SHUT DOWN IMMEDIATELY UPON ALARM CONDITION FROM DUCT DETECTORS (OR FIRE ALARM SYSTEM WHEN USING AREA SMOKE DETECTORS IN LIEU OF DUCT DETECTORS) WITHOUT INTERFACE FROM EMS OR ANY OTHER SYSTEMS. ALL CONTROL RELAYS USED FOR SHUT DOWN MUST BE CALIFORNIA STATE FIRE MARSHAL LISTED FOR RELEASING SERVICE.
24. ACCESS PANELS SHALL BE PROVIDED TO ALL EQUIPMENT, MANUAL VOLUME DAMPERS, ETC. LOCATED IN INACCESSIBLE AREAS.
25. MAINTAIN MINIMUM 10'-0" BETWEEN ALL OA INTAKES AND EXHAUST AIR DISCHARGES OR VENTS.

LEGEND

SYMBOL	ABBREV.	DESCRIPTION
		DEMOLITION
		ITEM TO BE RELOCATED
		FLEXIBLE CONNECTION, DUCTWORK
	10x6	DUCT SIZE (1ST NUMBER INDICATES SIDE SHOWN)
	(L)	INTERNALLY LINED DUCTWORK
	TV	SQUARE ELBOW WITH TURNING VANES
		ROUND ELBOW
	MVD	MANUAL VOLUME DAMPER
	BD	BACKDRAFT DAMPER
		FLEXIBLE DUCTWORK
	FSD	FIRE SMOKE DAMPER
	OA	OUTSIDE AIR
		ROUND DUCT UP
		CEILING SUPPLY AIR DIFFUSER (4-WAY THROW UNLESS NOTED OTHERWISE)
	SA	SUPPLY AIR
	RR/RG	RETURN AIR REGISTER/GRILLE
	RA	RETURN AIR
	ER/EG	EXHAUST AIR REGISTER/GRILLE
	EA	EXHAUST AIR
	AP	CEILING ACCESS PANEL
		RECTANGULAR SUPPLY DUCT UP
		RECTANGULAR RETURN DUCT UP
		RECTANGULAR EXHAUST DUCT UP
	TSTAT	THERMOSTAT
	HSTAT	HUMIDISTAT
	S	WALL SWITCH/WALL STAT
	CO	CARBON MONOXIDE SENSOR
	CO2	CARBON DIOXIDE SENSOR
	SD	DUCT MOUNTED SMOKE DETECTOR INTERLOCK WITH FIRE ALARM. SEE ELECT. DWGS.
	TC	TIME CLOCK (ELECTRONIC PROGRAMMABLE)
	TS	TIMER SWITCH
	POC	POINT OF CONNECTION
	POD	POINT OF DISCONNECT
	CFM	CUBIC FEET PER MINUTE
	CHWR	CHILLED WATER RETURN
	CHWS	CHILLED WATER SUPPLY
	HHWR	HEATING HOT WATER RETURN
	HHWS	HEATING HOT WATER SUPPLY
	ACI	AMERICAN CONCRETE INSTITUTE
	A.D.A.	AMERICANS WITH DISABILITIES ACT
	A.F.F.	ABOVE FINISH FLOOR
	A.G.A.	AMERICAN GAS ASSOCIATION
	AL	ALUMINUM
	AMB.	AMBIENT
	APRX.	APPROXIMATE(LY)
	ARCH.	ARCHITECT OR ARCHITECTURAL
	ASCE	AMERICAN SOCIETY OF CIVIL ENGINEERS
	BHP	BRAKE HORSEPOWER
	BLDG	BUILDING
	BTU(H)	BRITISH THERMAL UNIT (PER HOUR)
	B.U.R.	BUILT-UP ROOFING
	CAP.	CAPACITY
	C.B.C.	CALIFORNIA BUILDING CODE
	C.E.C.	CALIFORNIA ENERGY COMMISSION
	C.M.C.	CALIFORNIA MECHANICAL CODE
	C.P.C.	CALIFORNIA PLUMBING CODE
	CD	CONDENSATE DRAIN
	CGBC	CALIFORNIA GREEN BUILDING STANDARDS COMMISSION
	CHW	CHILLED WATER
	CONC.	CONCRETE
	COND.	CONDITIONS
	CONN.	CONNECTIONS
	COORD.	COORDINATE
	C.O.P.	COEFFICIENT OF PERFORMANCE
	CORR.	CORRIDOR
	CU	COPPER
	CW	COLD WATER
	DB	DRY BULB
	DET.	DETAIL
	DIM.	DIMENSIONS
	DN.	DOWN
	DWG(S)	DRAWING(S)

LEGEND (CONT.)


SYMBOL	ABBREV.	DESCRIPTION
	DX	DIRECT EXPANSION
	(E)	EXISTING
	EAT	ENTERING AIR TEMPERATURE
	EDB.	ENTERING DRY BULB
	ENT.	ENTERING
	EQ.	EQUAL
	EWT	ENTERING WATER TEMPERATURE
	EER	ENERGY EFFICIENCY RATIO
	E.E.S.	ENERGY EFFICIENCY STANDARDS
	EFF.	EFFICIENCY
	ELEC.	ELECTRICAL
	ESP	EXTERNAL STATIC PRESSURE (INCHES OF WATER)
	FAB	FABRICATED
	F.A.R.	FREE AREA REQUIRED
	FLA	FULL LOAD AMPS
	FPM	FEET PER MINUTE
	FT.	FEET
	GA.	GAUGE
	GALV.	GALVANIZED
	GPM	GALLONS PER MINUTE
	GSM	GALVANIZED SHEET METAL
	HERS	HOME ENERGY RATING SYSTEM
	HHW	HEATING HOT WATER
	HP	HORSEPOWER
	HSPF	HEATING SEASONAL PERFORMANCE FACTOR
	HVAC	HEATING, VENTILATION AND AIR CONDITIONING
	I.B.C.	INTERNATIONAL BUILDING CODE
	I.M.C.	INTERNATIONAL MECHANICAL CODE
	I.P.C.	INTERNATIONAL PLUMBING CODE
	IN.	INCHES
	IPLV	INTEGRATED PART-LOAD VALUE
	KW	KILOWATT
	LAT	LEAVING AIR TEMPERATURE
	LBS.	POUNDS
	LVG.	LEAVING
	LWT	LEAVING WATER TEMPERATURE
	MECH.	MECHANICAL
	MAX.	MAXIMUM
	MB	MACHINE BOLT
	MBH	1000 BTUH
	MCA	MINIMUM CIRCUIT AMPACITY
	MFR	MANUFACTURER
	MIN.	MINIMUM
	MOCP	MAXIMUM OVERCURRENT PROTECTION
	MTG.	MOUNTING
	MVD	MANUAL VOLUME DAMPER
	NA	NOT APPLICABLE
	N.F.P.A.	NATIONAL FIRE PROTECTION ASSOCIATION
	NIC	NOT IN CONTRACT
	NC	NOISE CRITERIA
	NO.	NUMBER
	OBD	OPPOSED BLADE DAMPER
	OPER.	OPERATING
	OSHPD	OFFICE OF STATEWIDE HEALTH PLANNING AND DEVELOPMENT
	PH	PHASE
	QTY.	QUANTITY
	RECT.	RECTANGLE/RECTANGULAR
	RPM	REVOLUTIONS PER MINUTE
	SEER	SEASONAL ENERGY EFFICIENCY RATIO
	SF	SQUARE FEET
	SQ.	SQUARE
	SMACNA	SHEET METAL AND AIR CONDITIONING CONTRACTORS' NATIONAL ASSOCIATION
	S.M.S.	SHEET METAL SCREW
	S.O.V.	SHUT-OFF VALVE
	SPD	STATIC PRESSURE DROP
	SQFT	SQUARE FEET
	STRUC.	STRUCTURAL
	STL.	STEEL
	TEMP.	TEMPERATURE
	THRU.	THROUGH
	TSP	TOTAL STATIC PRESSURE
	TYP.	TYPICAL
	U/C	UNDERCUT DOOR
	U.L.	UNDERWRITER'S LABORATORIES
	U.F.C.	UNIFIED FACILITIES CRITERIA
	V	VOLTAGE/VOLTS
	VEL.	VELOCITY
	VAV	VARIABLE AIR VOLUME
	VFD	VARIABLE FREQUENCY DRIVE
	WB	WET BULB
	WT.	WEIGHT

MANDATORY HVAC SYSTEM MEASURES

1. ALL WORK INDICATED ON DRAWINGS AND/OR SPECIFICATIONS SHALL BE COORDINATED WITH WORKS OF OTHER TRADES PRIOR TO START OF WORK.
2. ALL HVAC EQUIPMENT LISTED IN SECTION 100(H) OF THE E.E.S. MUST BE C.E.C. CERTIFIED.
3. ALL PIPING INSULATION SHALL BE CONSISTENT WITH THE REQUIREMENTS OF C.M.C. SECTIONS 1201.2 AND TABLE E 502.5, AND E.E.S. SECTION 120.3-A.
4. ALL DUCTWORK INSULATION SHALL BE CONSISTENT WITH THE REQUIREMENTS OF SECTIONS C.M.C. SECTION 604.0 TITLE 24 E.E.S. TABLE 150.1-A.
5. ALL HVAC EQUIPMENT AND APPLIANCE SHALL MEET THE REQUIREMENTS PER SECTIONS 110.1-110.2, 110.5 AND 120.1-120.7 E.E.S.
6. ALL HVAC SYSTEMS SHALL MEET THE CONTROL REQUIREMENTS PER SECTION 110.2 AND 120.2 E.E.S.
7. ALL VENTILATION SYSTEMS SHALL BE CONSTRUCTED AND INSTALLED IN ACCORDANCE WITH THE C.M.C.
8. THE CONTRACTOR SHALL PROVIDE THE BUILDING OWNER, MANAGER, AND THE ORIGINAL OCCUPANTS A LIST OF THE HEATING, VENTILATION, AND AIR CONDITIONING FEATURES, MATERIALS, AND COMPONENTS INSTALLED IN THE BUILDING AND OPERATING INSTRUCTIONS.
9. INSULATION MATERIAL SHALL MEET THE CALIFORNIA QUALITY STANDARD PER SECTION 120.3 AND 120.4 E.E.S.
10. ALL SPACE CONDITIONING AND VENTILATION SYSTEMS SHALL BE BALANCED TO THE QUANTITIES SPECIFIED IN THESE PLANS, IN ACCORDANCE WITH THE NATIONAL ENVIRONMENTAL BALANCING BUREAU (NEBB) PROCEDURAL STANDARDS, OR ASSOCIATED AIR BALANCE COUNCIL (ABC) NATIONAL STANDARDS. TESTING AND BALANCING SHALL BE DONE BY AN INDEPENDENT QUALIFIED AGENCY.
11. ALL SYSTEMS SHALL PROVIDE THE MINIMUM OUTSIDE AIR AS SHOWN ON THE MECHANICAL DRAWINGS, AND SHALL BE MEASURED AND CERTIFIED BY AN INDEPENDENT QUALIFIED TESTING AGENCY.
12. DUCT INSULATION SHALL HAVE A MINIMUM INSTALLED R-VALUE OF 8.0.
13. DURING CONSTRUCTION, ENDS OF DUCT OPENINGS SHALL BE SEALED AND MECHANICAL EQUIPMENT SHALL BE COVERED TO PROTECT INTEGRITY OF SYSTEM CLEANLINESS.
14. PRIOR TO FINAL APPROVAL OF THE BUILDING, THE LICENSED CONTRACTOR, ARCHITECT, OR ENGINEER IN RESPONSIBLE CHARGE OF THE OVERALL CONSTRUCTION MUST COMPLETE AND SIGN THE GREEN BUILDING STANDARDS CERTIFICATION FORM AND GIVE TO THE BUILDING DEPARTMENT OFFICIAL TO BE FILED WITH THE APPROVED PLANS.
15. PROVIDE TEMPORARY MEANS OF BUILDING VENTILATION DURING CONSTRUCTION IN ACCORDANCE WITH CGBCS SECTION 5.504.1.1.
16. BUILDING FLUSH-OUT SHALL BE PERFORMED AND MONITORED UPON CONSTRUCTION COMPLETION IN ACCORDANCE WITH CGBCS SECTION 5.504.2.
17. ALL ENVELOPE AND MECHANICAL CERTIFICATE OF ACCEPTANCE FORMS AND ALL RELATED ACCEPTANCE DOCUMENTS SHALL BE SUBMITTED TO THE FIELD INSPECTOR DURING CONSTRUCTION. CERTIFICATE OF OCCUPANCY WILL NOT BE ISSUED UNTIL THESE FORMS ARE REVIEWED AND APPROVED.
18. FOR PROJECTS OVER 10,000 SQUARE FEET IN FLOOR AREA, UNLESS NOTED OTHERWISE, FUNDAMENTAL MEASURES OF EES, LICHON 110.2(C) AND REFERENCE JOINT SYSTEMS SHALL BE PERFORMED IN ACCORDANCE WITH SPECIFICATION SECTION 23 08 00 AND THE CGBCS SECTION 5.410.2.
19. (FOR RESIDENTIAL ONLY) MECHANICAL EXHAUST FANS DIRECTLY EXHAUSTING BATHROOMS SHALL BE ENERGY STAR COMPLIANT AND CONTROLLED BY SPACE HUMIDISTAT AS PER CALGREEN CODE SECTION 4.508.1.
20. THERMOSTATIC CONTROLS FOR ALL SINGLE ZONE AIR CONDITIONERS AND HEAT PUMPS SHALL COMPLY WITH THE REQUIREMENTS OF EES, LICHON 110.2(C) AND REFERENCE JOINT APPENDIX J45. THERMOSTAT SHALL BE CAPABLE OF COMMUNICATING THROUGH EITHER (1) AT LEAST ONE EXPANSION PORT WITH A REMOVABLE MODULE TO ENABLE COMMUNICATION; OR (2) ON BOARD COMMUNICATION DEVICE.
21. DUCTWORK SHALL BE LEAK TESTED IN ACCORDANCE WITH SMACNA HVAC AIR DUCT LEAKAGE TEST MANUAL FOR A REPRESENTATIVE TOTAL NOT LESS THAN 10% OF INSTALLED DUCTWORK IN ACCORDANCE WITH THE REQUIREMENTS OF CMC 603.10.

VEHICLE EXHAUST SYSTEM NOTES

- A. THE GENERAL CONTRACTOR SHALL PROVIDE:
1. ADEQUATE ACCESS TO THE JOB SITE.
 2. INFORMATION ON CONSTRUCTION SCHEDULING TO FACILITATE PROGRESSIVE INSTALLATION.
 3. ELECTRICAL POWER TO THE VEHICLE EXHAUST CONTROL PANEL. (208V/3)
 4. ELECTRICAL POWER/CONTROL WIRING FROM THE VEHICLE EXHAUST CONTROL PANEL TO THE EXHAUST FAN.
 5. COMPRESSED AIR SOURCE WITH A MINIMUM OF 85 PSI FOR SYSTEM OPERATION.
 6. (4) FOUR OPEN ENDED 1/4" AIR LINES FROM THE STATION AIR SOURCE TO A POSITION ABOVE THE ENDS OF EACH RAIL.
 7. MOUNTING PROVISIONS FOR THE CONTROL PANEL.
 8. NECESSARY STRUCTURE AND BACKING TO SUPPORT VEHICLE EXHAUST RAILS AND SUPPORT SYSTEM USING A MAXIMUM LEG SPACING OF 10 FEET. (COORDINATE WITH ARCHITECT.)
 9. THE CODE REQUIRED FUSE DISCONNECT AT THE FAN.
 10. LOW VOLTAGE CONDUIT FROM THE CONTROL PANEL OR PANELS TO A POINT ABOVE THE CENTER OF EACH TRACK OR RAIL.
 11. ALL NECESSARY LINE AND LOW VOLTAGE WIRING AND CONDUIT TO CONTROL PANEL AND FROM THE CONTROL PANEL TO THE EXHAUST FAN.
 12. EQUIPMENT PAD FOR MOUNTING THE EXHAUST FAN.
 13. FLASHING FOR ROOF/WALL PENETRATIONS.
 14. TREATING/FINISHING OF ALL FLASHING AND EQUIPMENT ASSOCIATED WITH EXHAUST REMOVAL SYSTEM.
- B. THE VEHICLE EXHAUST SUBCONTRACTOR SHALL PROVIDE:
1. STRAIGHT RAIL SYSTEMS.
 2. RADIAL HIGH STATIC EXHAUST FAN, SIZED FOR ADEQUATE AIR FLOW FOR THE NUMBER OF DROPS, AT THE VOLTAGE AND PHASE FOR THE PARTICULAR STATION. AS REQUIRED.
 3. CONTROL PANELS WHICH HOUSE THE MOTOR STARTER, OVERLOAD RELAYS, TIMER, STEP-DOWN TRANSFORMER, AS REQUIRED.
 4. SENSORS TO ACTIVATE THE EXHAUST FAN UPON VEHICLE START-UP. AS REQUIRED.
 5. COMPLETE SUPPORT STRUCTURE FOR TRACKS OR RAILS.
 6. ALL SYSTEM DUCTWORK (MIN. 22 GAGE GALVANIZED STEEL ALL SIZES), HANGERS, AND GRABBERS.
 7. ALL MISC. FITTINGS, AND AIR DRYER, REGULATOR, ETC. FOR COMPLETE SYSTEM OPERATION.
 8. INSTALLATION OF SECONDARY AIRLINES FOR COMPLETE OPERATION OF GRABBERS.
 9. COMPLETE THE CONNECTION OF LOW VOLTAGE WIRING FROM POINT(S) ABOVE RAILS AS PROVIDED BY THE GENERAL CONTRACTOR TO THE PROVIDED PRESSURE SENSORS.
 10. COMPLETE START-UP OF THE SYSTEM.
 11. TRAINING OF THE FIRE FIGHTING CREWS.
 12. TRAINING VIDEO.

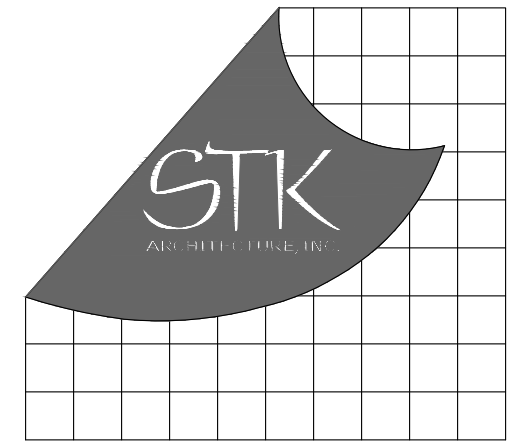

4005 ZEVIO DR., TEMECULA, CALIFORNIA 92590-3760
Phone: 951.296.8110 Fax: 951.296.6079 Email: stk@stkc.com

CONSULTANT:



3200 EXECUTIVE RIDGE
SUITE 210
VISTA, CA 92081
TEL: (760) 564-0100
#21189
www.salasobrien.com
E-Mail: admin@stkgeng.com

PROJECT ADMINISTERED BY:

SAN BERNARDINO COUNTY
PROJECT & FACILITIES
MANAGEMENT DEPARTMENT

385 N. ARROWHEAD AVE.
SAN BERNARDINO, CA 92415

PROJECT NAME:

SAN BERNARDINO
COUNTY FIRE
DEPARTMENT:
FIRE STATION 226

PROJECT # 10J0J032

CIP #21-037

CAFM # SAB198

APN # 0273-011-22

1920 DEL ROSA AVE N.
SAN BERNARDINO,
CA 92404

ISSUE INFORMATION:

DATE:	INFORMATION:
04-11-2022	20% CD SET
04-28-2022	50% CD SET
06-15-2022	95% CD SET
09-16-2022	95% CD- 3rd BAY
10-03-2022	PLAN CHECK

SHEET INFORMATION:

STK PROJECT NO.: 374-154-21
SCALE: AS NOTED
DATE: JANUARY 2021
PLOT DATE:
DRAWING NAME:

SEAL:



SHEET TITLE:
MECHANICAL
LEGEND AND
GENERAL
NOTES

SHEET NO.:

M0.1

DX COOLING COIL SCHEDULE									
TAG	MANUFACTURER & MODEL NO.	CAPACITY (MBH)		DESIGN COND. EDB (°F)	COND. FWB (°F)	CFM	S.P. DROP (IN. WC)	OPER. WEIGHT (LBS.)	REMARKS
		TOTAL	SENSIBLE						
CC 1	CARRIER CVPVA48	48	36	85	67	1400	0.05	50	1 2 3
CC 2	CARRIER CVPVA48	48	36	85	67	1400	0.05	50	1 2 3
CC 3	CARRIER CVPVA48	48	36	85	67	1400	0.05	50	1 2 3
CC 4	CARRIER CVPVA60	60	48	85	67	1750	0.05	50	1 2 3
CC 5	CARRIER CVPVA48	48	36	85	67	1400	0.05	50	1 2 3

- 1 SWEAT SUCTION TUBE & LIQUID TUBE CONNECTIONS. 3 PROVIDE FAN COIL WITH DRAIN PAN AND SECONDARY CONDENSATE DRAIN OVERFLOW CUTOUT SWITCH
- 2 COIL LOCATED ON SUPPLY SIDE OF FORCED AIR UNIT. COIL NUMBER CORRESPONDS WITH FURNACE NUMBER.

AIR DEVICE SCHEDULE					
TAG	MANUFACTURER & MODEL NO.	TYPE	FRAME STYLE	OBD (YES/NO)	REMARKS
A	TITUS PMC	PERFORATED SUPPLY	BORDER TYPE 3	NO	1 2 3 4
B	TITUS PAR	PERFORATED RETURN/EXHAUST	BORDER TYPE 3	NO	1 2 4
C	TITUS MCD	MODULAR CORE SUPPLY	BORDER TYPE 1	YES	1 2 3 4
D	TITUS 350RL	LOUVER FACE RETURN/EXHAUST	BORDER TYPE 3	NO	2 4
E	TITUS 300RL	DOUBLE DEFLECTION SUPPLY	BORDER TYPE 3	NO	2 4

- 1 SQUARE NECK WITH ROUND ADAPTOR. 4 SEE DETAIL 4/M5.1.
- 2 STEEL CONSTRUCTION.
- 3 MODULAR CORE WITH 4-WAY DEFLECTION, U.N.O.

CEILING FAN SCHEDULE										
TAG	MANUFACTURER & MODEL NO.	SERVES	VELOCITY (RPM)	ELECTRICAL DATA					OP. WEGT. (LBS.)	REMARKS
				NO.	HP	AMPS	V	PH.		
F 1	BIG ASS FANS ESSENCE 8-FOOT	APP BAY	158	1	---	10	115	1	75	12345
F 2	BIG ASS FANS ESSENCE 8-FOOT	APP BAY	158	1	---	10	115	1	75	12345
F 3	BIG ASS FANS ESSENCE 8-FOOT	APP BAY	158	1	---	10	115	1	75	12345

- 1 PROVIDE WITH MANUFACTURER'S INSTALLATION KIT. SEE MANUFACTURER'S INSTALLATION MANUAL FOR MOUNTING DETAILS. 4 PROVIDE ALL CONTROL WIRING IN CONDUIT AND ALL ACCESSORIES REQUIRED BY MANUFACTURER FOR PROPER OPERATION.
- 2 INTERLOCK WITH MANUFACTURER'S CONTROLLER.
- 3 PROVIDE WITH DISCONNECT SWITCH BY ELECTRICAL.
- 5 FIELD VERIFY EXACT ELECTRICAL REQUIREMENTS WITH MANUFACTURER AND COORDINATE WITH ELECTRICAL CONTRACTOR PRIOR TO START OF WORK.

UNIT HEATER SCHEDULE													
TAG	MANUFACTURER & MODEL NO.	SERVES	CFM	HEATING		AFUE (%)	FAN		ELECTRICAL			OPER. WEIGHT (LBS.)	REMARKS
				INPUT (MBH)	OUTPUT (MBH)		HP	TYPE	FLA	V	PH		
UH 1	REZNOR UBZ-100	APP BAY	1700	105	87.15	83	3/4	DIRECT	13.2	115	1	200	1 2 3 4
UH 2	REZNOR UBZ-100	APP BAY	1700	105	87.15	83	3/4	DIRECT	13.2	115	1	200	1 2 3 4

- 1 PROVIDE STAINLESS STEEL HEAT EXCHANGER AND SINGLE STAGE GAS VALVE. 3 PROVIDE CONCENTRIC VENT KIT. INSTALL PER MANUFACTURER'S INSTRUCTIONS AND DETAIL 3/M5.2.
- 2 CONTROL BY THERMOSTAT. SEE DETAIL 5/M5.2. MOUNT THERMOSTAT PER DETAIL 1/M5.1.
- 4 PROVIDE MOUNTING HARDWARE. SUPPORT PER DETAIL 6/M5.2.

CONDENSING UNIT (COOLING ONLY) SCHEDULE																		
TAG	MANUFACTURER & MODEL NO.	SERVES	COOLING NET CAPACITY			SEER (EER)	ELECTRICAL								OPER. WEIGHT (LBS.)	REMARKS		
			TOTAL (MBH)	SENSIBLE (MBH)	AMB. (°F)		COMPRESSOR			CONDENSER		FAN		UNIT POWER SUPPLY				
							NO.	RLA	LRA	NO.	HP	FLA	MCA	MOCP	V		PH	
CU 1	CARRIER 24ANB148-31	DORMS	48	36	90	18	1	21.2	104	1	1/5	2.7	29.2	40	208	1	360	①②③④⑤⑥⑦
CU 2	CARRIER 24ANB148-31	DORMS	48	36	90	18	1	21.2	104	1	1/5	2.7	29.2	40	208	1	360	①②③④⑤⑥⑦
CU 3	CARRIER 24ANB148-31	GYM	48	36	90	18	1	21.2	104	1	1/5	2.7	29.2	40	208	1	360	①②③④⑤⑥⑦
CU 4	CARRIER 24ANB160-31	KITCHEN/ LIVING	60	48	90	16.7	1	28.8	153	1	1/5	2.7	38.7	60	208	1	360	①②③④⑤⑥⑦
CU 5	CARRIER 24ANB148-31	FRONT OFFICE	48	36	90	18	1	21.2	104	1	1/5	2.7	29.2	40	208	1	360	①②③④⑤⑥⑦

- 1 PROVIDE REFRIGERANT PIPING AND INSULATION INCLUDING FULL REFRIGERANT CHARGE. SIZE SHALL BE AS PER MFR'S REQUIREMENT AND FINAL DEVELOPED LENGTH. PROVIDE ALL REFRIGERANT ACCESSORIES AS PER MFR'S RECOMMENDATION. VERIFY SIZING WITH MFR'S REP. PRIOR TO INSTALLATION. SEE DETAILS 5/M5.1 AND 6/M5.1.
- 2 PROVIDE WITH CRANKCASE HEATER AND LIQUID LINE SOLENOID VALVE FOR LONG LINE APPLICATIONS.
- 3 PROVIDE WITH EVAPORATOR FREEZE THERMOSTAT, ISOLATION RELAY, LOW-AMBIENT CONTROL KIT AND WINTER START CONTROL KIT FOR LOW-AMBIENT COOLING APPLICATIONS.
- 4 PROVIDE WITH VIBREX VIBRATION ISOLATION TYPE RC 2"x2" NEOPRENE PADS. MOUNT ON LEVEL PLATFORM. SEE DETAIL 8/M5.1.
- 5 PROVIDE WITH FUSED DISCONNECT. FOR CONTROL DIAGRAM. SEE DETAIL 11/M5.1.
- 6 PROVIDE ALL CONTROL WIRING INSIDE CONDUIT AND ALL OTHER ACCESSORIES FOR PROPER OPERATION REQUIRED BY MANUFACTURER.
- 7 FIELD VERIFY EXACT ELECTRICAL REQUIREMENTS WITH MANUFACTURER AND COORDINATE WITH ELECTRICAL CONTRACTOR PRIOR TO START OF WORK.

GAS FURNACE SCHEDULE																			
TAG	MANUFACTURER & MODEL NO.	SERVES	CFM	ESP (IN. WG.)	MIN. OA CFM	INPUT (MBH)	AFUE (%)	ELECTRICAL							FILTERS		OPER. WEIGHT (LBS.)	REMARKS	
								SUPPLY		FAN	UNIT		POWER	SUPPLY		QTY			SIZE
								NO.	HP	FLA	MCA	MOCP	V	PH.					
FAU 1	CARRIER 59SPSA 100-16	DORMS	1400	0.6	200	100	96.5	1	1	12.2	16.1	20	115	1	1	21x20x2	170	1 2 3 4 5 6 7 8 9 10 11 12	
FAU 2	CARRIER 59SPSA 100-16	DORMS	1500	0.6	200	100	96.5	1	1	12.2	16.1	20	115	1	1	21x20x2	170	1 2 3 4 5 6 7 8 9 10 11 12	
FAU 3	CARRIER 59SPSA 100-16	GYM	1400	0.6	200	100	96.5	1	1	12.2	16.1	20	115	1	1	21x20x2	170	1 2 3 4 5 6 7 8 9 10 11 12	
FAU 4	CARRIER 59SPSA 120-22	COMMON	1750	0.6	200	120	96.5	1	1	12.2	16.1	20	115	1	1	25x24x2	190	1 2 3 4 5 6 7 8 9 10 11 12	
FAU 5	CARRIER 59SPSA 100-16	FRONT/ADMIN	1400	0.6	200	100	96.5	1	1	12.2	16.1	20	115	1	1	21x20x2	170	1 2 3 4 5 6 7 8 9 10 11 12	


- 1 FOR FURNACE MOUNTING, SEE DETAIL 7/M5.1. 6 PROVIDE PVC FURNACE FLUE PIPES WITH CONCENTRIC VENT TERMINATION KIT. SIZE SHALL BE BASED ON THE FINAL DEVELOPED LENGTH AND MANUFACTURER'S RECOMMENDATIONS. SEE DETAIL 3/M5.2.
- 2 PROVIDE WITH DUCT MOUNTED SMOKE DETECTOR. SEE FLOOR PLAN FOR LOCATION. SEE ELECTRICAL PLAN FOR POWER REQUIREMENTS.
- 3 PROVIDE UV EMITTERS. 80 WATT/120V/1PH.
- 4 PROVIDE DOOR SWITCH.
- 5 PROVIDE NATURAL GAS BURNER.
- 7 PROVIDE WITH PROGRAMMABLE THERMOSTAT. SEE DETAIL 1/M5.1.
- 8 PROVIDE UL 900 (CLASS 1 OR 2) (MERV-13) PLEATED FILTER.
- 9 PROVIDE WITH STAINLESS STEEL DRAIN PAN.
- 10 PROVIDE WITH FUSED DISCONNECT. FOR CONTROL DIAGRAM, SEE DETAIL 11/M5.1.
- 11 PROVIDE ALL CONTROL WIRING INSIDE CONDUIT AND ALL OTHER ACCESSORIES FOR PROPER OPERATION REQUIRED BY MANUFACTURER.
- 12 FIELD VERIFY EXACT ELECTRICAL REQUIREMENTS WITH MANUFACTURER AND COORDINATE WITH ELECTRICAL CONTRACTOR PRIOR TO START OF WORK.

EXHAUST FAN SCHEDULE														
TAG	MANUFACTURER & MODEL NO.	SERVES	CFM	ESP (IN. W.G.)	DRIVE TYPE	RPM	BHP (WATTS)	HP (WATTS)	MAX. SONES	V	PH	FAN TYPE	OPER. WEIGHT (LBS.)	REMARKS
EF 1	PLYMOVENT TEV-585-60	PLYMOVENT	2840	6.0	BELT	3480	—	7.5	—	208	3	UTILITY SET	175	1 2 11 12
EF 2	COOK GC-622	ELEC	350	0.25	DIRECT	1137	—	(107)	2.0	115	1	CEILING MOUNT	35	3 4 5 7 8 9 10
EF 3	COOK GC-168	JAN	150	0.25	DIRECT	1093	—	(53)	3.0	115	1	CEILING MOUNT	21	3 4 5 6 8 9 10
EF 4	COOK GC-342	RESTROOM	200	0.25	DIRECT	1620	—	(70)	3.5	115	1	CEILING MOUNT	32	3 4 5 6 8 9 10
EF 5	COOK GC-342	LAUNDRY	200	0.25	DIRECT	1620	—	(70)	3.5	115	1	CEILING MOUNT	32	3 4 5 6 8 9 10
EF 6	COOK GC-342	RESTROOM	200	0.25	DIRECT	1620	—	(70)	3.5	115	1	CEILING MOUNT	32	3 4 5 6 8 9 10
EF 7	COOK GC-622	TEL	350	0.25	DIRECT	1137	—	(107)	2.0	115	1	CEILING MOUNT	35	3 4 5 7 8 9 10
EF 8	COOK GC-342	RESTROOM	200	0.25	DIRECT	1620	—	(70)	3.5	115	1	CEILING MOUNT	32	3 4 5 6 8 9 10
EF 9	COOK GC-342	RESTROOM	200	0.25	DIRECT	1620	—	(70)	3.5	115	1	CEILING MOUNT	32	3 4 5 6 8 9 10
EF 10	COOK GC-342	RESTROOM	200	0.25	DIRECT	1620	—	(70)	3.5	115	1	CEILING MOUNT	32	3 4 5 6 8 9 10

- 1 PROVIDE WITH SPRING TYPE VIBRATION ISOLATION HARDWARE, SILENCER, FLEXIBLE CONNECTIONS, MOTOR GUARD AND BACKDRAFT RAIN CAP. 7 INTERLOCK WITH THERMOSTAT. SEE DETAIL 12/M5.1. SEE FLOOR PLANS FOR LOCATION.
- 2 PROVIDE WITH BACKDRAFT DAMPER.
- 3 PROVIDE WITH INTEGRAL BACKDRAFT DAMPER AND CEILING GRILLE.
- 4 PROVIDE ALL MOUNTING HARDWARE INCLUDING SEISMIC BRACING. SEE DETAIL 9/M5.1.
- 5 PROVIDE THERMAL OVERLOAD PROTECTION ON FAN MOTOR.
- 6 INTERLOCK WITH WALL SWITCH. SEE DETAIL 12/M5.1. SEE FLOOR PLANS FOR THERMOSTAT LOCATION.
- 8 PROVIDE WITH DISCONNECT SWITCH, BY OTHERS.
- 9 PROVIDE ALL CONTROL WIRING IN CONDUIT AND ALL ACCESSORIES REQUIRED BY MANUFACTURER FOR A COMPLETE AND OPERATIONAL SYSTEM.
- 10 FIELD VERIFY EXACT ELECTRICAL REQUIREMENTS WITH MANUFACTURER AND COORDINATE WITH ELECTRICAL CONTRACTOR PRIOR TO START OF WORK.
- 11 PROVIDE WITH CONTROL PANEL (PLYMOVENT MODEL #OS-3). FAN IS RADIAL, CAST ALUM WHEEL, CAST ALUMINUM HOUSING WITH FLEXIBLE CONNECTIONS AND FAN SILENCER. ENTIRE FAN ASSEMBLY SHALL BE INSTALLED INDOORS.
- 12 MECHANICAL CONTRACTOR SHALL PROVIDE FUSED DISCONNECT AND MOTOR STARTED (COORDINATE WITH EXHAUST REMOVAL SYSTEM SUPPLIER). SEE DETAIL 10/M5.1 FOR CONTROL.

SUPPLY FAN SCHEDULE														
TAG	MANUFACTURER & MODEL NO.	SERVES	CFM	ESP (N. W.G.)	DRIVE TYPE	RPM	BHP (WATTS)	HP (WATTS)	MAX. SONES	V	PH	FAN TYPE	OPER. WEIGHT (LBS.)	REMARKS
<div>S1</div>	COOK GN-622	TURN AROUND	350	0.25	DIRECT	1137	—	(107)	2.0	115	1	INLINE	35	①②③④⑤⑥⑦

- 1 PROVIDE WITH BACKDRAFT DAMPER.
- 2 PROVIDE ALL MOUNTING HARDWARE INCLUDING SEISMIC BRACING. SEE DETAIL 9/M5.1.
- 3 PROVIDE THERMAL OVERLOAD PROTECTION ON FAN MOTOR.
- 4 INTERLOCK WITH WALL SWITCH. SEE DETAIL 12/M5.1. SEE FLOOR PLANS FOR THERMOSTAT LOCATION.
- 5 PROVIDE WITH DISCONNECT SWITCH, BY OTHERS.
- 6 PROVIDE ALL CONTROL WIRING IN CONDUIT AND ALL ACCESSORIES REQUIRED BY MANUFACTURER FOR A COMPLETE AND OPERATIONAL SYSTEM.
- 7 FIELD VERIFY EXACT ELECTRICAL REQUIREMENTS WITH MANUFACTURER AND COORDINATE WITH ELECTRICAL CONTRACTOR PRIOR TO START OF WORK.

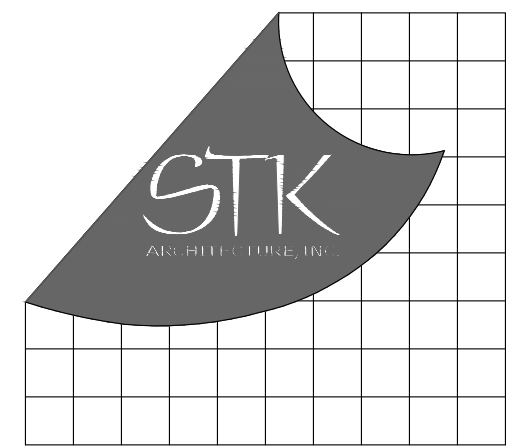

4095 ZEVO DR., TEMECULA, CALIFORNIA 92590-3760
Phone: 951.296.8110 Fax: 951.296.6079 Email: stk@stkc.com

CONSULTANT:



3200 EXECUTIVE RIDGE
SUITE 210
VISTA, CA 92081
TEL: (760) 560-0100
#21189
www.salasobrien.com
E-Mail: admin@stseeng.com

PROJECT ADMINISTERED BY:
SAN BERNARDINO COUNTY
PROJECT & FACILITIES
MANAGEMENT DEPARTMENT

385 N. ARROWHEAD AVE.
SAN BERNARDINO, CA 92415

PROJECT NAME:
SAN BERNARDINO
COUNTY FIRE
DEPARTMENT:
FIRE STATION 226

PROJECT # 10J0J032
CIP #21-037
CAFM # SAB198
APN # 0273-011-22

1920 DEL ROSA AVE N.
SAN BERNARDINO,
CA 92404

ISSUE INFORMATION:	
DATE:	INFORMATION:
04-11-2022	20% CD SET
04-28-2022	50% CD SET
06-15-2022	95% CD SET
09-16-2022	95% CD- 3rd BAY
10-03-2022	PLAN CHECK

SHEET INFORMATION:
STK PROJECT NO.: 374-154-21
SCALE: AS NOTED
DATE: JANUARY 2021
PLOT DATE: -
DRAWING NAME: -

SEAL:



SHEET TITLE:

MECHANICAL
SCHEDULES

SHEET NO.:

M0.2

Project Name:	San Bernardino FS	NRCC-PRF-01-E	Page 1 of 10
Project Address:	1920 Del Rosa Ave. N. San Bernardino 92404	Calculation Date/Time:	16:45, Mon, Jun 13, 2022
Input File Name:	SBFS T-24.cibd19x		

A. GENERAL INFORMATION

1 Project Location (city)	San Bernardino	8 Standards Version	Compliance2019
2 CA Zip Code	92404	9 Compliance Software (version)	EnergyPro 8.2
3 Climate Zone	10	10 Weather File	IVERSIDE_72369_CZ2010.epw
4 Total Conditioned Floor Area in Scope	4,641 ft ²	11 Building Orientation (deg)	[N] 0 deg
5 Total Unconditioned Floor Area	0 ft ²	12 Permitted Scope of Work	NewEnvelopeAndMechanical
6 Total # of Stories (Habitable Above Grade)	1	13 Building Type(s)	Nonresidential
7 Total # of dwelling units	0	14 Gas Type	Natural Gas

B. PROJECT SUMMARY

Table Instructions: Table B shows which building components are included in the performance calculation. If indicated as not included, the project must show compliance prescriptively if within permit application.

Building Components Complying via Performance				Building Components Complying Prescriptively			
Envelope (see Table G)	<input checked="" type="checkbox"/> Performance	Covered Process: Commercial Kitchens	<input type="checkbox"/> Not Included	<input type="checkbox"/> Performance	The following building components are ONLY eligible for prescriptive compliance and should be documented on the NRCC form listed if within the scope of the permit application (i.e. compliance will not be shown on the NRCC-PRF-E).		
	<input type="checkbox"/> Not Included			<input checked="" type="checkbox"/> Not Included			
Mechanical (see Table H)	<input checked="" type="checkbox"/> Performance	Covered Process: Computer Rooms	<input type="checkbox"/> Not Included	<input type="checkbox"/> Performance	Indoor Lighting (Unconditioned)§140.6	NRCC-LTI-E	
	<input type="checkbox"/> Not Included			<input checked="" type="checkbox"/> Not Included	Outdoor Lighting §140.7	NRCC-LTO-E	
Domestic Hot Water (see Table I)	<input type="checkbox"/> Performance	Covered Process: Laboratory Exhaust	<input type="checkbox"/> Not Included	<input type="checkbox"/> Performance	Sign Lighting §140.8	NRCC-LTS-E	
	<input checked="" type="checkbox"/> Not Included			<input checked="" type="checkbox"/> Not Included	Mandatory Measures		
Lighting (Indoor Conditioned, see Table K)	<input type="checkbox"/> Performance	<input type="checkbox"/> Not Included	Electrical power systems, commissioning, solar ready, elevator and escalator requirements are mandatory and should on the NRCC form listed if applicable (i.e. compliance will not be shown on the NRCC-PRF-E).				
	<input type="checkbox"/> Not Included		Electrical Power Distribution §110.11		NRCC-ELC-E		
Solar Thermal Water Heating (see Table L)	<input type="checkbox"/> Performance		Commissioning §120.8		NRCC-CMR-E		
	<input type="checkbox"/> Not Included		Solar Ready §110.10		NRCC-SRA-E		

CA Building Energy Efficiency Standards- 2019 Nonresidential Compliance Report Version: NRCC-PRF-01-E-12202021-6384 Report Generated at: 2022-06-13 16:46:00

Project Name:	San Bernardino FS	NRCC-PRF-01-E	Page 2 of 10
Project Address:	1920 Del Rosa Ave. N. San Bernardino 92404	Calculation Date/Time:	16:45, Mon, Jun 13, 2022
Input File Name:	SBFS T-24.cibd19x		

C1. COMPLIANCE RESULTS FOR PERFORMANCE COMPONENTS (Annual TDV Energy Use, kBtu/ft²-yr)

COMPLIES			
Energy Component	Standard Design (TDV)	Proposed Design (TDV)	Compliance Margin (TDV) ¹
Space Heating	2.04	3.66	-1.62
Space Cooling	84.26	77.34	6.92
Indoor Fans	95.58	38.81	56.77
Heat Rejection	--	--	--
Pumps & Misc.	--	--	--
Domestic Hot Water	8.42	8.42	--
Indoor Lighting	39.55	39.55	--
ENERGY STANDARDS COMPLIANCE TOTAL	229.85	167.78	62.07 (27.0%)

¹ Notes: The number in parenthesis following the Compliance Margin in column 4, represents the Percent Better than Standard.

C2. RESULTS FOR 'ABOVE CODE' QUALIFICATIONS¹

<input type="checkbox"/> This project is pursuing CalGreen Tier 1				<input type="checkbox"/> This project is pursuing CalGreen Tier 2			
Miscellaneous Energy Component		Standard Design (TDV)	Proposed Design (TDV)	Compliance Margin (TDV) ¹			
Receptacle		125.67	125.67	--			
Process		--	--	--			
Other Ltg		--	--	--			
Process Motors		--	--	--			
COMPLIANCE TOTAL PLUS MISCELLANEOUS COMPONENTS		355.52	293.45	62.1 (17.5%)			

¹ Notes: This table is used to document compliance with programs OTHER THAN Title 24 Part 6, if applicable.

CA Building Energy Efficiency Standards- 2019 Nonresidential Compliance Report Version: NRCC-PRF-01-E-12202021-6384 Report Generated at: 2022-06-13 16:46:00

Project Name:	San Bernardino FS	NRCC-PRF-01-E	Page 3 of 10
Project Address:	1920 Del Rosa Ave. N. San Bernardino 92404	Calculation Date/Time:	16:45, Mon, Jun 13, 2022
Input File Name:	SBFS T-24.cibd19x		

C3. ENERGY USE SUMMARY

Energy Component	Standard Design Site (MWh)	Proposed Design Site (MWh)	Margin (MWh)	Standard Design Site (MBtu)	Proposed Design Site (MBtu)	Margin (MBtu)
Space Heating	--	--	--	4.6	8.5	-3.9
Space Cooling	9.9	8.9	1.0	--	--	--
Indoor Fans	15.1	6.1	9.0	--	--	--
Heat Rejection	--	--	--	--	--	--
Pumps & Misc.	--	--	--	--	--	--
Domestic Hot Water	1.4	1.4	0.0	--	--	--
Indoor Lighting	6.3	6.3	0.0	--	--	--
Compliance Total	32.7	22.7	10.0	4.6	8.5	-3.9
Receptacle	19.9	19.9	0.0	--	--	--
Process	--	--	--	--	--	--
Other Ltg	--	--	--	--	--	--
Process Motors	--	--	--	--	--	--
TOTAL	52.6	42.6	10.0	4.6	8.5	-3.9

D. EXCEPTIONAL CONDITIONS

This project includes partial performance compliance scope options. The building must show compliance with all other applicable compliance scope options (performance or prescriptively) before occupying.

The building does not include service water heating. Verify that service water heating is not required and is not included in the design.

This project uses the Simplified Geometry Performance Modeling Approach which is not capable of modeling daylighting controls and assumes the prescriptive Secondary Daylit Control requirements are met. PRESCRIPTIVE COMPLIANCE documentation (form NRCC-LTI-02-E) for the requirements of section 140.6(d) Automatic Daylighting Controls in Secondary Daylit Zones is required.

E. HERS VERIFICATION

This Section Does Not Apply

CA Building Energy Efficiency Standards- 2019 Nonresidential Compliance Report Version: NRCC-PRF-01-E-12202021-6384 Report Generated at: 2022-06-13 16:46:00

Project Name:	San Bernardino FS	NRCC-PRF-01-E	Page 4 of 10
Project Address:	1920 Del Rosa Ave. N. San Bernardino 92404	Calculation Date/Time:	16:45, Mon, Jun 13, 2022
Input File Name:	SBFS T-24.cibd19x		

G1. ENVELOPE GENERAL INFORMATION (conditioned spaces only)

1	2	3	4
Opaque Surfaces & Orientation	Total Gross Surface Area (ft ²)	Total Fenestration Area (ft ²)	Window to Wall Ratio (%)
North-Facing ¹	80 ft ²	0 ft ²	00.0%
East-Facing ²	800 ft ²	128 ft ²	16.0%
South-Facing ³	800 ft ²	64 ft ²	08.0%
West-Facing ⁴	800 ft ²	128 ft ²	16.0%
Total	2,480 ft²	320 ft²	12.9%
Roof	4,641 ft ²	0 ft ²	00.0%

Notes:

¹ North-Facing is oriented to within 45 degrees of true north, including 45°00'00" east of north (NE), but excluding 45°00'00" west of north (NW).

² East-Facing is oriented to within 45 degrees of true east, including 45°00'00" south of east (SE), but excluding 45°00'00" north of east (NE).

³ South-Facing is oriented to within 45 degrees of true south, including 45°00'00" west of south (SW), but excluding 45°00'00" east of south (SE).

⁴ West-Facing is oriented to within 45 degrees of true west, including 45°00'00" north of due west (NW), but excluding 45°00'00" south of west (SW).

G3. OPAQUE SURFACE ASSEMBLY SUMMARY

1	2	3	4	5	6	7	8	9	10
Surface Name	Surface Type	Area (ft ²)	Framing Type	Cavity R-Value	Continuous R-Value	Units	Value	Description of Assembly Layers	Status ¹
Slab On Grade ⁶	Underground Floor	4641	NA	0	NA	F-Factor	0.73	Slab Type = Unheated Slab/Grade Insulation Orientation = None Insulation R-Value = R0	N
R-30 Roof No Attic ⁷	Roof	4641	Wood	30	NA	U-Factor	0.034	Asphalt shingles - 1/4 in. Vapor permeable felt - 1/8 in. Plywood - 1/2 in. Air - Cavity - Wall/Roof Ceiling - 4 in. or more Wood framed roof, 16in. OC, 11.25in. R-30 Gypsum Board - 1/2 in.	N

CA Building Energy Efficiency Standards- 2019 Nonresidential Compliance Report Version: NRCC-PRF-01-E-12202021-6384 Report Generated at: 2022-06-13 16:46:00

Project Name:	San Bernardino FS	NRCC-PRF-01-E	Page 5 of 10
Project Address:	1920 Del Rosa Ave. N. San Bernardino 92404	Calculation Date/Time:	16:45, Mon, Jun 13, 2022
Input File Name:	SBFS T-24.cibd19x		

G3. OPAQUE SURFACE ASSEMBLY SUMMARY

1	2	3	4	5	6	7	8	9	10
Surface Name	Surface Type	Area (ft ²)	Framing Type	Cavity R-Value	Continuous R-Value	Units	Value	Description of Assembly Layers	Status ¹
R-19 Wall10	Exterior Wall	2480	Wood	19	NA	U-Factor	0.072	Stucco - 7/8 in. Vapor permeable felt - 1/8 in. Wood framed wall, 16in. OC, 5.5in., R-19 Gypsum Board - 1/2 in.	N

¹ Status: N - New, A - Altered, E - Existing

G5. FENESTRATION ASSEMBLY SUMMARY

1	2	3	4	5	6	7	8	9
Fenestration Assembly Name / Tag or I.D.	Fenestration Type / Product Type / Frame Type	Certification Method ¹	Assembly Method	Area ft ²	Overall U-Factor	Overall SHGC	Overall VT	Status ²
Double Metal Tinted	Vertical fenestration Fixed/Window Metal Framing	Default Performance	Site Built	320	0.71	0.60	0.77	N

¹ Newly installed fenestration shall have a certified NRCC Label Certificate or use the CEC default tables found in Table 110.6-A and Table 110.6-B. Center of Glass (COG) values are for the glass-only, determined by the manufacturer, and are shown for ease of verification. Site-built fenestration values are calculated per Nonresidential Appendix N46 and are used in the analysis.

² Status: N - New, A - Altered, E - Existing

H1. DRY SYSTEM EQUIPMENT (furnaces, air handling units, heat pumps, VRF, economizers etc.)

1	2	3	4	5	6	7	8	9	10	11	12
Equipment Name	Equipment Type	Qty	Total Heating Output (kBtu/h)	Supp Heat Output (kBtu/h)	Efficiency Unit	Efficiency	Total Cooling Output (kBtu/h)	Efficiency Unit	Efficiency	Economizer Type (if present)	Status ¹
FAUs	SZAC (Split3Phase)	5	80	0	AFUE	94.0	46	SEER EER	15.00 12.50	No Economizer	N

¹ Status: N - New, A - Altered, E - Existing

CA Building Energy Efficiency Standards- 2019 Nonresidential Compliance Report Version: NRCC-PRF-01-E-12202021-6384 Report Generated at: 2022-06-13 16:46:00

Project Name:	San Bernardino FS	NRCC-PRF-01-E	Page 6 of 10
Project Address:	1920 Del Rosa Ave. N. San Bernardino 92404	Calculation Date/Time:	16:45, Mon, Jun 13, 2022
Input File Name:	SBFS T-24.cibd19x		

H2. FAN SYSTEMS SUMMARY¹

1	2	3	4	5	6	7	8	9	10	11	12	13
Name or Item Tag	System Type packaged, DOAS, etc.	Design OA	CFM	CFM	BHP	Watts	Control	CFM	BHP	Watts	Control	Economizer Type (if present)
FAUs	SZAC	139	1600	0.250	218.0	Constant Volume	NA	NA	NA	NA	NA	No Economizer

¹ Status: N - New, A - Altered, E - Existing

H3. EXHAUST FAN SUMMARY

This Section Does Not Apply

H4. Wet System Equipment (boilers, chillers, cooling towers, etc.)

This Section Does Not Apply

H5. SYSTEM SPECIAL FEATURES

1	2	3	4	5	6
System Name	Optimum Start	Window Interlocks per §140.4(e)	Evaporative Cooling	Heat Recovery	Other Controls
FAUs	No Optimum Start	NA	No Evaporative Cooler	No Heat Recovery	No DCV Controls, No DDC No Economizer No Supply Air Temp. Control

Notes: This table includes controls related to the performance path only. For projects using the prescriptive path, mandatory and prescriptive controls requirements are documented on the NRCC-MCH-E.

H6. MECHANICAL VENTILATION

1	2	3	4	5	6	7	8	9
Zone Name	Ventilation Function	# hotel rooms	# of people	# of bedrooms	Supply OA CFM	Exhaust CFM	Conditioned Area (sf)	DCV or Occupant Sensor Controls, or Both
1-Fire Station	Office - Office space	0	23.20	0	696	0	4641	NA

Multifamily or Hotel/Motel Occupancy? (If "Yes", see DOMESTIC/SERVICE HOT WATER SYSTEM SUMMARY)

No

CA Building Energy Efficiency Standards- 2019 Nonresidential Compliance Report Version: NRCC-PRF-01-E-12202021-6384 Report Generated at: 2022-06-13 16:46:00

Project Name:	San Bernardino FS	NRCC-PRF-01-E	Page 7 of 10
Project Address:	1920 Del Rosa Ave. N. San Bernardino 92404	Calculation Date/Time:	16:45, Mon, Jun 13, 2022
Input File Name:	SBFS T-24.cibd19x		

Does the Project include Zonal Systems?

No

H7. ZONAL SYSTEM AND TERMINAL UNIT SUMMARY

1	2	3	4	5	6	7	8	9	10	11	12
System ID	Zone Name	System Type	Rated Capacity (kBtu/h)		Airflow (cfm)		Fan				
			Heating	Cooling	Design	Min.	Min. Ratio	BHP	Watts	Cycles	ECM Motor
1-Fire Station-Tm	1-Fire Station	Uncontrolled	NA	NA	8000	NA	0.00	NA	NA	NA	<input type="checkbox"/>

H8. EVAPORATIVE COOLER SUMMARY

This Section Does Not Apply

CA Building Energy Efficiency Standards- 2019 Nonresidential Compliance Report Version: NRCC-PRF-01-E-12202021-6384 Report Generated at: 2022-06-13 16:46:00

Project Name:	San Bernardino FS	NRCC-PRF-01-E	Page 8 of 10
Project Address:	1920 Del Rosa Ave. N. San Bernardino 92404	Calculation Date/Time:	16:45, Mon, Jun 13, 2022
Input File Name:	SBFS T-24.cibd19x		

L. DECLARATION OF REQUIRED CERTIFICATES OF INSTALLATION

Table Instructions: Selections shall be made by Documentation Author to indicate which Certificates of Installation must be submitted for the features to be recognized for compliance. These documents must be retained and provided to the building inspector during construction and can be found online at: https://www.energy.ca.gov/title24/2019standards/2019_compliance_documents/Nonresidential_Documents/NRCC/

Building Component	Form/Title
Envelope	NRCC-ENV-01-E - Must be submitted for all buildings
Mechanical	NRCC-MCH-01-E - Must be submitted for all buildings

CA Building Energy Efficiency Standards- 2019 Nonresidential Compliance Report Version: NRCC-PRF-01-E-12202021-6384 Report Generated at: 2022-06-13 16:46:00

Project Name:	San Bernardino FS	NRCC-PRF-01-E
---------------	-------------------	---------------

NOT FOR

Project Name:	San Bernardino FS	NRCC-PRF-01-E	Page 10 of 10
Project Address:	1920 Del Rosa Ave. N. San Bernardino 92404	Calculation Date/Time:	16:45, Mon, Jun 13, 2022
Input File Name:	SBFS T-24.cbd19x		

DOCUMENTATION AUTHOR'S DECLARATION STATEMENT

I certify that this Certificate of Compliance documentation is accurate and complete.

Documentation Author Name: Farzad Tadayon

Company: Salas O'Brien Engineers

Address: 3220 Executive Ridge, Suite 210

City/State/Zip: Vista CA 92081

Phone: 760.560.0100

Signature:

Signature Date: 2022-06-13

CEA/HERS Certification Identification (if applicable): M29230

RESPONSIBLE PERSON'S DECLARATION STATEMENT

I certify the following under penalty of perjury, under the laws of the State of California:

1. The information provided on this Certificate of Compliance is true and correct.

2. I am eligible under Division 3 of the Business and Professions Code to accept responsibility for the building design or system design identified on this Certificate of Compliance (responsible designer).

3. The energy features and performance specifications, materials, components, and manufactured devices for the building design or system design identified on this Certificate of Compliance conform to the requirements of Title 24, Part 1 and Part 6 of the California Code of Regulations.

4. The building design features or system design features identified on this Certificate of Compliance are consistent with the information provided on other applicable compliance documents, worksheets, calculations, plans and specifications submitted to the enforcement agency for approval with this building permit application.

5. I will ensure that a completed signed copy of this Certificate of Compliance shall be made available with the building permit(s) issued for the building, and made available to the enforcement agency for all applicable inspections. I understand that a completed signed copy of this Certificate of Compliance is required to be included with the documentation the builder provides to the building owner at occupancy.

Responsible Envelope Designer Name:

Company: STK Architecture

Address: 42095 Zevo Dr.

City/State/Zip: Temecula CA 92590

Phone:

Signature:

Date Signed:

Title:

License #:

Responsible Lighting Designer Name:

Company:

Address:

City/State/Zip:

Phone:

Signature: NOT IN SCOPE

Date Signed:

Title:

License #:

Responsible Mechanical Designer Name: Farzad Tadayon

Company: Salas O'Brien

Address: 3220 Executive Ridge Suite 210

City/State/Zip: Vista CA 92081


Phone: 760.560.0100

Signature:

Date Signed: 06/13/2022

Title: MECHANICAL ENGINEER

License #: M29230

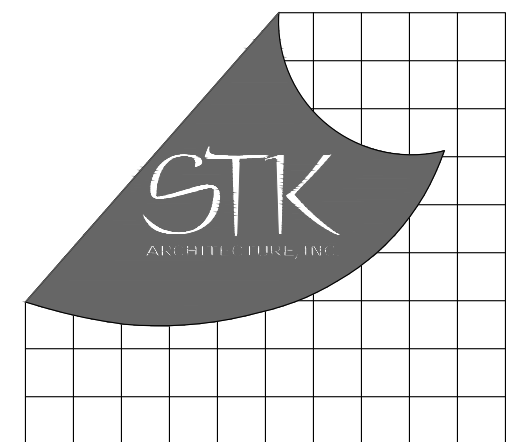

42095 ZEVO DR., TEMECULA, CALIFORNIA 92590-3760
Phone: 951.296.8110 Fax: 951.296.6079 Email: stk@stkinc.com

CONSULTANT:



www.salasobrien.com
E-Mail: admin@stgeng.com

PROJECT ADMINISTERED BY:
SAN BERNARDINO COUNTY
PROJECT & FACILITIES
MANAGEMENT DEPARTMENT

385 N. ARROWHEAD AVE.
SAN BERNARDINO, CA 92415

PROJECT NAME:
SAN BERNARDINO
COUNTY FIRE
DEPARTMENT:
FIRE STATION 226

PROJECT # 10J0J032

CIP #21-037

CAFM # SAB198

APN # 0273-011-22

1920 DEL ROSA AVE N.
SAN BERNARDINO,
CA 92404

ISSUE INFORMATION:

DATE:	INFORMATION:
04-11-2022	20% CD SET
04-28-2022	50% CD SET
06-15-2022	95% CD SET
09-16-2022	95% CD- 3rd BAY
10-03-2022	PLAN CHECK

SHEET INFORMATION:

STK PROJECT NO.: 374-154-21
SCALE: AS NOTED
DATE: JANUARY 2021
PLOT DATE: -
DRAWING NAME:

SEAL:




SHEET TITLE:

TITLE 24

SHEET NO.:

M0.4

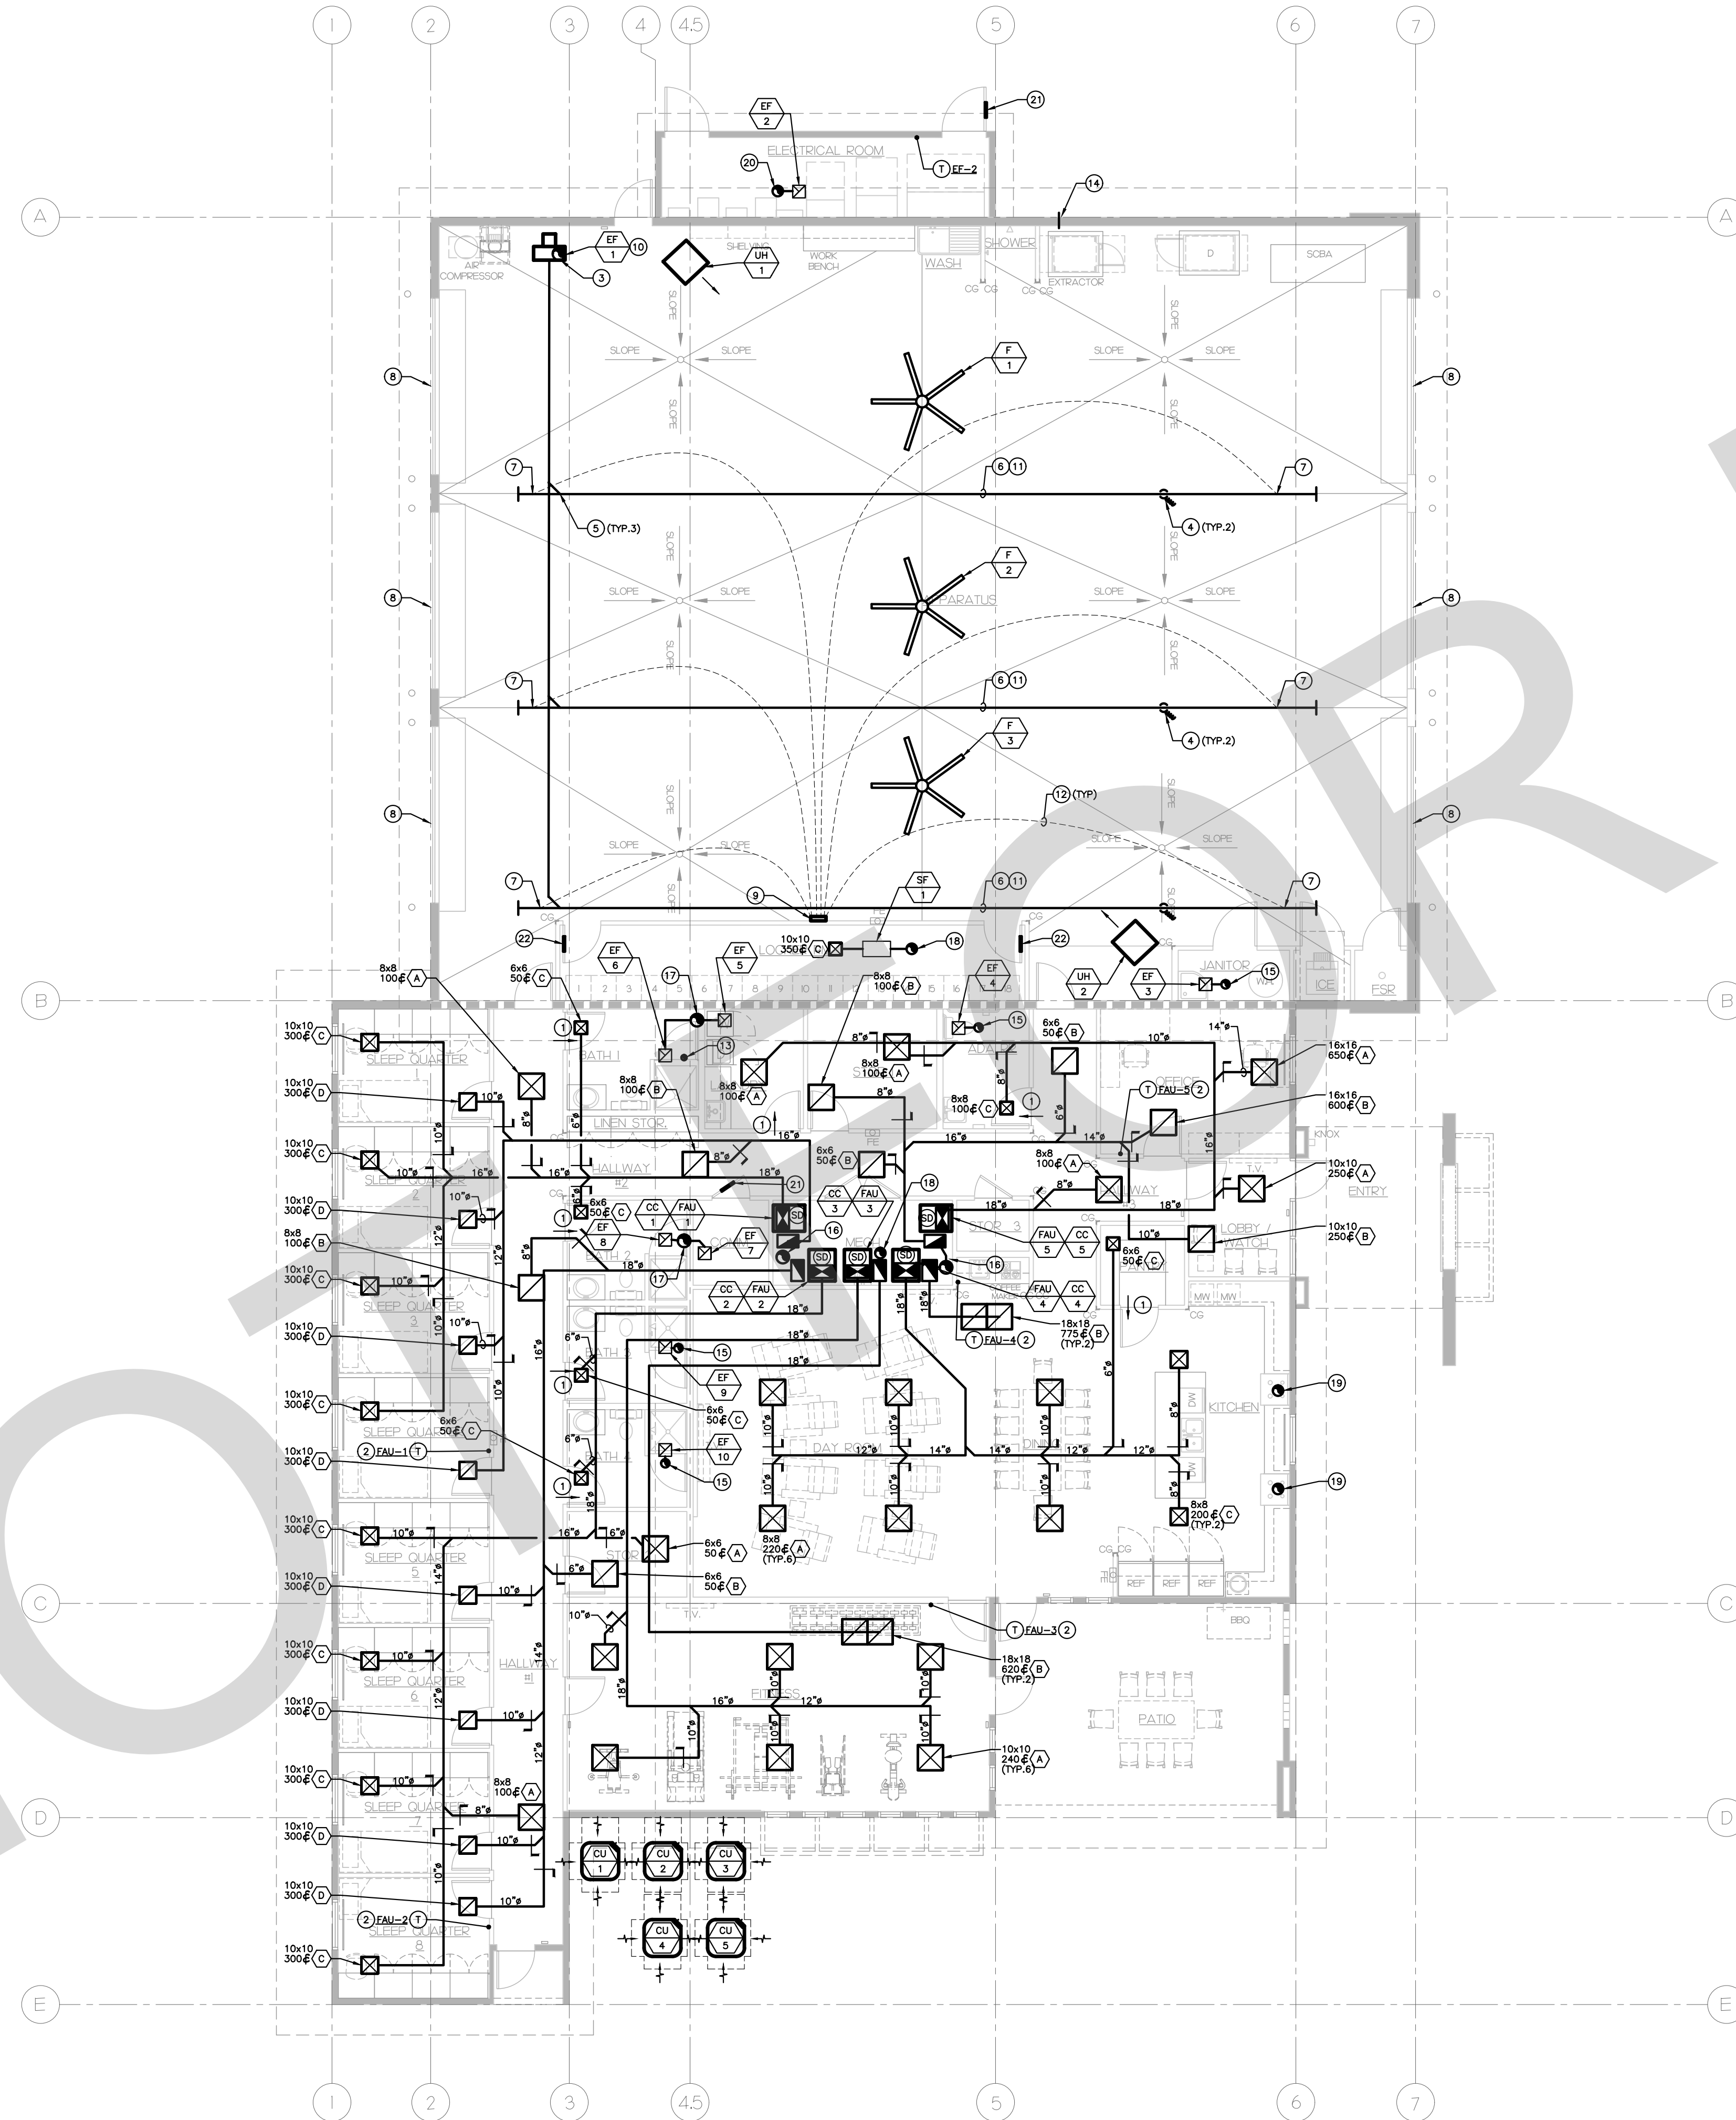

GENERAL NOTES

- A. CONTRACTOR SHALL COORDINATE WITH ALL OTHER TRADES. IN CASE OF DISCREPANCIES OR ANY POTENTIAL CONFLICTS, INFORM THE ARCHITECT AND ENGINEER IN WRITING PRIOR TO START OF WORK.
- B. FOR DUCT TAKE-OFF, SEE DETAIL 3/M5.1.
- C. FOR DUCT SMOKE DETECTOR, SEE DETAIL 7/M5.2.



KEY NOTES

- 1 UNDERCUT DOOR 1".
- 2 FULLY PROGRAMMABLE THERMOSTAT. SEE 1/M5.1.
- 3 12" VEHICLE EXHAUST DUCT UP THRU ROOF TO ROOF CAP. TERMINATE MINIMUM 3' ABOVE FINISHED ROOF. MAINTAIN DUCT MINIMUM 3' AWAY FROM EXTERIOR WALLS AND 10'-0" FROM BUILDING OPENINGS.
- 4 FLEXIBLE EXHAUST HOSE WITH FITTINGS AND CONNECTIONS AS SPECIFIED AND PER MANUFACTURER'S RECOMMENDATIONS.
- 5 7" VEHICLE EXHAUST DUCT, SEE DETAIL 1/M5.2 ATTACHMENT TO RAIL SYSTEM. SEE SPECIFICATIONS FOR MATERIAL, SEE DETAIL 2/M5.2 FOR SUPPORT.
- 6 STRAIGHT RAIL SYSTEM FOR VEHICLE EXHAUST MOUNTING SHALL BE FIELD VERIFIED BY THE MANUFACTURER'S REPRESENTATIVE. SEE ARCHITECTURAL DRAWINGS FOR RAIL SUPPORT. MOUNT BOTTOM OF RAIL AT 14'-0" A.F.F.
- 7 SENSOR LOCATION FOR AUTO START. LOCATION SHALL BE WITHIN 5 FEET OF FRONT AND BACK OF RAIL. PROVIDE COMPRESSOR FITTING FOR ADDITIONAL DETAILS. SEE SPECIFICATIONS AND MANUFACTURER'S INSTALLATION GUIDE.
- 8 ROLL UP APPARATUS DOOR. INSTALL WITHOUT WEATHER STRIPPING TO MAINTAIN 4.5 SF F.A.R. FOR VEHICLE EXHAUST MAKE UP AIR.
- 9 VEHICLE EXHAUST REMOVAL SYSTEM CONTROL PANEL. VERIFY EXACT LOCATION WITH OWNER PRIOR TO START OF WORK. MOUNT AS PER MANUFACTURER'S WRITTEN RECOMMENDATIONS.
- 10 VEHICLE EXHAUST FAN. FOR INSTALLATION, SEE DETAIL 10/M5.1.
- 11 CONTRACTOR SHALL PROVIDE STRUCTURAL CROSS MEMBERS AS REQUIRED BY THE MANUFACTURER FOR SUPPORT OF EXHAUST REMOVAL SYSTEM.
- 12 ROUTE LOW VOLTAGE CONTROL WIRING IN CONDUIT TO SENSOR CONNECTION LOCATION ON EACH RAIL. CONCEAL CONTROL WIRING AND INSTALL AS PER MANUFACTURER'S REQUIREMENTS.
- 13 4" DRYER VENT UP THRU ROOF. PROVIDE WITH DRYER VENT BACK DRAFT DAMPER.
- 14 4" DRYER VENT UP THRU WALL. PROVIDE WITH DRYER VENT BACK DRAFT DAMPER.
- 15 8" EA DUCT UP THRU ROOF TO ROOF CAP.
- 16 12" OA DUCT UP THRU ROOF TO ROOF CAP.
- 17 12" EA DUCT UP THRU ROOF TO ROOF CAP.
- 18 10" OA DUCT UP THRU ROOF TO ROOF CAP.
- 19 10" RANGE VENT DUCT UP THRU ROOF TO ROOF CAP.
- 20 10" EA DUCT UP THRU ROOF TO ROOF CAP.
- 21 18x14 DOOR LOUVER. MINIMUM 0.88 SQFT. F.A.R. SEE ARCHITECTURAL DRAWINGS FOR EXACT SIZE, LOCATION, COLOR AND STYLE.
- 22 12x8 DOOR LOUVER. MINIMUM 0.3 SQFT. F.A.R. SEE ARCHITECTURAL DRAWINGS FOR EXACT SIZE, LOCATION, COLOR AND STYLE.

MECHANICAL FLOOR PLAN

1/8" = 1'-0"

1

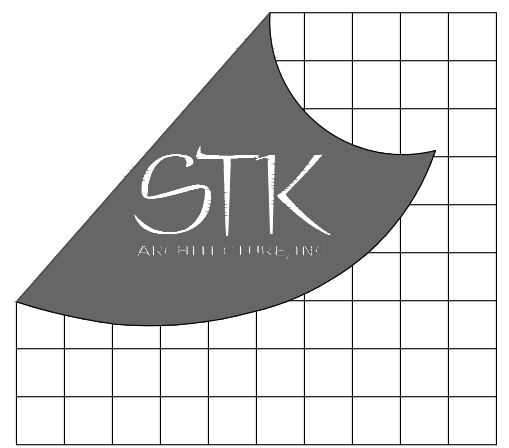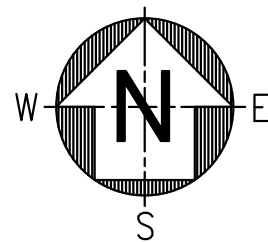

PROJECT ADMINISTERED BY:
SAN BERNARDINO COUNTY
PROJECT & FACILITIES
MANAGEMENT DEPARTMENT

385 N. ARROWHEAD AVE.
SAN BERNARDINO, CA 92415


PROJECT NAME:
SAN BERNARDINO
COUNTY FIRE
DEPARTMENT:
FIRE STATION 226

PROJECT # 10J0J032
CIP #21-037
CAFM # SABI98
APN # 0273-011-22

1920 DEL ROSA AVE N.
SAN BERNARDINO,
CA 92404

ISSUE INFORMATION:	
DATE:	INFORMATION:
04-11-2022	20% CD SET
04-28-2022	50% CD SET
06-15-2022	95% CD SET
09-16-2022	95% CD- 3rd BAY
10-03-2022	PLAN CHECK

SHEET INFORMATION:	
STK PROJECT NO.:	374-154-21
SCALE:	AS NOTED
DATE:	JANUARY 2021
PLOT DATE:	
DRAWING NAME:	

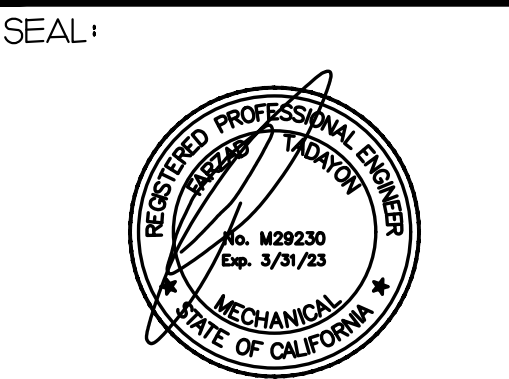

SHEET TITLE:

MECHANICAL
FLOOR PLAN

SHEET NO.:


M2.1

GENERAL NOTES

A. CONTRACTOR SHALL COORDINATE WITH ALL OTHER TRADES. IN CASE OF DISCREPANCIES OR ANY POTENTIAL CONFLICTS, INFORM THE ARCHITECT AND ENGINEER IN WRITING PRIOR TO START OF WORK.

KEY NOTES



1 ROOF CAP. SEE DETAIL 4/M5.2.

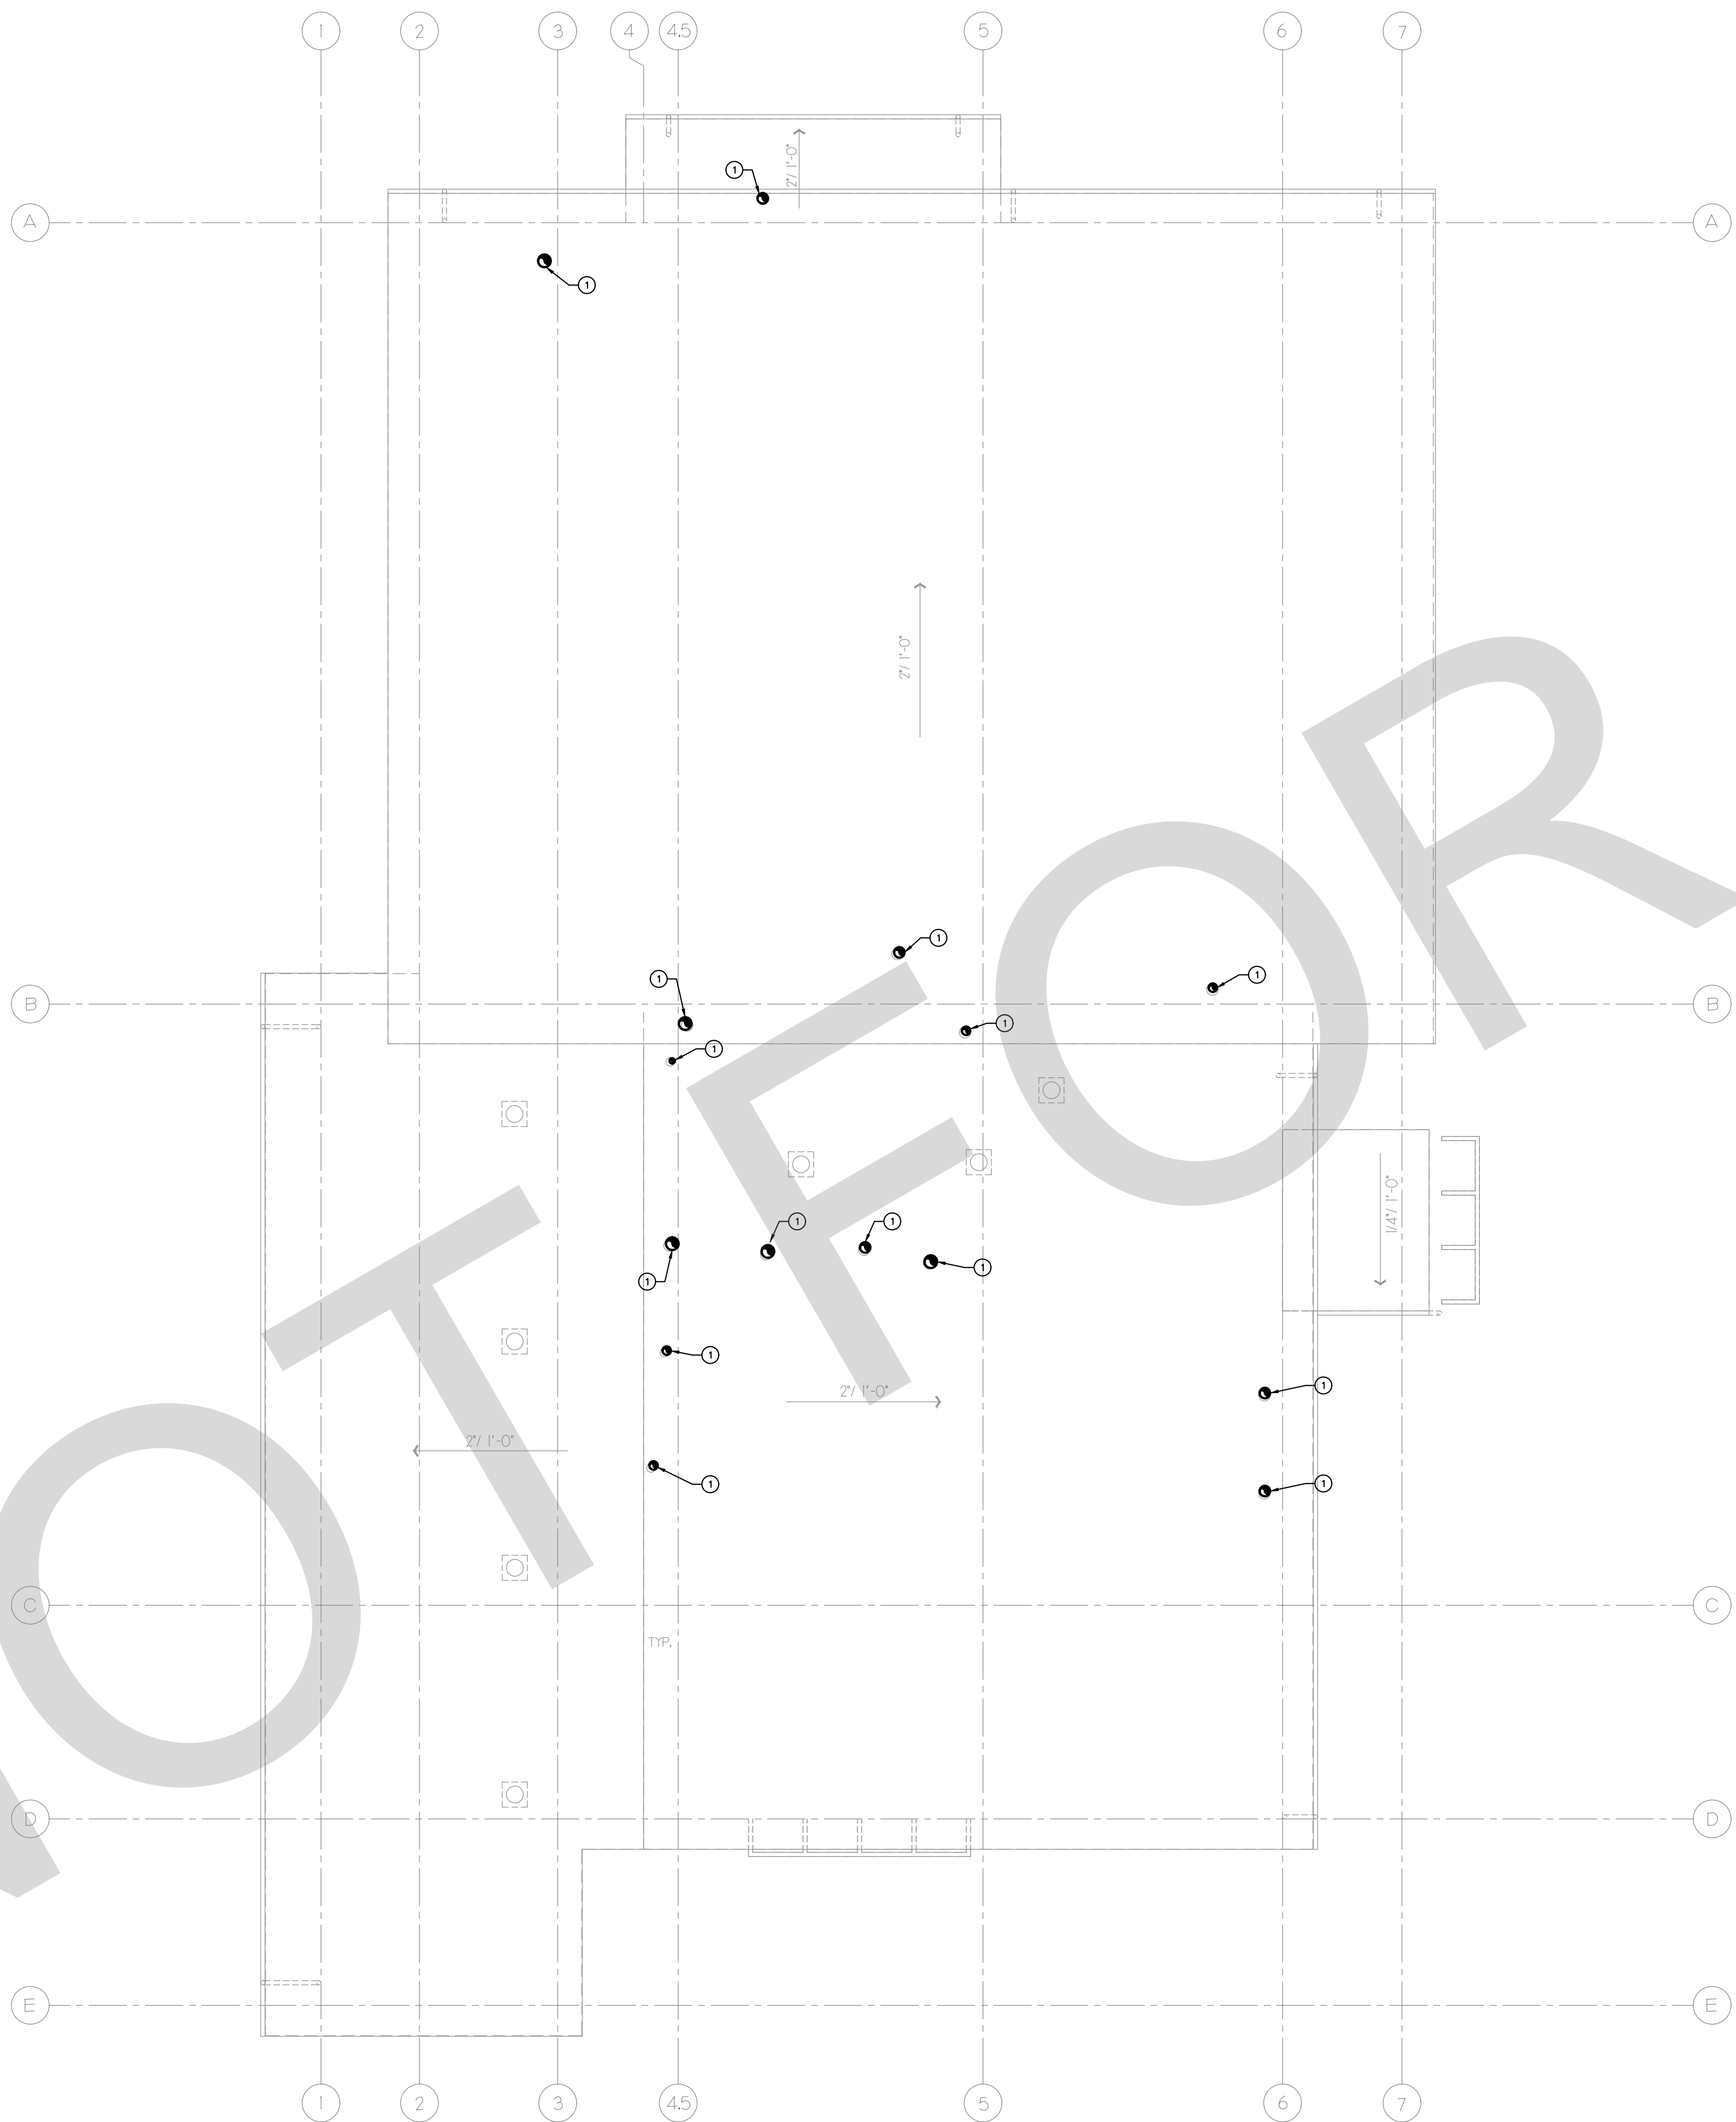

MECHANICAL ROOF PLAN

1/8" = 1'-0"

1

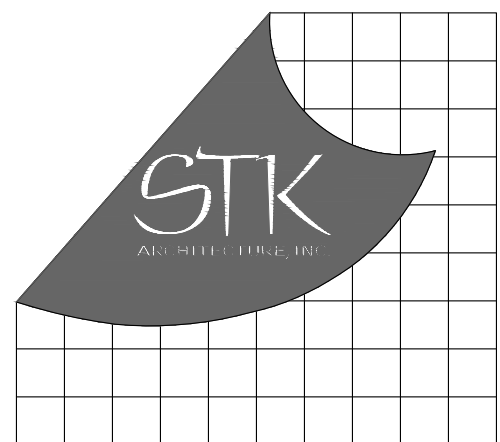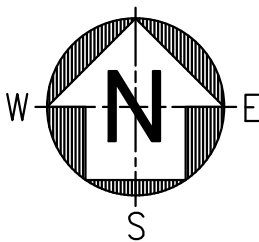

CONSULTANT:



PROJECT ADMINISTERED BY:

SAN BERNARDINO COUNTY
PROJECT & FACILITIES
MANAGEMENT DEPARTMENT

385 N. ARROWHEAD AVE.
SAN BERNARDINO, CA 92415

PROJECT NAME:

SAN BERNARDINO
COUNTY FIRE
DEPARTMENT:
FIRE STATION 226

PROJECT # 10101032

CIP #21-037

CAFM # SAB198

APN # 0273-011-22

1920 DEL ROSA AVE N.
SAN BERNARDINO,
CA 92404

ISSUE INFORMATION:

DATE:	INFORMATION:
04-11-2022	20% CD SET
04-28-2022	50% CD SET
06-15-2022	95% CD SET
09-16-2022	95% CD- 3rd BAY
10-03-2022	PLAN CHECK

SHEET INFORMATION:

STK PROJECT NO.: 374-154-21
SCALE: AS NOTED
DATE: JANUARY 2021
PLOT DATE: -
DRAWING NAME: -

SEAL:







SHEET TITLE:

MECHANICAL
ROOF PLAN

SHEET NO.:

M2.2

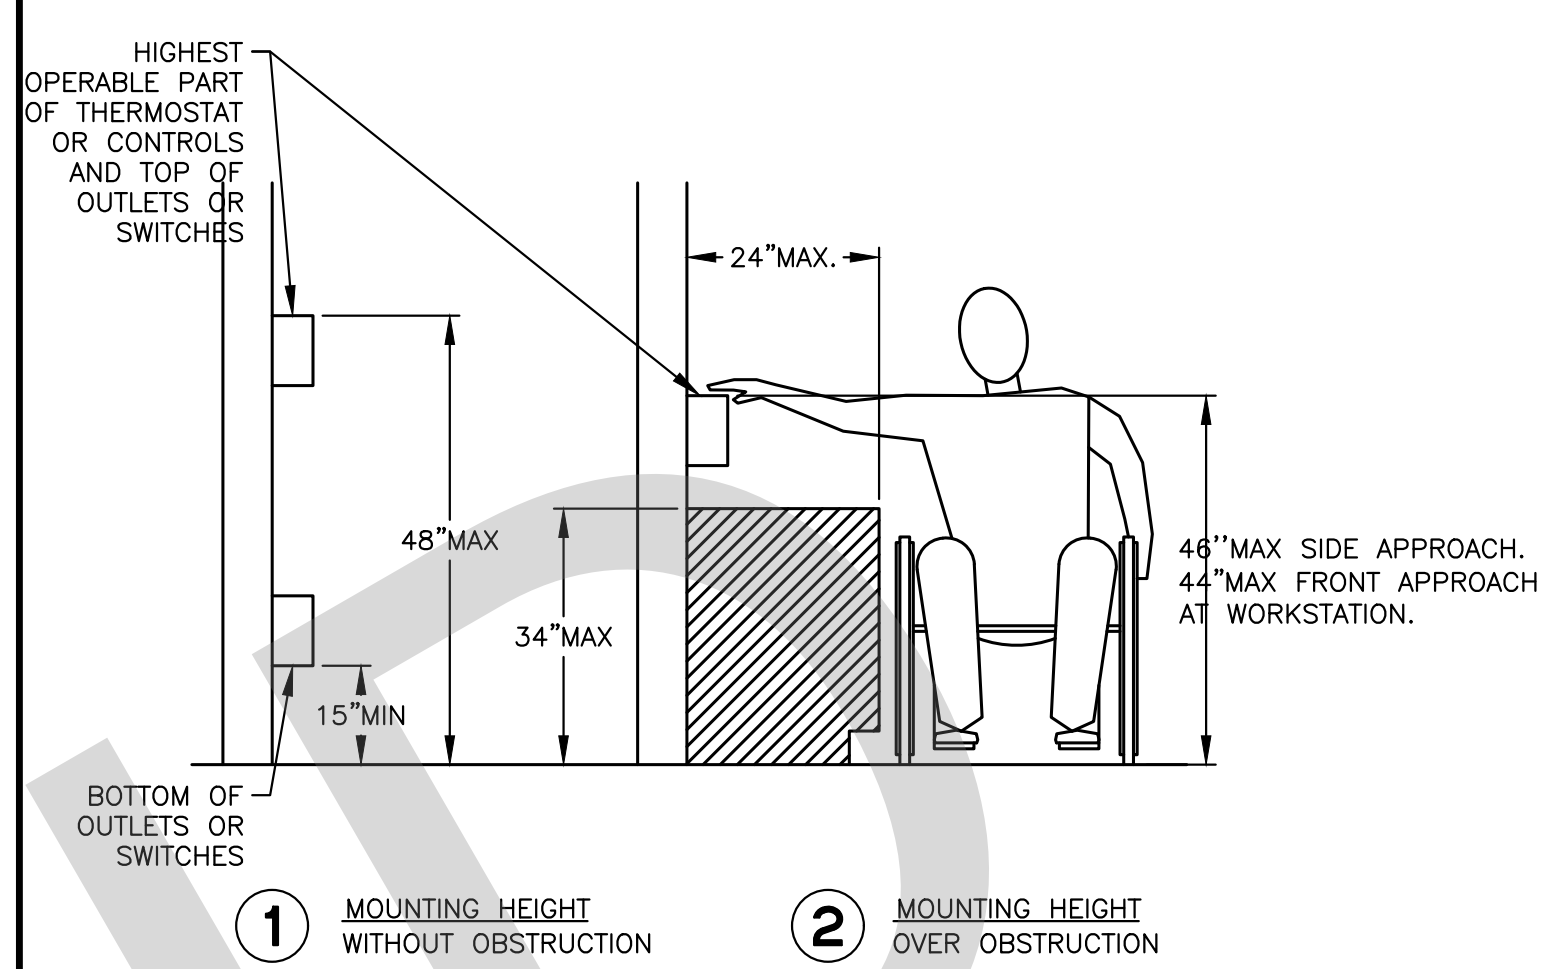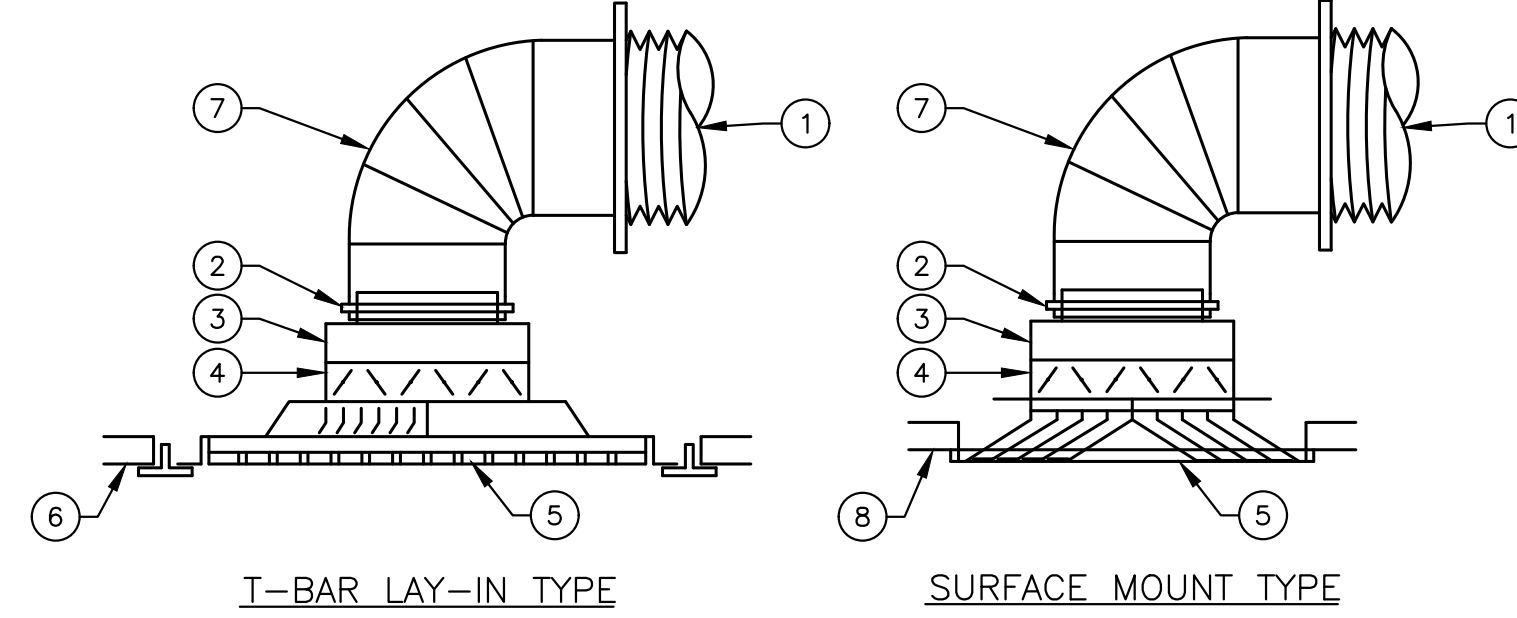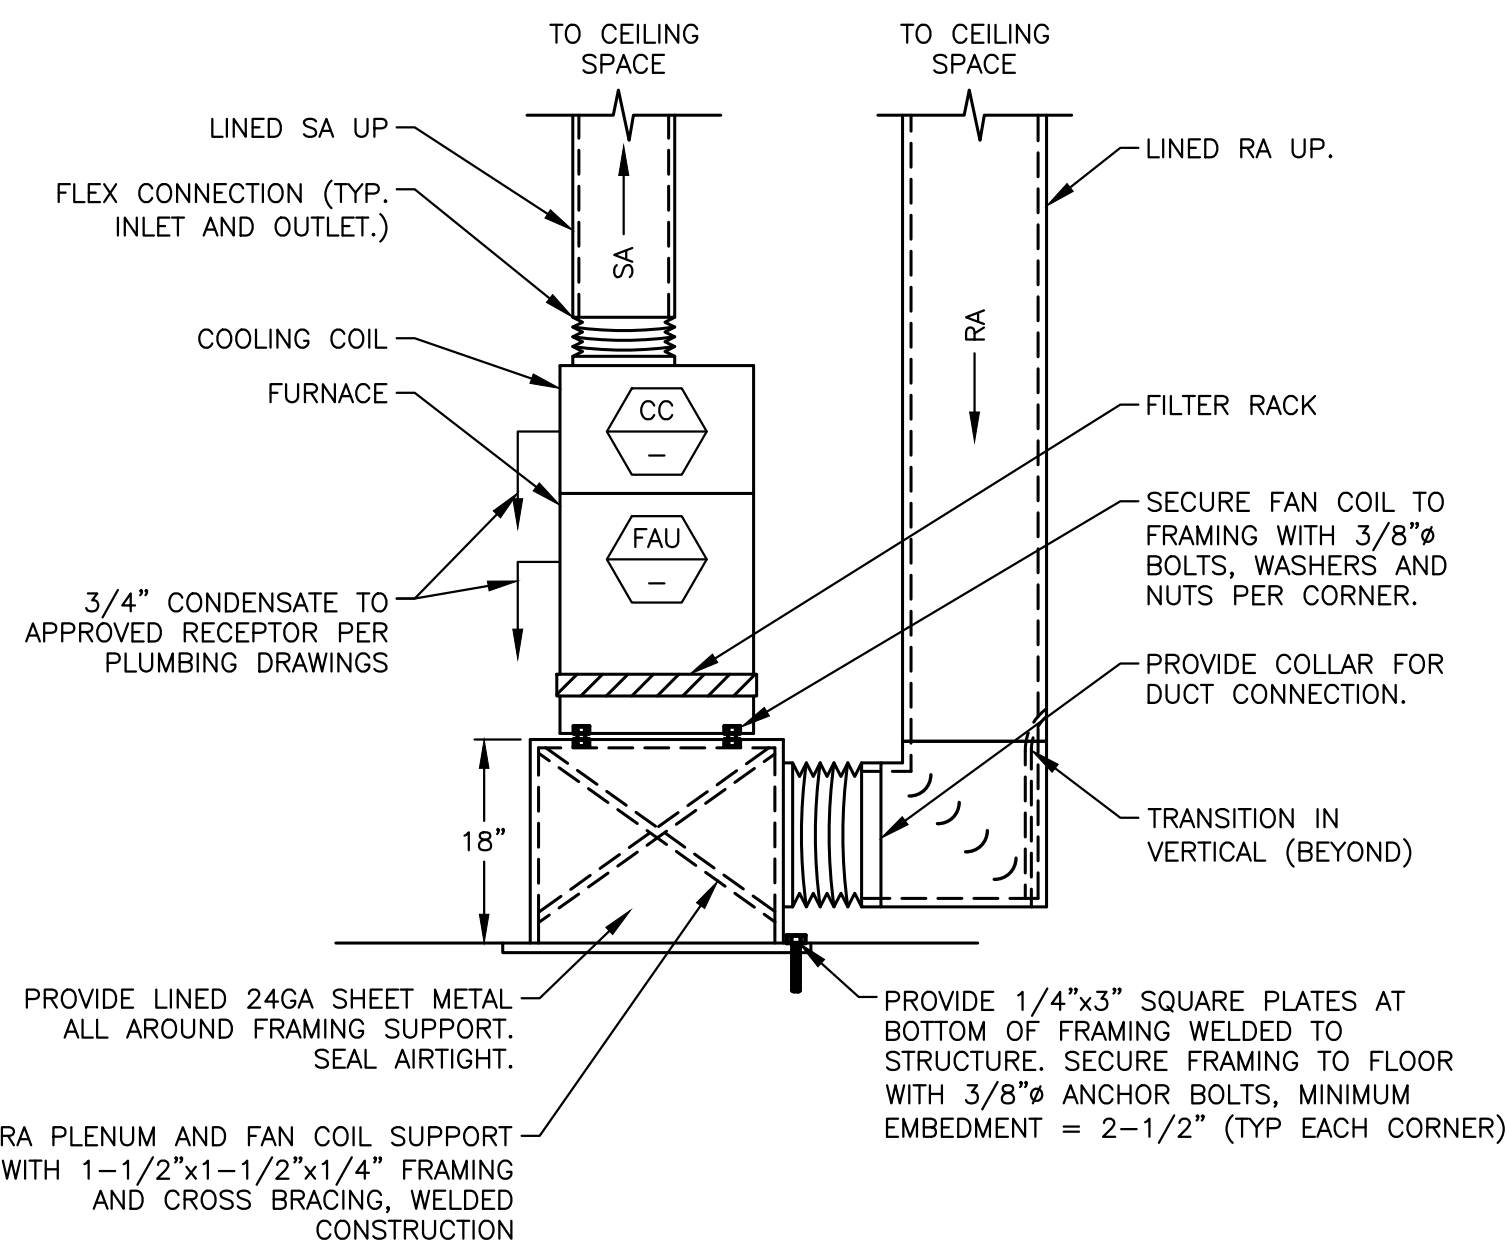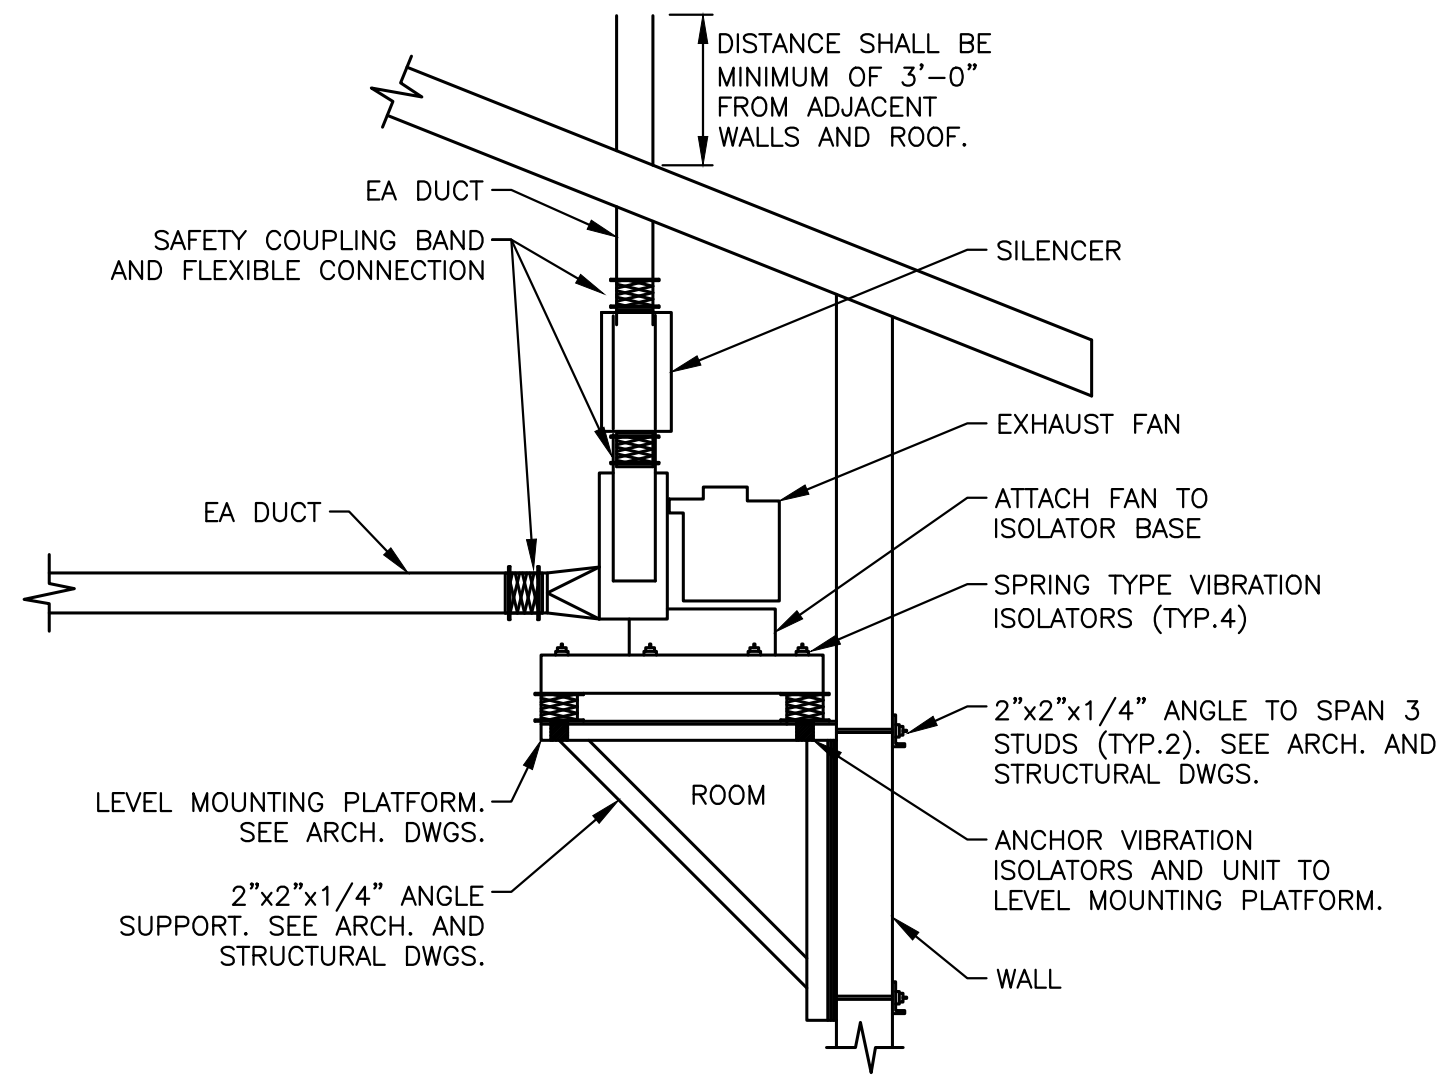

- 1 FLEXIBLE DUCT.
- 2 STAINLESS STEEL CLAMP (NO DUCT TAPE).
- 3 SQUARE TO ROUND ADAPTOR (WHERE INDICATED).
- 4 OPPOSED BLADE DAMPERS (WHERE INDICATED).
- 5 DIFFUSER OR GRILLE.
- 6 LAY-IN T-BAR CEILING.
- 7 RIGID 90° ELBOW.
- 8 HARD-LID CEILING.

VEHICLE EXHAUST FAN MOUNTING DETAIL

SCALE
NONE

VERTICAL FURNACE INSTALLATION DETAIL





SCALE
NONE

CEILING DIFFUSER/REGISTER DETAIL

SCALE
NONE

THERMOSTAT MOUNTING DETAIL

SCALE
NONE

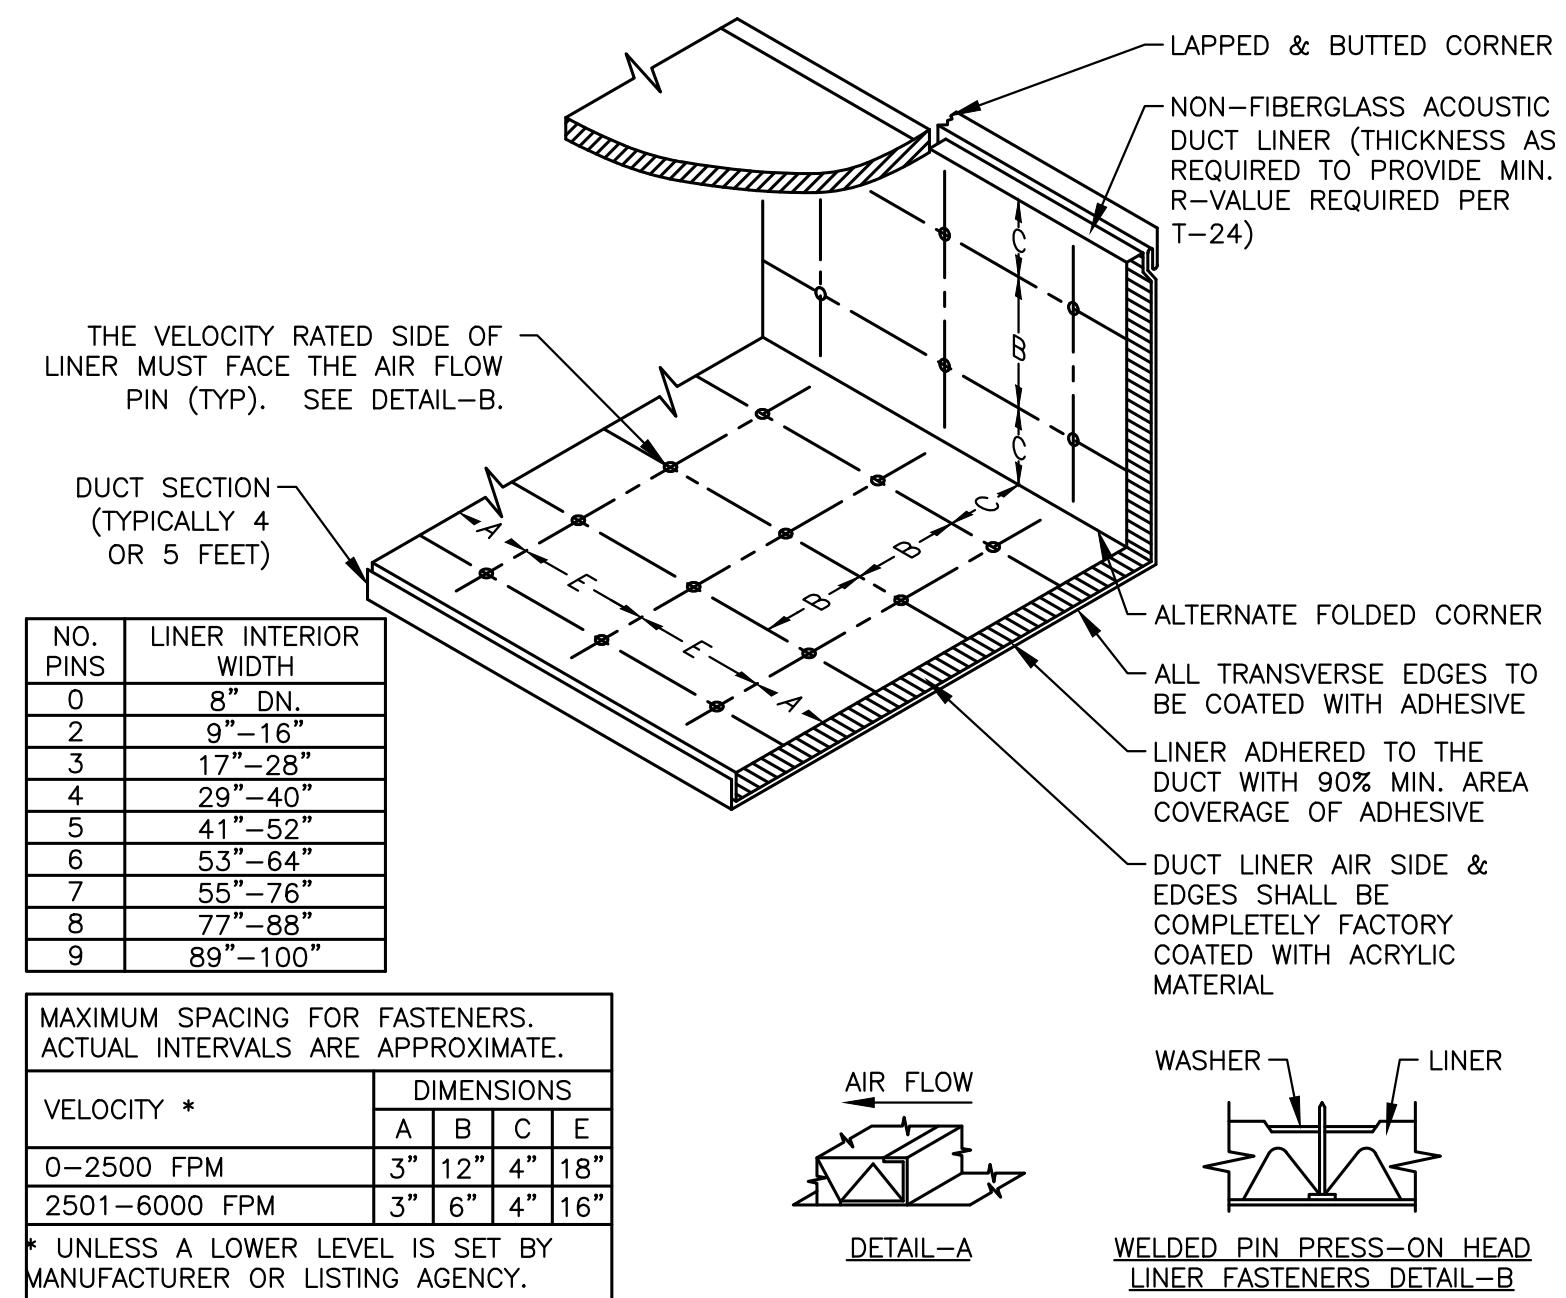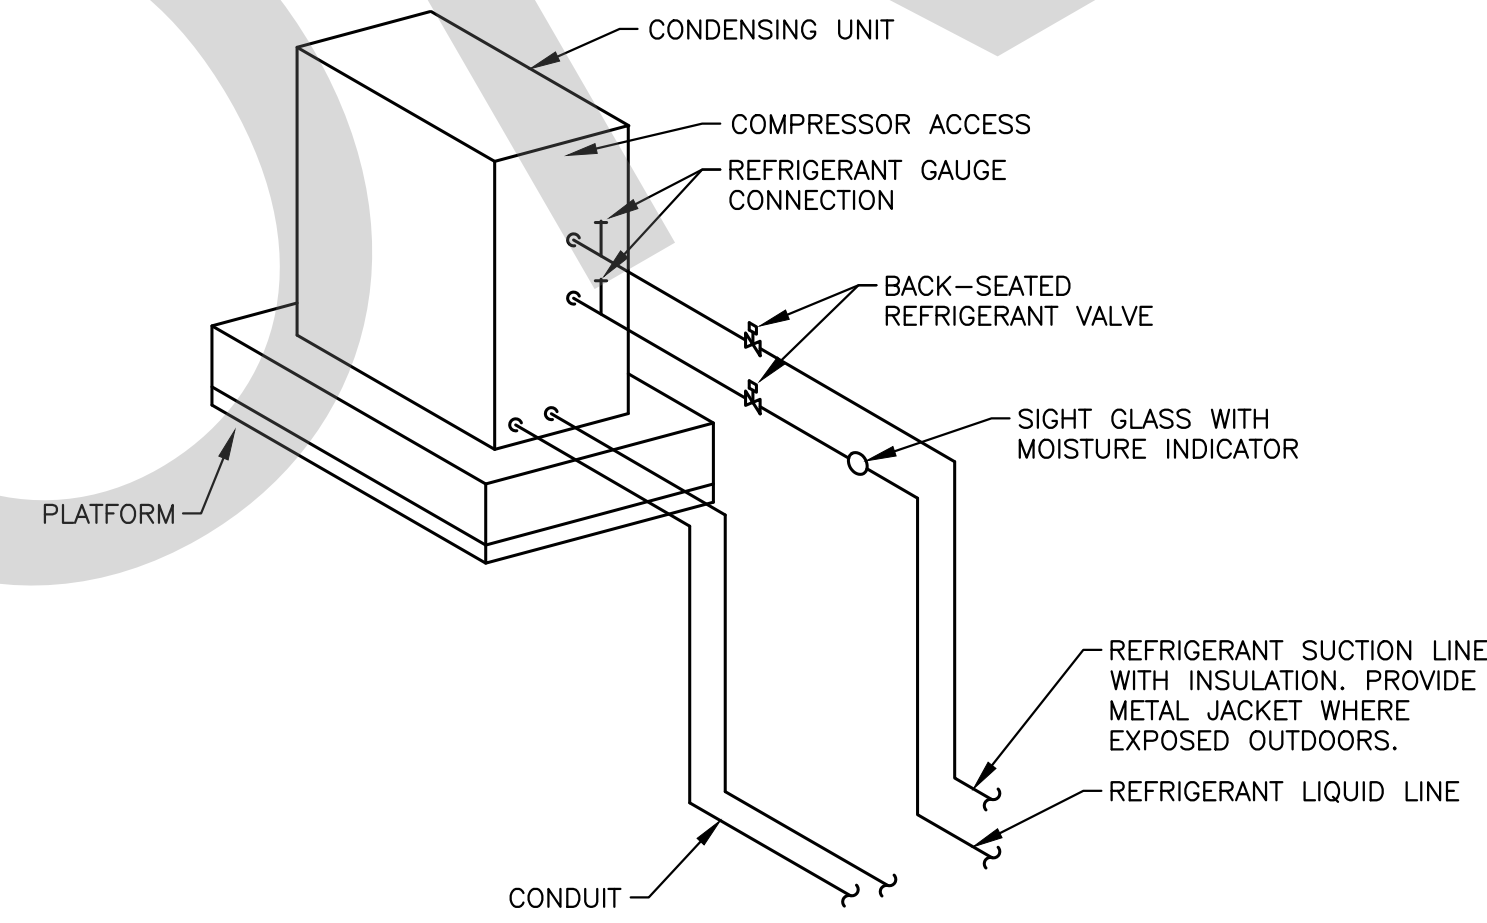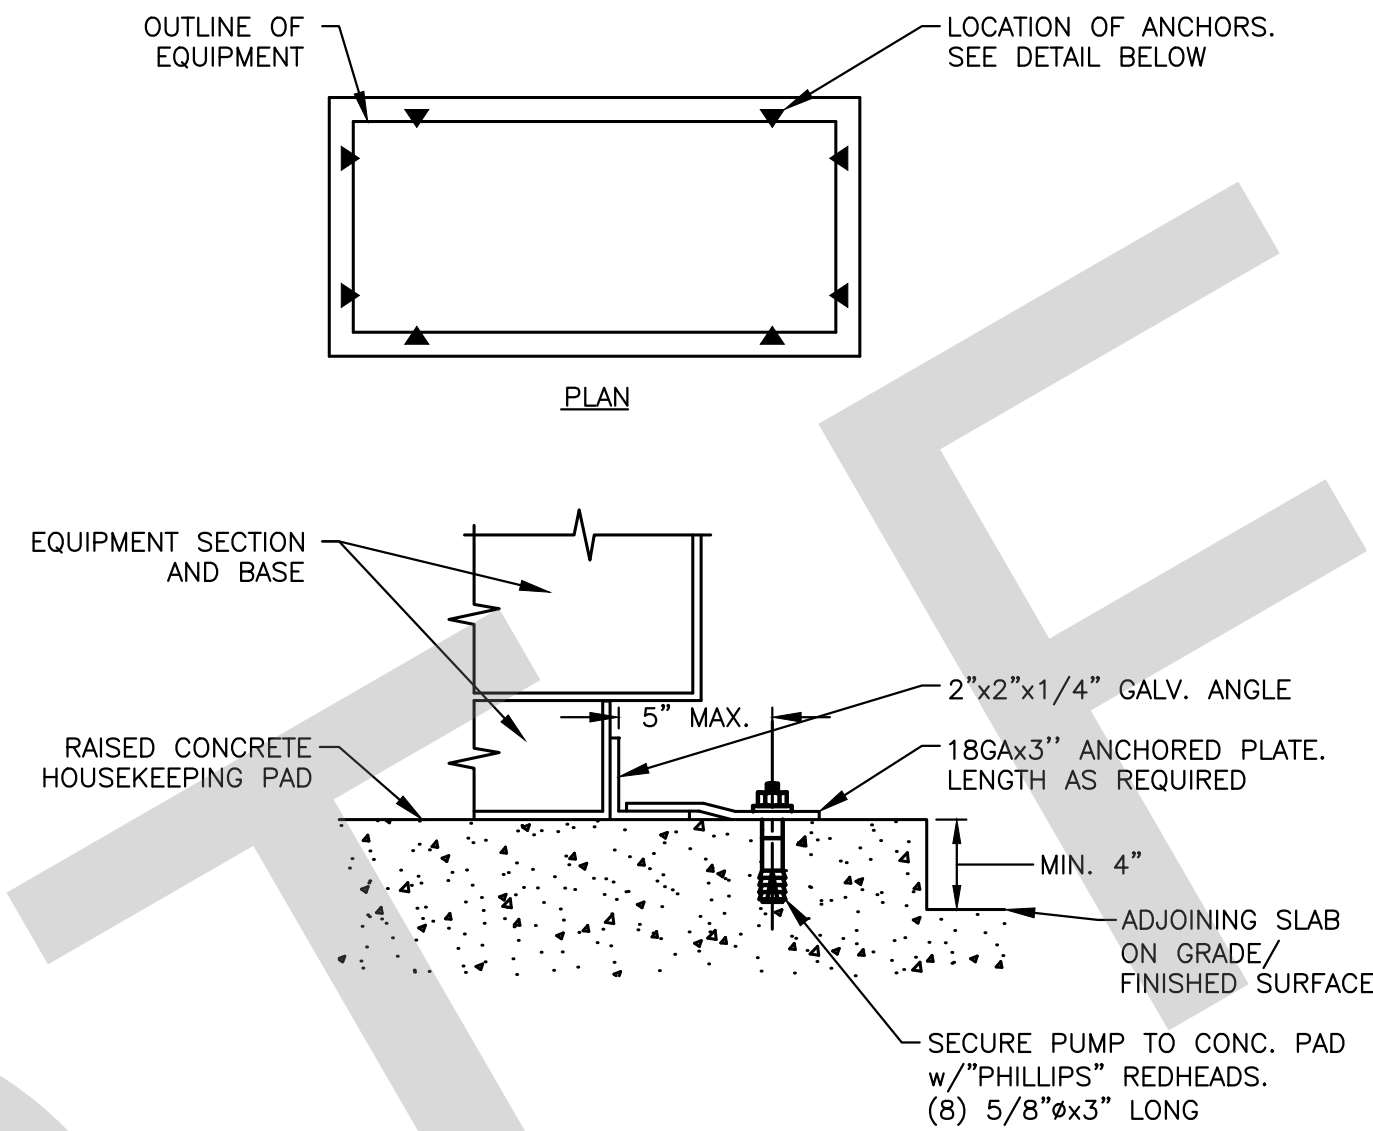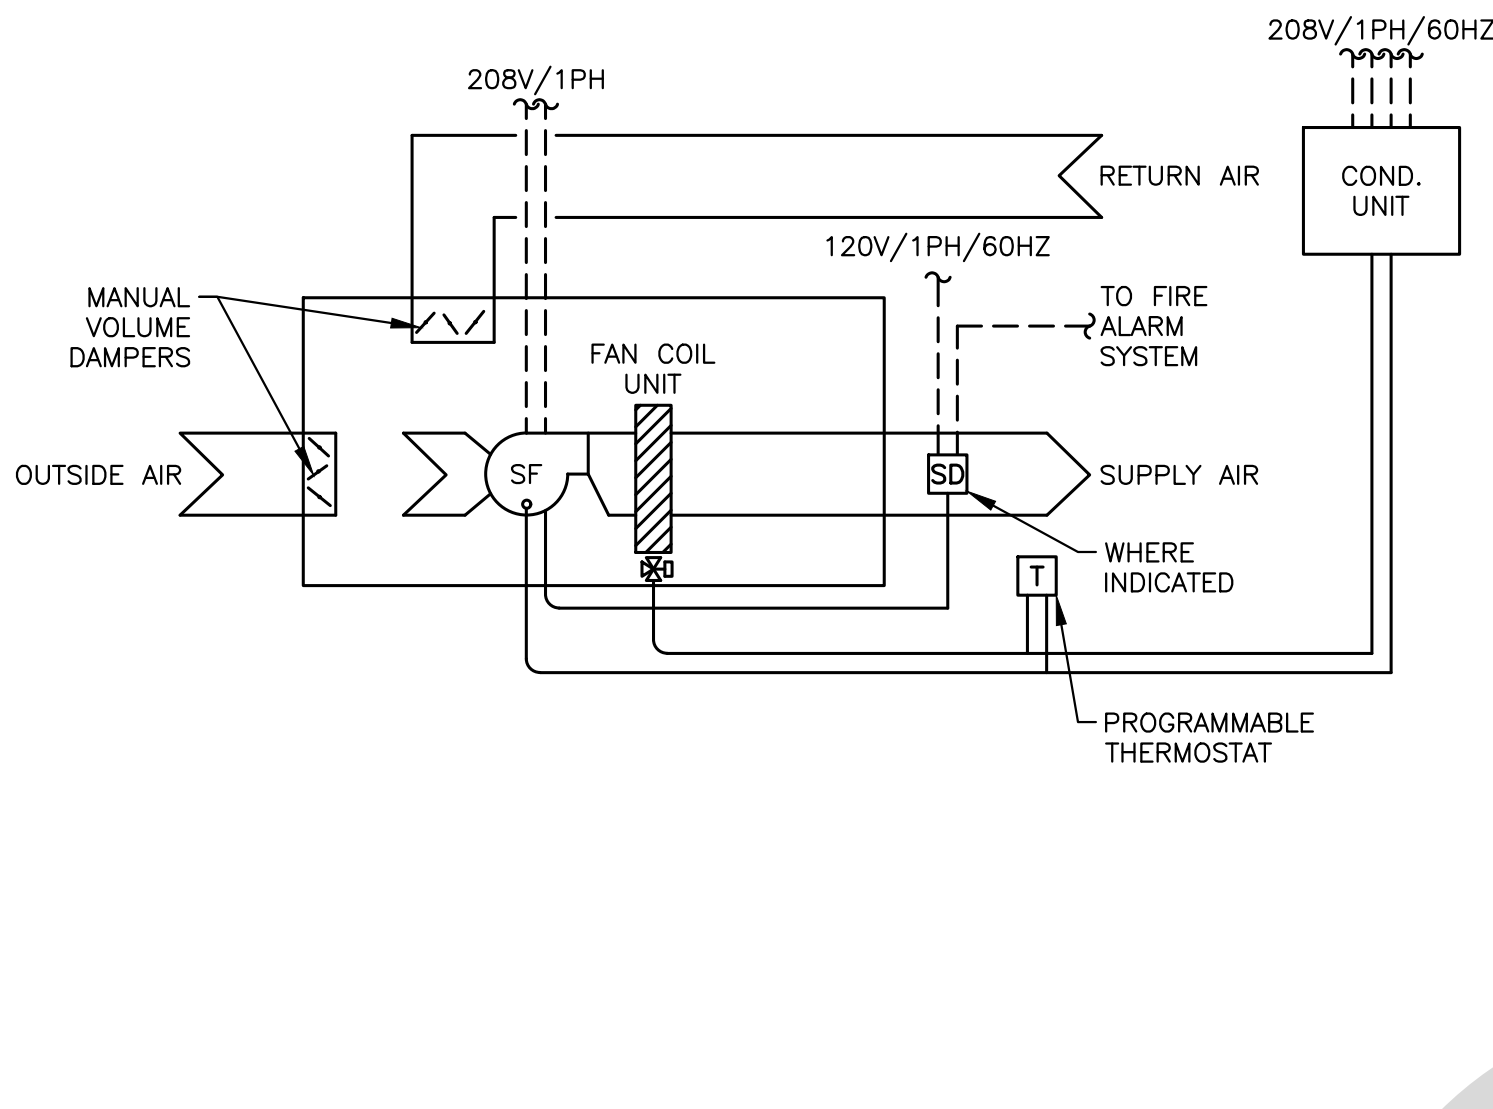

SPLIT SYSTEM HEAT PUMP CONTROL DIAGRAM

SCALE
NONE

CONDENSING UNIT MOUNTING DETAIL





SCALE
NONE

CONDENSING UNIT PIPING DIAGRAM

SCALE
NONE

DUCT LINER DETAIL

SCALE
NONE

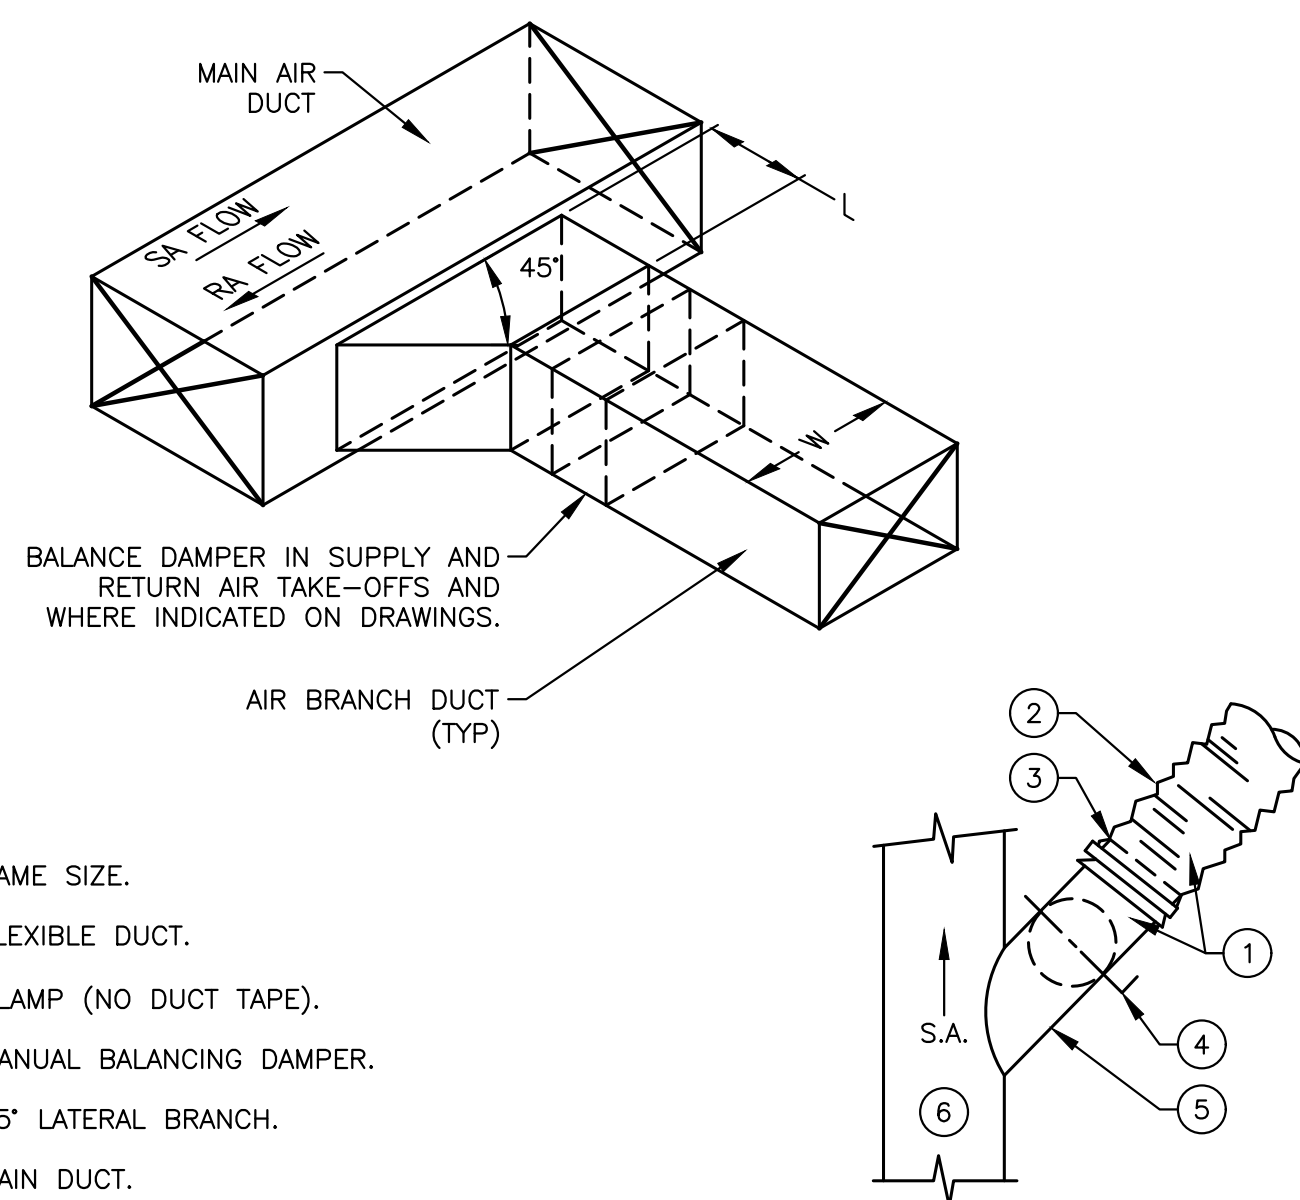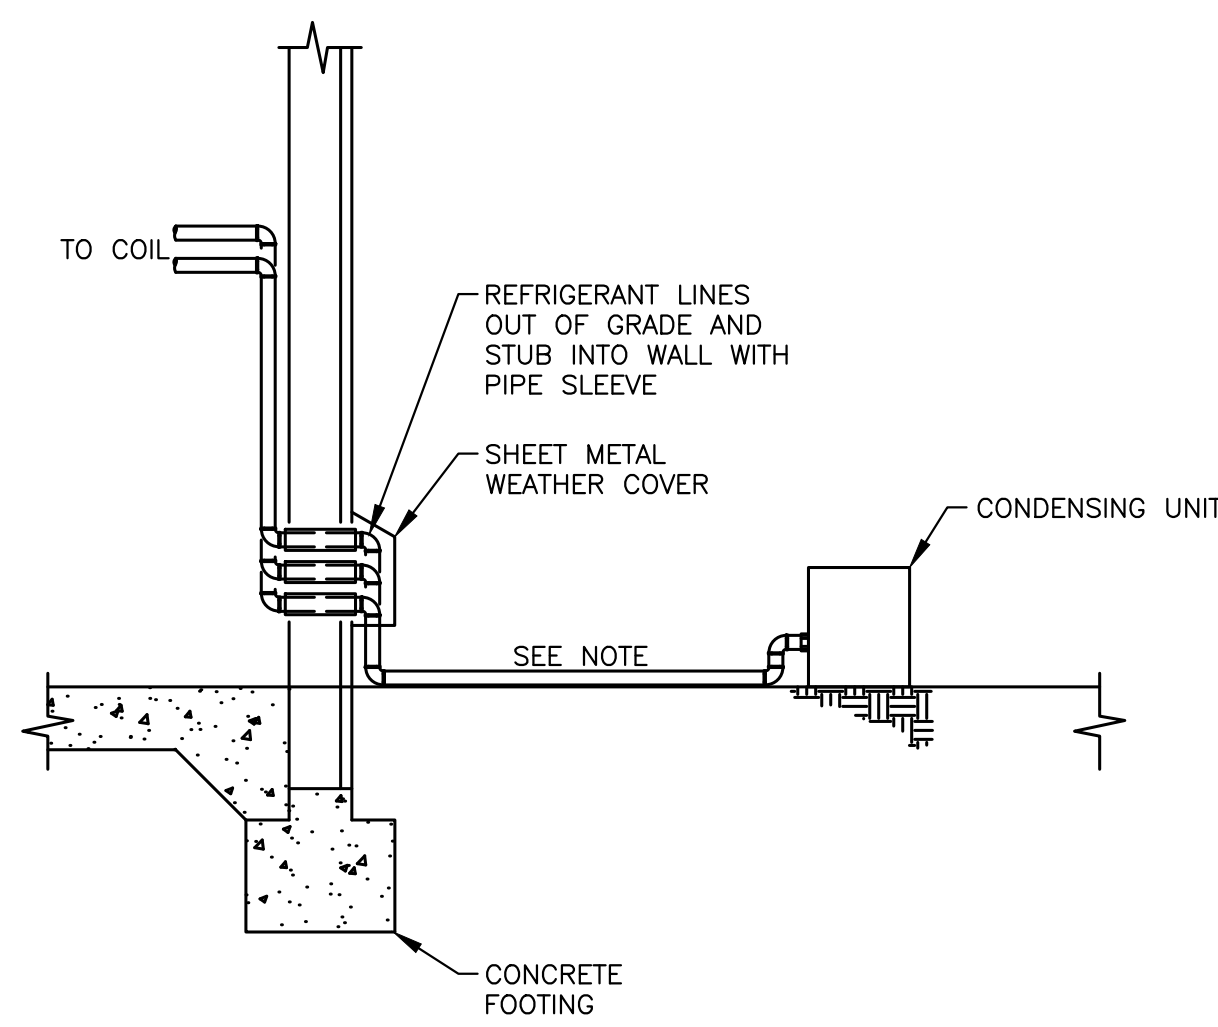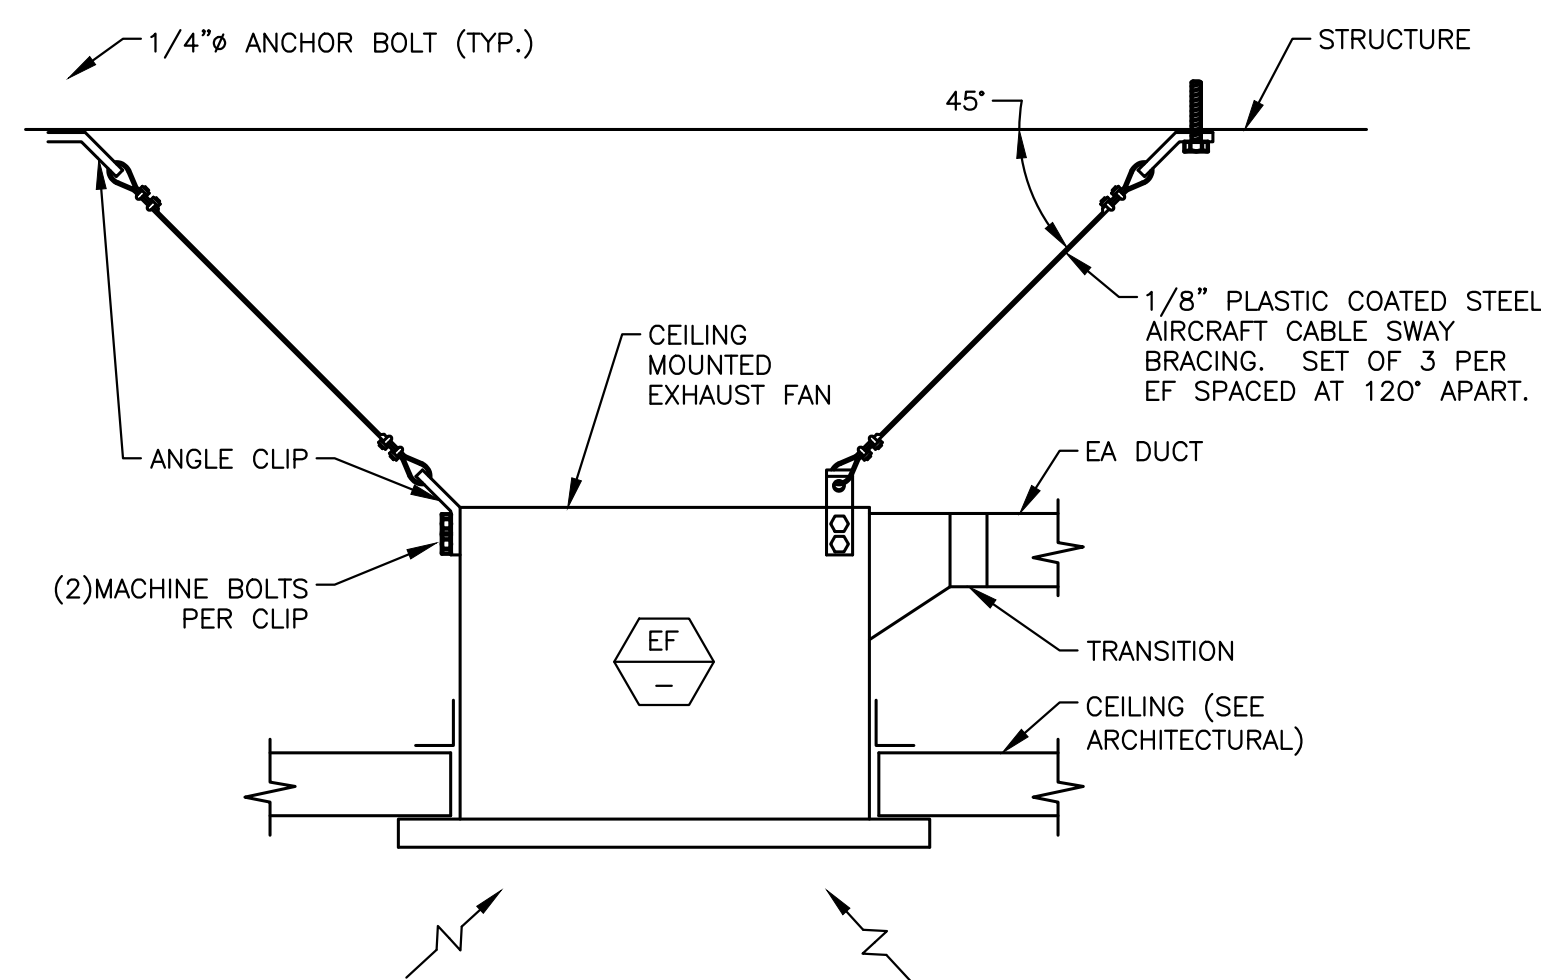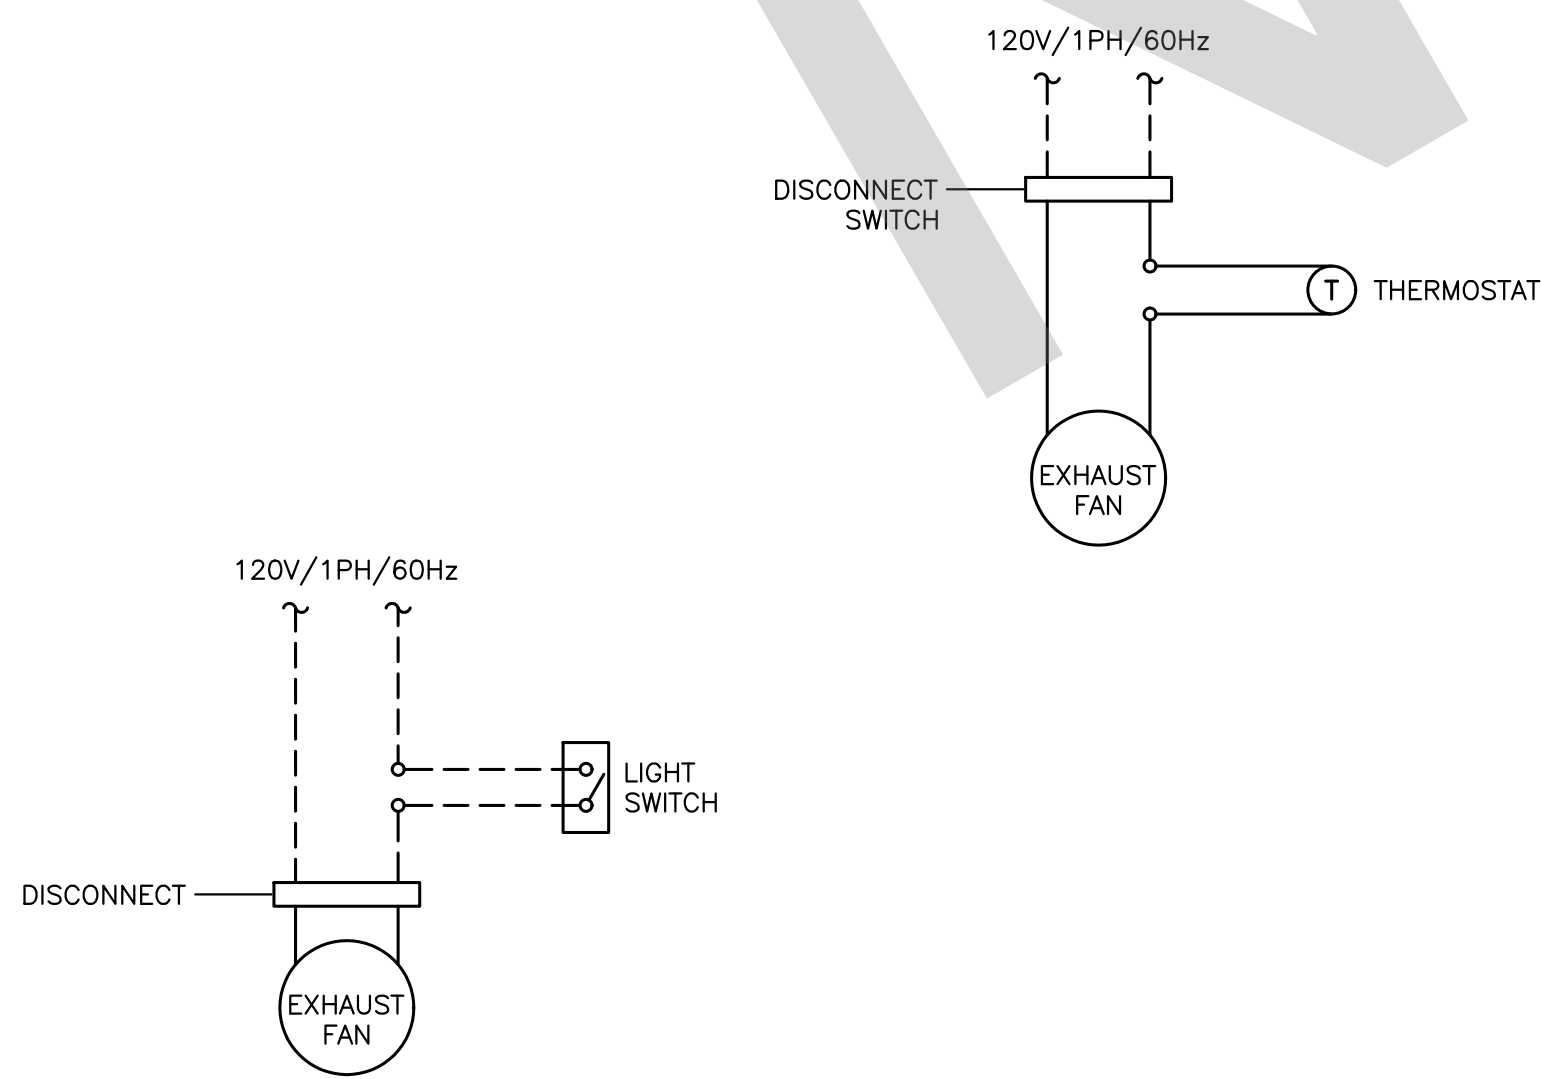

EXHAUST FAN CONTROL DIAGRAMS

SCALE
NONE

CEILING MOUNTED EXHAUST FAN DETAIL

SCALE
NONE

REFRIGERANT PIPE TO UNIT DETAIL

SCALE
NONE

DUCT TAKE-OFF DETAIL

SCALE
NONE

ISSUE INFORMATION:	
DATE:	INFORMATION:
04-11-2022	20% CD SET
04-28-2022	50% CD SET
06-15-2022	95% CD SET
09-16-2022	95% CD- 3rd BAY
10-03-2022	PLAN CHECK

SHEET INFORMATION:	
STK PROJECT NO.:	374-154-21
SCALE:	AS NOTED
DATE:	JANUARY 2021
PLOT DATE:	
DRAWING NAME:	



SHEET TITLE:


MECHANICAL
DETAILS

SHEET NO.:

M5.1



-
- A technical drawing of a vertical pipe assembly. The assembly consists of a central vertical pipe (6) passing through a horizontal flange (7). On top of the pipe is a cap (3). Two vertical support brackets (4) are attached to the pipe, each secured with a bolt (1) and a nut (2). The brackets are connected to the flange by a horizontal link (5). The flange is shown in cross-section with diagonal hatching.

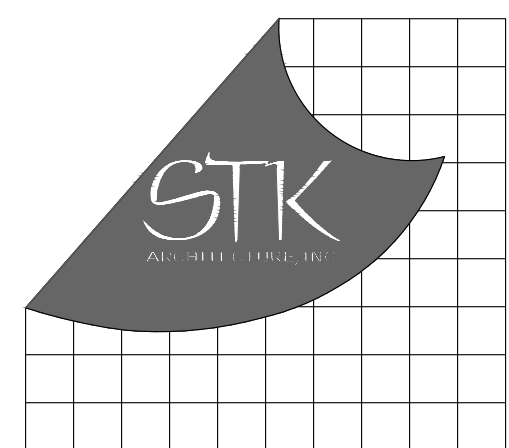

42096 ZEVO DR., TEMECULA, CALIFORNIA 92590-3780

CONSULTANT:



ED ES SS NP

PROJECT ADMINISTERED BY:
SAN BERNARDINO COUNTY
PROJECT & FACILITIES
MANAGEMENT DEPARTMENT

385 N. ARROWHEAD AVE.
SAN BERNARDINO, CA 92415

PROJECT NAME:

SAN BERNARDINO
COUNTY FIRE
DEPARTMENT:
FIRE STATION 226

PROJECT # 10.10.1032

CIP #21-037

CAFM # SABI98

APN #: 0273-011-22

1920 DEL ROSA AVE N
SAN BERNARDINO,
CA 92404

ISSUE INFORMATION:

DATE:	INFORMATION:
04-11-2022	20% CD SET
04-28-2022	50% CD SET
06-15-2022	95% CD SET
09-16-2022	95% CD- 3rd BA
10-03-2022	PLAN CHECK

SHEET INFORMATION

STK PROJECT NO.: 374-154-7
SCALE: AS NOTED
DATE: JANUARY 2007
PLOT DATE: -
DRAWING NAME:

SEAL:




SHEET TITLE


MECHANICAL DETAILS

SHEET NO.:



M5.2

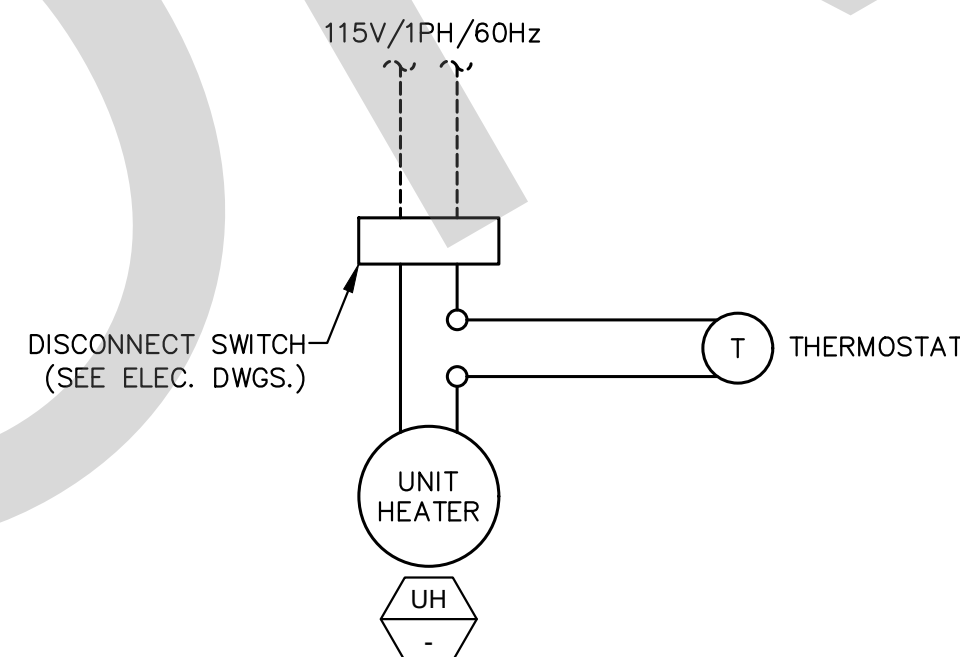
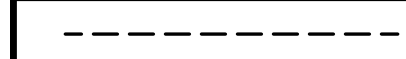
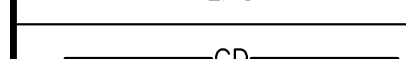
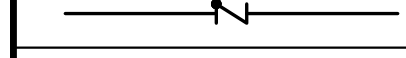

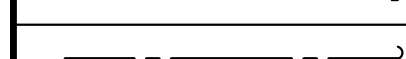
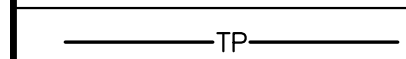

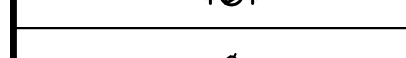


NOTE: CONTRACTOR SHALL PROVIDE ALL CONTROL WIRING INSIDE CONDUIT AND ALL OTHER ACCESSORIES REQUIRED FOR PROPER OPERATION OF SYSTEM AS RECOMMENDED BY MANUFACTURER.	-----	WIRING PROVIDED AND INSTALLED BY DIVISION	16
	_____	WIRING PROVIDED AND INSTALLED BY DIVISION	15

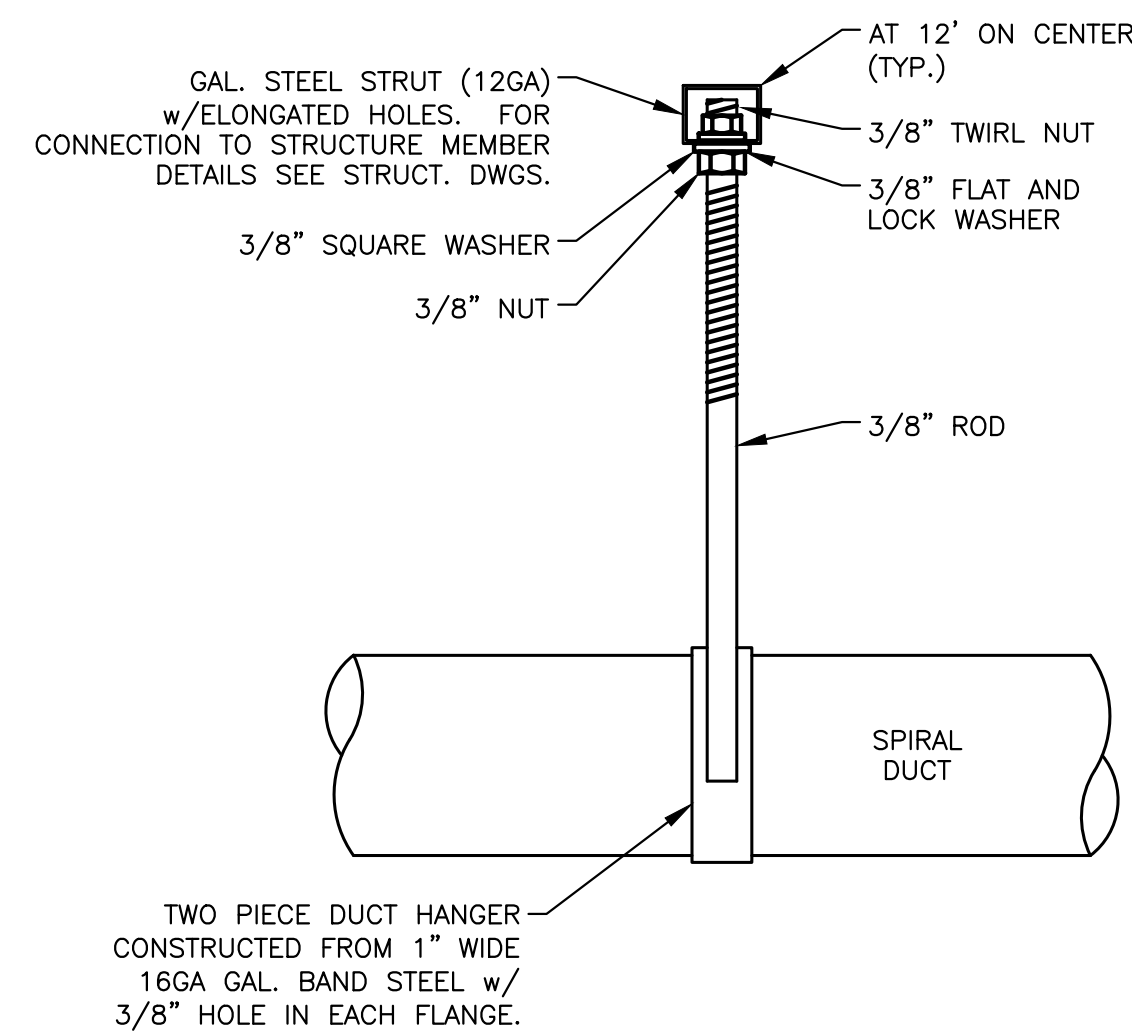

NOTE: PROVIDE GUARDS AS NECESSARY TO PROTECT DUCT FROM DAMAGE

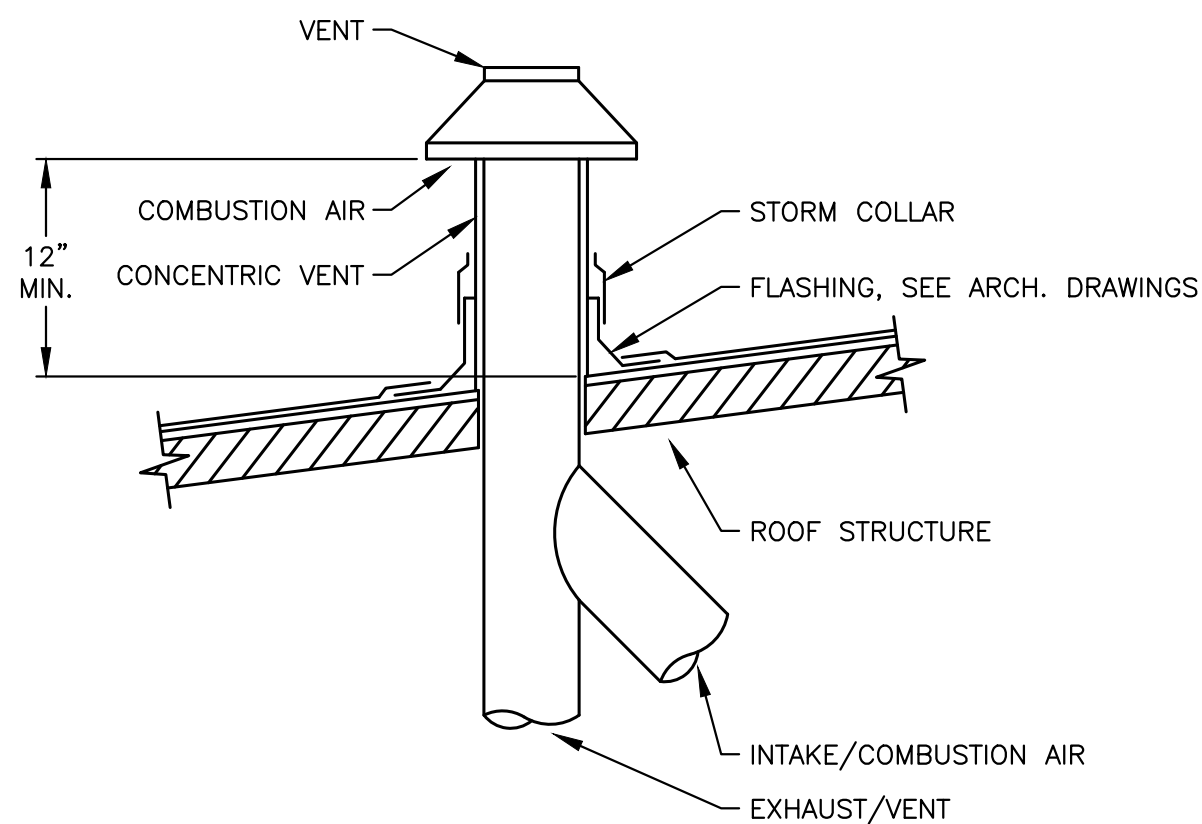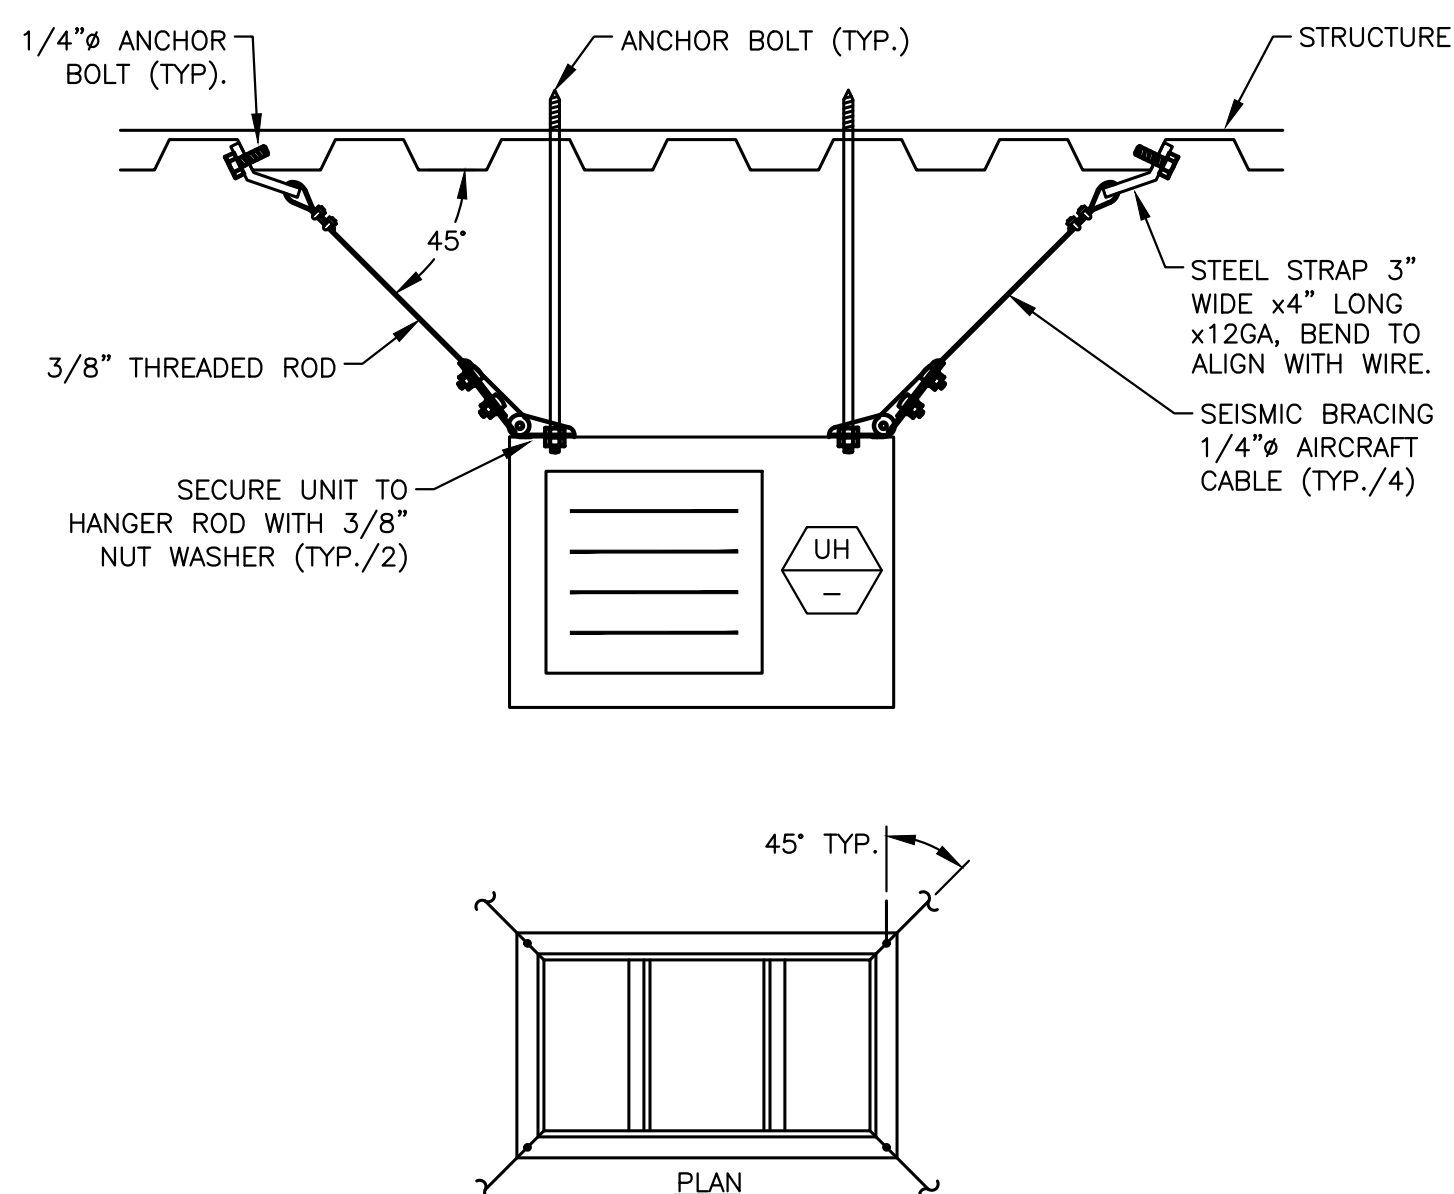

PLUMBING LEGEND					
SYMBOL	ABBREVIATION	DESCRIPTION	ABBREVIATION	DESCRIPTION	
	S	SEWER PIPE	ABV	ABOVE	
	OW	OILY WASTE PIPE	A/C	ABOVE CEILING	
	GW	GREASE WASTE PIPE	AGA	AMERICAN GAS ASSOCIATION	
	PW	PUMPED (FORCED) WASTE PIPE	ANSI	AMERICAN NATIONAL STANDARD INSTITUTE	
	IW	INDIRECT WASTE PIPE	ASME	AMERICAN SOCIETY FOR MECHANICAL ENGINEERS	
	V	VENT PIPE	ASSE	AMERICAN SOCIETY FOR SANITARY ENGINEERS	
	CW	COLD WATER PIPE	ASTM	AMERICAN SOCIETY FOR TESTING AND MATERIALS	
	ICW	INDUSTRIAL COLD WATER PIPE	ADA	AMERICANS WITH DISABILITIES ACT	
	SCW	SOFT COLD WATER PIPE	AF	ABOVE FINISHED FLOOR	
	HW	HOT WATER PIPE	AFG	ABOVE FINISHED GRADE	
	IHW	INDUSTRIAL HOT WATER PIPE	A/G	ACCESS PANEL	
	HWR	HOT WATER RETURN PIPE	ARCH	ARCHITECT OR ARCHITECTURAL	
	140	140°F HOT WATER PIPE	BT	BATH TUB	
	R	RECLAIMED WATER PIPE	BEL	BELOW	
	G	LOW PRESSURE NATURAL GAS PIPE	B/F	BELOW FLOOR	
	MPG	MEDIUM PRESSURE NATURAL GAS PIPE	B/G	BELOW GRADE	
	HPG	HIGH PRESSURE NATURAL GAS PIPE	BOP	BOTTOM OF PIPE	
	LPG	LIQUEFIED PETROLEUM GAS PIPE	B/S	BELOW SLAB	
	CD	CONDENSATE DRAIN PIPE	BTU	BRITISH THERMAL UNIT	
	SCD	SECONDARY CONDENSATE DRAIN PIPE	BTUH	BRITISH THERMAL UNITS PER HOUR	
	PCD	PUMPED CONDENSATE DRAIN PIPE	CBC	CALIFORNIA BUILDING CODE	
	RD	ROOF DRAIN PIPE	CFC	CALIFORNIA FIRE CODE	
	ORD	OVERFLOW ROOF DRAIN PIPE	CMC	CALIFORNIA MECHANICAL CODE	
	CA	COMPRESSED AIR PIPE	CPC	CALIFORNIA PLUMBING CODE	
	FCO	FLOOR CLEAN OUT	CI	CAST IRON	
	GCO	GRADE CLEAN OUT	CISPI	CAST IRON SOIL PIPE INSTITUTE	
	WCO	WALL CLEAN OUT	CLG	CEILING	
	FC	FLXIBLE CONNECTION	CP	CIRCULATION PUMP	
	SOV	SHUT OFF VALVE	CL	CLARIFIER	
	GC	GAS COCK	CLR	CLEAR	
	CV	CHECK VALVE	CONC	CONCRETE	
	BV	BALL VALVE	CONN	CONNECT OR CONNECTION	
	PRV	PRESSURE REDUCING VALVE	CONTR	CONTRACTOR	
	BLV	BALANCING VALVE	CPH	CUBIC FEET PER HOUR	
	PTR	PRESSURE AND TEMPERATURE RELIEF VALVE	CFM	CUBIC FEET PER MINUTE	
	U	UNION	C	DEGREES CELSIUS	
		CAPPED PIPE	F	DEGREES FAHRENHEIT	
	CONT	CONTINUED OR CONTINUATION	DIV	DIVISION	
	TP	TRAP PRIMER LINE	DWG(S)	DRAWING(S)	
	WHA	WATER HAMMER ARRESTOR	EA	EACH	
	RPBP	REDUCED PRESSURE BACKFLOW PREVENTER	(E)	EXISTING	
	HB	HOSE BIBB	ELEC	ELECTRICAL	
		PIPE DOWN OR DROP	ELEV	ELEVATION	
		PIPE UP OR RISE	ET	EXPANSION TANK	
		VALVE ON DROP	FF	FINISHED FLOOR	
		VALVE ON RISE	FFM	FEET PER MINUTE	
	T	THERMOMETER	FLR	FLOOR	
	AS	AQUASTAT	FT	FEET OR FOOT	
	P.O.D.	POINT OF DISCONNECT	FU	FAT, OIL, AND GREASE	
	POC	POINT OF CONNECTION	GA	GALVANIZED	
	AD, FD	AREA DRAIN OR FLOOR DRAIN	GALV	GALLONS PER CYCLE	
	FS, RR	FLOOR SINK OR ROOF RECEPTOR	GPC	GALLONS PER CYCLE	
	VTR	VENT THROUGH ROOF	GPF	GALLONS PER FLUSH	
	DEMO	DEMOLITION OR DEMOLISH	GPH	GALLONS PER HOUR	
	RELO	RELOCATE	GPM	GALLONS PER MINUTE	
	CIRC PUMP	CIRCULATING PUMP	GD	GARBAGE DISPOSAL	
	DIA, DIAM	DIAMETER	HD	HEAD	
			GI	GREASE INTERCEPTOR	
			HDR	HEADER	
			HR	HOUR	
			IM	ICE MAKER SUPPLY BOX	
			IES	ILLUMINATING ENGINEERS SOCIETY	
			IND	INDIRECT	
			IAPMO	INTERNATIONAL ASSOCIATION OF PLUMBERS AND MECHANICAL OFFICIALS	
			IBC	INTERNATIONAL BUILDING CODE	
			IMC	INTERNATIONAL MECHANICAL CODE	
			IPC	INTERNATIONAL PLUMBING CODE	
			INV	INVERT	
			IE	INVERT ELEVATION	
			KEC	KITCHEN EQUIPMENT CONTRACTOR	
			KD	KILOGRAMS	
			KPQ	KILOPASCALS	
			KS	KITCHEN SINK	
			LS	LAUNDRY SINK	
			L, LAV	LAVATORY	
			L/S	LITERS PER SECOND	
			LPF	LITERS PER FLUSH	
			MH	MANHOLE	
			MFR	MANUFACTURER	
			MSS	MANUFACTURERS STANDARDIZATION SOCIETY	
			MAX	MAXIMUM	
			MECH	MECHANICAL	
			MSA	MEDIUM PRESSURE GAS METER SET ASSEMBLY	
			MSL	MILLILITER	
			MIN	MINIMUM	
			MS	MOP SINK	
			MTD	MOUNTED	
			NSF	NATIONAL SANITATION FOUNDATION	
			NSH	NET POSITIVE SUCTION HEAD	
			NOM	NOMINAL	
			NIC	NOT IN CONTRACT	
			NTS	NOT TO SCALE	
			NO	NUMBER	
			PLBG	PLUMBING	
			PDI	PLUMBING AND DRAINAGE INSTITUTE	
			PE	POLYETHYLENE	
			LBS	POUNDS	
			PSIG	POUNDS PER SQUARE INCH GAUGE	
			PD	PRESSURE DROP	
			QTY	QUANTITY	
			REQ'D	REQUIRED	
			RI	ROUGH-IN	
			SCH	SCHEDULE	
			SH	SHOWER	
			P.O.D.	SHUT-OFF VALVE	
			SOV	SPECIFICATION	
			SPC	SQUARE FEET	
			SS	STAINLESS STEEL	
			STRUC	STRUCTURAL	
			TDH	TEMPERATURE	
			MBH	THOUSANDS OF BRITISH THERMAL UNITS PER HOUR	
			THRU	THROUGH	
			TDL	TOTAL DEVELOPED HEAD	
			TEL	TOTAL DEVELOPED LENGTH	
			TYP	TOTAL EQUIVALENT LENGTH	
			UNO	TYPICAL	
			UL	UNLESS NOTED OTHERWISE	
			UBC	UNDERWRITERS LABORATORIES	
			UMC	UNIFORM BUILDING CODE	
			UPC	UNIFORM MECHANICAL CODE	
			UR	UNIFORM PLUMBING CODE	
			VCP	VITRIFIED CLAY PIPE	
			V/PH/Hz	VOLTS/PHASE/HERTZ	
			WB, WSB	WASHING MACHINE SUPPLY BOX	
			WC	WATER CLOSET	
			WHA	WATER HAMMER ARRESTOR	
			WH	WATER HEATER	
			YB	YARD BOX	

PLUMBING GENERAL NOTES:

- THESE DOCUMENTS MAY NOT BE USED FOR ANY REPRODUCTION, BIDDING, OR CONSTRUCTION UNLESS AUTHORIZED IN WRITING, BY SALAS O'BRIEN AND THE ENGINEER OF RECORD RESPONSIBLE FOR THEIR PREPARATION.
- CONTRACTOR SHALL FIELD VERIFY THE LOCATIONS OF ALL EXISTING UTILITY PIPES PRIOR TO START OF WORK. NECESSARY ADJUSTMENTS TO THE PLUMBING LAYOUT SHALL BE DONE AT NO EXTRA COST.
- CONTRACTOR SHALL NOTIFY ALL LOCAL UTILITY COMPANIES INCLUDING BUT NOT LIMITED TO THE GAS COMPANY, ELECTRIC COMPANY, TELEPHONE COMPANY, AND THE WATER DEPARTMENT, ABOUT THE EXTENT OF PLUMBING WORK. ALL EXCAVATION WORK SHALL BE APPROVED BY ALL UTILITY COMPANIES TO ASSURE PREVENTION OF INTERRUPTION OF EXISTING SERVICES PRIOR TO START OF WORK.
- ALL PLUMBING WORK SHALL MEET OR EXCEED THE REQUIREMENTS OF THE CALIFORNIA PLUMBING CODE, CALIFORNIA BUILDING CODE, CALIFORNIA MECHANICAL CODE, CALIFORNIA ADMINISTRATIVE CODE, TITLE 24, AMERICANS WITH DISABILITIES ACT (ADA), NATIONAL FIRE PROTECTION ASSOCIATION (NFPA), THE LOCAL CITY AND COUNTY CODES, AND ALL OTHER CODES HAVING JURISDICTION. IN CASE OF CONFLICT, THE MORE STRICT REGULATIONS SHALL GOVERN.
- ALL PLUMBING WORK SHALL BE COORDINATED WITH THE WORKS OF OTHER TRADES PRIOR TO START OF WORK. NECESSARY ADJUSTMENTS SHALL BE MADE AT NO EXTRA COST.
- FOR MINIMUM PIPE SIZE CONNECTIONS TO EACH PLUMBING FIXTURE SEE PLUMBING FIXTURE SCHEDULE. THESE VALUES ARE MINIMUM; LARGER CONNECTIONS MAY RESULT BASED ON THE DIFFERENT MANUFACTURER'S RECOMMENDATIONS.
- MANUFACTURER'S NAMES AND MODEL NUMBERS SHOWN FOR PLUMBING FIXTURES AND EQUIPMENT ARE FOR REFERENCE ONLY. OTHER MANUFACTURERS WHICH CAN MEET THE DESIGN REQUIREMENTS OF THE PLUMBING SYSTEM MAY BE SUBSTITUTED UPON APPROVAL FROM THE ARCHITECT AND THE OWNER.
- PROVIDE DIELECTRIC FITTINGS FOR DISSIMILAR METALS IN CONTACT.
- PROVIDE HANGERS AND SUPPORTS FOR PIPING IN ACCORDANCE WITH THE RECOMMENDATIONS OF MSS SP-59-2003.
- PROVIDE VALVES AT THE FOLLOWING LOCATIONS:
 - WATER MAIN SHUT-OFF VALVE IN VALVE BOX.
 - VALVE WITH HOSE CONNECTION ON DOWNSTREAM SIDE OF THE MAIN SHUT-OFF VALVE.
 - SHUT-OFF VALVE ON EACH SUPPLY TO EACH FIXTURE AND EQUIPMENT ITEM NOT PROVIDED WITH CONTROL STOP OR OTHER AUXILIARY SHUT-OFF VALVE. INSTALL SHUT-OFF VALVES SO THAT STEMS EITHER ARE VERTICAL WITH HANDWHEELS OR OPERATORS ON TOP OR ARE HORIZONTAL AND SO THAT VALVES ARE EASILY ACCESSIBLE FOR OPERATION, SERVICE, REMOVAL AND REPLACEMENT.
- PROVIDE SLEEVES FOR ALL PIPE AND TUBING PASSING THROUGH FLOORS, ROOFS, AND WALLS. PACK CAULK INTO THE SPACE AROUND THE PIPE OR TUBING. PROVIDE FLASHING FOR ALL PIPES EXTENDING THROUGH THE ROOF.
- ALL VENT TERMINATIONS AT ROOF SHALL BE AT LEAST 10 FEET AWAY FROM OUTSIDE AIR INTAKES, OPERABLE WINDOWS, AND BUILDING OPENINGS.
- FILL CRACKS BETWEEN FIXTURES AND WALL/FLOORS WITH SILICONE RUBBER SEALANT.
- LOCATE, SIZE, AND INSTALL WATER HAMMER ARRESTERS IN ACCORDANCE WITH PLUMBING AND DRAINAGE INSTITUTE STANDARD NO. WH-201.
- INSTALL FIXTURES IN ACCORDANCE WITH THE MANUFACTURER'S RECOMMENDATIONS AND ALL APPLICABLE CODES. SECURE FLOOR OUTLET OF FLOOR-MOUNTED FIXTURES TO DRAINAGE CONNECTIONS AND FLOOR IN A RIGID MANNER. RIGIDLY SUPPORT WALL-HUNG FIXTURES BY MEANS OF METAL SUPPORTING MEMBERS. USE CHROMIUM-PLATED BRASS BOLTS, NUTS, AND WASHERS WHERE EXPOSED. ALL CONNECTIONS SHALL BE MADE GAS-TIGHT AND WATER-TIGHT. USE OF PUTTY AND PLASTICS FOR GASKETS WILL NOT BE PERMITTED.
- PROVIDE ALL FIXTURE COMPONENTS AS INDICATED ON DRAWINGS. PROVIDE ADDITIONAL COMPONENTS AS PER MANUFACTURER'S RECOMMENDATIONS FOR PROPER OPERATION OF THE FIXTURES.
- PROVIDE EACH PLUMBING FIXTURE (INCLUDING HOSE BIBBS) WITH AN INDIVIDUAL STOP OR COMPRESSION VALVE OF POLISHED CHROME-PLATED LOOSE KEY TYPE.
- WHERE DEPTHS OR INVERTS ELEVATIONS ARE NOT INDICATED, PROVIDE MINIMUM COVERAGE (ABOVE TOP OF PIPES) AS FOLLOWS:
 - ANY PIPING UNDER SLAB (TOP OF PIPE TO UNDERSIDE OF SLAB): 18 INCHES.
 - CAST IRON AND COPPER PIPES IN OTHER LOCATIONS: 18 INCHES.
 - EXCAVATE TO UNDISTURBED EARTH; CUT LEVEL AND FORM TRUE. REMOVE DEBRIS, RUBBISH AND SOFT MATERIAL (SUCH AS MUD). WHERE ROCK IS ENCOUNTERED, UNDERCUT TRENCHES 6-INCHES AND FILL WITH WELL TAMPED NEUTRAL SAND AND PEA GRAVEL TO PROPER PIPE ELEVATION. DURING EXCAVATION FREE OF STANDING WATER. UNDERCUT TRENCH 6-INCHES AND INSTALL PIPING IN A 6-INCH NEUTRAL SAND ENVELOPE.
- BACKFILL TO A POINT 12-INCHES ABOVE TOP OF PIPING WITH EARTH (EXCAVATED MATERIAL MAY BE USED) FREE OF CLAY, DEBRIS, RUBBISH, ROCKS, OR CLODS OVER 4-INCHES IN THE GREATEST DIMENSION. BACKFILL ABOVE 12-INCHES FROM TOP OF PIPING MAY BE WITH EXCAVATED MATERIAL. APPLY BACKFILL BY HAND IN 6-INCH DEEP LAYERS THE FULL WIDTH OF THE TRENCH. MOISTEN EACH LAYER (DO NOT FLOOD OR PUDDLE). AND HAND TAMP TO A MINIMUM 90 PERCENT COMPACTION BEFORE PROCEEDING WITH THE NEXT LAYER OF BACKFILL.
- DO NOT EXCAVATE UNDER FOUNDATIONS OR FOOTINGS EXCEPT IN MANNER PERMITTED BY THE ARCHITECT. DO NOT BACKFILL UNTIL INSTALLED PIPING HAS BEEN SUCCESSFULLY TESTED.
- VERIFICATION OF WATER AGENCY APPROVAL SHALL BE SUBMITTED TO THE BUILDING AND SAFETY DIVISION PRIOR TO ISSUANCE OF A PLUMBING PERMIT FOR THIS PROJECT.
- ALL PENETRATIONS THRU FIRE RATED ASSEMBLIES SHALL BE PACKED WITH APPROVED FIRE PROOFING. FOR LOCATIONS OF FIRE RATED ASSEMBLIES, SEE ARCHITECTURAL PLANS.
- ROUTE ALL PIPES AS HIGH AS POSSIBLE IN EXPOSED LOCATIONS. COORDINATE ROUTING WITH ALL OTHER TRADES PRIOR TO START OF WORK.
- NO SPRAY FOAM INSULATION SHALL BE APPLIED TO AREAS CONTAINING PEX PIPING.

PLUMBING MANDATORY MEASURES

- ALL PLUMBING SYSTEM COMPONENTS SHALL MEET OR EXCEED THE REQUIREMENTS OF CURRENT CBC, CMC, CPC, NEC, NFPA, ASTM, ANSI, AND ALL LOCAL AND STATE CODE REQUIREMENTS. (SEE BELOW)
- ALL PLUMBING EQUIPMENT LISTED IN OF THE 2019 CALIFORNIA CODE OF REGULATIONS (CCR), TITLE-24, PART 6, SECTION 110.3 ENERGY EFFICIENCY STANDARDS MUST BE CERTIFIED BY THE MANUFACTURER TO MEET OR EXCEED SPECIFICATIONS OR EFFICIENCIES ADOPTED BY THE CEC.
- ALL HEATERS FOR DOMESTIC HOT WATER MUST BE CERTIFIED BY THE MANUFACTURER TO MEET THE SPECIFICATIONS OR EFFICIENCIES AS ADOPTED BY THE CEC IN ACCORDANCE WITH THE 2019 CALIFORNIA CODE OF REGULATIONS (CCR), TITLE-24, PART 6, SECTION 110.3 RESIDENTIAL NON-RESIDENTIAL.
- ALL GAS APPLIANCES MUST HAVE PILOTLESS IGNITION SYSTEM IN ACCORDANCE WITH SECTION 110.5 OF THE 2019 CALIFORNIA CODE OF REGULATIONS, TITLE-24, PART 6, ENERGY EFFICIENCY STANDARDS, TABLE 4-4.
- ALL INSULATING MATERIALS INSTALLED MUST BE CERTIFIED BY CALIFORNIA ENERGY COMMISSION TO MEET 2019 CALIFORNIA CODE OF REGULATIONS, TITLE-24, PART 6, ENERGY EFFICIENCY STANDARDS, SECTION 120.3 AND TABLE 4-15.
- ALL INSULATION INSTALLED SHALL MEET THE FLAME SPREAD AND SMOKE DENSITY REQUIREMENTS OF 2019 CBC, PART 1, SECTION 720 AND 2019 CMC. SECTION 602.2.
- ALL PIPING EXPOSED TO WEATHER SHALL BE METALLIC.
- ALL FERRROSS PIPING EXPOSED TO WEATHER SHALL BE GALVANIZED AND PAINTED.
- ALL PIPES, FITTINGS AND FIXTURES USED TO CONVEY POTABLE WATER SHALL BE LEAD FREE IN COMPLIANCE WITH CPC SECTION 604.2.
- ALL FIXTURES REQUIRED TO BE ACCESSIBLE SHALL BE INSTALLED AS PER THE LATEST REQUIREMENTS OF TITLE 24 AND ADA (AMERICANS WITH DISABILITIES ACT).
- CROSS CONNECTION PROTECTION SHALL BE PROVIDED AT ALL POTABLE WATER SUPPLIED APPLIANCES AND EQUIPMENT (OTHER THAN THOSE LISTED IN INFORMATION BULLETIN 103).
- A WATER HEATER PRESSURE AND TEMPERATURE RELIEF DRAIN THAT TERMINATES OUTSIDE THE BUILDING SHALL COMPLY WITH CPC SECTION 608.5.
- WATER HEATER SHALL BE ANCHORED OR STRAPPED TO RESIST HORIZONTAL DISPLACEMENT DUE TO EARTHQUAKE MOTION PER CPC SECTION 607.2.
- WATER HEATER SHALL COMPLY WITH CPC SECTION 608.3, FOR THERMAL EXPANSION REQUIREMENTS.
- LAVATORY FAUCETS IN PUBLIC RESTROOM SHALL BE SELF CLOSING TYPE.
- TUB AND SHOWER COMBINATIONS SHALL BE PROVIDED WITH MIXING VALVES PER CPC SECTION 408.3.
- SHOWERHEADS SHALL BE 1.8 GPM AT 80PSI.
- NONRESIDENTIAL LAVATORY FAUCETS SHALL BE 0.4 GPM MAXIMUM.
- KITCHEN FAUCETS AND WASH FOUNTAINS SHALL BE 1.8 GPM MAXIMUM.
- METERING FAUCETS SHALL BE 0.2 GPC MAXIMUM.
- WATER CLOSETS (GRAVITY TANK TYPE, FLUSHOMETER TANK, FLUSHOMETER VALVE AND ELECTROMECHANICAL HYDRAULIC TYPE) SHALL BE 1.28 GPF MAXIMUM.
- FLOOR-MOUNT URINALS SHALL BE 0.5 GPF MAXIMUM. WALL-MOUNT URINALS SHALL BE 0.125 GPF MAXIMUM.
- ALL INSTALLATION OF PEX PIPE INSTALLED IN NEW CONSTRUCTION SHALL BE FLUSHED TWICE OVER A PERIOD OF AT LEAST ONE WEEK PER CPC SECTION 604.1.2. PEX.
 - AT THE TIME OF FILL, EACH NEW PLUMBING FIXTURE SHALL HAVE A REMOVABLE TAG APPLIED STATING:
 - THIS NEW PLUMBING SYSTEM SHALL BE FIRST FILLED AND FLUSHED ON (DATE) BY (NAME). THE STATE OF CALIFORNIA REQUIRES THAT THE SYSTEM BE FLUSHED AFTER STANDING AT LEAST ONE WEEK AFTER THE FILL DATE SPECIFIED ABOVE. IF THIS SYSTEM IS USED EARLIER THAN ONE WEEK AFTER THE FILL DATE ABOVE, IF THIS SYSTEM IS USED EARLIER THAN ONE WEEK AFTER THE FILL DATE, THE WATER MUST BE ALLOWED TO RUN FOR AT LEAST TWO MINUTES PRI

MANDATORY CALGREEN CHECKLIST	
WATER EFFICIENCY AND CONSERVATION INDOOR WATER USE	MANDATORY
5.303.1.1 METERS. SEPARATE METERS SHALL BE INSTALLED FOR THE USES DESCRIBED IN SECTIONS 5.303.1.1 AND 5.303.1.2. 5.303.1.1 BUILDINGS IN EXCESS OF 50,000 SQUARE FEET. SEPARATE SUBMETERS SHALL BE INSTALLED AS FOLLOWS: 1. FOR EACH INDIVIDUAL LEASED, RENTED OR OTHER TENANT SPACE WITHIN THE BUILDING PROJECTED TO CONSUME MORE THAN 100GAL/DAY. 2. WHERE SEPARATE SUBMETERS FOR INDIVIDUAL BUILDINGS TENANTS ARE UNFEASIBLE, FOR WATER SUPPLIED TO THE FOLLOWING SUBSYSTEMS: a. MAKEUP WATER FOR COOLING TOWERS WHERE FLOW THROUGH IS GREATER THAN 500 GPM (30L/S) b. MAKEUP WATER FOR EVAPORATIVE COOLERS GREATER THAN 6 GPM (0.04 L/S) c. STEAM AND HOT-WATER BOILERS WITH ENERGY INPUT MORE THAN 500,000 Btu/h (147 kW) 5.303.1.2 EXCESS CONSUMPTION. ANY BUILDING OR A SPACE WITHIN A BUILDING THAT IS PROJECTED TO CONSUME MORE THAN 1,000 GAL/DAY (3800 L/DAY) SHALL BE PROJECTED TO CONSUME MORE THAN 1,000 GAL/DAY (3800 L/DAY) (CALCULATE SAVINGS BY WATER USE WORKSHEETS) 5.303.2.1 MULTIPLE SHOWERHEADS SERVING ONE SHOWER. WHEN A SHOWER IS SERVED BY MORE THAN ONE SHOWERHEAD, THE COMBINED FLOW RATE OF ALL THE SHOWERHEADS CONTROLLED BY A SINGLE VALVE SHALL NOT EXCEED THE MAXIMUM FLOW RATE AT ≥ 20 PERCENT REDUCTION CONTAINED IN TABLE 5.303.2.3 OR THE SHOWER SHALL BE DESIGNED TO ONLY ALLOW ONE SHOWERHEAD TO BE IN OPERATION AT A TIME. 5.303.4 WASTEWATER REDUCTION. EACH BUILDING SHALL REDUCE THE GENERATION OF WASTEWATER BY ONE OF THE FOLLOWING METHODS: 1. THE INSTALLATION OF WATER-CONSERVING FIXTURES OR 2. UTILIZING NONPOTABLE WATER SYSTEMS. 5.303.6 PLUMBING FIXTURES AND FITTINGS. PLUMBING FIXTURES (WATER CLOSETS AND URINALS) AND FITTINGS (FAUCETS AND SHOWERHEADS) SHALL COMPLY WITH THE REQUIREMENTS LISTED FOR EACH TYPE IN ITEMS LISTED IN TABLE 5.303.6. 1. WATER CLOSETS (TOILETS) – FLUSHMETER TYPE 2. WATER CLOSETS (TOILETS) – TANK TYPE 3. URINALS 4. PUBLIC LAVATORY FAUCETS 5. PUBLIC METERING SELF-CLOSING FAUCETS 6. RESIDENTIAL BATHROOM LAVATORY SINK FAUCETS 7. RESIDENTIAL KITCHEN FAUCETS 8. RESIDENTIAL SHOWER HEADS 9. SINGLE SHOWER FIXTURES SERVED BY MORE THAN ONE SHOWERHEAD	

WATER REDUCTION FIXTURE FLOW RATES	
PER 2019 CALIFORNIA GREEN BUILDING CODE – TABLE A5.303.2.3.1	
FIXTURE TYPE	MAXIMUM FLOW RATE
KITCHEN FAUCETS	1.8 GPM AT 60 PSI
WASH FOUNTAINS	1.8 [RIM SPACE (IN.)/20 GPM AT 60 PSI]
METERING FAUCETS	0.20 GALLONS/CYCLE
METERING FAUCETS FOR WASH FOUNTAINS	0.20 GALLONS/CYCLE/20 [RIM SPACE (IN.)] 60 PSI

EACH PLUMBING FIXTURE AND FITTING SHALL MEET THE FLOW RATE SPECIFIED IN 2019 CAL GREEN TABLE A5.303.2.3.1

WATER CONSERVATION FIXTURE FLOW RATES	
PER 2019 CALIFORNIA GREEN BUILDING CODE SECTION 5.303.3	
FIXTURE TYPE	MAXIMUM BASELINE FLOW RATE
WATER CLOSETS	1.28 GALLONS PER FLUSH
URINALS (FLOOR-MOUNT/WALL-MOUNT)	0.5/0.125 GALLONS PER FLUSH
SHOWERHEADS	1.8 GPM AT 80 PSI

PLUMBING FIXTURES (WATER CLOSETS AND URINALS) AND FITTINGS (FAUCETS AND SHOWERHEADS) SHALL COMPLY WITH 5.303.3.

PLUMBING FIXTURES AND FIXTURE FITTINGS	
PER 2019 CALIFORNIA PLUMBING CODE – TABLE 1701.1	
REQUIRED STANDARDS	
WATER CLOSETS (TOILETS) – FLUSHMETER VALVE TYPE SINGLE FLUSH, MAXIMUM FLUSH VOLUME	ASME A 112.19.2/CSA B45.1 – 1.28 GPF (4.8 L)
WATER CLOSETS (TOILETS) – FLUSHMETER VALVE TYPE DUAL FLUSH, MAXIMUM FLUSH VOLUME	ASME A 112.19.2 AND USEPA WATERSENSE TANK-TYPE HIGH-EFFICIENCY TOILET SPECIFICATION – 1.28 GPF (4.8 L)
WATER CLOSETS (TOILETS) – TANK TYPE	U.S. EPA WATERSENSE TANK-TYPE HIGH EFFICIENCY TOILET SPECIFICATION
URINALS, MAXIMUM FLUSH VOLUME	ASME A 112.19.2/CSA B45.1 – 0.5 GPF (1.9 L)
URINALS, NONWATER URINALS	ASME A 112.19.19 (VITREOUS CHINA) ANSI Z124.9–2004 OR IAPMO Z124.9 (PLASTIC)
PUBLIC LAVATORY FAUCETS: MAXIMUM FLOW RATE – 0.5 GPM (1.9 L/MIN.)	ASME A 112.18.1/CSA B125.1
PUBLIC METERING SELF-CLOSING FAUCETS: MAXIMUM FLOW RATE – 0.25 (1.0 L) PER METERING CYCLE	ASME A 112.18.1/CSA B125.1
RESIDENTIAL BATHROOM LAVATORY SINK FAUCETS: MAXIMUM FLOW RATE – 1.5 GPM (5.7 L/MIN)	ASME A 112.18.1/CSA B125.1

PLUMBING FIXTURES (WATER CLOSETS AND URINALS) AND FITTINGS (FAUCETS AND SHOWERHEADS) SHALL MEET THE STANDARDS REFERENCED IN TABLE 5.303.6.


PLUMBING PIPE MATERIAL SCHEDULE			
SERVICE	LOCATION	PIPE MATERIAL	SLOPE
WATER	ABOVE GRADE	ASTM B88 TYPE "L" HARD DRAWN COPPER WITH WROUGHT COPPER FITTINGS.	1/32" PER 1'
	BELOW GRADE	ASTM B88 TYPE "K" HARD DRAWN COPPER, FACTORY INSULATED, WITH WROUGHT COPPER FITTINGS.	1/32" PER 1'
SEWER AND VENT	ABOVE GRADE	ASTM A888 SERVICE WEIGHT CAST IRON PIPE AND DWV FITTINGS SHALL CONFORM TO CPC AND BEAR THE COLLECTIVE TRADEMARK OF CISPI AND NSF.	1/4" PER 1'
	BELOW GRADE	ABS SCHEDULE 40 PIPE AND DWV FITTINGS SHALL CONFORM TO ASTM D2321–2000 AND CPC.	1/4" PER 1'
NATURAL GAS	ABOVE GRADE	ASTM A53 SCHEDULE 40 GALVANIZED STEEL "BLACK" PIPE AND FITTINGS SHALL CONFORM TO CPC. EXPOSED PIPING SHALL BE PAINTED.	1/4" PER 15'
	BELOW FLOOR (INTERIOR)	ASTM A53 SCHEDULE 40 GALVANIZED STEEL "BLACK" PIPE AND FITTINGS SHALL CONFORM TO CPC. PIPING INSTALLED UNDERGROUND BENEATH BUILDING SHALL CONFORM TO CPC 1210.1.6.	1/4" PER 15'
CONDENSATE	BELOW GRADE (EXTERIOR)	ASTM D2513–16g POLYETHYLENE "PE" PIPE. ALL FITTINGS SHALL BE AS PER CPC.	1/4" PER 15'
	ABOVE GRADE	ASTM B88 TYPE "L" HARD DRAWN COPPER WITH WROUGHT COPPER FITTINGS.	1/4" PER 1'

PIPE INSULATION THICKNESS									
PER 2019 CALIFORNIA ENERGY CODE TABLE 120.3–A									
FLUID OPERATING TEMPERATURE RANGE (°F)	INSULATION CONDUCTIVITY		NOMINAL PIPE DIAMETER(INCHES)						
	CONDUCTIVITY (IN BTU-IN/H PER SQ. FT² °F)	MEAN RATING TEMPERATURE (°F)	<1	1 – < 1.5	1.5 – < 4	4 – < 8	8 AND LARGER		
			INSULATION THICKNESS REQUIRED (IN INCHES)						
SPACE HEATING, SERVICE WATER HEATING SYSTEMS (STEAM, STEAM CONDENSATE, REFRIGERANT, SPACE HEATING, SERVICE HOT WATER)			MINIMUM PIPE INSULATION REQUIRED (THICKNESS IN INCHES OR R-VALUE)						
ABOVE 350	0.32 – 0.34	250	INCHES 4.5 R-VALUE R37	5.0 R41	5.0 R37	5.0 R27	5.0 R23		
251–350	0.29 – 0.31	200	INCHES 3.0 R-VALUE R24	4.0 R34	4.5 R35	4.5 R26	4.5 R22		
201–250	0.27 – 0.30	150	INCHES 2.5 R-VALUE R21	2.5 R20	2.5 R17.5	3.0 R17	3.0 R14.5		
141–200	0.25 – 0.29	125	INCHES 1.5 R-VALUE R11.5	1.5 R11	2.0 R14	2.0 R11	2.0 R10		
105–140	0.22 – 0.28	100	INCHES 1.0 R-VALUE R7.7	1.5 R12.5	1.5 R11	1.5 R9	1.5 R8		
SPACE COOLING SYSTEMS (CHILLED WATER, REFRIGERANT AND BRINE)			NOMINAL PIPE DIAMETER(INCHES)						
			<=1	1 – < 1.5	1.5 – < 4	4 – < 8	8 <		
			MINIMUM PIPE INSULATION REQUIRED (THICKNESS IN INCHES OR R-VALUE)						
40–60	0.21 – 0.27	75	INCHES 0.5 R-VALUE R3	RES 0.5 R6	NONRES 0.5 R3	RES 0.5 R5	1.0 1.0	1.0 1.0	1.0 1.0
BELOW 40	0.20 – 0.26	50	INCHES 1.0 R-VALUE R8.5	1.0 R14	1.5 R12	1.5 R10	1.5 R10	1.5 R9	

FIXTURE DATA							
SYMBOL	DESCRIPTION	NO. OF UNITS	DOMESTIC WATER		NO. OF UNITS	SEWER	
			F.U. PER UNIT ①	TOTAL FIXTURE UNITS		F.U. PER UNIT ②	TOTAL FIXTURE UNITS
			CW	HW			
WB 1	CLOTHES WASHER SUPPLY BOX	1	4.0	4.0	3.0	1	3.0
DW 1	DISHWASHER	1	1.5	1.5	1.1	1	---
EX 1	EXTRACTOR	1	4	4.0	3.0	1	4.0
HB 1	HOSE BIBB	1	2.5	2.5	---	1	---
HB 1	ADDITIONAL HOSE BIBB	7	1.0	7.0	---	7	---
L 1	LAVATORY	5	1.0	5.0	3.8	5	1.0
BS 1	BAR SINK	1	2.0	2.0	1.5	1	2.0
KS 1	KITCHEN SINK	1	1.5	1.5	1.1	1	2.0
LS 1	LAUNDRY SINK	2	1.5	3.0	2.3	2	2.0
MS 1	SERVICE/MOP BASIN SINK	1	3.0	3.0	2.3	1	3.0
SH 1	SHOWER	5	2.0	10.0	7.5	5	2.0
WC 1	WATER CLOSET (TANK)	5	2.5	12.5	---	5	4.0
IM 1	ICE MAKER	3	0.5	1.5	---	---	---
FD 1	FLOOR DRAIN	11	---	---	---	11	---
FS 1	FLOOR SINK	3	---	---	---	3	---
	TOTAL			57.5	25.5		53.0

① WATER FIXTURE UNITS PER CPC TABLE A 103.1 ② SEWER FIXTURE UNITS PER CPC TABLE 702.1

WATER CALCULATIONS			
DOMESTIC COLD WATER PRESSURE CALCULATION (AVG PSI / 100 FT)		DOMESTIC COLD WATER SIZING	
RESIDUAL PRESSURE PER CONVERSATION WITH JASON WOLF AT EAST VALLEY WATER DISTRICT, (909)888.8986 ON 05/17/2022. AVAILABLE WATER PRESSURE IS 85 PSI. CONTRACTOR TO FIELD VERIFY STREET WATER PRESSURE PRIOR TO START OF WORK. IN CASE OF ANY DISCREPANCIES NOTIFY ARCHITECT/ENGINEER PRIOR TO START OF WORK.		FRICTION LOSS 3.0 PSI PER 100 FT AVG, AT 8 FPS MAX. VELOCITY	
MAX. SYSTEM INLET PRESSURE [AT WATER METER INLET]	=	85	PSI
MIN. SYSTEM INLET PRESSURE [AT PRESSURE REDUCING VALVE INLET]	=	80	PSI
SYSTEM PRESSURE LOSSES		PIPE SIZE WSFU	
1 1/2" WATER METER @ 32 GPM	=	1.3	PSI
1 1/2" BACKFLOW PREVENTER @ 32 GPM	=	13	PSI
1 1/2" PRESSURE REDUCING VALVE @ 32 GPM	=	5	PSI
TOTAL OF SYSTEM PRESSURE LOSSES	=	19.3	PSI
RESIDUAL PRESSURE AT PRV	=	60.7	PSI
PRESSURE REDUCING VALVE SETPOINT	=	60	PSI
STATIC HEIGHT PRESSURE LOSS (25' x .433)	=	10.8	PSI
RESIDUAL PRESSURE REQUIRED AT GOVERNING FIXTURE [WATER CLOSET 25 PSI]	=	25	PSI
TOTAL SYSTEM PRESSURE LOSSES (DOWNSTREAM OF PRV)	=	35.8	PSI
PRESSURE AVAILABLE FOR PIPE SIZING (PRV SETPOINT – TOTAL SYSTEM PRESSURE LOSSES DOWNSTREAM OF PRV)		=	24.2
ACTUAL LENGTH OF SYSTEM	=	515	FT
DEVELOPED LENGTH OF SYSTEM (515' X 1.5)	=	773	FT
AVERAGE PRESSURE DROP (PRESSURE AVAILABLE FOR PIPE SIZING) X 100 FT / (DEVELOPED LENGTH OF SYSTEM)		(24.2PSI / 773)	
	=	3.1	PSI/100 FT AVG
SUMMARY			
PIPE SIZING BASED UPON 3.1 PSI LOSS PER 100' AVG			

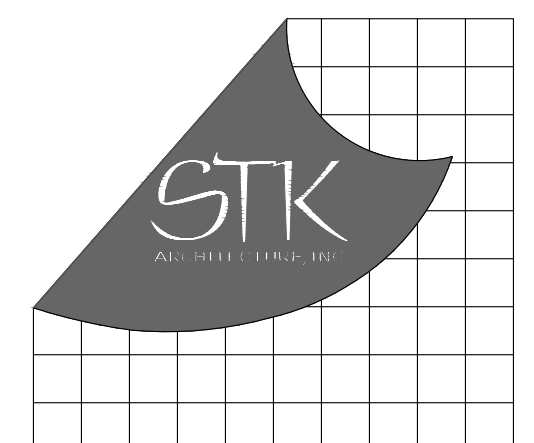

PROJECT ADMINISTERED BY:
SAN BERNARDINO COUNTY
PROJECT & FACILITIES
MANAGEMENT DEPARTMENT

385 N. ARROWHEAD AVE.
SAN BERNARDINO, CA 92415

PROJECT NAME:
SAN BERNARDINO
COUNTY FIRE
DEPARTMENT:
FIRE STATION 226

PROJECT # 10J0J032
CIP #21-037
CAFM # SABI98
APN # 0273-011-22

1920 DEL ROSA AVE N.
SAN BERNARDINO,
CA 92404

ISSUE INFORMATION:	
DATE:	INFORMATION:
04-11-2022	20% CD SET
04-28-2022	50% CD SET
06-15-2022	95% CD SET
09-16-2022	95% CD- 3rd BAY
10-03-2022	PLAN CHECK

SHEET INFORMATION:
STK PROJECT NO.: 374-154-21
SCALE: AS NOTED
DATE: JANUARY 2021
PLOT DATE:
DRAWING NAME:
SEAL:



SHEET TITLE:
PLUMBING
SCHEDULES &
CALCULATIONS

SHEET NO.:
P0.2

GAS FIRED WATER HEATER SCHEDULE											
SYMBOL	MANUFACTURER & MODEL NO.	LOCATION	SERVICE	STORAGE (GAL.)	MBH	RECOVERY @ 90°FAT (GPH)	INLET TEMP °F	OUTLET TEMP °F	WEIGHT (LBS.)	THERMAL EFFICIENCY %	REMARKS
WH 1	A.O.SMITH BTH-250 MXI	JANITOR'S ROOM	DOMESTIC HOT WATER	100	250	323	50°	140°	1360	98	12345678

- 1

APPROVED FOR USE IN CALIFORNIA LOW NOX TYPE.
- 2
- FULLY AUTOMATIC CONTROLS WITH SAFETY SHUTOFF.

3

4

5

6



PROVIDE MANUFACTURER'S VERTICAL FLUE CONDENSATE DRAIN CONNECTION.

7

8

SYMBOL	FIXTURE	MIN. PIPE SIZE				DESCRIPTION
		CW	HW	V	S	
<div>WC1</div>	WATER CLOSET (TANK TYPE)	3/4"	--	2"	4"	AMERICAN STANDARD "CADET 3 FLOWISE" #2833.128 ELONGATED TOILET. 1.28 GPF. WHITE VITREOUS CHINA. SEAT: OLSONITE #95SSC. OPEN FRONT SEAT LESS COVER.
<div>WC2</div>	WATER CLOSET (TANK TYPE, ADA)	3/4"	--	2"	4"	AMERICAN STANDARD "CADET RIGHT HEIGHT" #2835.128 ELONGATED TOILET. 1.28 GPF. WHITE VITREOUS CHINA. ADA. LOCATE ACTUATOR AS PER ADA. SEAT: OLSONITE #95SSC. OPEN FRONT SEAT LESS COVER.
<div>L1</div>	LAVATORY (COUNTERTOP, ADA)	3/4"	3/4"	1-1/2"	2"	AMERICAN STANDARD "AQUALYN" #0476.028 LAVATORY. VITREOUS CHINA, SELF-RIMMING, FRONT OVERFLOW. FAUCET: CHICAGO FAUCET #2200-4E39-VPABCP SINGLE HANDLE, DECK MOUNTED WITH 0.35 GPM AERATOR AND POINT-OF-USE TMV. PROVIDE "LAV-GUARD 2" P-TRAP COVER.
<div>L2</div>	LAVATORY (WALL MOUNT, ADA)	3/4"	3/4"	1-1/2"	2"	AMERICAN STANDARD "LUCERNE" #0355.012 LAVATORY. VITREOUS CHINA, FRONT OVERFLOW, FAUCET LEDGE. FAUCET: CHICAGO FAUCET #2200-4E39-VPABCP SINGLE HANDLE, DECK MOUNTED WITH 0.35 GPM AERATOR AND POINT-OF-USE TMV. PROVIDE "LAV-GUARD 2" P-TRAP COVER.
<div>SH1</div>	SHOWER	3/4"	3/4"	1-1/2"	2"	"AMERICAN STANDARD" #1662.213. FLOWISE 1.5 GPM COMMERCIAL SHOWER SYSTEM WITH HAND SHOWER AND FIXED SHOWERHEAD, IN-LINE VACUUM BREAKER, METAL HOSE, SLIDE BAR, 2-WAY DIVERTER VALVE AND HANDLE.
<div>KS1</div>	KITCHEN SINK	3/4"	3/4"	1-1/2"	2"	JUST MANUFACTURING #DL-1933-A-GR SINK. TYPE 304, 18 GAUGE STAINLESS STEEL, SELF-RIMMING, 4" CENTERS. FAUCET: MOEN "SALORA" #CA7570C SINGLE HANDLE, CHROME PULLOUT FAUCET.
<div>FS1</div>	FLOOR SINK	--	--	1-1/2"	2"	ZURN #N1900-P-2. CAST IRON BODY WITH SQUARE SLOTTED LIGHT-DUTY 1/2" GRATE WITH PORCELAIN ENAMEL INTERIOR AND TOP WITH INTERIOR BOTTOM DOME STRAINER AND TRAP PRIMER CONNECTION.
<div>FD1</div>	FLOOR DRAIN	--	--	1-1/2"	2"	ZURN #N415B-P-Y. CAST IRON BODY WITH BOTTOM OUTLET, COMBINATION INVERTIBLE MEMBRANE CLAMP AND COLLAR WITH NICKEL BRONZE STRAINER, TRAP PRIMER CONNECTION AND SEDIMENT BUCKET.
<div>SHD1</div>	SHOWER DRAIN	--	--	1-1/2"	2"	ZURN #FD2260. SHOWER STALL DRAIN. ABS BODY WITH BOTTOM OUTLET, GASKET SEAL AND STAINLESS STEEL ROUND STRAINER.
<div>AD1</div>	AREA DRAIN	--	--	2"	4"	ZURN #N415S-HD-P. CAST IRON BODY WITH BOTTOM OUTLET, COMBINATION INVERTIBLE MEMBRANE CLAMP AND COLLAR WITH HEAVY DUTY TRAFFIC RATED GRATE, AND TRAP PRIMER CONNECTION.
<div>HB1</div>	HOSE BIBB	3/4"	--	--	--	ZURN #Z130S-VB N-N-FREEZE WALL HYDRANT. ENCASED HYDRANT WITH BRONZE BODY, ALL BRONZE INTERIOR PARTS, KEY OPERATED CONTROL VALVE, STAINLESS STEEL BOX WITH HINGED COVER WITH LOCK.
<div>HB2</div>	HOSE BIBB	3/4"	--	--	--	ZURN #Z139S-VB NON-FREEZE YARD HYDRANT. EXPOSED HYDRANT WITH CAST IRON HEAD AND LIFT HANDLE. BRONZE INTERIOR PARTS, GALVANIZED STEEL CASING WITH BRONZE VALVE HOUSING, DRAIN PORT.
<div>MS1</div>	MOP SINK	3/4"	3/4"	2"	3"	CECO #871 CORNER SERVICE SINK. FAUCET: AMERICAN STANDARD #8344.112 EXPOSED YOKE WALL-MOUNT UTILITY FAUCET. PROVIDE CECO B71-3" DRAIN AND B-872 COATED WIRE RIM GUARD.
<div>LS1</div>	LAUNDRY SINK	3/4"	3/4"	2"	3"	CUSTOM FREE STANDING TYPE 304, 14 GAUGE STAINLESS STEEL, WITH DRAINBOARD AND LEGS. SINK DIM. 24" X 18" X 12" DEEP. OVERALL DIMENSION 24" FRONT TO BACK X 63" LONG X 36" HIGH W/12" BACKSPLASH. FAUCET: CHICAGO #509-GCLP WALL MOUNTED POT FILLER WITH SPRAY VALVE.
<div>LS2</div>	LAUNDRY SINK	3/4"	3/4"	1 1/2"	2"	WALL HUNG. JUST MANUFACTURING DRAWING A-18664. TYPE 304, 14 GAUGE STAINLESS STEEL. FAUCET: JS-47-TGSA.
<div>BS1</div>	BAR SINK	3/4"	3/4"	1 1/2"	2"	UST MODEL# SL-ADA-17519-A-GR LEDGE TYPE, TOP MOUNT SS TYPE 304, 18-8 FAUCET: MOEN MODEL METHOD #7585 SERIES. SINGLE LEVER TYPEPULLOUT SPOUT.
<div>EX1</div>	EXTRACTOR	3/4"	3/4"	2	3	WASHER-EXTRACTOR B&C TECHNOLOGIES MODEL HE-65.
<div>WB1</div>	CLOTHES WASHER SUPPLY BOX	3/4"	3/4"	1 1/2"	2"	CLY GRAY #82048 SUPPLY BOX. HOT DIPPED GALVANIZED STEEL, 20 GAUGE FACEPLATE, 18 GAUGE BOX. HAMMER ARRESTER VALVES, MALE THREADED DRAIN FITTING.
<div>IM1</div>	ICE MAKER SUPPLY BOX	1/2"	--	--	--	CLY GRAY #BIM875AB SUPPLY BOX. HOT DIPPED GALVANIZED STEEL, 20 GAUGE FACEPLATE, 18 GAUGE BOX.
<div>DW1</div>	DISHWASHER	--	3/4"	--	--	REFER TO ARCHITECTURAL SPECIFICATION.

PLUMBING EQUIPMENT SCHEDULE					
TAG	EQUIPMENT	LOCATION	MANUFACTURER	MODEL	REMARKS
<div>WHA1</div>	WATER HAMMER ARRESTOR	VARIES	MIFAB	HAMMERGARD MWH SERIES	PROVIDE WITH APPROVED ACCESS PANEL. SEE DETAIL 11/P5.1.
<div>TP1</div>	TRAP PRIMER	VARIES	MIFAB	M2-500	PROVIDE WITH MI-DU 4-WAY DISTRIBUTION UNIT (IF APPLICABLE). PROVIDE WITH APPROVED ACCESS PANEL. SEE DETAIL 1/P5.2.
<div>WF1</div>	WATER FILTER	FOR ICE MACHINE	ICE-O-MATIC	IFQ1	1000 LBS OF ICE/DAY, 1.5 GPM, 125 MAX PSI, 100°F MAX, 0.5 MICRON FILTER 5 LBS., QUARTER TURN CARTRIDGE, NSF CERTIFIED.
<div>TV1</div>	TEMPERING VALVE	JANITOR'S ROOM	POWERS	1432-RB	INSTALL PER MANUFACTURER'S INSTRUCTION'S.
<div>CP1</div>	CIRCULATION PUMP	JANITOR'S ROOM	TACO	113	1/8 HP, 115 V, 60HZ, 1ø, 27 LBS. INSTALL PER MANUFACTURER'S INSTRUCTIONS. PROVIDE AQUASTAT.
<div>ET1</div>	EXPANSION TANK	JANITOR'S ROOM	AMTROL	THERM-X-TROL ST-12	SIZED PER MANUFACTURER'S RECOMMENDATIONS.
<div>CA1</div>	AIR COMPRESSOR	AIR COMPRESSOR ROOM	INGERSOLL-RAND	2340N5-V	80 GAL VERT RECENER, 5HP, 2 STAGE COMPRESSOR, 14.0 CFM AT 175 PSIG MAX, LOW LEVEL SWITCH, AIR COOLED AFTER COOLED, ELECTRIC TANK DRAIN, MAGNETIC STARTER, START UP KIT, 208V, 3ø.
<div>GD1</div>	GARBAGE DISPOSAL	KITCHEN	IN-SINK-ERATOR	BADGER 5	1/2 HP, 120 V, 60HZ, 1725 RPM, 12-5/8" HEIGHT, 20 LBS. INSTALL PER MANUFACTURER'S INSTRUCTIONS.
<div>OI1</div>	OIL INTERCEPTOR	DRIVEWAY (B/C)	JENSEN PRE-CAST	PC C-750	750 GALLON OIL INTERCEPTOR. PROVIDE TRAFFIC RATED HEAVY DUTY CAST IRON FRAME AND COVERS WITH GAS TIGHT GASKETS. SEE DETAIL 10/P5.1 FOR SIZING CALCULATION.
<div>GO1</div>	GAS OUTLET BOX	VARIES	GUY GRAY	MGB1	20 GAUGE BOX AND FACEPLATE, WHITE POWDER COAT ON COLD ROLLED STEEL.
<div>RPBP1</div>	REDUCED PRESSURE BACKFLOW PREVENTER	VARIES	WILKINS	375XL	LINE SIZED LEAD-FREE REDUCED PRESSURE BACKFLOW PREVENTER.
<div>PRV1</div>	PRESSURE REDUCING VALVE	PER PLAN	WILKINS	500 XL SERIES	LOCATED IN YARDBOX WITH BUILDING SHUT-OFF VALVE.
<div>AGV1</div>	AUTOMATIC GAS SHUT-OFF VALVE	KITCHEN	JEFFERSON SOLENOID	1332	LINE SIZED. NORMALLY OPEN OPERATION. AUTOMATICALLY CLOSSES WHEN SIGNAL IS RECEIVED AND MANUALLY OPEN AND RESET ONLY WHEN SIGNAL IS OFF. VALVE SHALL BE INTERLOCKED WITH CALL-IN DISPATCH RADIO FOR SHUT-OFF UPON ACTIVATION. FOR INTERLOCKING, SEE ELECTRICAL DRAWINGS.

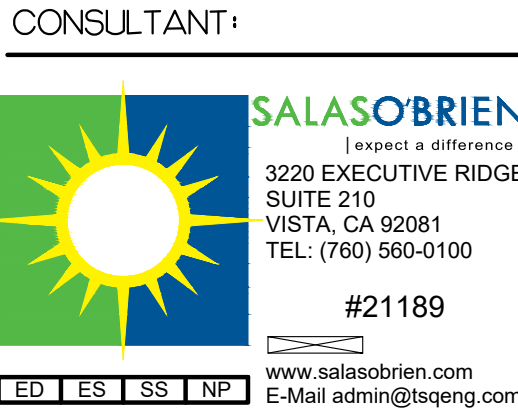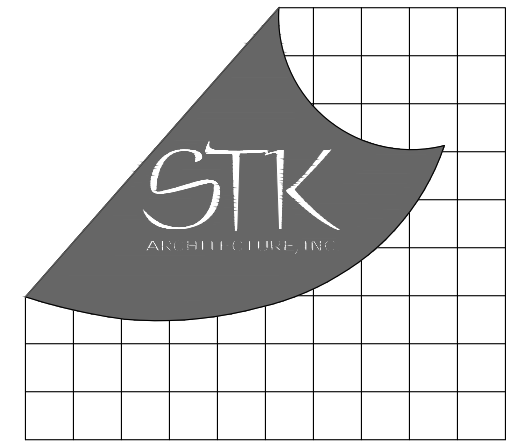

PROJECT ADMINISTERED BY:
SAN BERNARDINO COUNTY
PROJECT & FACILITIES
MANAGEMENT DEPARTMENT

385 N. ARROWHEAD AVE.
SAN BERNARDINO, CA 92415

PROJECT NAME:
SAN BERNARDINO
COUNTY FIRE
DEPARTMENT:
FIRE STATION 226

PROJECT # 10J0J032
CIP #21-037
CAFM # SAB198
APN # 0273-011-22

1920 DEL ROSA AVE N.
SAN BERNARDINO,
CA 92404

ISSUE INFORMATION:	
DATE:	INFORMATION:
04-11-2022	20% CD SET
04-28-2022	50% CD SET
06-15-2022	95% CD SET
09-16-2022	95% CD- 3rd BAY
10-03-2022	PLAN CHECK

SHEET INFORMATION:
STK PROJECT NO.: 374-154-21
SCALE: AS NOTED
DATE: JANUARY 2021
PLOT DATE:
DRAWING NAME:

SEAL:




SHEET TITLE:

PLUMBING
SCHEDULES

SHEET NO.:

P0.3

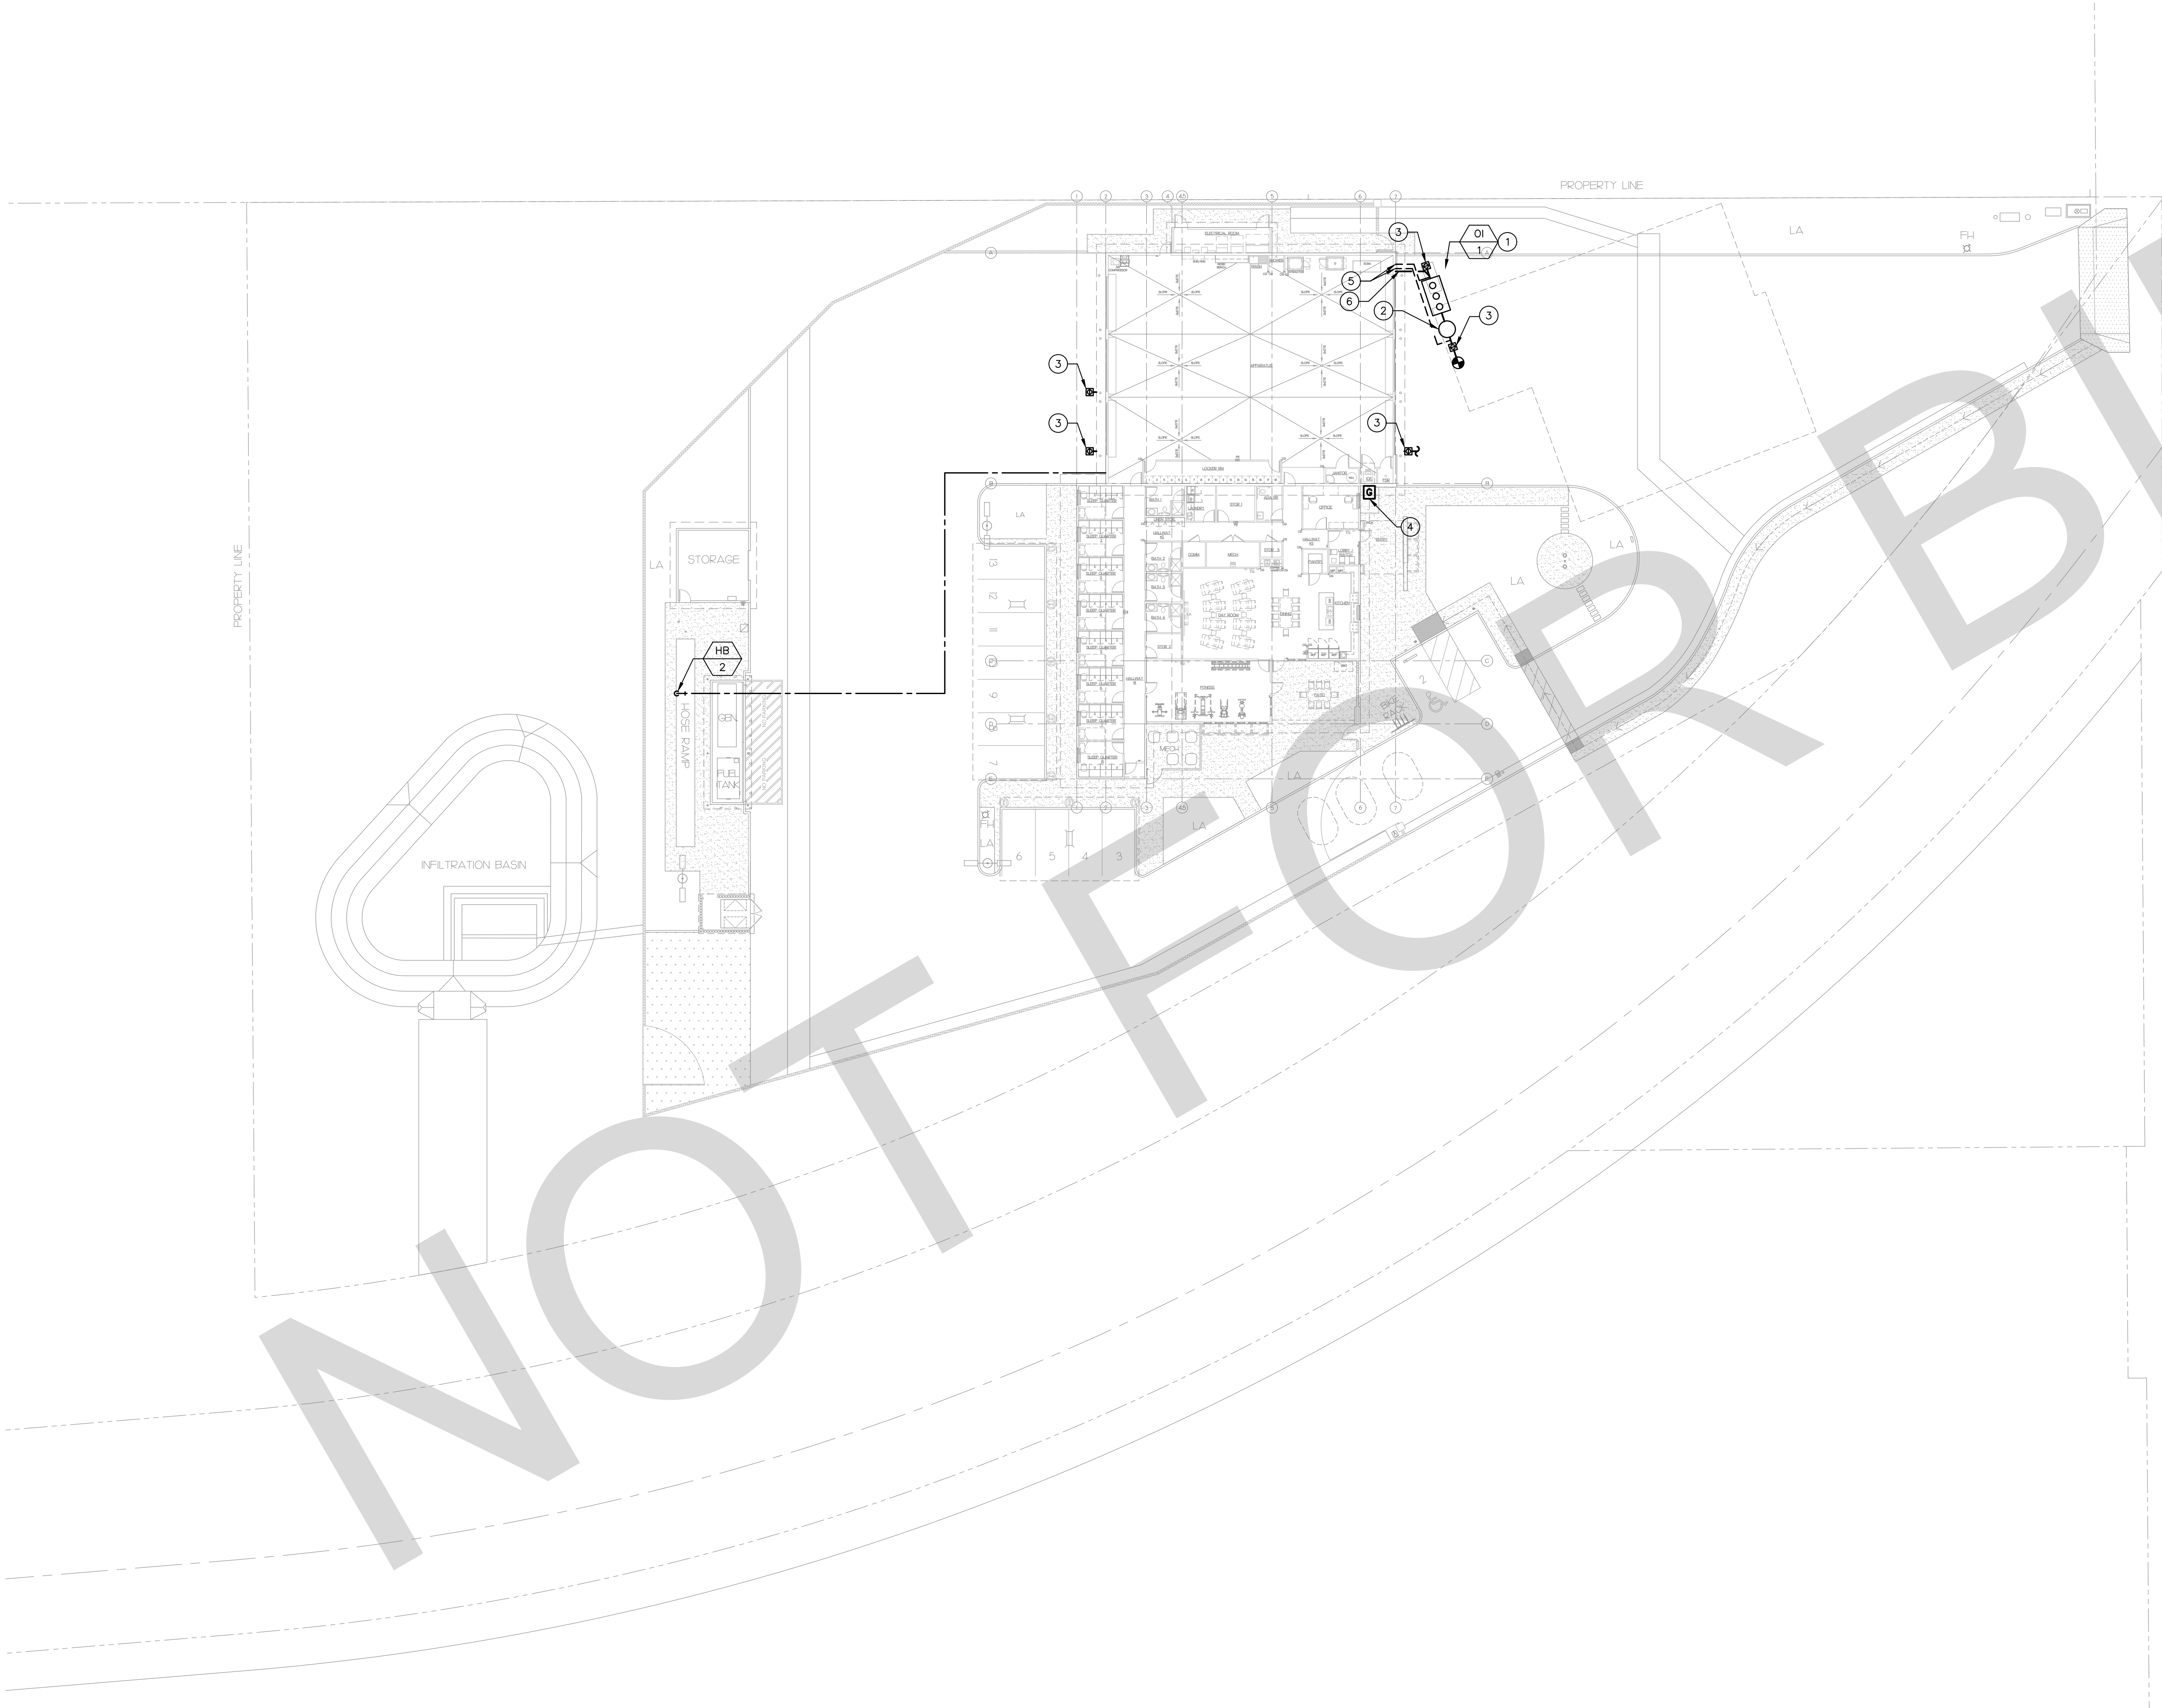

GENERAL NOTES

- A. CONTRACTOR SHALL FIELD VERIFY EXACT LOCATION OF ALL PIPING AND UTILITIES PRIOR TO START OF WORK. IN THE EVENT OF ANY DISCREPANCIES OR POTENTIAL CONFLICTS, NOTIFY THE ARCHITECT AND ENGINEER IN WRITING PRIOR TO START OF WORK.
- B. ALL PIPING LOCATIONS ARE DIAGRAMMATIC. CONTRACTOR SHALL COORDINATE WITH ALL TRADES AND OWNER'S REPRESENTATIVE AND VERIFY EXACT ROUTING PRIOR TO START OF WORK.
- C. VERIFY EXACT SIZE AND LOCATION OF ALL PLUMBING CONNECTIONS TO MECHANICAL EQUIPMENT PRIOR TO START OF WORK. IN NO CASE SHALL THE CONNECTION SIZE BE LARGER THAN THE BRANCH PIPING SIZE.

KEY NOTES



- ① 750 GALLON CLARIFIER. SEE DETAIL ___/P5.1.
- ② 24" SAMPLING BOX. PROVIDE HEAVY DUTY TRAFFIC-RATED COVER.
- ③ GRADE CLEAN OUT. SEE DETAIL 2/P3.1.
- ④ PROPOSED GAS METER LOCATION. OBTAIN APPROVAL FROM GAS UTILITY COMPANY PRIOR TO INSTALLATION.
- ⑤ 2" VENT IN WALL UP TO CEILING.
- ⑥ 4" OILE OW TO CLARIFIER.

FINISHED FLOOR ELEVATION: 1160

UPSTREAM MANHOLE INVERT ELEVATION: 44.50

CONTRACTOR SHALL FIELD VERIFY EXACT ELEVATION PRIOR TO START OF WORK. IN CASE OF ANY DISCREPANCIES OR POTENTIAL CONFLICTS, INFORM THE ARCHITECT AND ENGINEER IN WRITING BEFORE PROCEEDING FURTHER.

BACKWATER VALVE NOT REQUIRED.

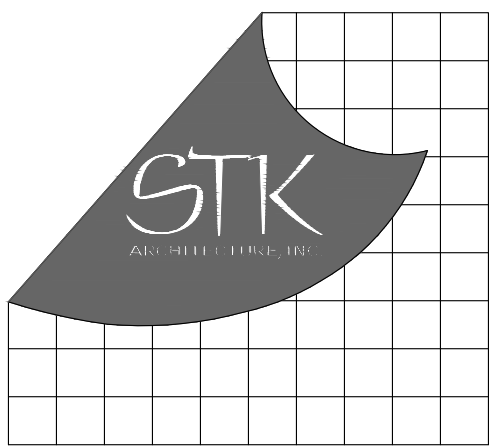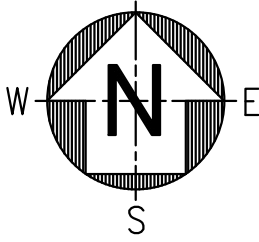

PROJECT ADMINISTERED BY:
SAN BERNARDINO COUNTY
PROJECT & FACILITIES
MANAGEMENT DEPARTMENT

385 N. ARROWHEAD AVE.
SAN BERNARDINO, CA 92415

PROJECT NAME:
SAN BERNARDINO
COUNTY FIRE
DEPARTMENT:
FIRE STATION 226

PROJECT # 10J0J032
CIP #21-037
CAFM # SAB198
APN # 0273-011-22

1920 DEL ROSA AVE N.
SAN BERNARDINO,
CA 92404

ISSUE INFORMATION:	
DATE:	INFORMATION:
04-11-2022	20% CD SET
04-28-2022	50% CD SET
06-15-2022	95% CD SET
09-16-2022	95% CD- 3rd BAY
10-03-2022	PLAN CHECK

SHEET INFORMATION:

STK PROJECT NO.: 374-154-21

SCALE: AS NOTED

DATE: JANUARY 2021

PLOT DATE: -

DRAWING NAME: -

SEAL:




SHEET TITLE:


PLUMBING
SITE PLAN

SHEET NO.:

P1.1

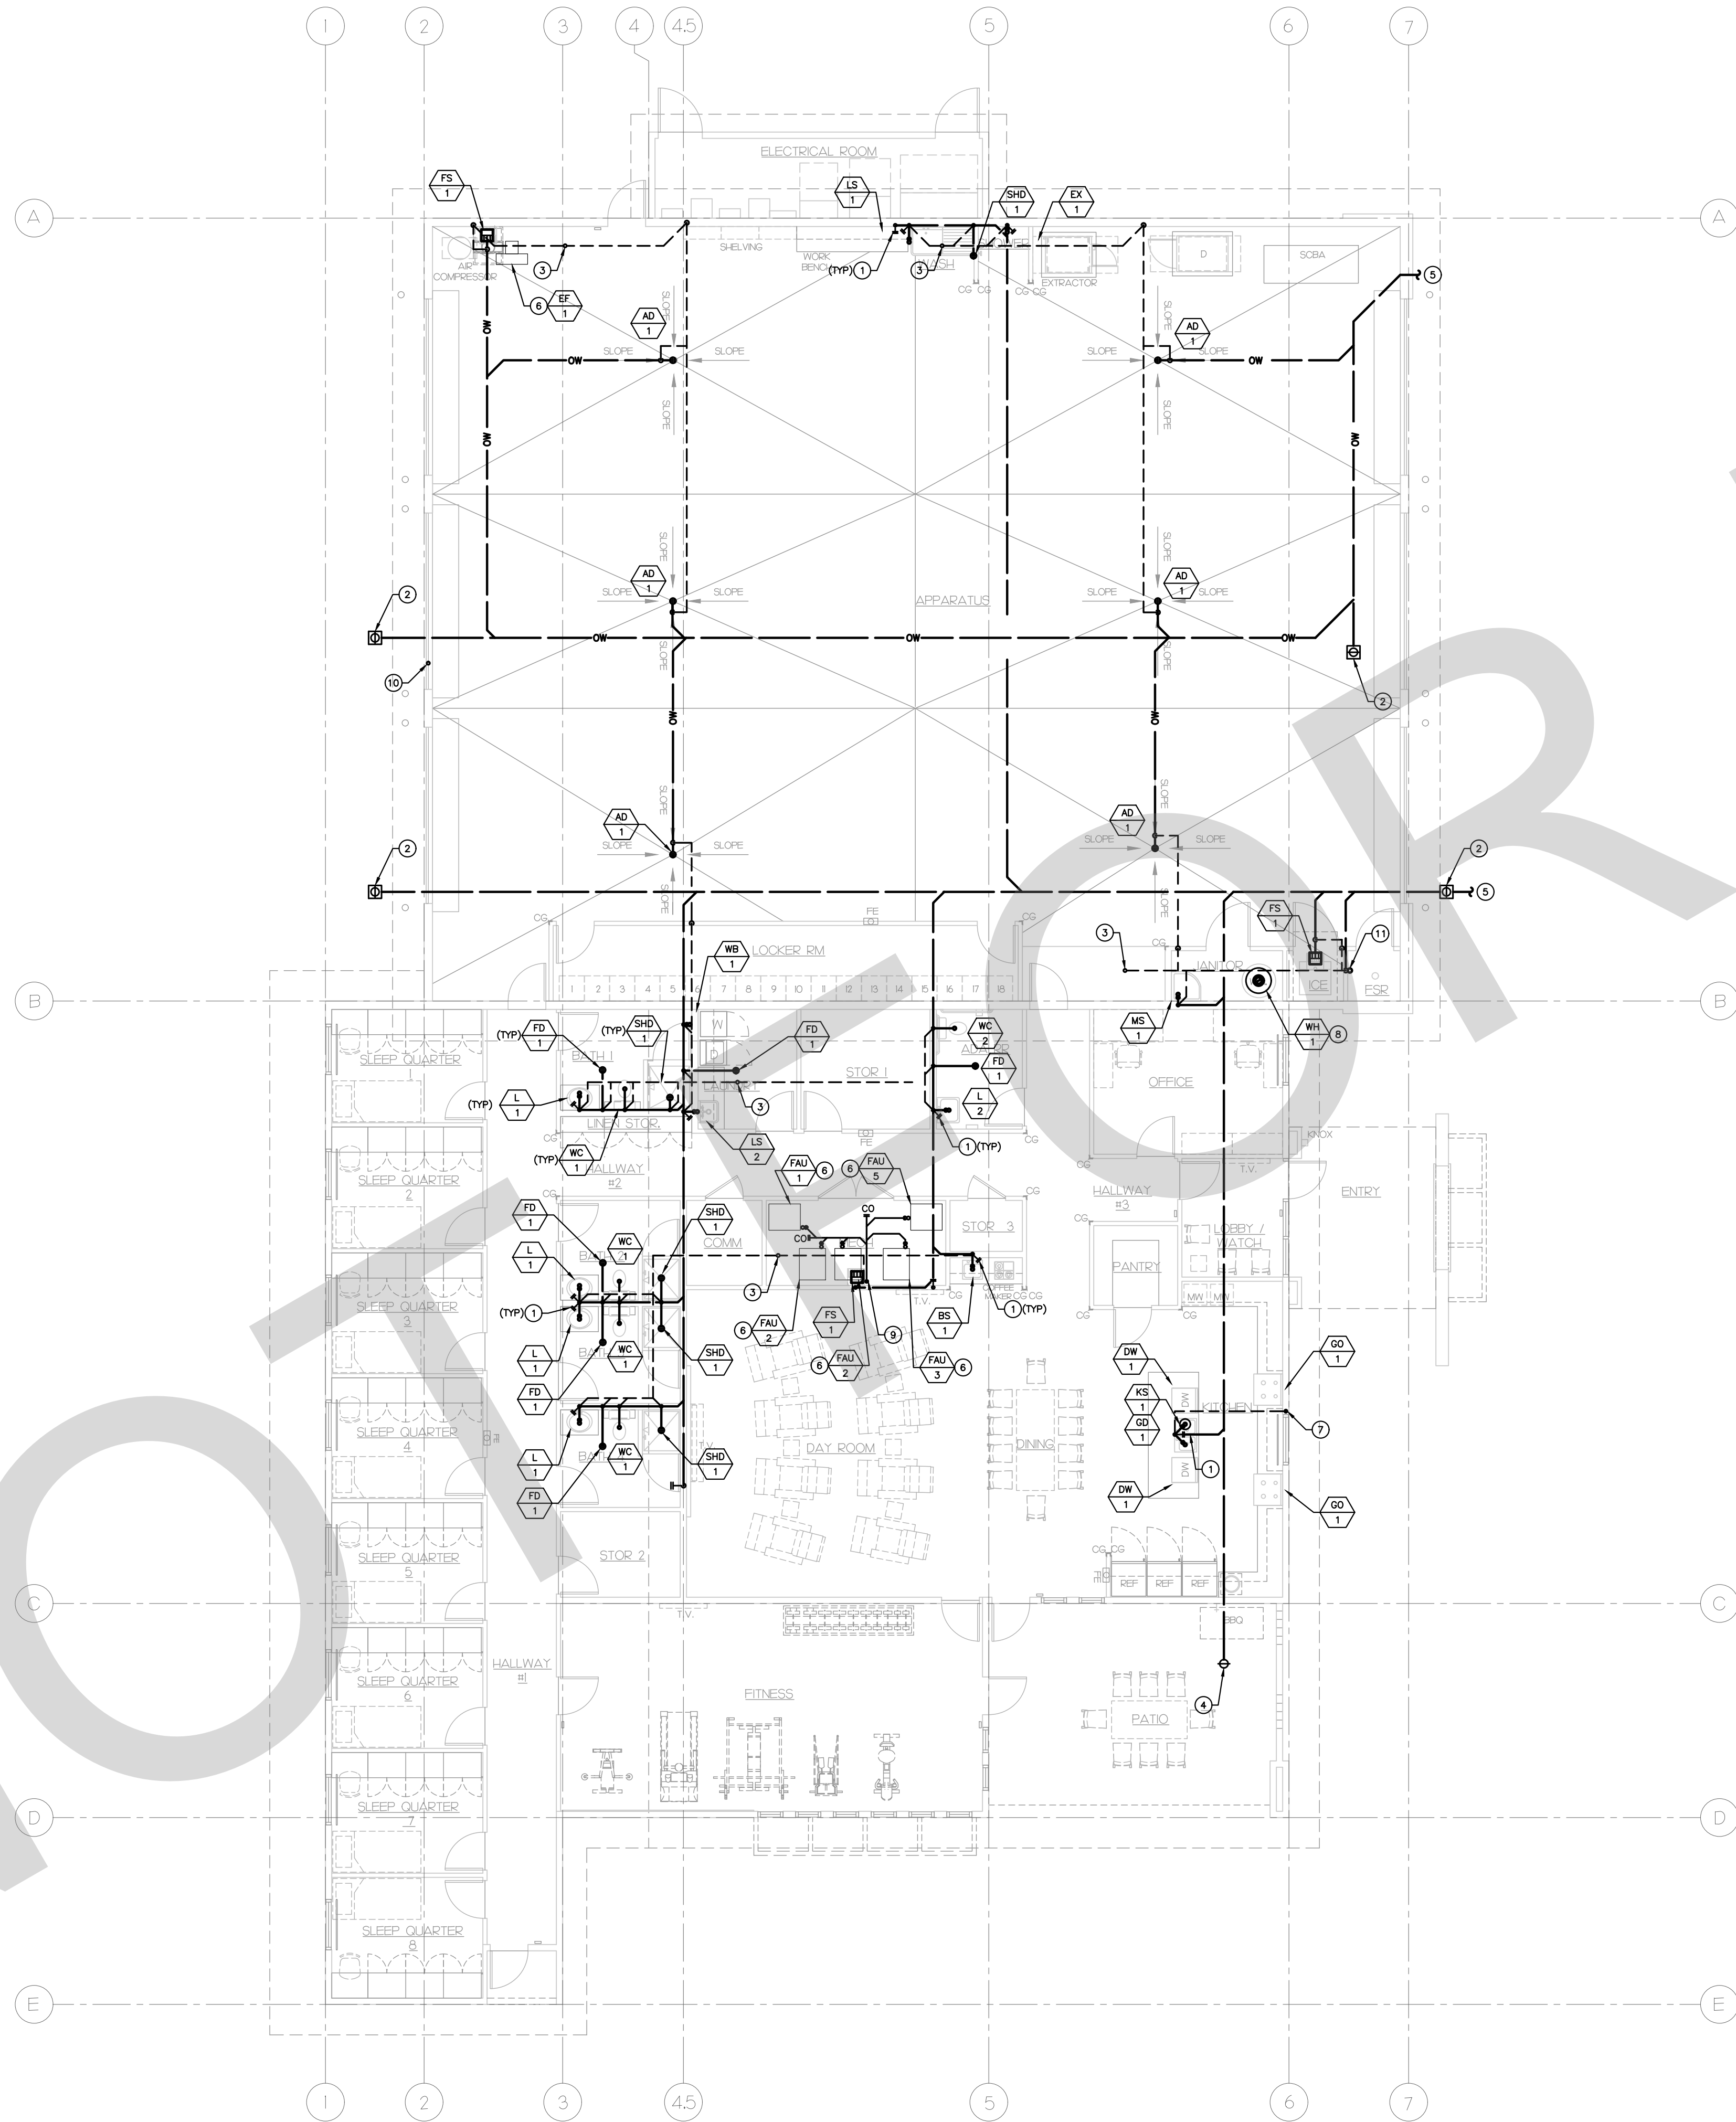

PLUMBING FLOOR PLAN - SEWER & VENT 1
1/8" = 1'-0"

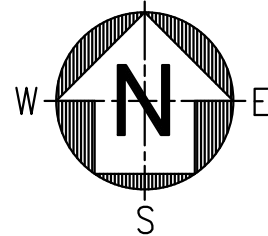


GENERAL NOTES

- A. CONTRACTOR SHALL FIELD VERIFY EXACT LOCATION OF ALL PIPING AND UTILITIES PRIOR TO START OF WORK. IN THE EVENT OF ANY DISCREPANCIES OR POTENTIAL CONFLICTS, NOTIFY THE ARCHITECT AND ENGINEER IN WRITING PRIOR TO START OF WORK.
- B. ALL PIPING LOCATIONS ARE DIAGRAMMATIC. CONTRACTOR SHALL COORDINATE WITH ALL TRADES AND OWNER'S REPRESENTATIVE AND VERIFY EXACT ROUTING PRIOR TO START OF WORK.
- C. VERIFY EXACT SIZE AND LOCATION OF ALL PLUMBING CONNECTIONS TO MECHANICAL EQUIPMENT PRIOR TO START OF WORK. IN NO CASE SHALL THE CONNECTION SIZE BE LARGER THAN THE BRANCH PIPING SIZE.

KEY NOTES

- 1 WALL CLEAN OUT. SEE DETAIL 4/P5.1.
- 2 HEAVY DUTY TRAFFIC RATED GRADE CLEAN OUT. SEE DETAIL 5/P5.1.
- 3 VENT THRU ROOF. SEE DETAIL 1/P5.1.
- 4 FLOOR CLEAN OUT. SEE DETAIL 5/P5.1.
- 5 FOR CONTINUATION, SEE P1.1.
- 6 MECHANICAL UNIT SHOWN FOR REFERENCE ONLY. SEE MECHANICAL PLANS FOR EXACT LOCATION. ROUTE CONDENSATE DRAIN DOWN TO FLOOR SINK. SEE DETAIL 2/P5.2.
- 7 VENT UP FROM BELOW FLOOR THRU ROOF. SEE DETAIL 1/P5.1.
- 8 ROUTE WATER HEATER PTR AND DRAIN PIPING TO MOP SINK. TERMINATE AT MIN. 1" AIR GAP ABOVE FIXTURE RIM.
- 9 ROUTE 3/4" CONDENSATE/EQUIPMENT DRAIN WITH INSULATION DOWN IN WALL TO FLOOR SINK. TERMINATE AT MIN. 1" AIR GAP ABOVE FIXTURE RIM. SEE DETAIL 2/S.2.
- 10 VENT FROM OIL INTERCEPTOR UP THRU ROOF.
- 11 SPRINKLER RISER HUB DRAIN. SEE DETAIL 3/P5.1.

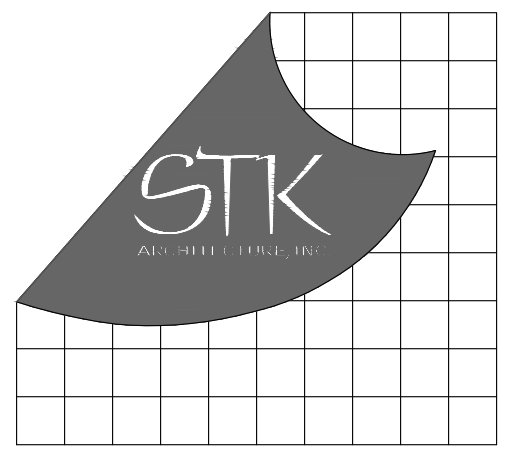

PROJECT ADMINISTERED BY:
SAN BERNARDINO COUNTY
PROJECT & FACILITIES
MANAGEMENT DEPARTMENT

385 N. ARROWHEAD AVE.
SAN BERNARDINO, CA 92415

PROJECT NAME:
SAN BERNARDINO
COUNTY FIRE
DEPARTMENT:
FIRE STATION 226

PROJECT # 10J0J032
CIP #21-037
CAFM # SAB198
APN # 0273-011-22

1920 DEL ROSA AVE N.
SAN BERNARDINO,
CA 92404

ISSUE INFORMATION:	
DATE:	INFORMATION:
04-11-2022	20% CD SET
04-28-2022	50% CD SET
06-15-2022	95% CD SET
09-16-2022	95% CD- 3rd BAY
10-03-2022	PLAN CHECK

SHEET INFORMATION:
STK PROJECT NO.: 374-154-21
SCALE: AS NOTED
DATE: JANUARY 2021
PLOT DATE:
DRAWING NAME:


SEAL:



SHEET TITLE:
PLUMBING
FLOOR PLAN
SEWER & VENT

SHEET NO.:

P2.1

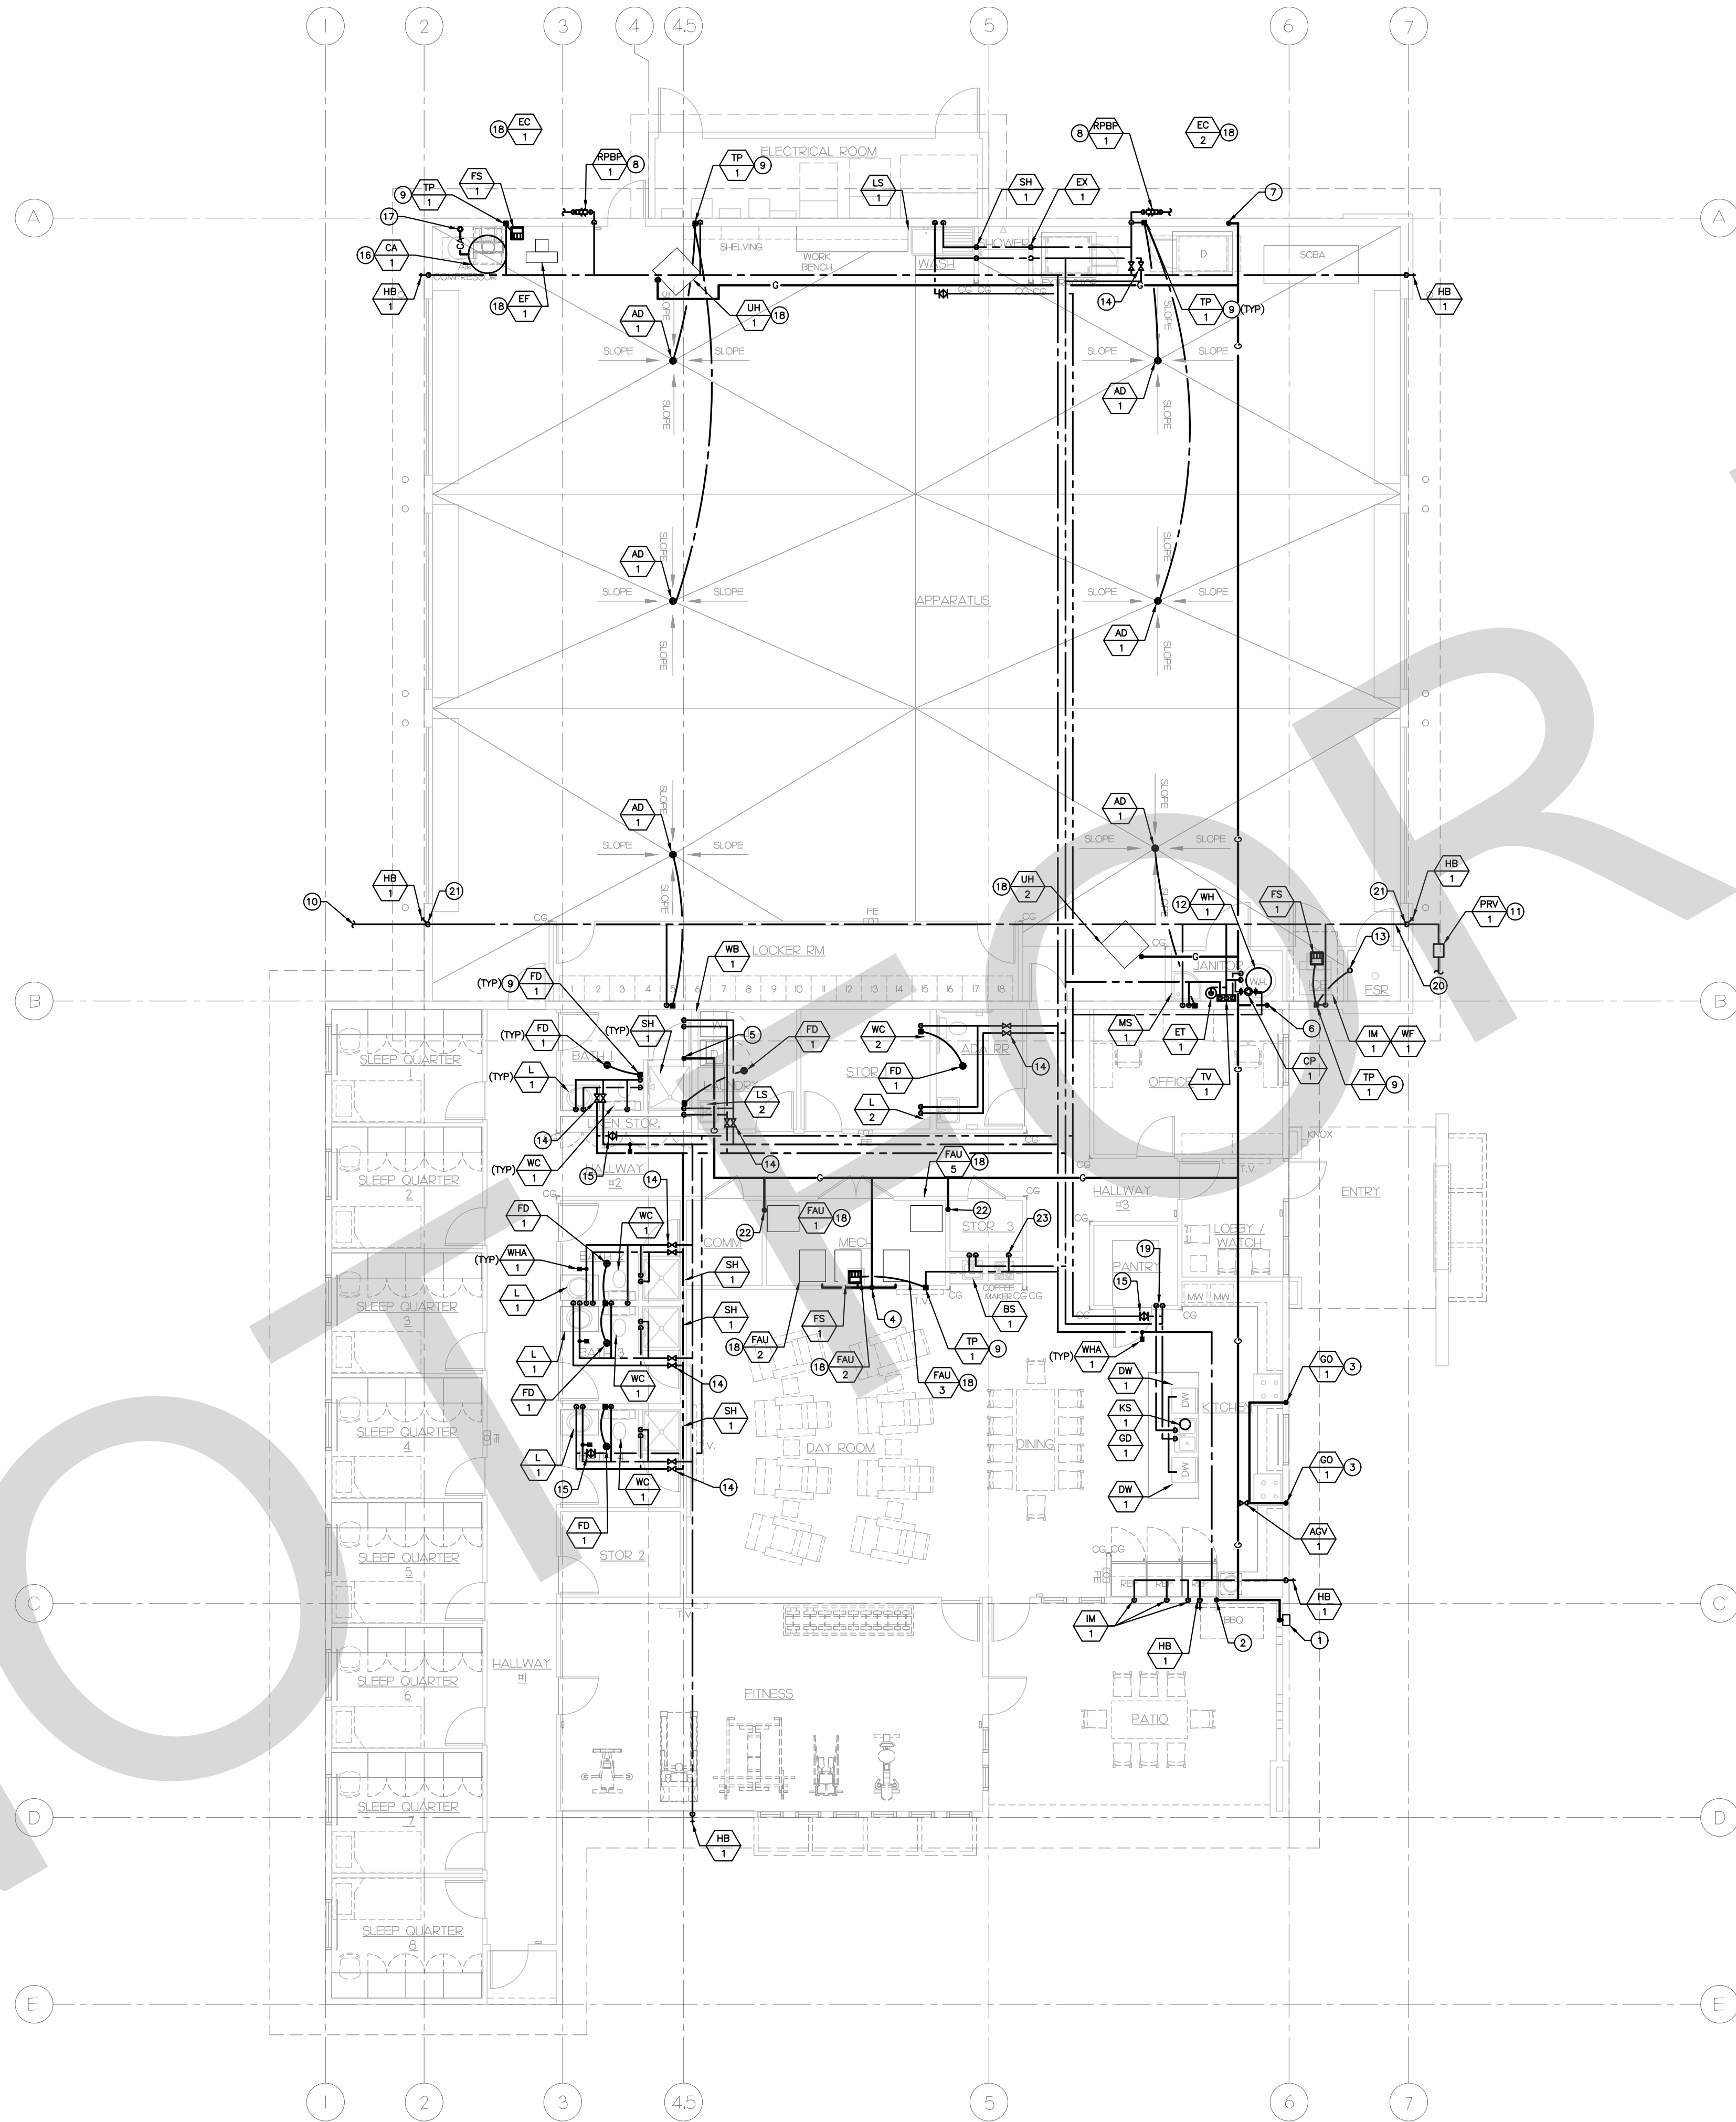


GENERAL NOTES

- A. CONTRACTOR SHALL FIELD VERIFY EXACT LOCATION OF ALL PIPING AND UTILITIES PRIOR TO START OF WORK. IN THE EVENT OF ANY DISCREPANCIES OR POTENTIAL CONFLICTS, NOTIFY THE ARCHITECT AND ENGINEER IN WRITING PRIOR TO START OF WORK.
- B. ALL PIPING LOCATIONS ARE DIAGRAMMATIC. CONTRACTOR SHALL COORDINATE WITH ALL TRADES AND OWNER'S REPRESENTATIVE AND VERIFY EXACT ROUTING PRIOR TO START OF WORK.
- C. VERIFY EXACT SIZE AND LOCATION OF ALL PLUMBING CONNECTIONS TO MECHANICAL EQUIPMENT PRIOR TO START OF WORK. IN NO CASE SHALL THE CONNECTION SIZE BE LARGER THAN THE BRANCH PIPING SIZE.

KEY NOTES

- 1. PROPOSED GAS METER LOCATION.
- 2. 3/4" GAS DOWN IN WALL TO BBQ.
- 3. 1" GAS DOWN IN WALL TO RANGE.
- 4. 1 1/2" GAS DOWN IN WALL TO MECHANICAL EQUIPMENT. SEE GAS CONNECTION DETAIL 6/PS.1.
- 5. 3/4" GAS DOWN IN WALL TO DRYER-1.
- 6. 1 1/4" GAS DOWN IN WALL TO WATER HEATER.
- 7. 1" GAS DOWN IN WALL TO DRYER-2.
- 8. RPBP FOR CW SUPPLY TO EVAP COOLER.
- 9. 1/2" CW DOWN TO TRAP PRIMER. SEE DETAIL 1/PS.2.
- 10. SEE SHEET P1.1 FOR CONTINUATION.
- 11. CW SOV AND PRV IN YARDBOX. SEE DETAIL 4/PS.2.
- 12. GAS-FIRED WATER HEATER. SEE DETAIL 7/PS.1. ROUTE PTR PIPING TO MOP SINK.
- 13. FIRE RISER HUB DRAIN. SEE DETAIL 3/PS.1.
- 14. CW AND HW SHUT-OFF VALVE ABOVE CEILING. PROVIDE APPROVED ACCESS PANEL IF ABOVE HARD-LID CEILING.
- 15. HWR BALANCING VALVE ABOVE CEILING. PROVIDE APPROVED ACCESS PANEL IF ABOVE HARD-LID CEILING.
- 16. AIR COMPRESSOR FLOOR-MOUNTED BELOW PLYMOVENT PLATFORM. SEE 8/PS.1. FOR PIPING DETAIL.
- 17. COMPRESSED AIR UP AGAINST WALL TO PLYMOVENT FOR CONNECTION.
- 18. MECHANICAL EQUIPMENT SHOWN FOR REFERENCE ONLY. SEE MECHANICAL PLANS FOR EXACT LOCATION AND SPECIFICATIONS.
- 19. 3/4" CW AND 3/4" HW DOWN IN WALL TO UNDER SLAB TO KS-1 AND DW-1.
- 20. 2" CW PIPE UP IN WALL.
- 21. 3/4" PIPE DOWN IN WALL ROUTED TO HB-1 OUTSIDE BLDG.
- 22. 1" GAS DOWN IN WALL TO MECHANICAL EQUIPMENT.
- 23. 1/2" CW TO COFFEE MACHINE.

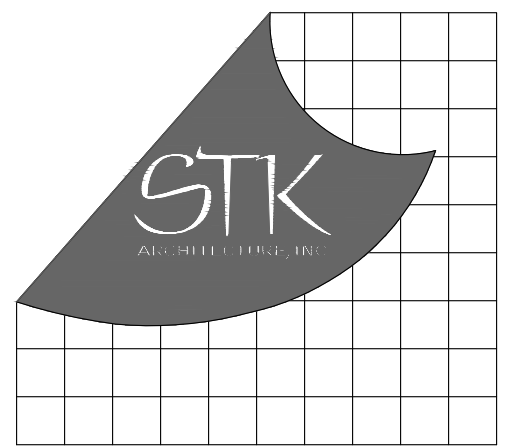

PROJECT ADMINISTERED BY:
SAN BERNARDINO COUNTY
PROJECT & FACILITIES
MANAGEMENT DEPARTMENT

385 N. ARROWHEAD AVE.
SAN BERNARDINO, CA 92415

PROJECT NAME:
SAN BERNARDINO
COUNTY FIRE
DEPARTMENT:
FIRE STATION 226

PROJECT # 10J0J032
CIP #21-037
CAFM # SAB198
APN # 0273-011-22

1920 DEL ROSA AVE N.
SAN BERNARDINO,
CA 92404

ISSUE INFORMATION:	
DATE:	INFORMATION:
04-11-2022	20% CD SET
04-28-2022	50% CD SET
06-15-2022	95% CD SET
09-16-2022	95% CD- 3rd BAY
10-03-2022	PLAN CHECK

SHEET INFORMATION:
STK PROJECT NO.: 374-154-21
SCALE: AS NOTED
DATE: JANUARY 2021
PLOT DATE:
DRAWING NAME:

SEAL:



SHEET TITLE:
PLUMBING
FLOOR PLAN
DOMESTIC
WATER


SHEET NO.:


P2.2

PLUMBING FLOOR PLAN - DOMESTIC WATER

1/8" = 1'-0"

1

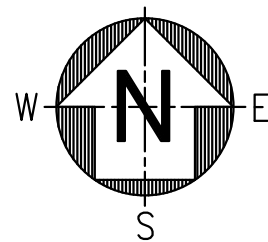

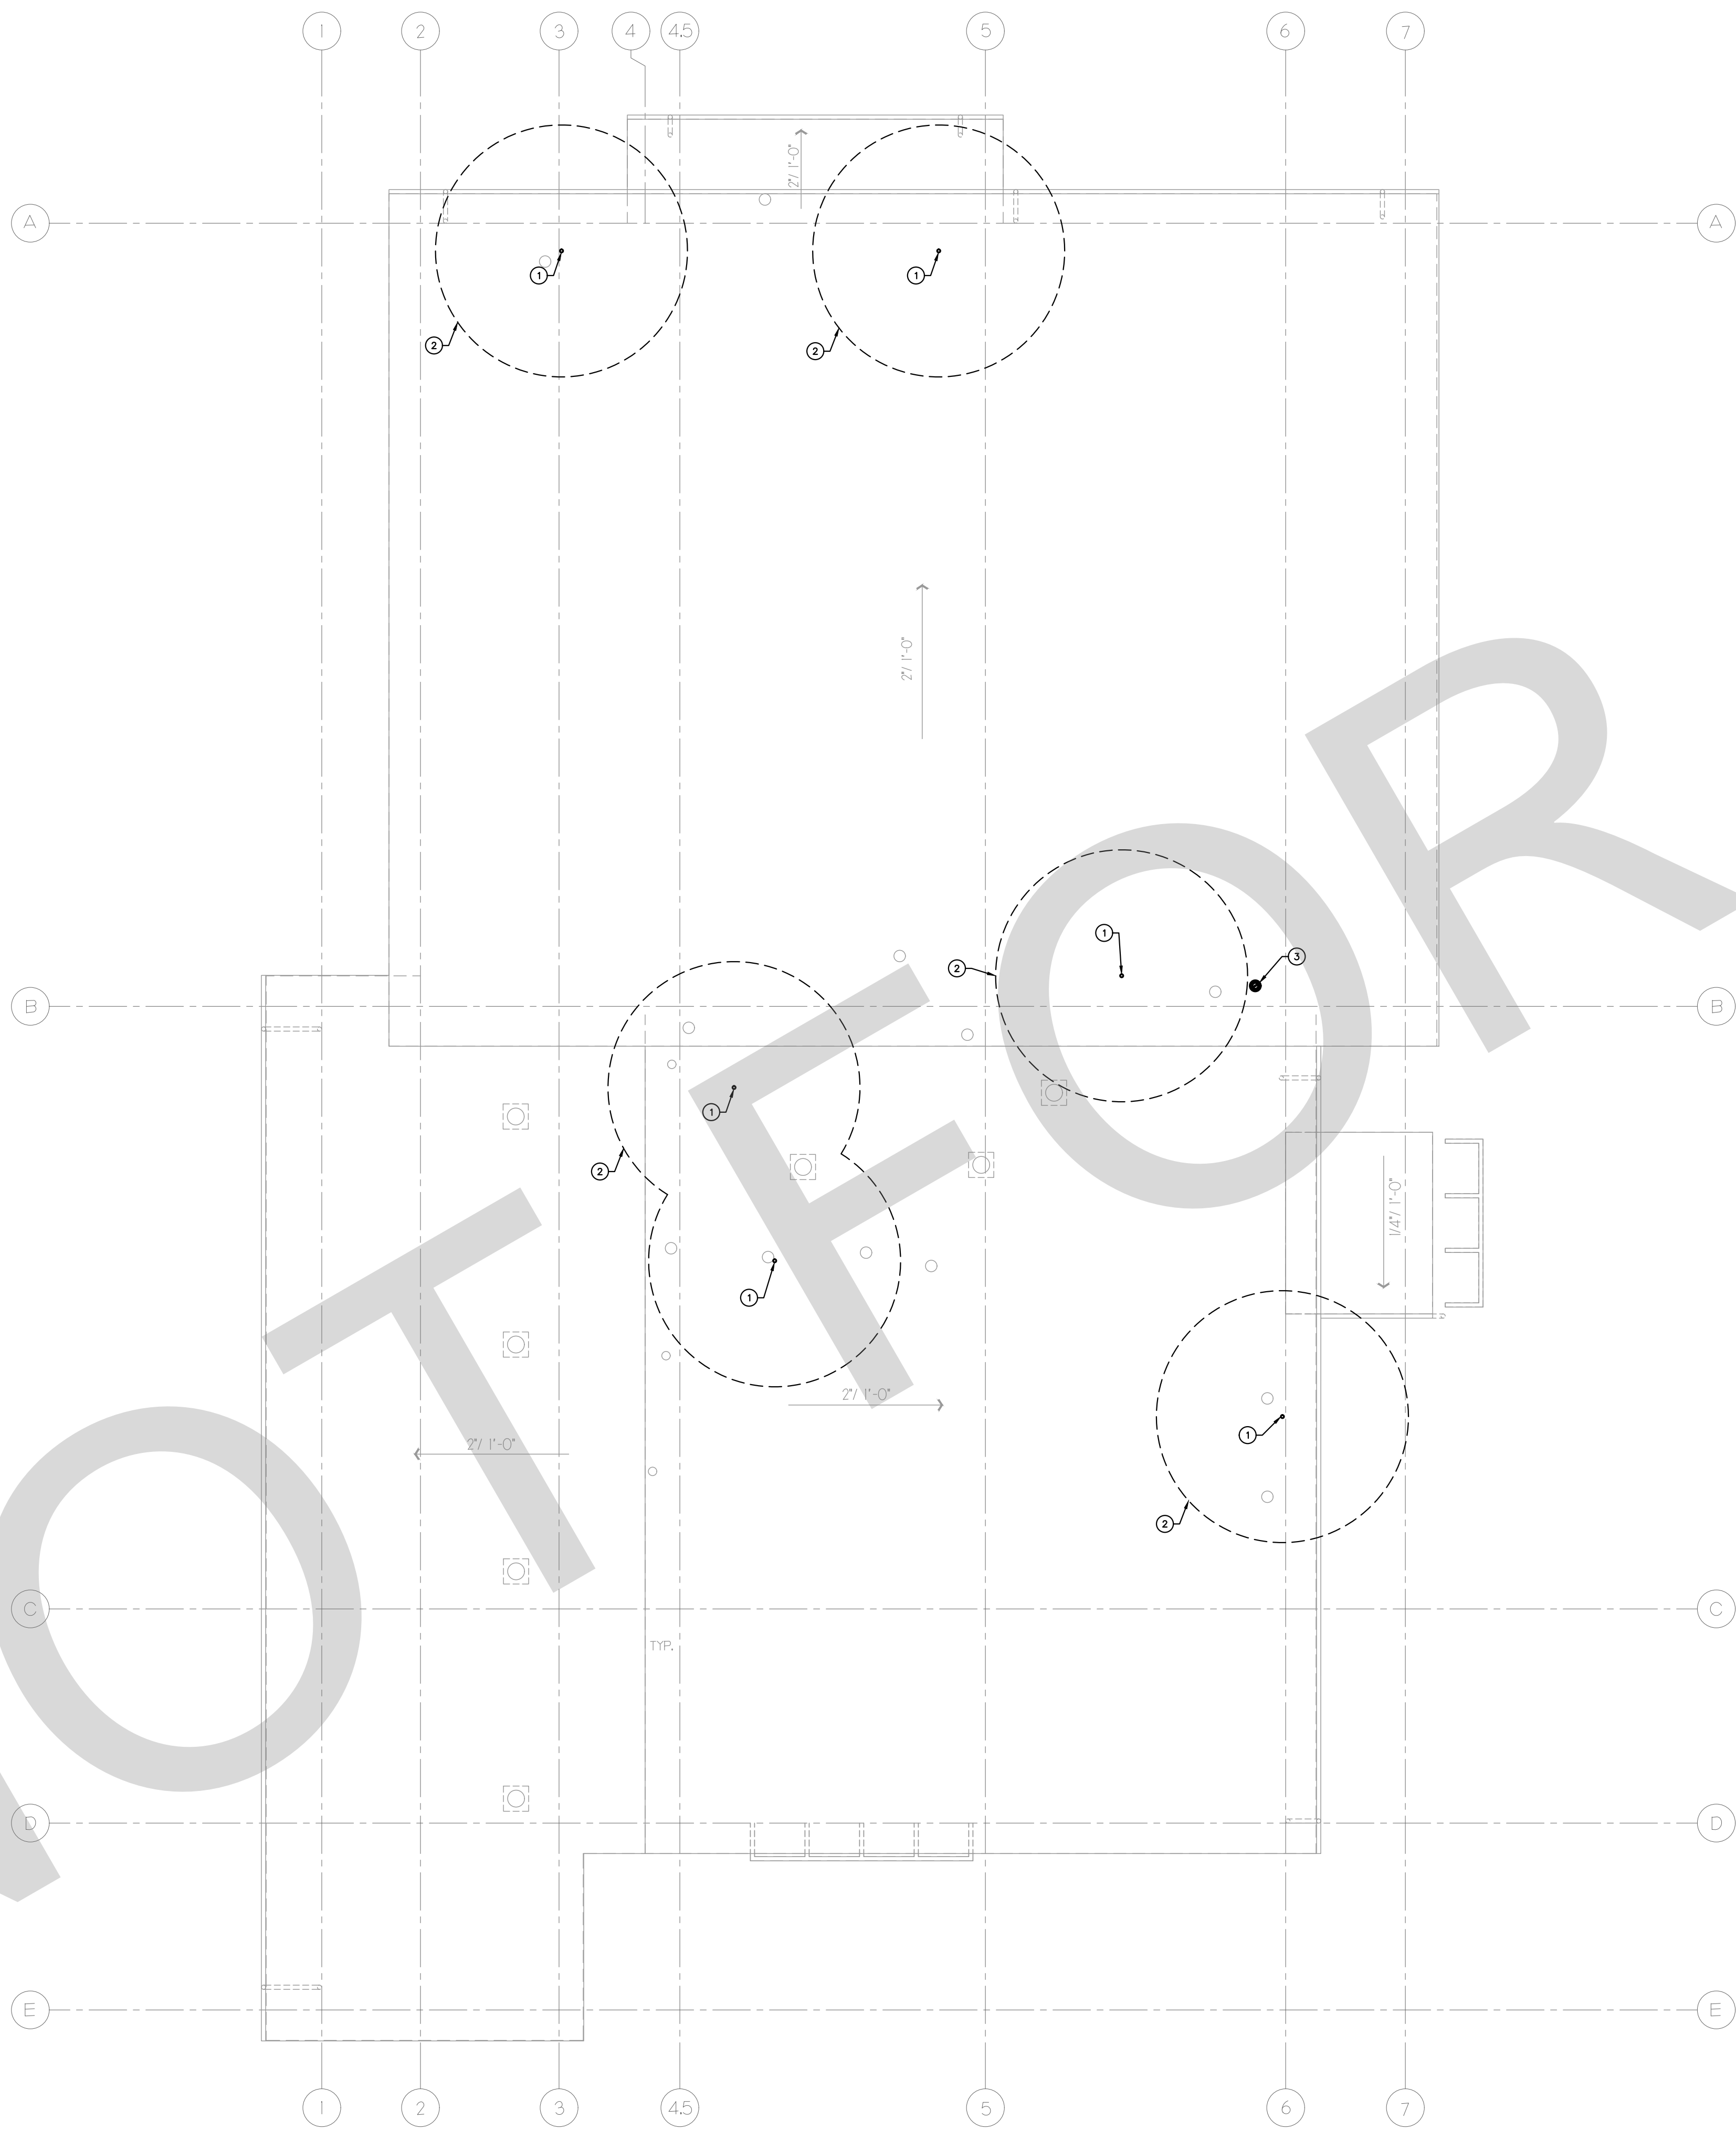


GENERAL NOTES

- A. CONTRACTOR SHALL FIELD VERIFY EXACT LOCATION OF ALL PIPING AND UTILITIES PRIOR TO START OF WORK. IN THE EVENT OF ANY DISCREPANCIES OR POTENTIAL CONFLICTS, NOTIFY THE ARCHITECT AND ENGINEER IN WRITING PRIOR TO START OF WORK.
- B. ALL PIPING LOCATIONS ARE DIAGRAMMATIC. CONTRACTOR SHALL COORDINATE WITH ALL TRADES AND OWNER'S REPRESENTATIVE AND VERIFY EXACT ROUTING PRIOR TO START OF WORK.
- C. VERIFY EXACT SIZE AND LOCATION OF ALL PLUMBING CONNECTIONS TO MECHANICAL EQUIPMENT PRIOR TO START OF WORK. IN NO CASE SHALL THE CONNECTION SIZE BE LARGER THAN THE BRANCH PIPING SIZE.

KEY NOTES

- ① VENT THRU ROOF. SEE DETAIL 1/P5.1.
- ② MAINTAIN MINIMUM 10 FOOT HORIZONTAL CLEARANCE FROM AND 3 FOOT VERTICAL CLEARANCE ABOVE ALL OPERABLE WINDOWS, DOORS AND MECHANICAL AIR INTAKES, BUILDING OPENINGS, AND VENT SHAFTS.
- ③ WATER HEATER CONCENTRIC VENT. INSTALL PER MANUFACTURER'S WRITTEN INSTRUCTIONS.

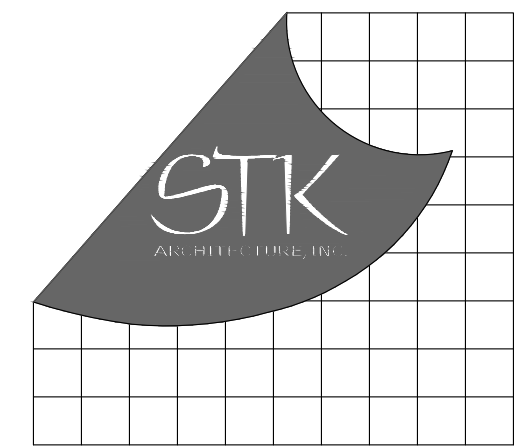

4205 ZEVU DR., TEMECULA, CALIFORNIA 92590-3760
Phone: 951.266.8110 Fax: 951.266.6079 Email: sk@stkinc.com

CONSULTANT:



3220 EXECUTIVE RIDGE
SUITE 210
VISTA, CA 92081
TEL: (760) 560-0100
www.salasobrien.com
E-Mail: admin@stsqeng.com

PROJECT ADMINISTERED BY:

SAN BERNARDINO COUNTY
PROJECT & FACILITIES
MANAGEMENT DEPARTMENT

385 N. ARROWHEAD AVE.
SAN BERNARDINO, CA 92415

PROJECT NAME:

SAN BERNARDINO
COUNTY FIRE
DEPARTMENT:
FIRE STATION 226

PROJECT # 10101032

CIP #21-037

CAFM # SAB198

APN # 0273-011-22

1920 DEL ROSA AVE N.
SAN BERNARDINO,
CA 92404

ISSUE INFORMATION:

DATE:	INFORMATION:
04-11-2022	20% CD SET
04-28-2022	50% CD SET
06-15-2022	95% CD SET
09-16-2022	95% CD- 3rd BAY
10-03-2022	PLAN CHECK

SHEET INFORMATION:

STK PROJECT NO.: 374-154-21
SCALE: AS NOTED
DATE: JANUARY 2021
PLOT DATE: -
DRAWING NAME: -

SEAL:



SHEET TITLE:

PLUMBING
ROOF PLAN


SHEET NO.:


P2.3

PLUMBING ROOF PLAN

1/8" = 1'-0"

1

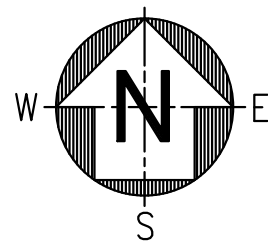

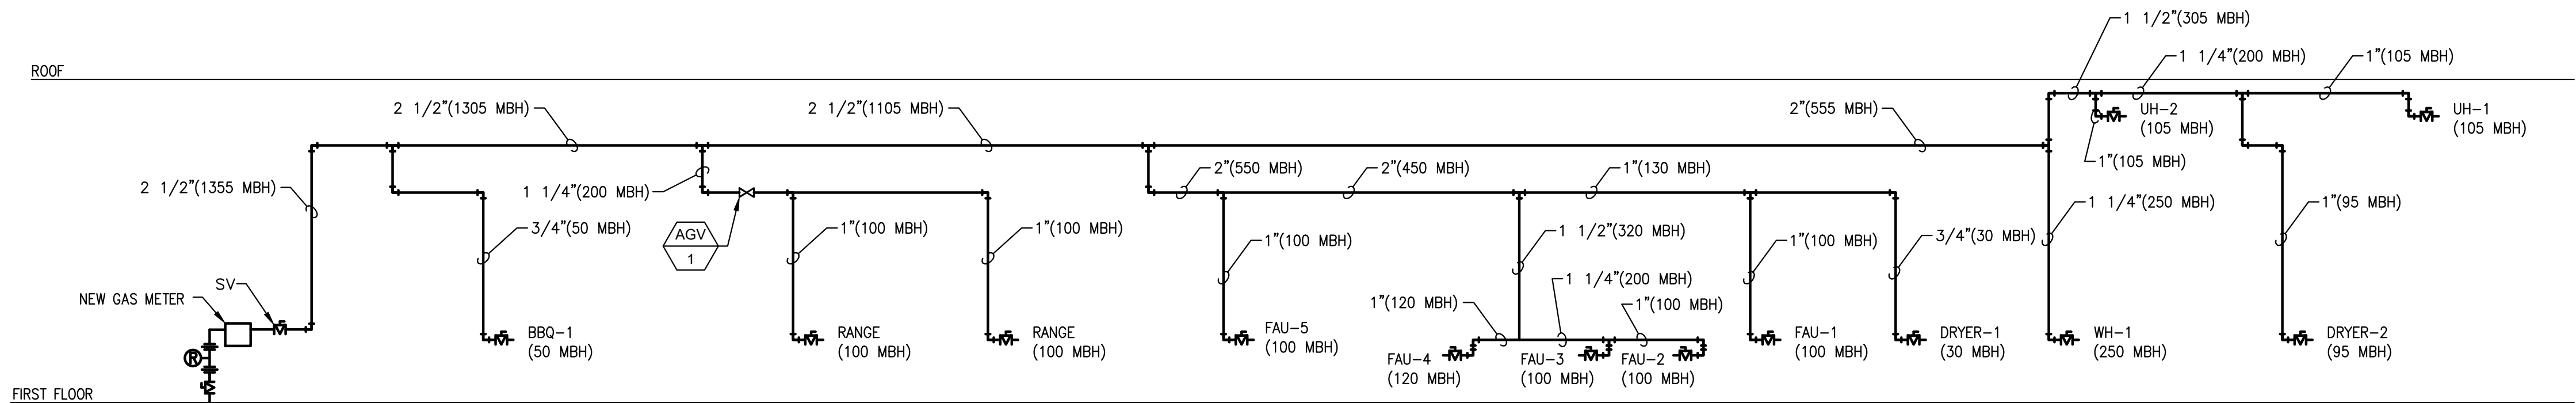

NOTES: GAS PIPE BRANCH SIZE TO EQUIPMENT SHALL NEVER BE SMALLER THAN CONNECTION SIZES TO EQUIPMENT. IN CASE OF A DISCREPANCY, PROVIDE THE LARGER SIZE PIPE.

CONTRACTOR SHALL FIELD VERIFY EXACT LENGTH, GAS LOAD REQUIREMENTS AND EQUIPMENT CONNECTION SIZES PRIOR TO START OF WORK. IN CASE OF ANY DISCREPANCIES OR POTENTIAL CONFLICT, NOTIFY ARCHITECT AND ENGINEER IN WRITING PRIOR TO START OF WORK.

FOR TYPICAL GAS CONNECTION DETAIL SEE 6/P5.1 SHEET.

TOTAL LENGTH: 161'
BASED ON TABLE 1215.2(1)
CPC
SCH.40 METALLIC PIPE
[NFPA 54:TABLE 6.2(B)]

NOMINAL	PIPE SIZE							
	1/2"	3/4"	1"	1-1/4"	1-1/2"	2"	2-1/2"	3"
LENGTH(FT)	CAPACITY IN CUBIC FEET OF GAS PER HOUR (CFH)							
175	37	77	144	296	443	854	1360	2410

NEW GAS SYSTEM

WH-1 = 250 MBH
BBQ-1 = 50 MBH
DRYER-1 = 30 MBH
DRYER-2 = 95 MBH
RANGE = 100 MBH
FAU-1 = 100 MBH
FAU-2 = 100 MBH
FAU-3 = 100 MBH
FAU-4 = 120 MBH
FAU-5 = 100 MBH
UH-1 = 105 MBH
UH-2 = 105 MBH


TOTAL NEW MBH = 1355

GAS	NATURAL
INLET PRESSURE	<2 PSI
PRESSURE DROP	0.5 IN. W.C.
SPECIFIC GRAVITY	0.60

PLUMBING RISER DIAGRAM - GAS

NO SCALE

1

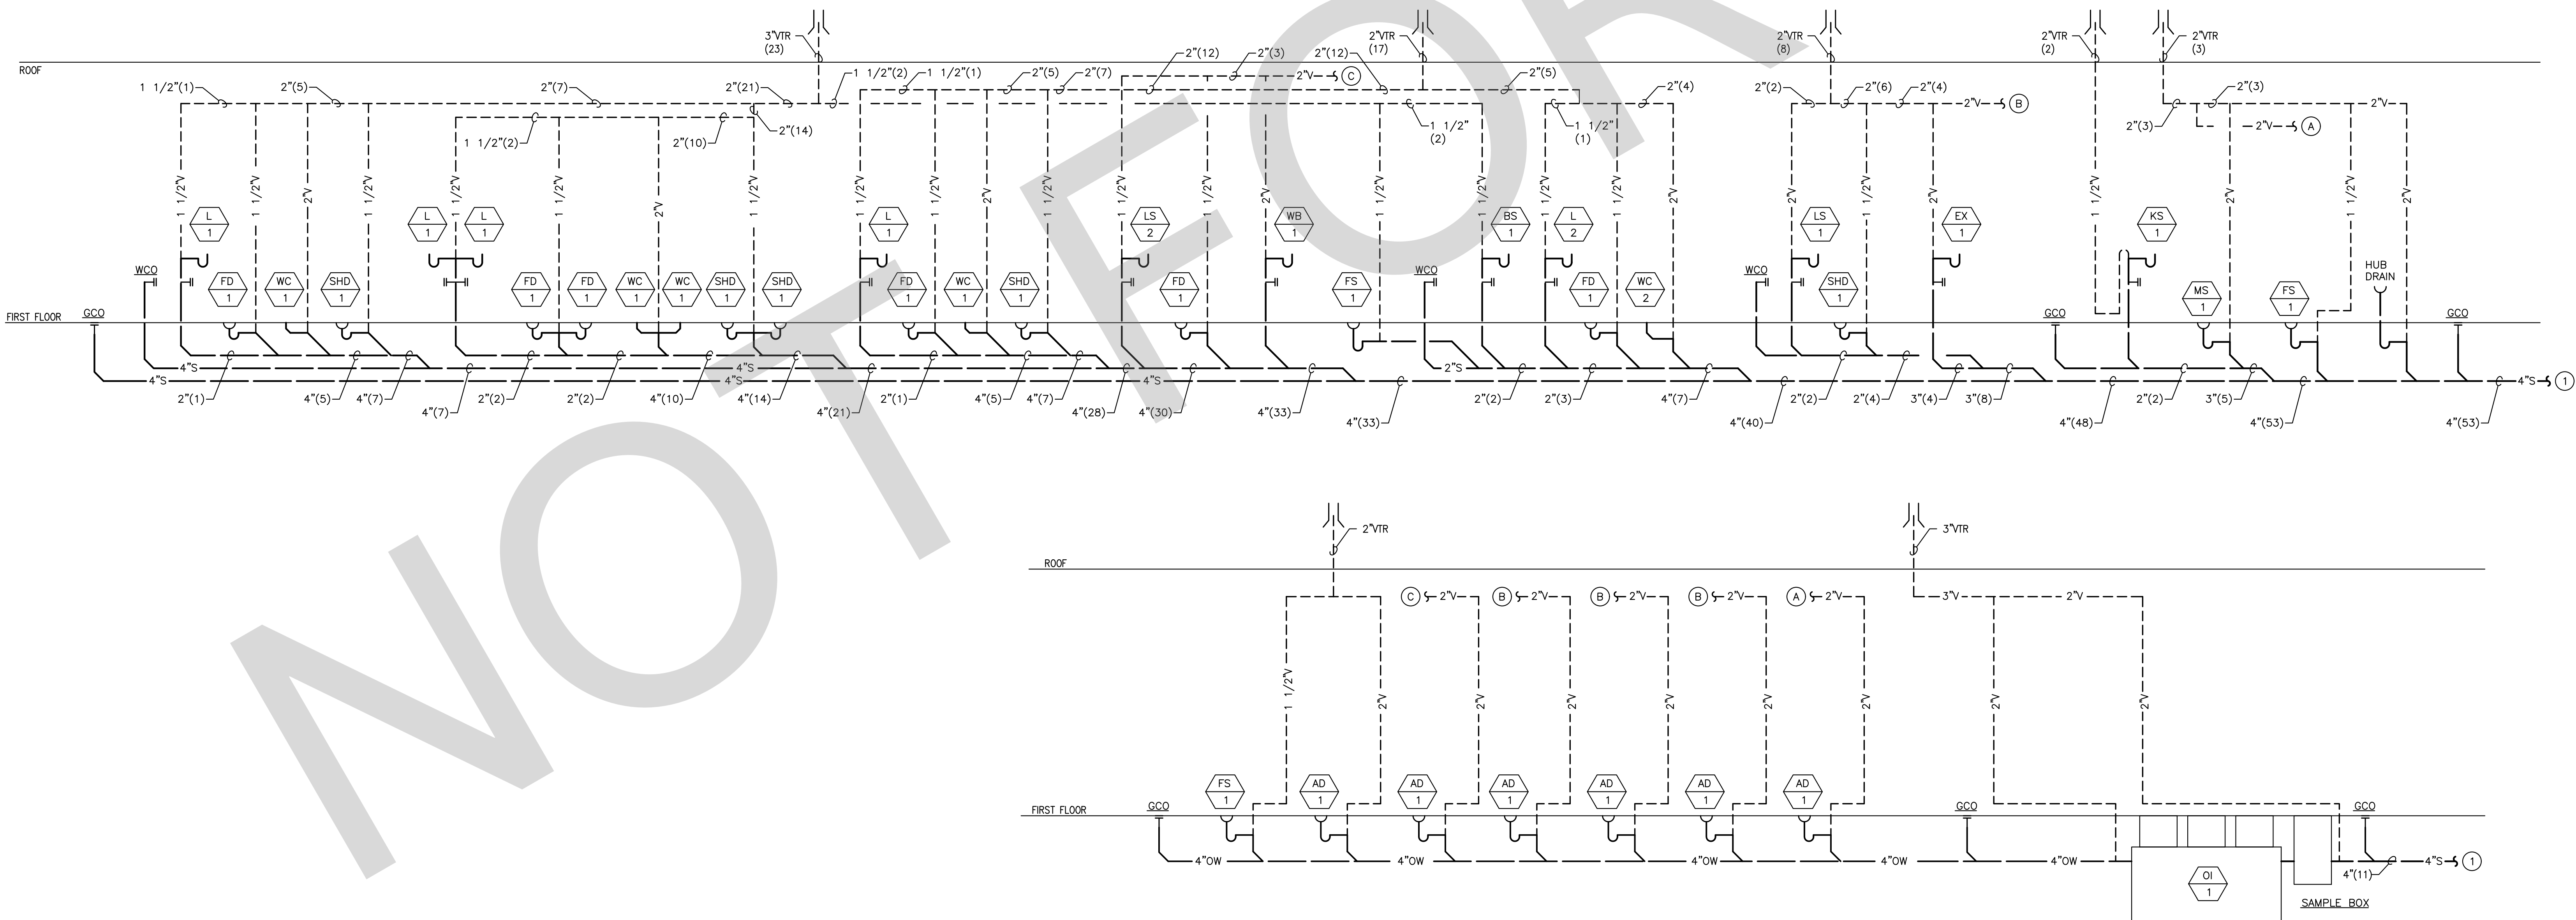

PLUMBING RISER DIAGRAM - SEWER AND VENT

NO SCALE


2

GENERAL NOTES

- CONTRACTOR SHALL FIELD VERIFY EXACT LOCATION OF ALL PIPING AND UTILITIES PRIOR TO START OF WORK. IN THE EVENT OF ANY DISCREPANCIES OR POTENTIAL CONFLICTS, NOTIFY THE ARCHITECT AND ENGINEER IN WRITING PRIOR TO START OF WORK.
- ALL PIPING LOCATIONS ARE DIAGRAMMATIC. CONTRACTOR SHALL COORDINATE WITH ALL TRADES AND OWNER'S REPRESENTATIVE AND VERIFY EXACT ROUTING PRIOR TO START OF WORK.
- VERIFY EXACT SIZE AND LOCATION OF ALL PLUMBING CONNECTIONS TO MECHANICAL EQUIPMENT PRIOR TO START OF WORK. IN NO CASE SHALL THE CONNECTION SIZE BE LARGER THAN THE BRANCH PIPING SIZE.

KEY NOTES

- SEE SHEET P1.1 FOR CONTINUATION.

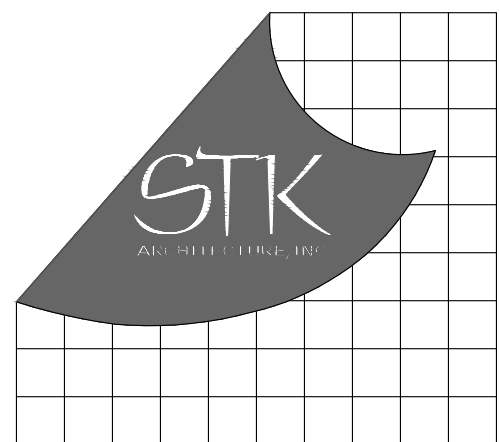

4205 ZEVU DR., TEMECULA, CALIFORNIA 92590-3760
Phone: 951.296.8110 Fax: 951.296.6079 Email: stk@stkc.com

CONSULTANT



3220 EXECUTIVE RIDGE SUITE 210
VISTA, CA 92081
TEL: (760) 560-0100
#21189
www.salasobrien.com
E-Mail: admin@salasobrien.com

PROJECT ADMINISTERED BY:

SAN BERNARDINO COUNTY
PROJECT & FACILITIES
MANAGEMENT DEPARTMENT

385 N. ARROWHEAD AVE.
SAN BERNARDINO, CA 92415

PROJECT NAME:

SAN BERNARDINO
COUNTY FIRE
DEPARTMENT:
FIRE STATION 226

PROJECT # 10.10.032

CIP #21-037

CAFM # SAB198

APN # 0273-011-22

1920 DEL ROSA AVE N.
SAN BERNARDINO,
CA 92404

ISSUE INFORMATION:

DATE:	INFORMATION:
04-11-2022	20% CD SET
04-28-2022	50% CD SET
06-15-2022	95% CD SET
09-16-2022	95% CD- 3rd BAY
10-03-2022	PLAN CHECK

SHEET INFORMATION:

STK PROJECT NO.: 374-154-21
SCALE: AS NOTED
DATE: JANUARY 2021
PLOT DATE:
DRAWING NAME:

SEAL:



SHEET TITLE:

PLUMBING
RISER
DIAGRAM

SHEET NO.:


P4.1

GENERAL NOTES

- A. CONTRACTOR SHALL FIELD VERIFY EXACT LOCATION OF ALL PIPING AND UTILITIES PRIOR TO START OF WORK. IN THE EVENT OF ANY DISCREPANCIES OR POTENTIAL CONFLICTS, NOTIFY THE ARCHITECT AND ENGINEER IN WRITING PRIOR TO START OF WORK.
- B. ALL PIPING LOCATIONS ARE DIAGRAMMATIC. CONTRACTOR SHALL COORDINATE WITH ALL TRADES AND OWNER'S REPRESENTATIVE AND VERIFY EXACT ROUTING PRIOR TO START OF WORK.
- C. VERIFY EXACT SIZE AND LOCATION OF ALL PLUMBING CONNECTIONS TO MECHANICAL EQUIPMENT PRIOR TO START OF WORK. IN NO CASE SHALL THE CONNECTION SIZE BE LARGER THAN THE BRANCH PIPING SIZE.

KEY NOTES

- 1 SEE SHEET P1.1 FOR CONTINUATION.

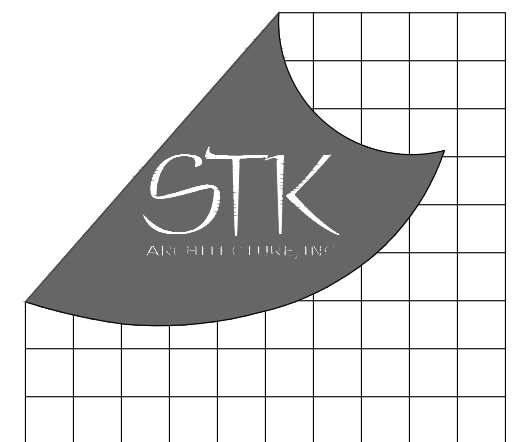

4205 ZEVOS DR. TEMECULA, CALIFORNIA 92590-3760
Phone: 951.296.8110 Fax: 951.296.6079 Email: stk@stkinc.com

CONSULTANT:



www.salasobrien.com
E-Mail: admin@stgeng.com

PROJECT ADMINISTERED BY:
SAN BERNARDINO COUNTY
PROJECT & FACILITIES
MANAGEMENT DEPARTMENT

385 N. ARROWHEAD AVE.
SAN BERNARDINO, CA 92415

PROJECT NAME:
SAN BERNARDINO
COUNTY FIRE
DEPARTMENT:
FIRE STATION 226

PROJECT # 10J0J032
CIP #21-037
CAFM # SAB98
APN # 0273-011-22

1920 DEL ROSA AVE N.
SAN BERNARDINO,
CA 92404

ISSUE INFORMATION:

DATE:	INFORMATION:
04-11-2022	20% CD SET
04-28-2022	50% CD SET
06-15-2022	95% CD SET
09-16-2022	95% CD- 3rd BAY
10-03-2022	PLAN CHECK

SHEET INFORMATION:

STK PROJECT NO.: 374-154-21
SCALE: AS NOTED
DATE: JANUARY 2021
PLOT DATE:
DRAWING NAME:

SEAL:






SHEET TITLE:

PLUMBING
RISER
DIAGRAM

SHEET NO.:

P4.2





PLUMBING RISER DIAGRAM - DOMESTIC WATER 1
NO SCALE

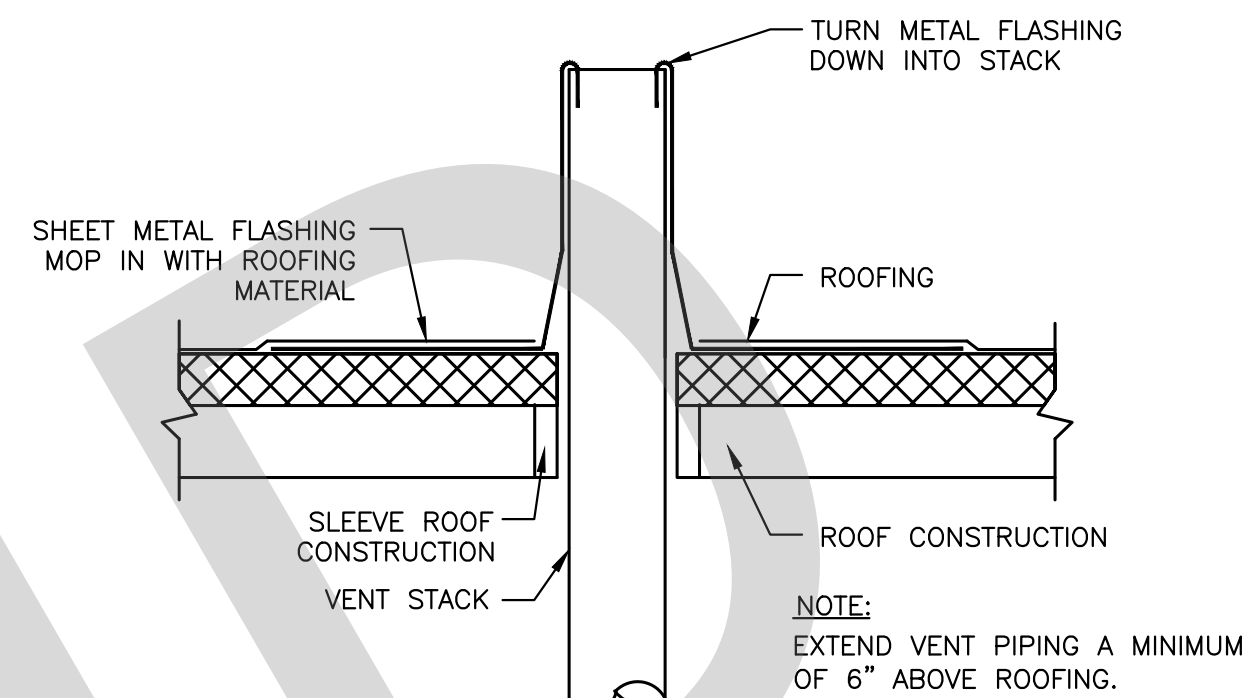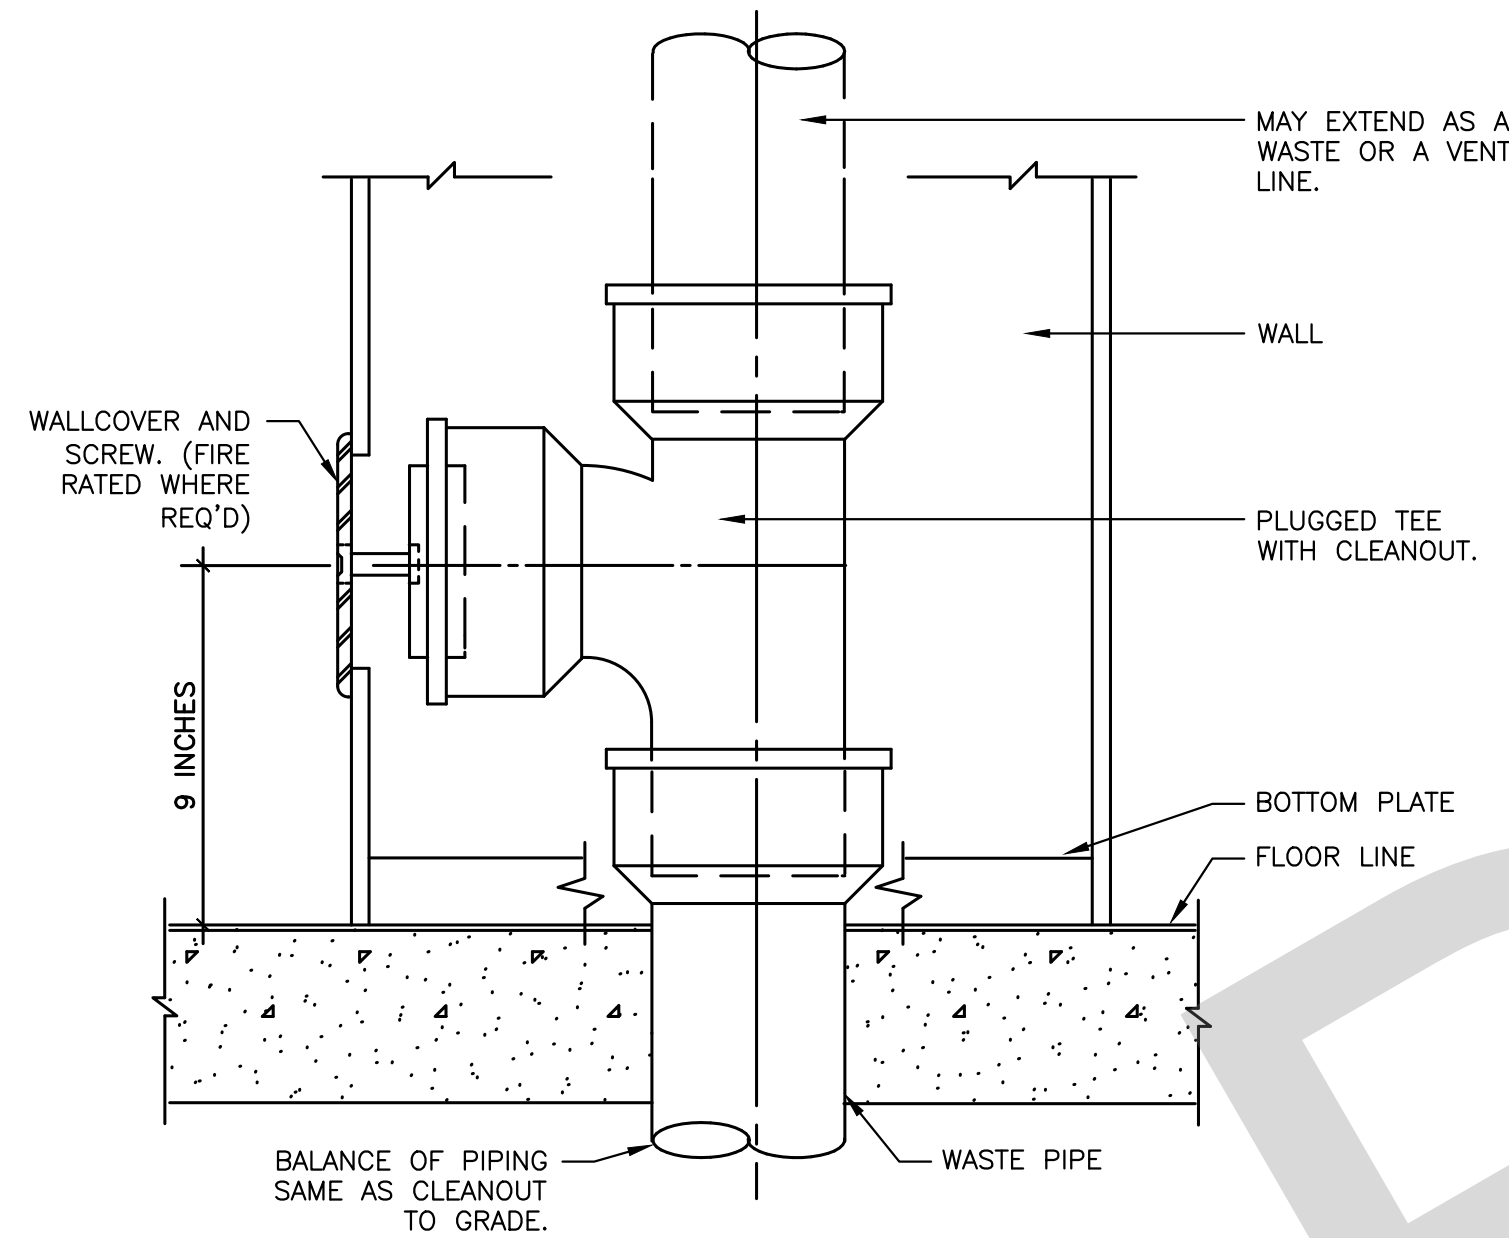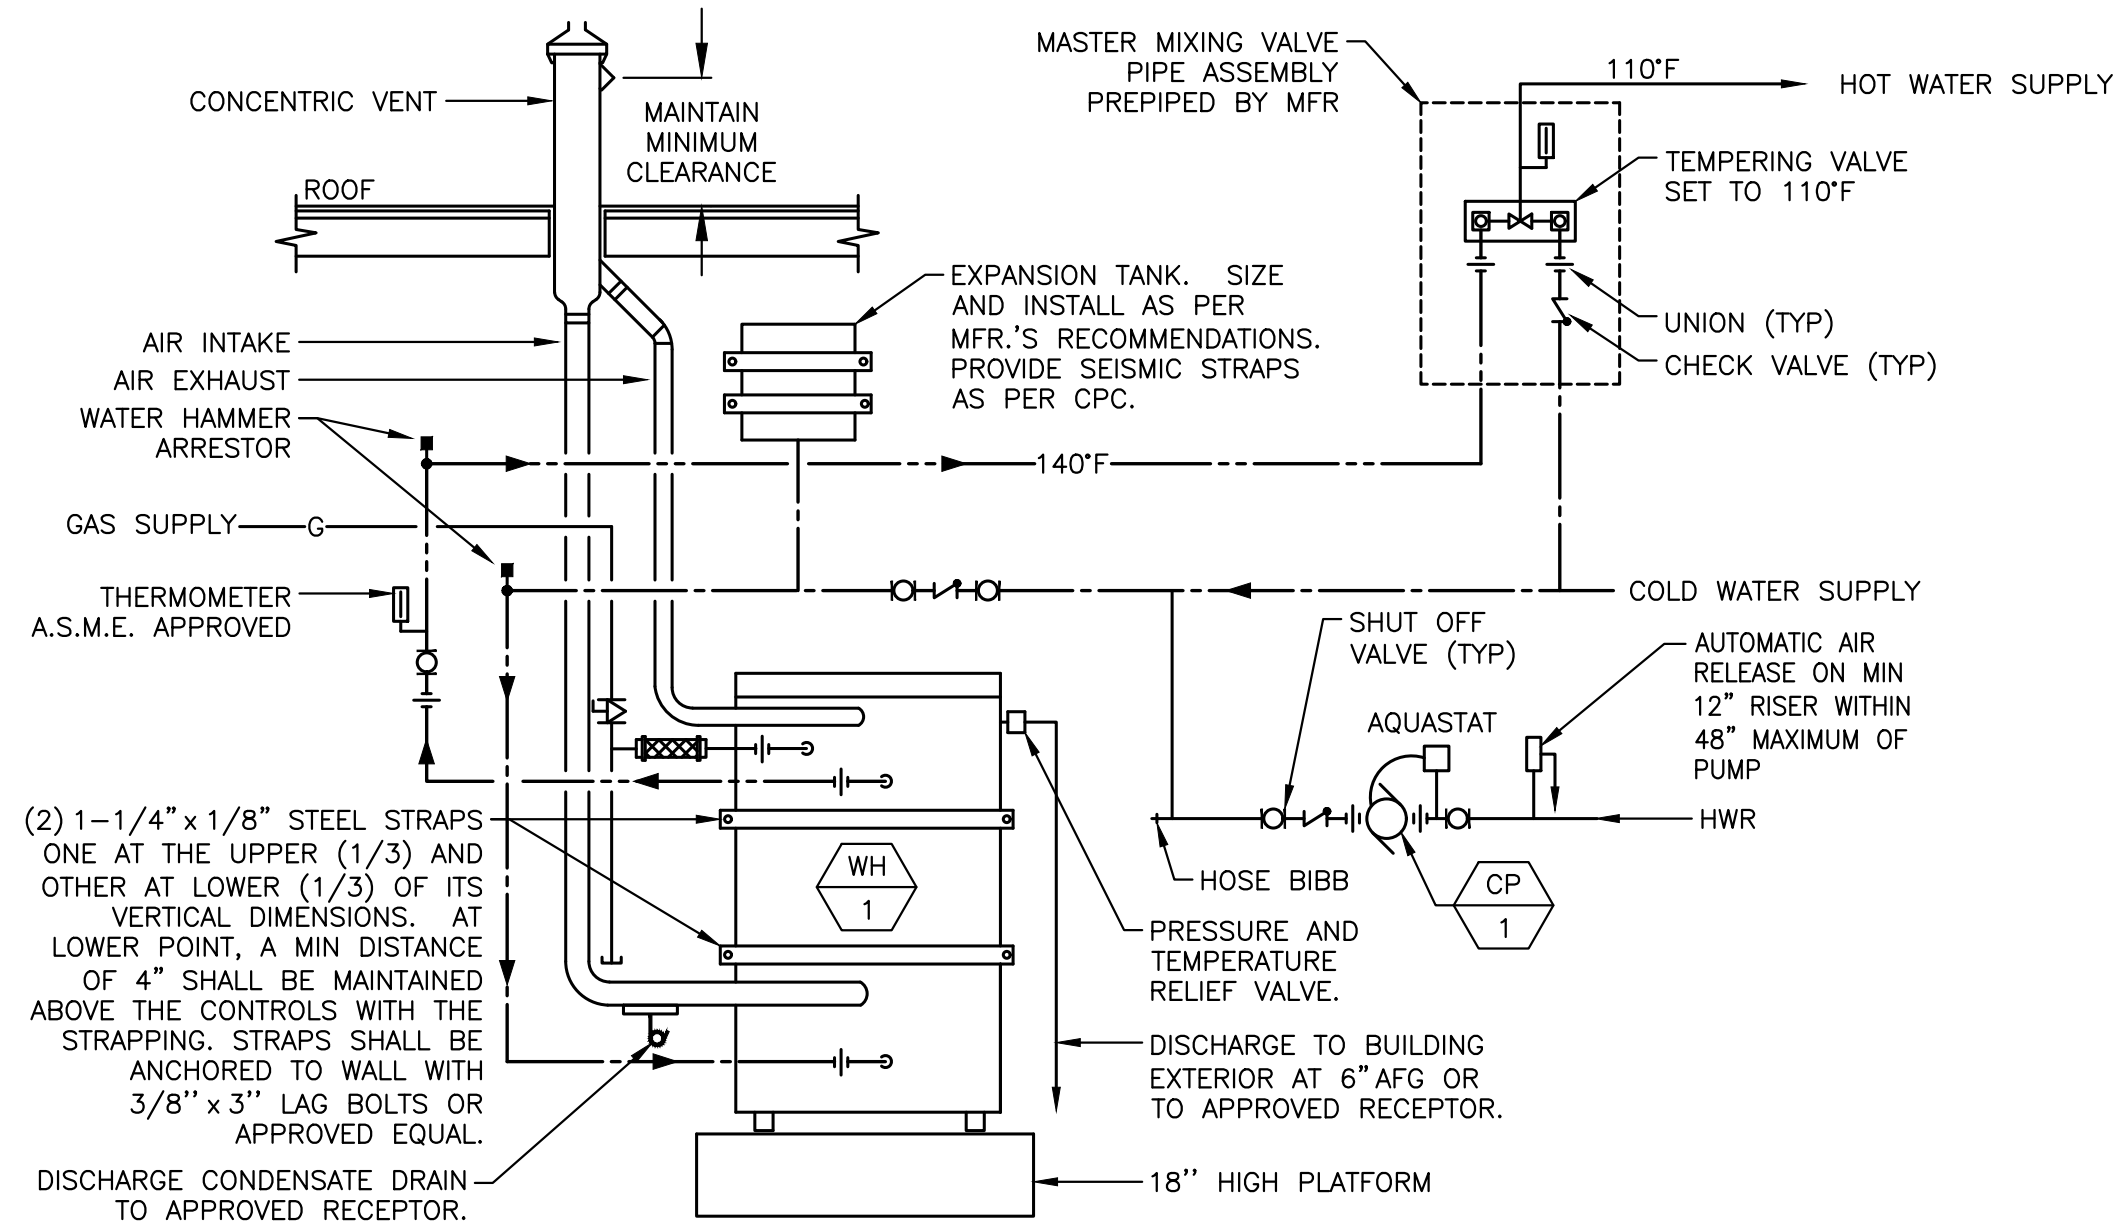

GAS FIRED, TANK TYPE WATER HEATER DETAIL

WALL CLEANOUT DETAIL

VENT THRU ROOF DETAIL

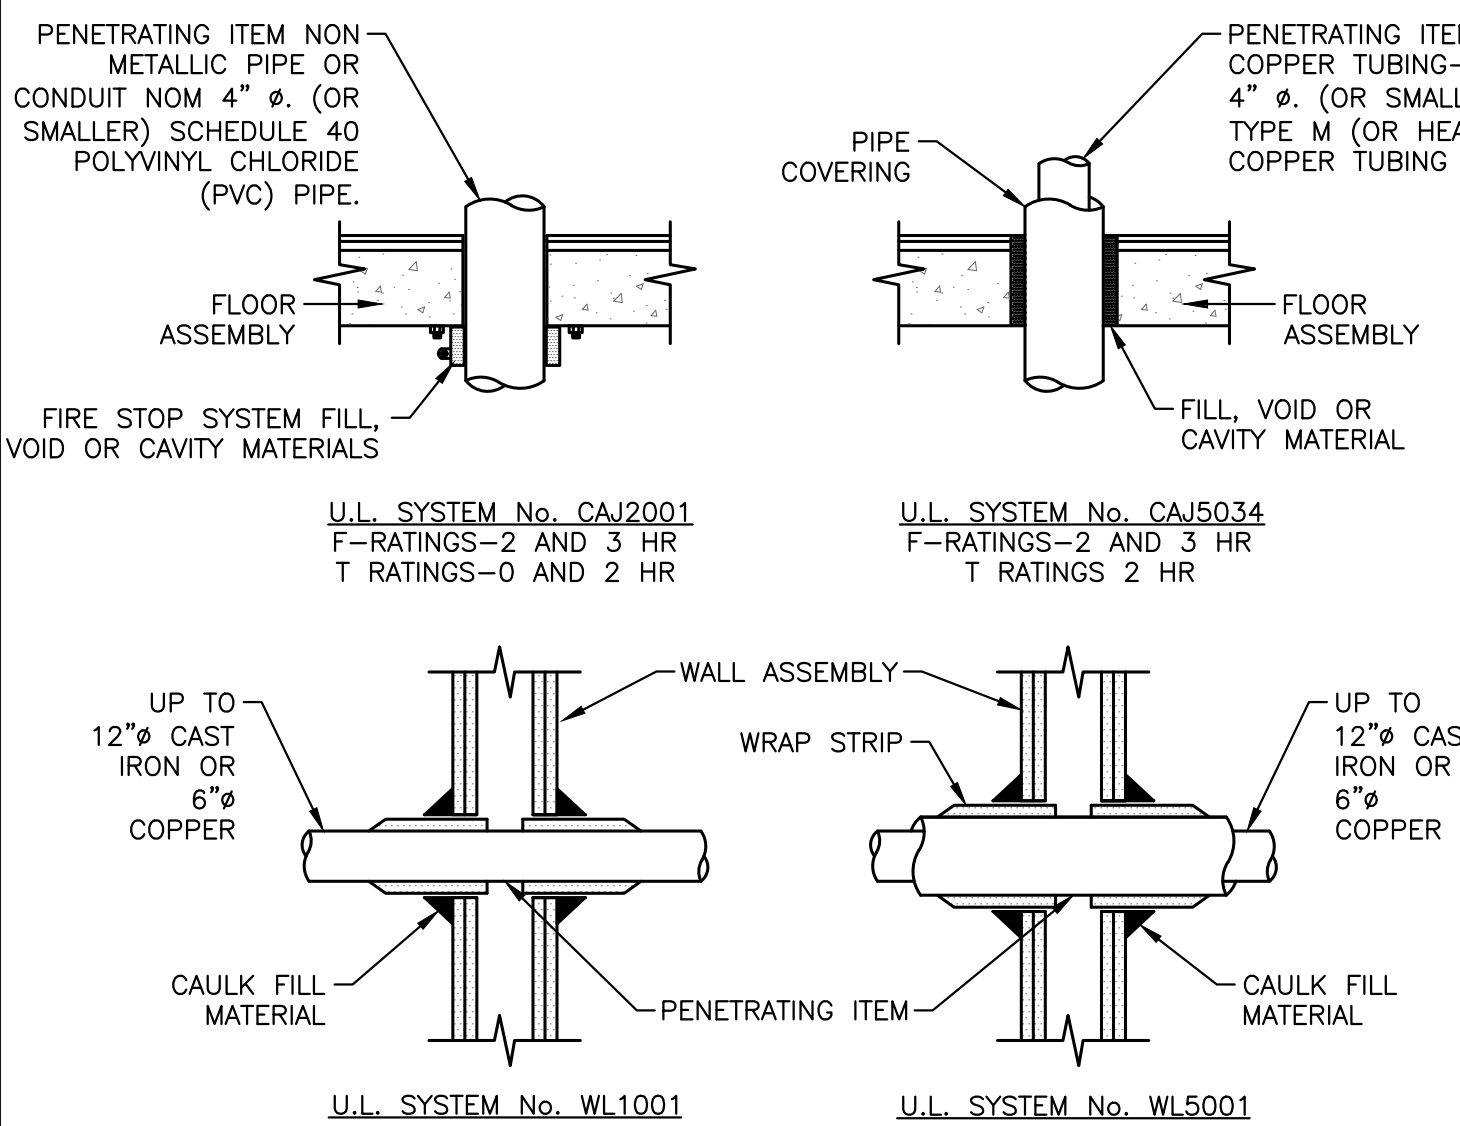
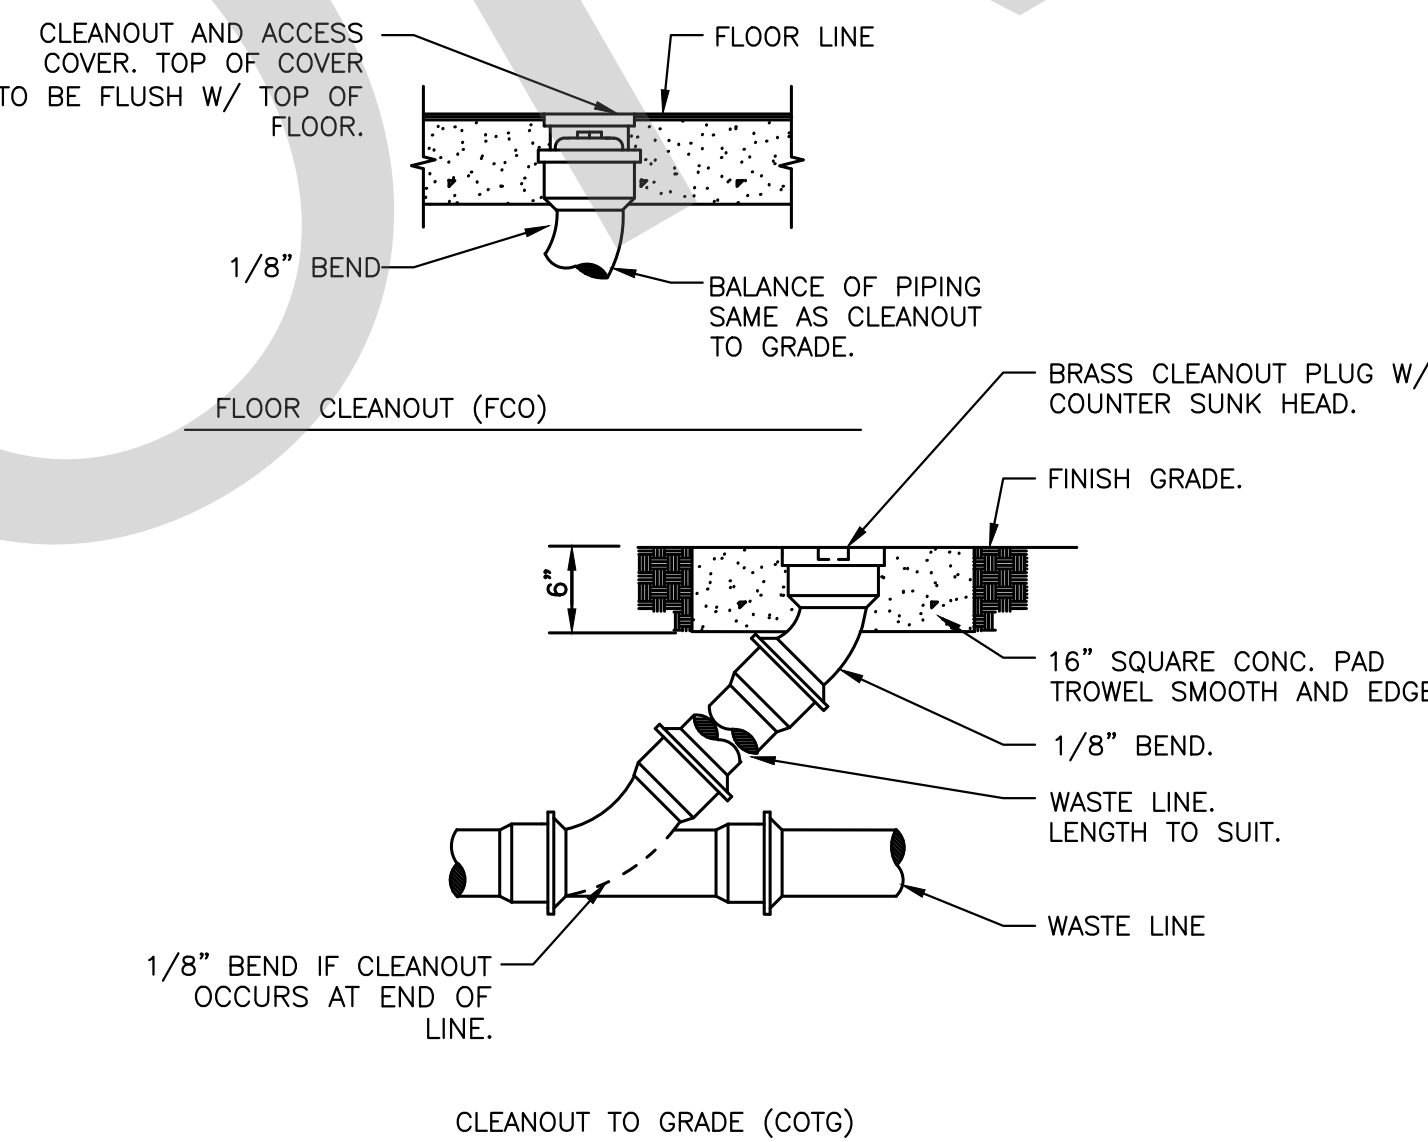
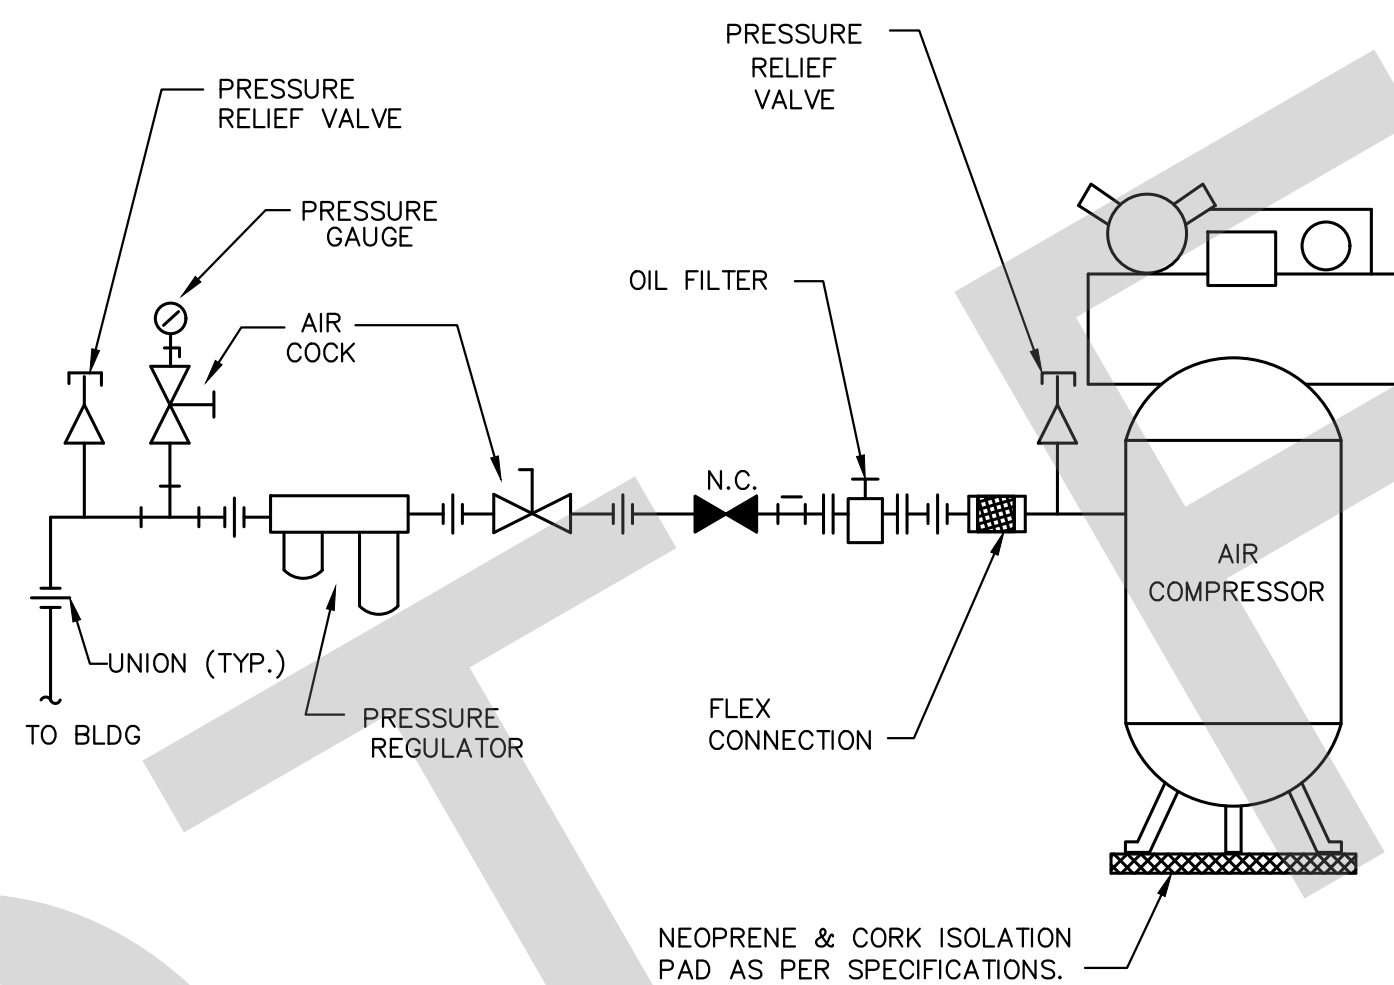
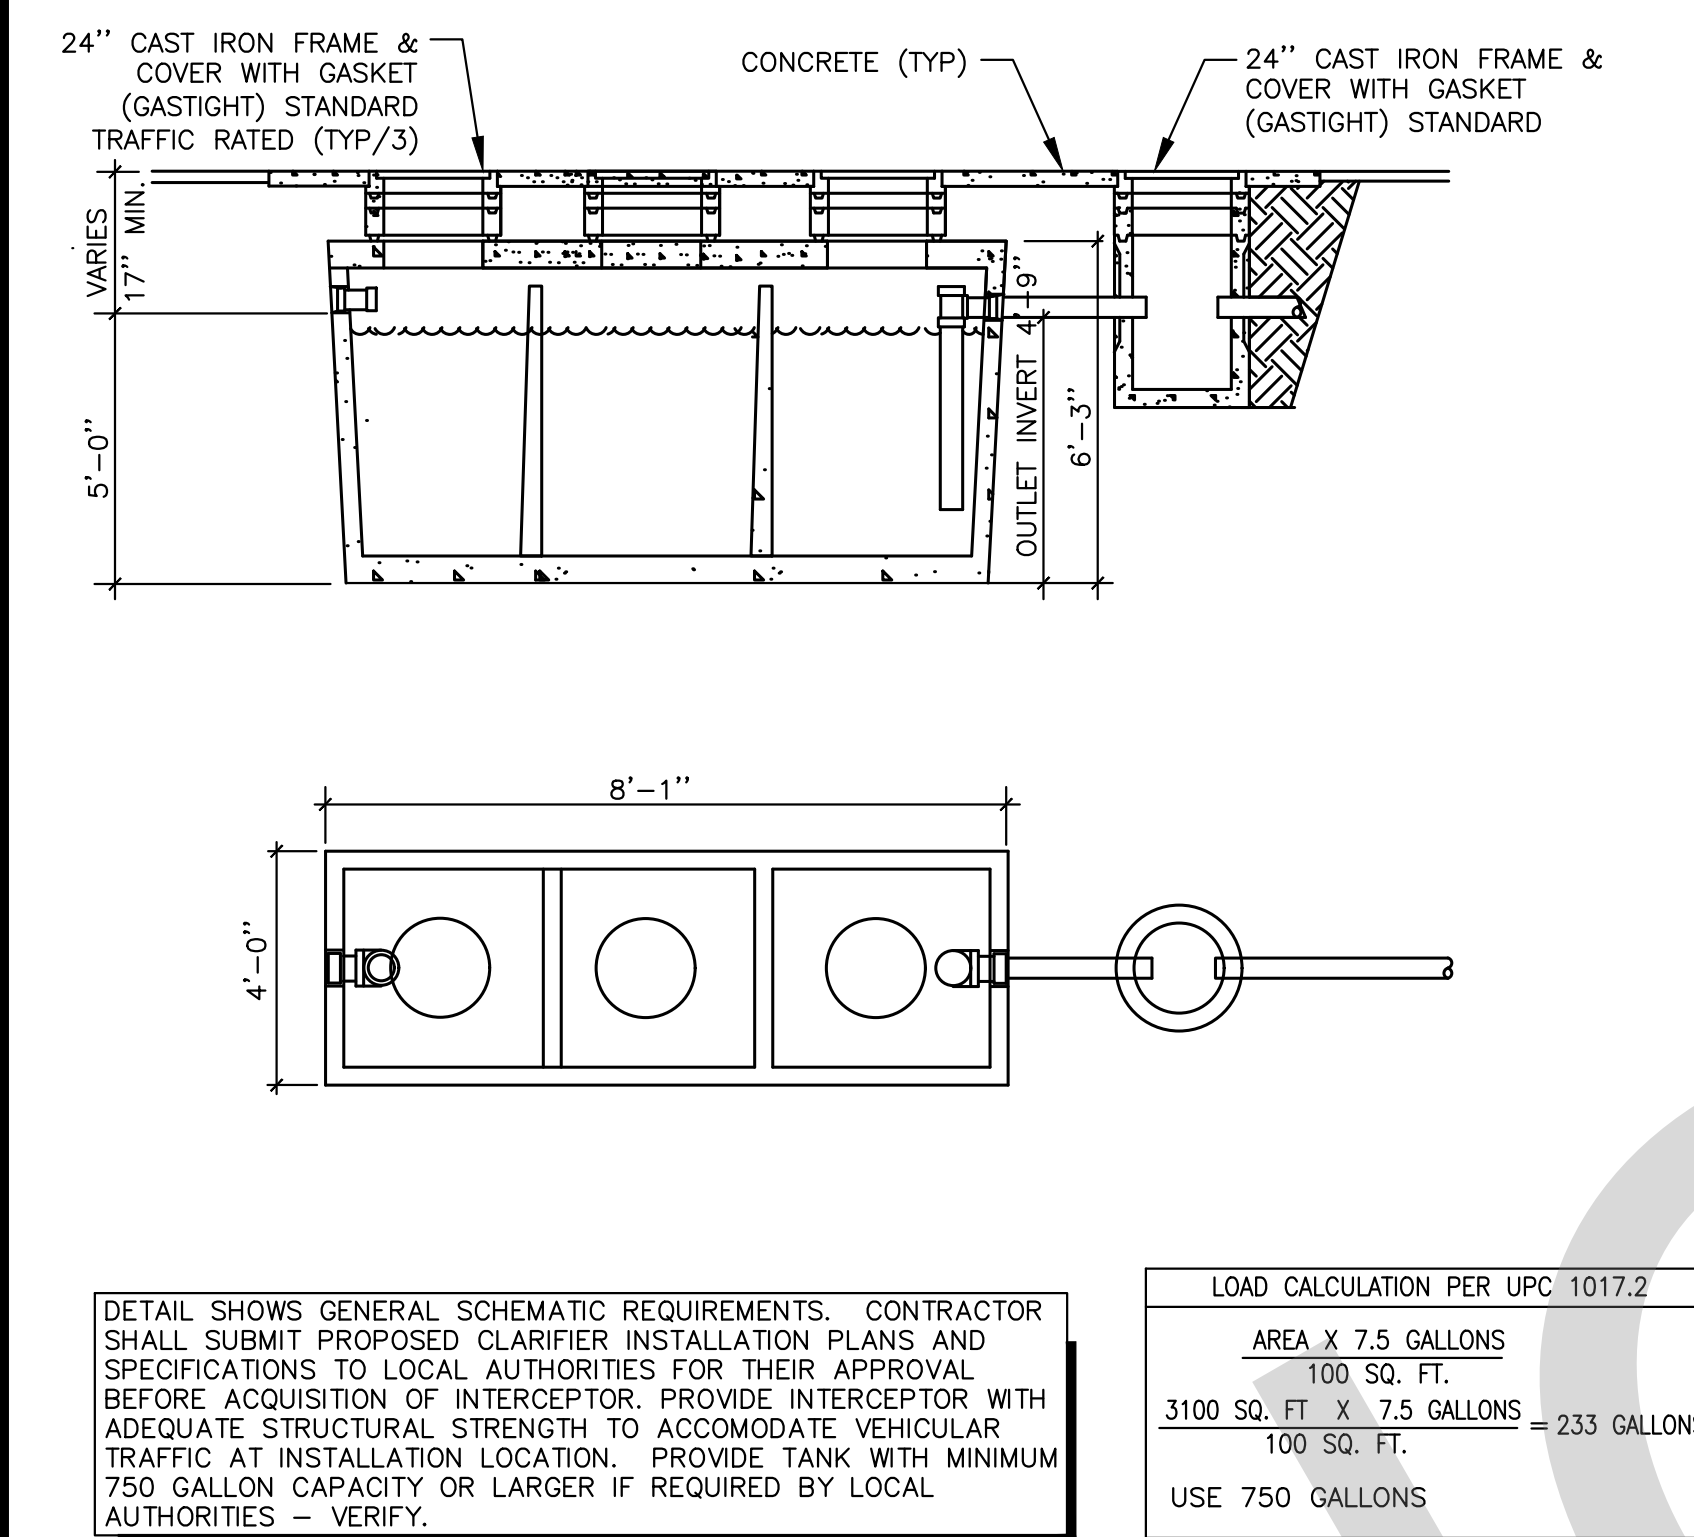


OIL INTERCEPTOR DETAIL

AIR COMPRESSOR PIPING DETAIL

FLOOR AND GRADE CLEANOUTS

PIPE PENETRATION DETAIL

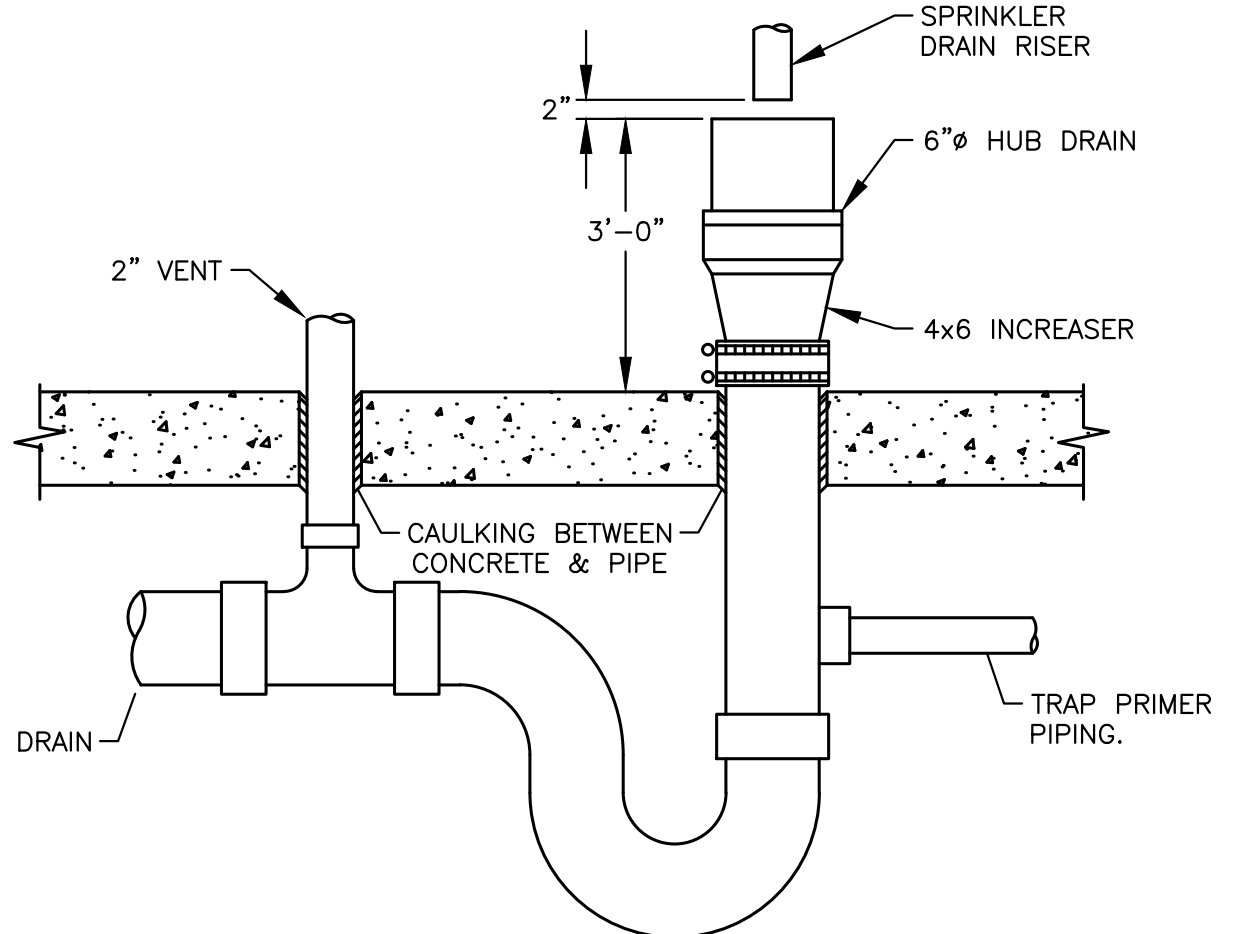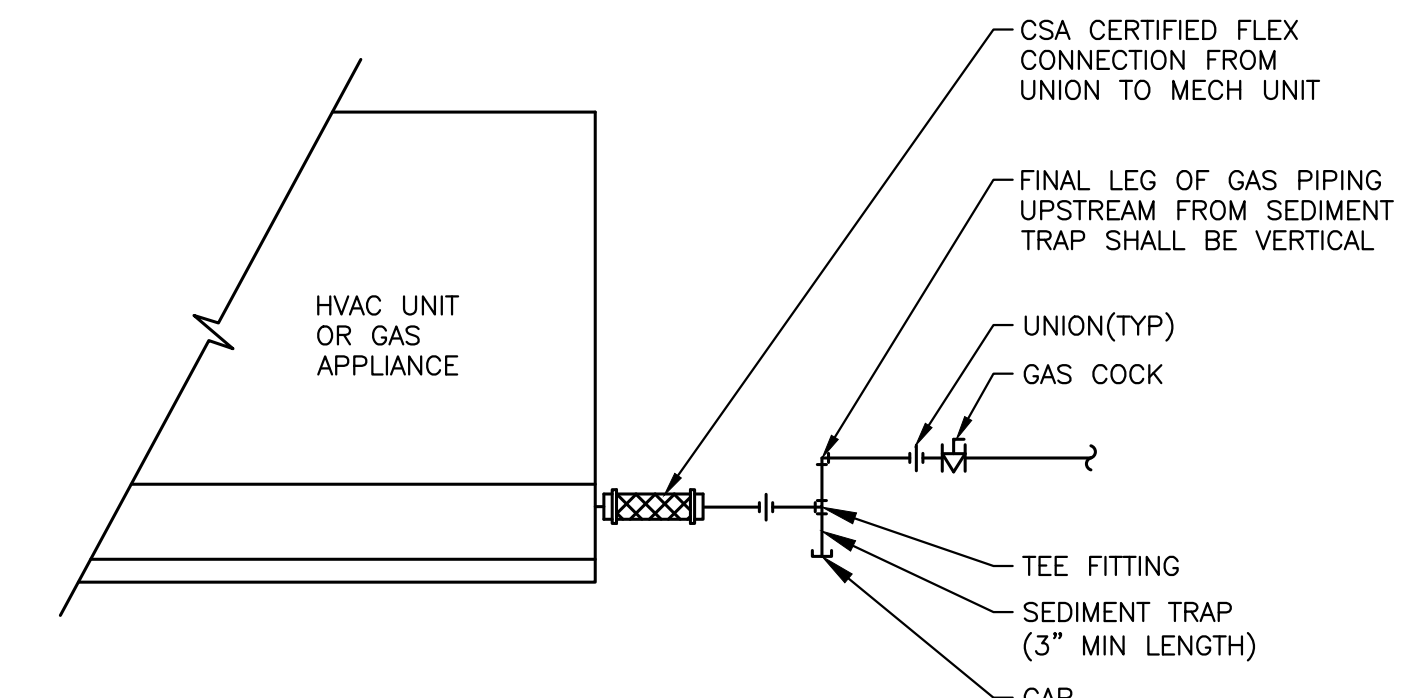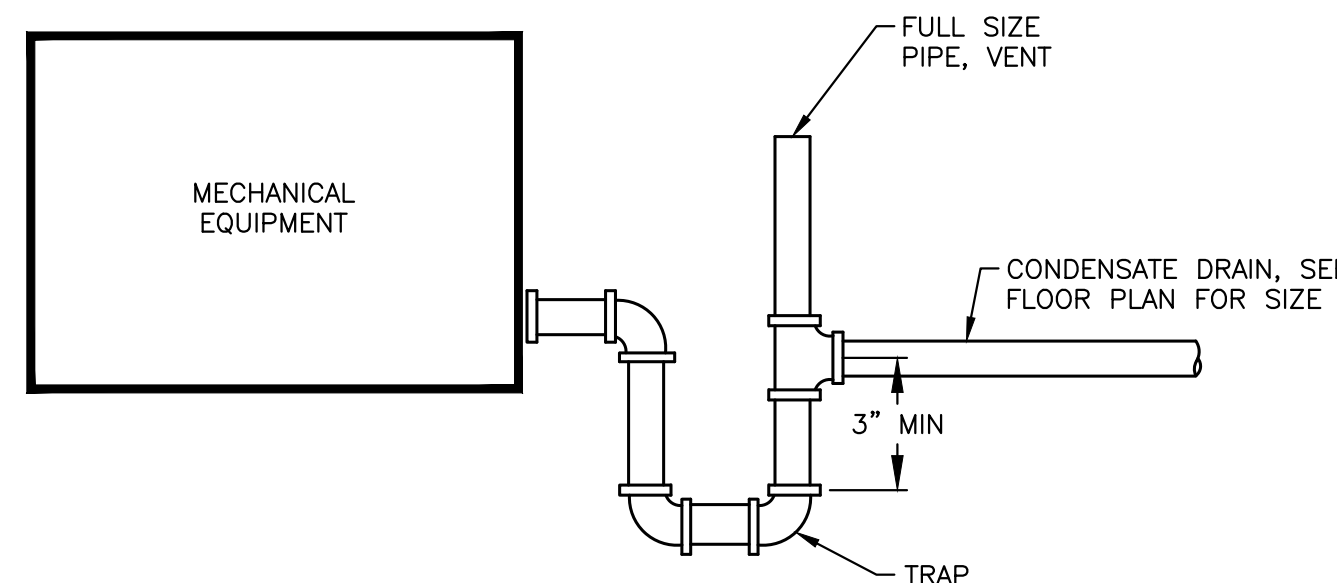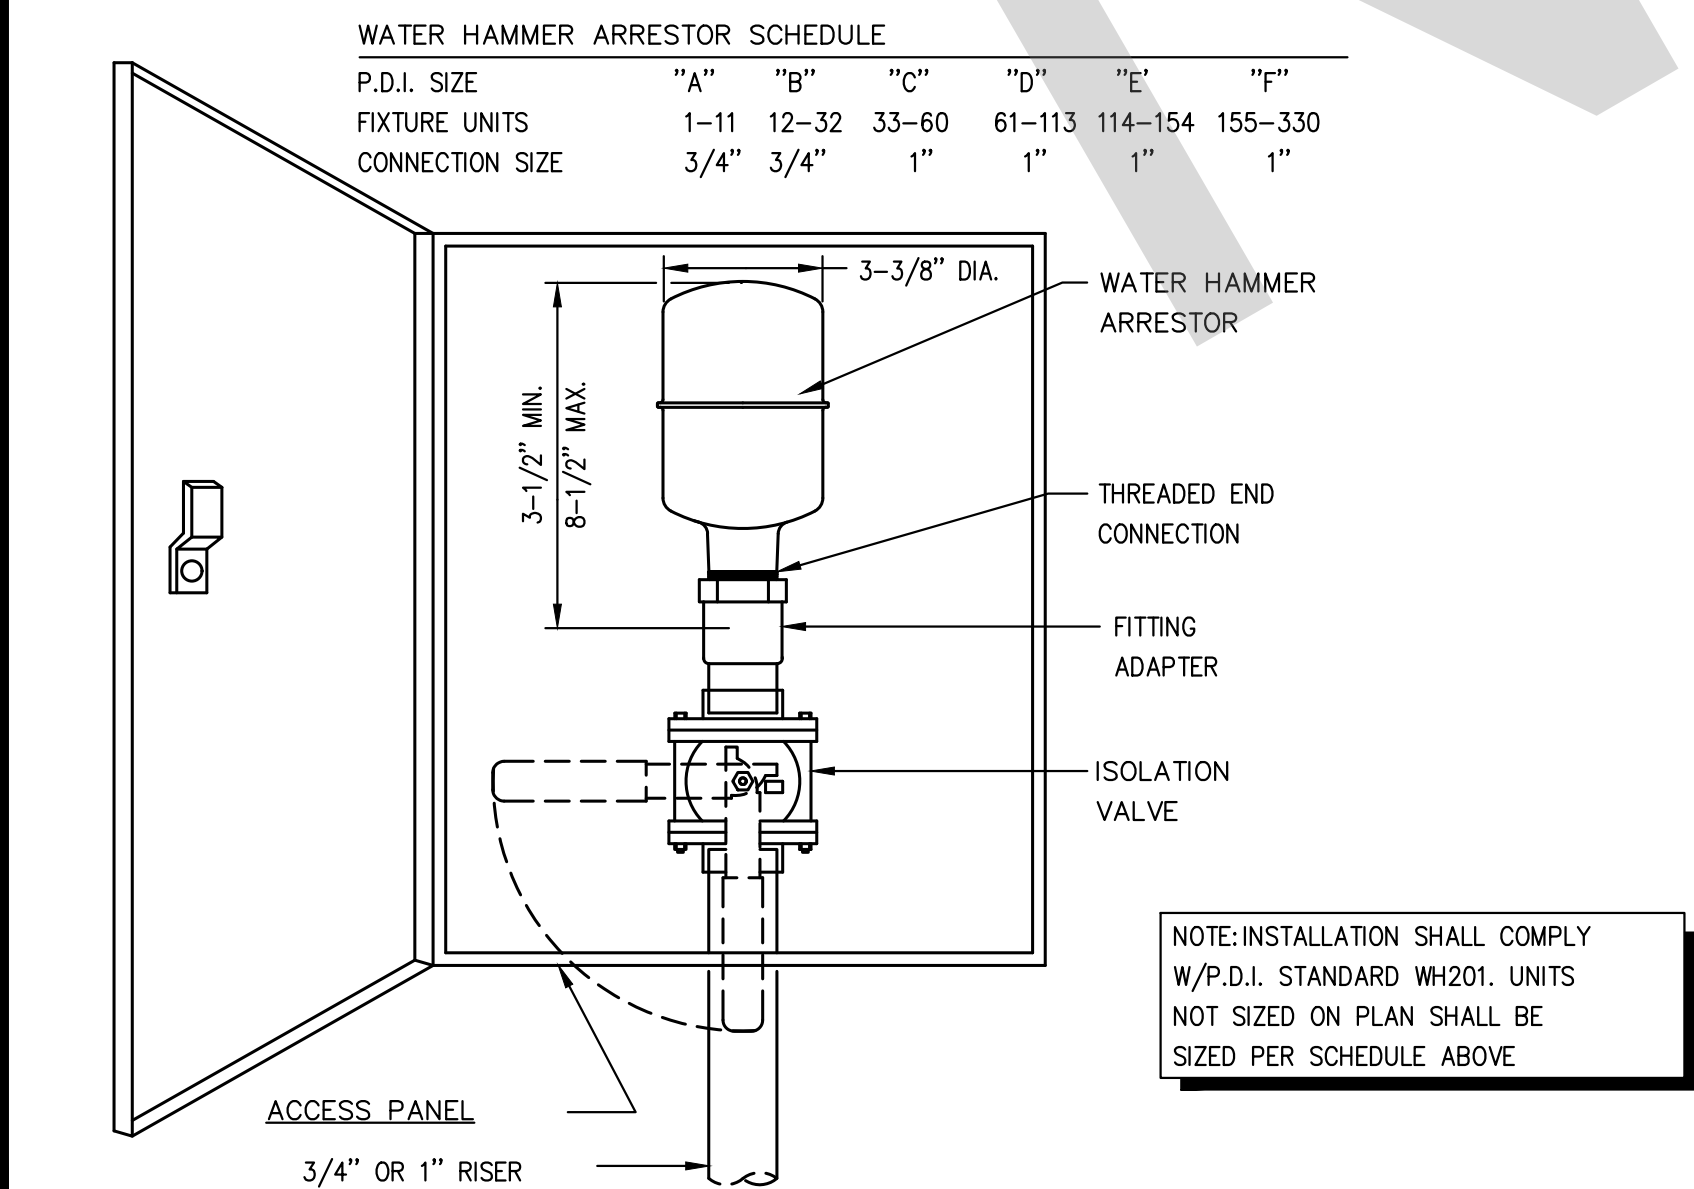

WATER HAMMER ARRESTOR DETAIL

CONDENSATE DRAIN TRAP DETAIL

GAS CONNECTION DETAIL

FIRE SPRINKLER RISER DRAIN DETAIL



PROJECT ADMINISTERED BY:
SAN BERNARDINO COUNTY
PROJECT & FACILITIES
MANAGEMENT DEPARTMENT

385 N. ARROWHEAD AVE.
SAN BERNARDINO, CA 92415


PROJECT NAME:
**SAN BERNARDINO
COUNTY FIRE
DEPARTMENT:
FIRE STATION 226**

PROJECT # 10.10.032
CIP # 2H-037
ACFM # SAB98
APN # 0273-Oil-22

1920 DEL ROSA AVE N.
SAN BERNARDINO,
CA 92404





ISSUE INFORMATION:	
DATE:	INFORMATION:
04-11-2022	20% CD SET
04-28-2022	50% CD SET
06-15-2022	95% CD SET
09-16-2022	95% CD- 3rd BAY
10-03-2022	PLAN CHECK


SHEET INFORMATION:
STK PROJECT NO.: 374-154-21
SCALE: AS NOTED
DATE: JANUARY 2021
PLOT DATE: -
DRAWING NAME:

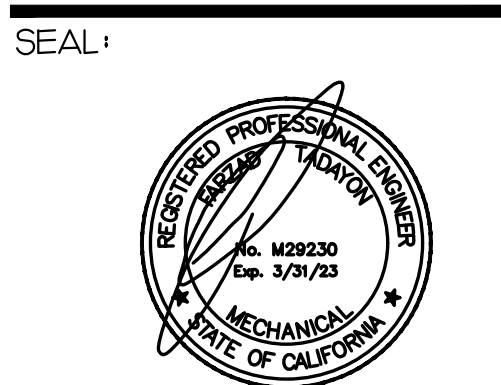

SHEET TITLE:
**PLUMBING
DETAILS**


SHEET NO.:
P5.1

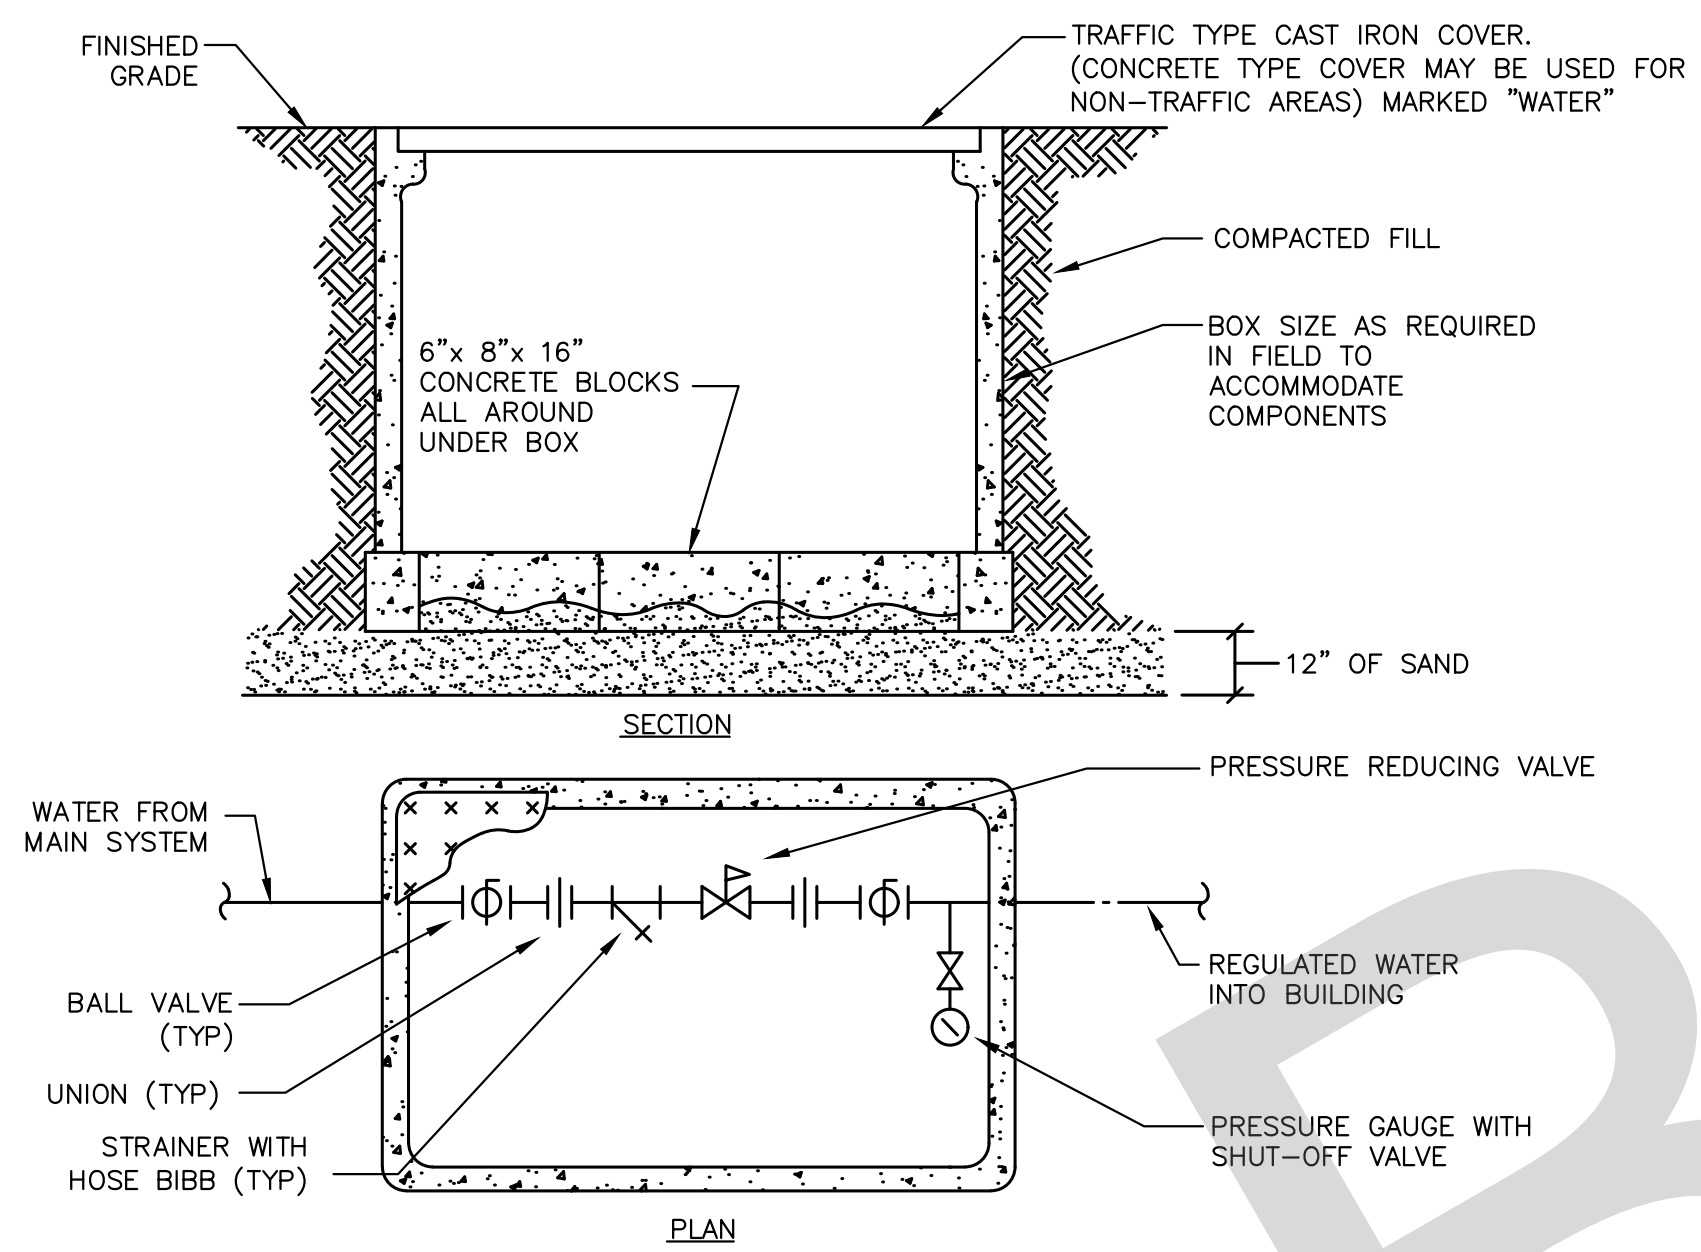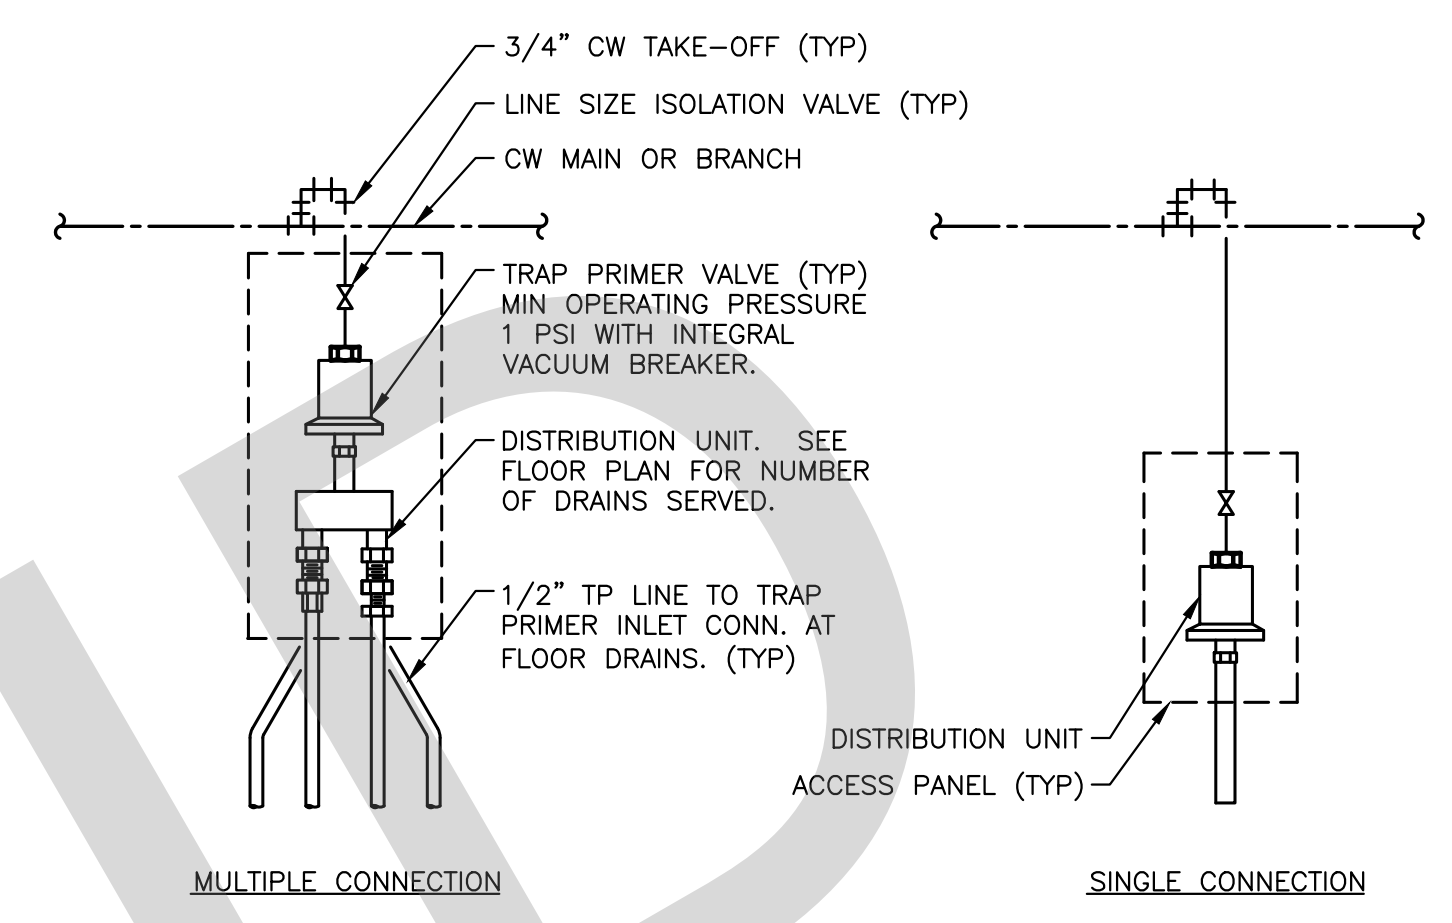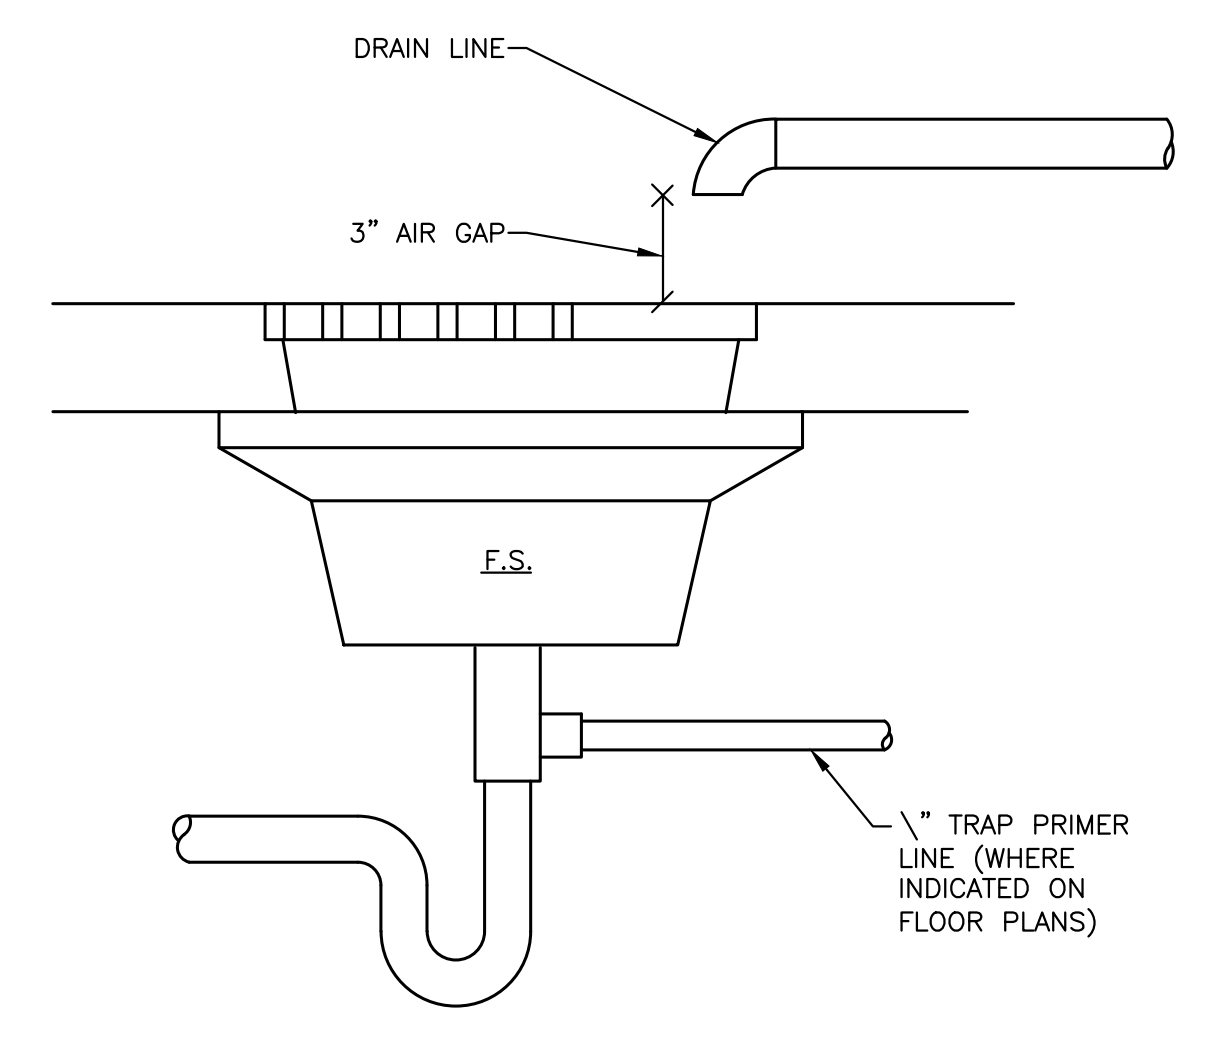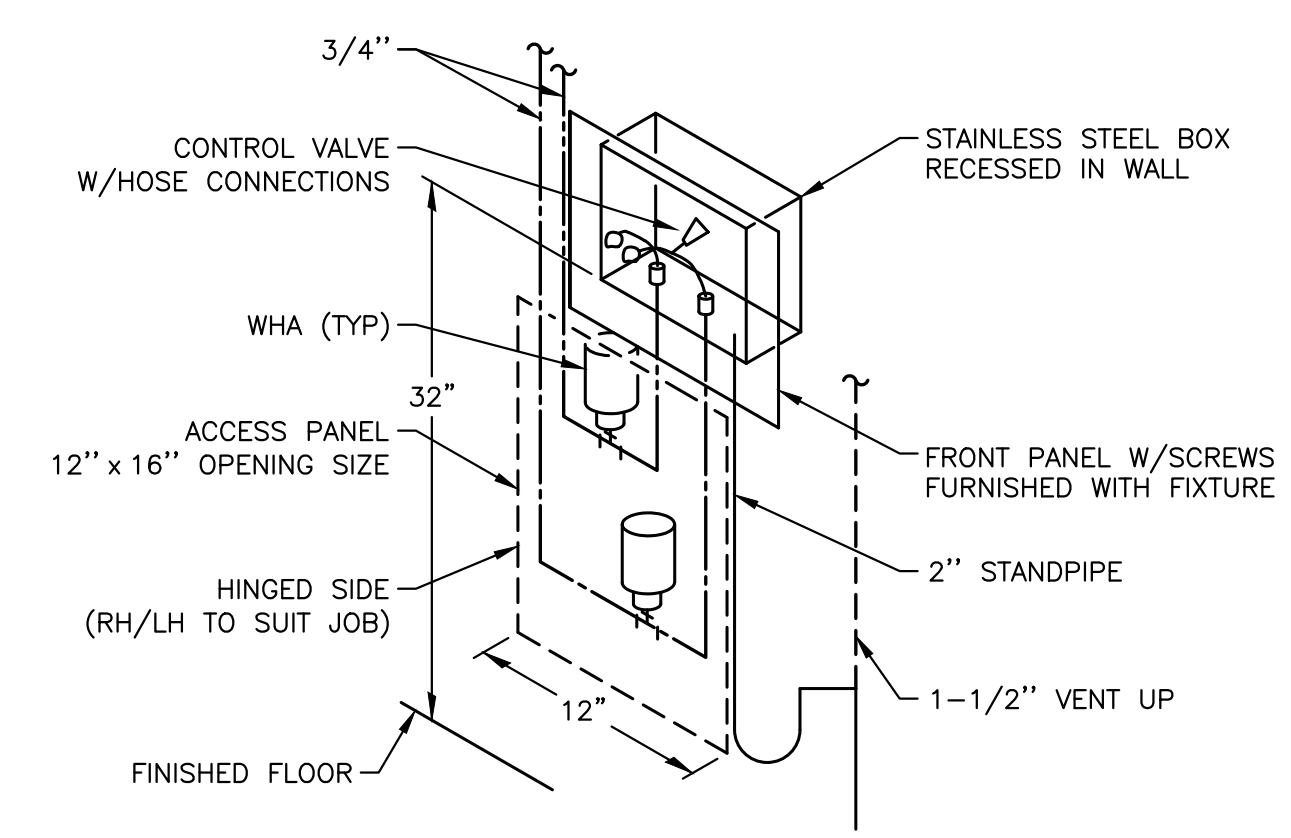											
NOT USED	SCALE NONE	10	NOT USED	SCALE NONE	7	WATER PRV YARDBOX DETAIL	SCALE NONE	4	TRAP PRIMER DETAIL	SCALE NONE	1
											
NOT USED	SCALE NONE	11	NOT USED	SCALE NONE	8	NOT USED	SCALE NONE	5	AIR GAP FITTING DETAIL	SCALE NONE	2
											
NOT USED	SCALE NONE	12	NOT USED	SCALE NONE	9	NOT USED	SCALE NONE	6	WASHING MACHINE CONNECTION DETAIL	SCALE NONE	3

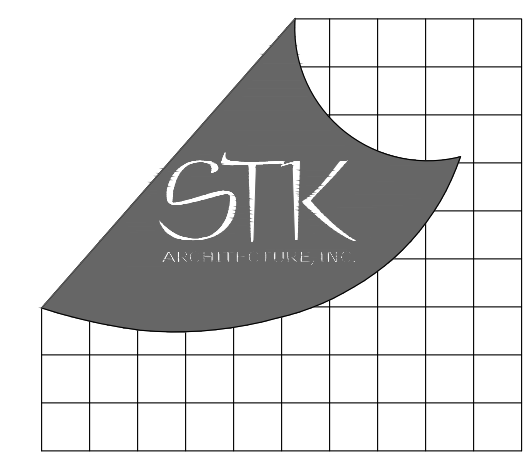

4095 ZEVU DR. TEMECULA, CALIFORNIA 92590-3760
Phone: 951.266.8110 Fax: 951.266.6079 Email: sk@stkc.com

CONSULTANT:



SALASOBRIEN
[expect a difference]
3220 EXECUTIVE RIDGE
SUITE 210
VISTA, CA 92081
TEL: (760) 560-0100
#21189
www.salasobrien.com
E-Mail: admin@stbcqng.com

PROJECT ADMINISTERED BY:
SAN BERNARDINO COUNTY
PROJECT & FACILITIES
MANAGEMENT DEPARTMENT

385 N. ARROWHEAD AVE.
SAN BERNARDINO, CA 92415

PROJECT NAME:
SAN BERNARDINO
COUNTY FIRE
DEPARTMENT:
FIRE STATION 226

PROJECT # 10J0J032
CIP #21-037
CAFM # SAB198
APN # 0273-011-22


1920 DEL ROSA AVE N.
SAN BERNARDINO,
CA 92404

ISSUE INFORMATION:	
DATE:	INFORMATION:
04-11-2022	20% CD SET
04-28-2022	50% CD SET
06-15-2022	95% CD SET
09-16-2022	95% CD- 3rd BAY
10-03-2022	PLAN CHECK

SHEET INFORMATION:

STK PROJECT NO.: 374-154-21
SCALE: AS NOTED
DATE: JANUARY 2021
PLOT DATE: -
DRAWING NAME: -


SEAL:

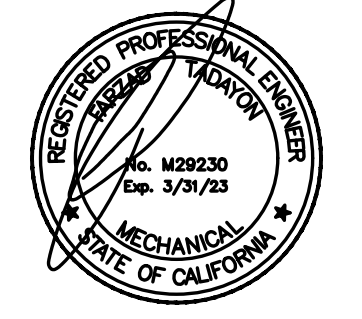


SHEET TITLE:

PLUMBING
DETAILS

SHEET NO.:
P5.2

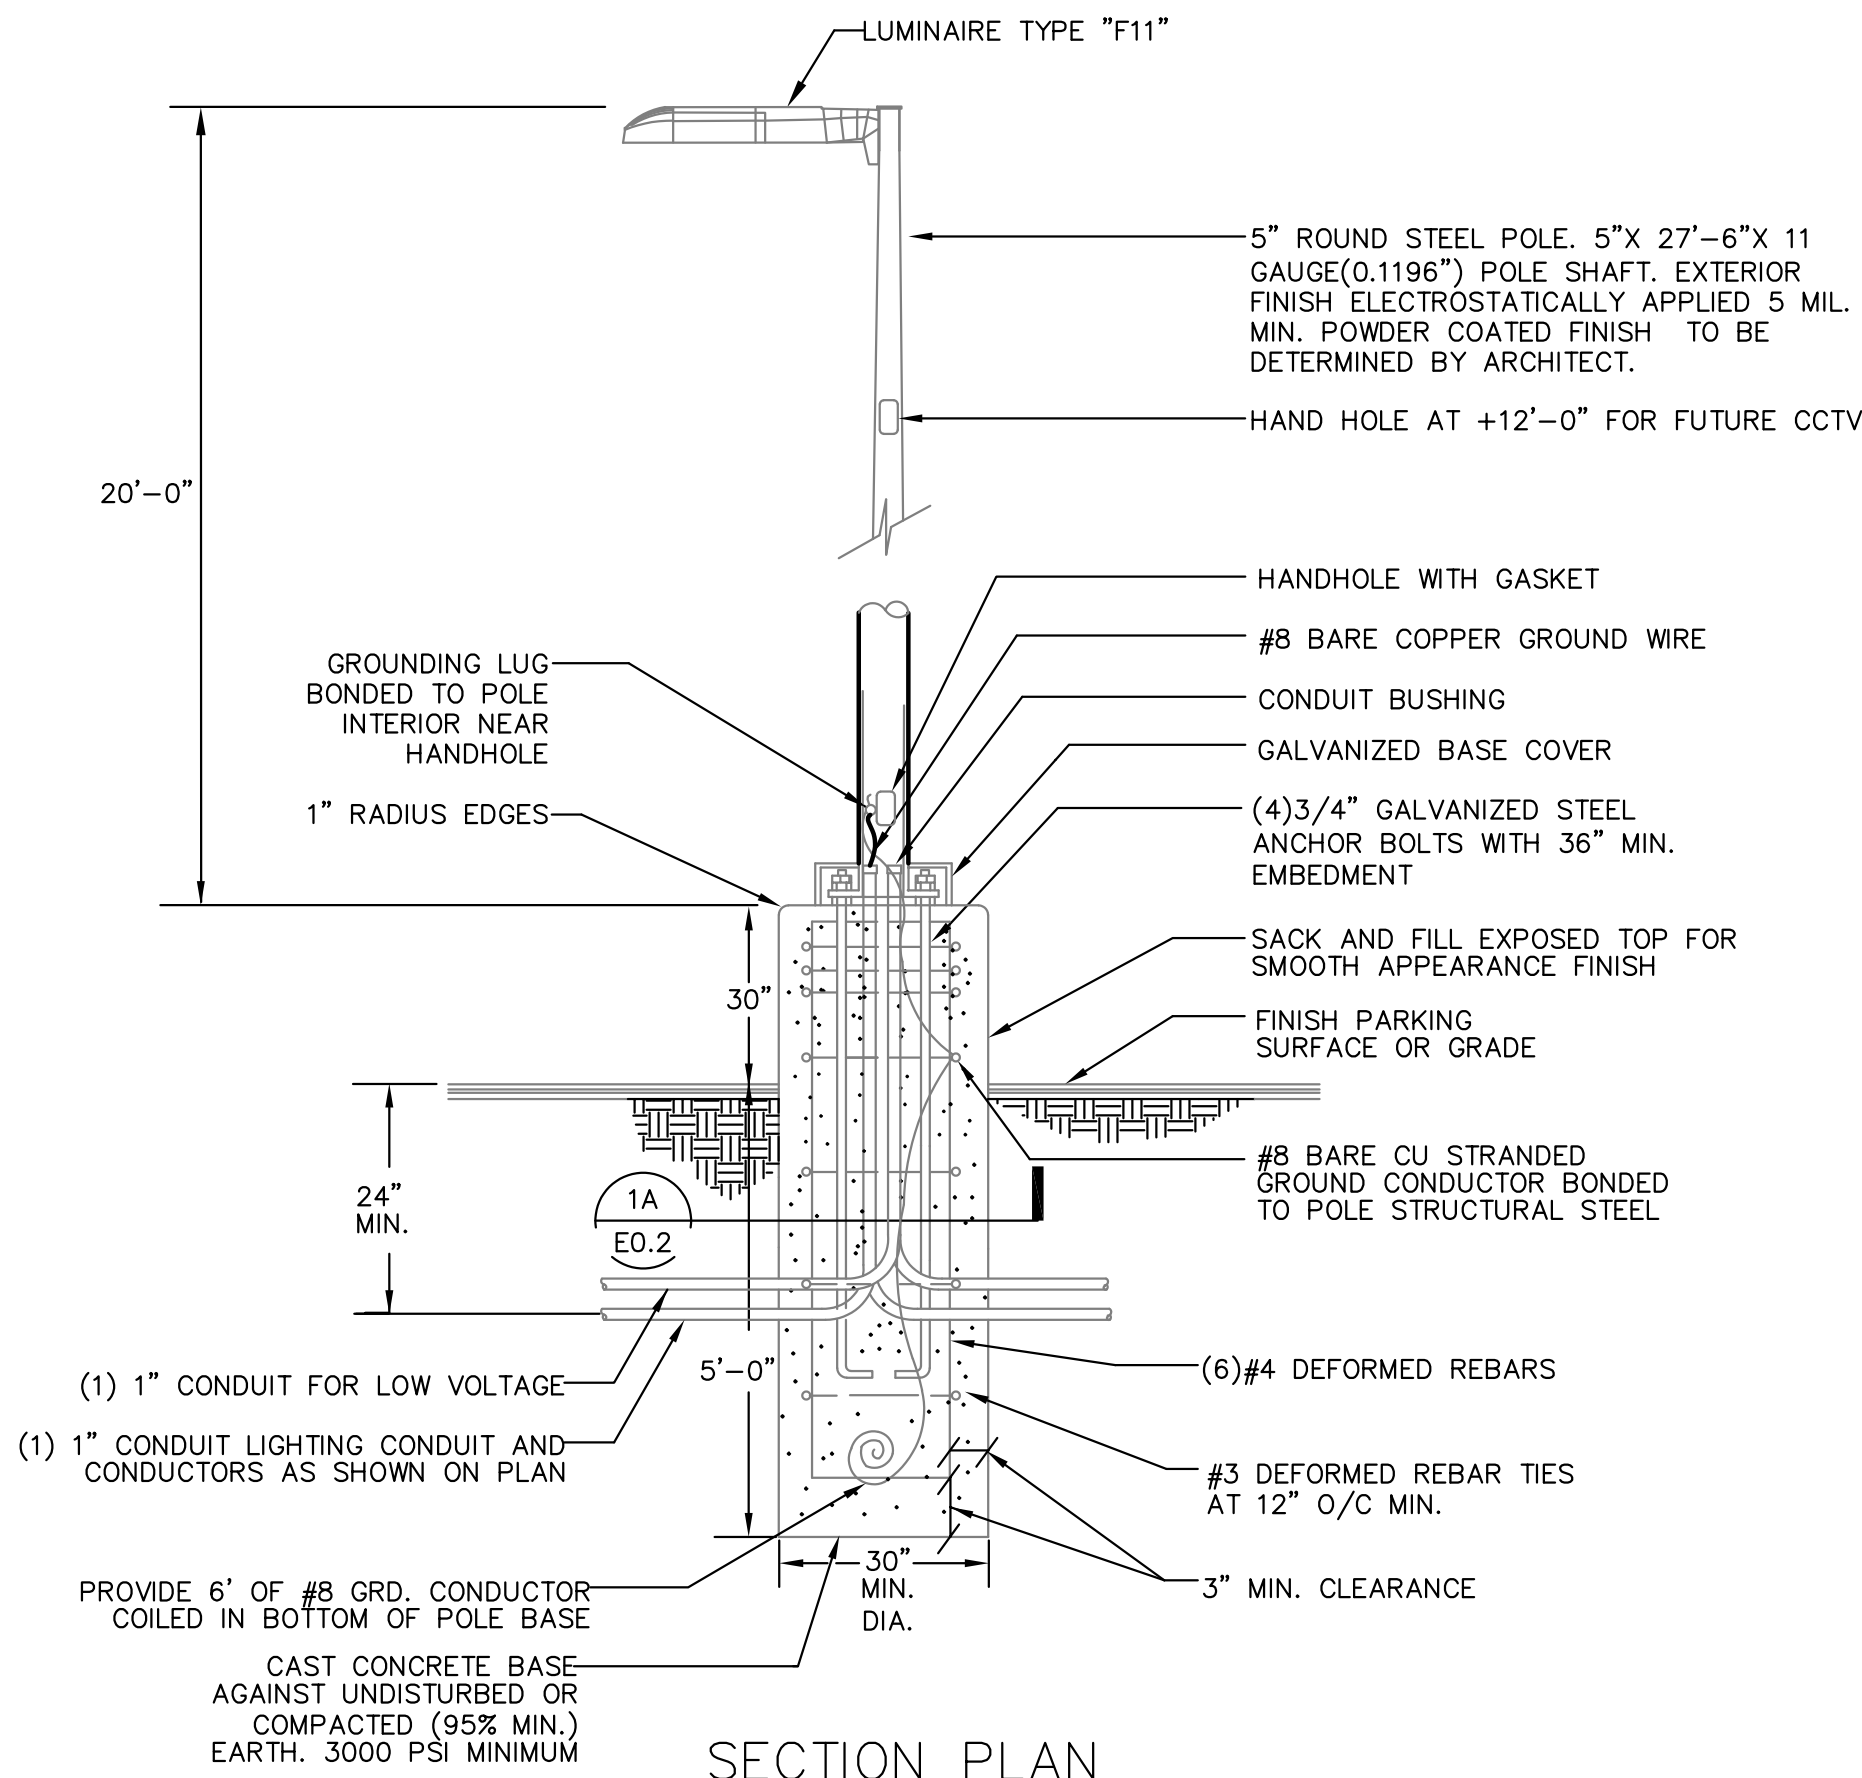

SECTION PLAN

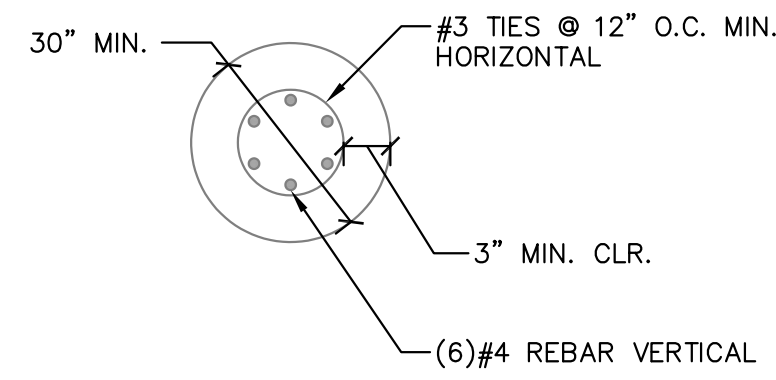


BASE PLAN

FOOTING BASE PLAN 1A

NOTE: POLE BASE DIMENSIONS AND ANCHORING HARDWARE SHALL BE APPROVED BY THE STRUCTURAL ENGINEER OF RECORD PRIOR TO INSTALLATION.

SCALE: NONE

FIXTURE TYPE "S1" DETAIL 1

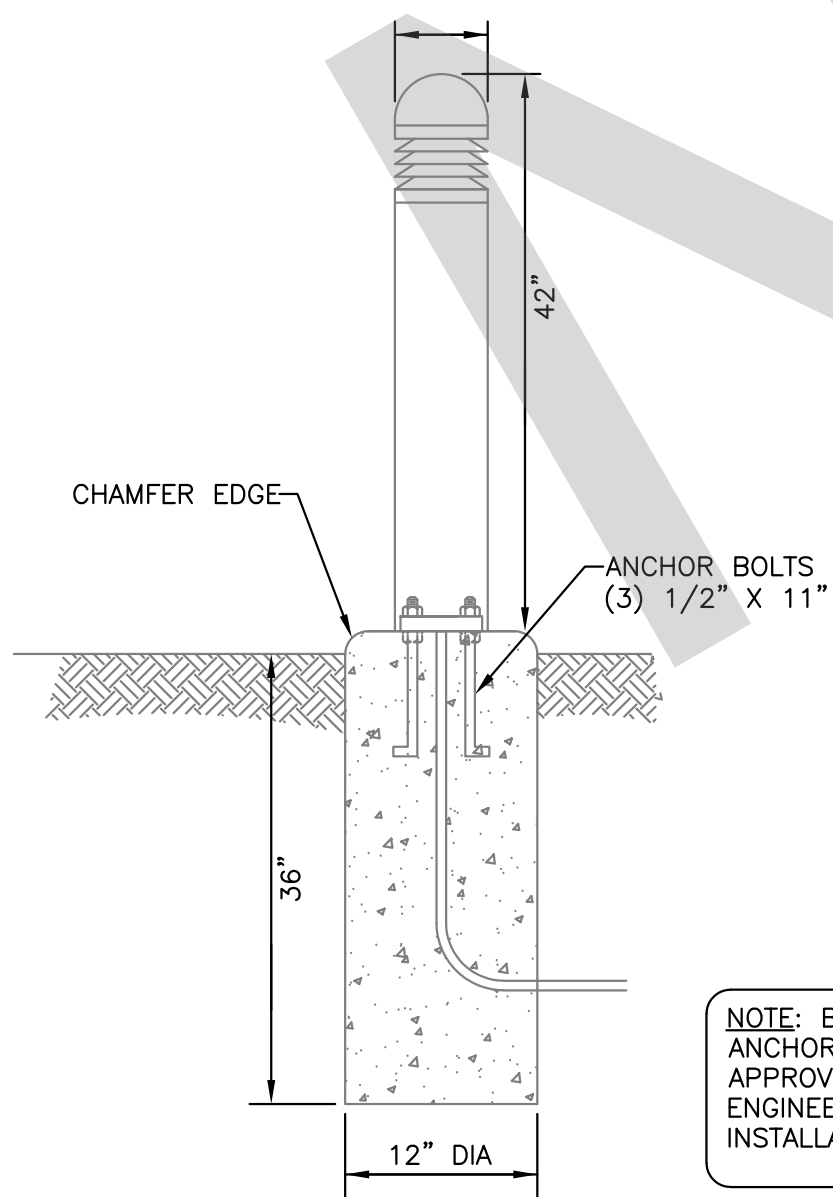

NOTE: BASE DIMENSIONS AND ANCHORING HARDWARE SHALL BE APPROVED BY THE STRUCTURAL ENGINEER OF RECORD PRIOR TO INSTALLATION.


SCALE: NONE

FIXTURE TYPE "S2" DETAIL 2

LIGHTING CONTROL PANEL 'LCP'						
RELAY #	PANEL	CIR #	VOLTS	SERVICES	CONTROL	BLDG. SHUT-OFF CONTROL BY
1	B	1	208	POLE LIGHTING	PHOTOCELL "ON", TIMECLOCK "OFF"	NONE
2	B	3	208	—	—	—
3	B	5	120	MONUMENT SIGN	PHOTOCELL "ON", TIMECLOCK "OFF"	NONE
4	B	7	120	FLAGPOLE, BOLLARD LIGHTING	PHOTOCELL "ON", TIMECLOCK "OFF"	NONE
5	B	9b	120	ENTRY CANOPY LIGHTING	PHOTOCELL "ON", TIMECLOCK "OFF"	NONE
6	B	9y	120	REAR WALL SCONCE LIGHTING	PHOTOCELL "ON", TIMECLOCK "OFF"	NONE
7	—	—	—	SPARE	—	—
8	—	—	—	SPARE	—	—
NORMAL-EMERGENCY BARRIER						
9	B	1v	120	APP BAY FRONT EXTERIOR LIGHTING	PHOTOCELL "ON", TIMECLOCK "OFF"	NONE
10	B	1w	120	APP BAY REAR EXTERIOR LIGHTING	PHOTOCELL "ON", TIMECLOCK "OFF"	NONE
11	B	11y	120	SIDE EXIT DOOR LIGHT	PHOTOCELL "ON", TIMECLOCK "OFF"	NONE
12	—	—	—	SPARE	—	—

LIGHTING MATRIX CONTROL SYSTEM NOTES:

1. PROVIDE THE LIGHTING CONTROL SYSTEM WITH AN INTEGRAL ELECTRONIC SOLID-STATE, 365 DAY PROGRAMMABLE, MULTI-CHANNEL, TIME SWITCH WITH INTEGRAL BACKUP POWER (MINIMUM 90 MINUTES).
2. PROVIDE (1) PHOTOCELL ON ROOF FOR CONTROL OF SITE LIGHTING AND RED LIGHTS.

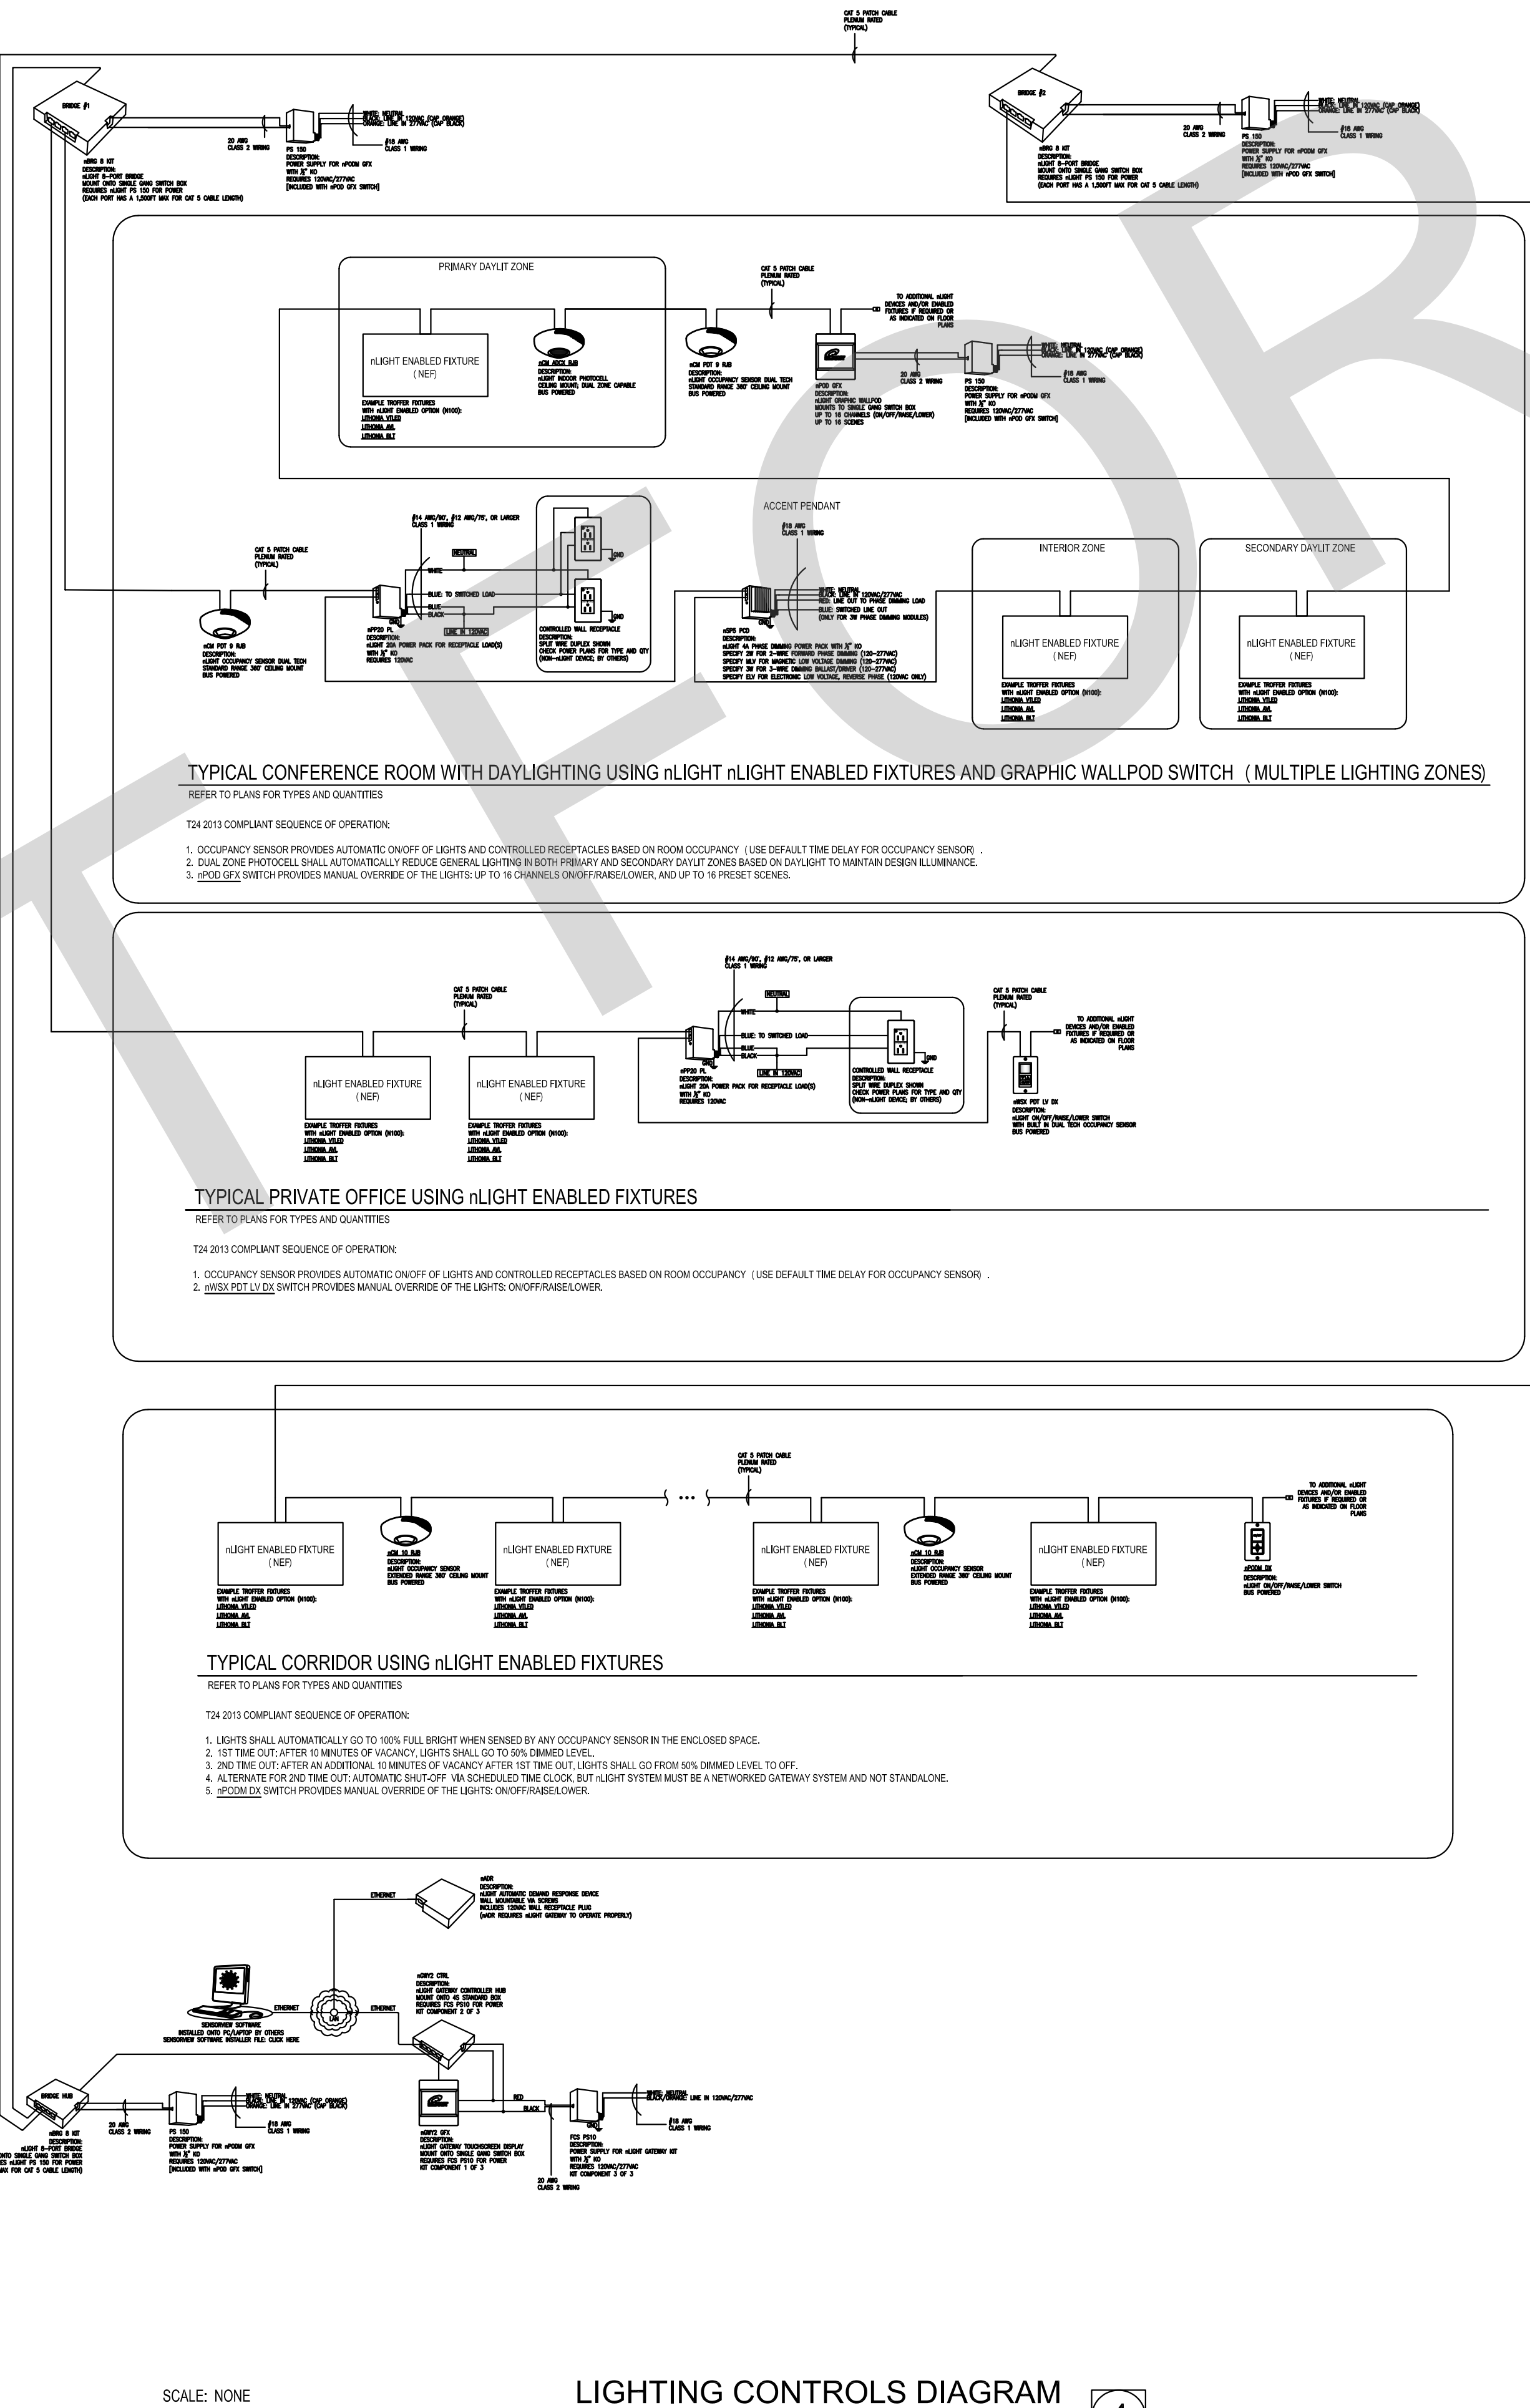


SCALE: NONE

LIGHTING CONTROLS DIAGRAM 4

LIGHTING FIXTURE SCHEDULE									
FIXT DES	SYMBOL	LAMP TYPE	FIXTURE MOUNTING	LAMP DESC	WATTS	VOLTS	MFR/CATALOG	DESCRIPTION	
(F1)		LED	WALL PER ARCH	54W LED 4000K 6256 LUMENS	54	120	LIGMAN LIGHTING UTR-31712-54W-T4 W40-01-120/277-DIM-0CC	WALL MOUNTED LED AREALIGHT FIXTURE, BLACK FINISH, REMOTE SENSOR CONTROL AT 15', WET LOCATION LISTED, SEE ARCHITECTURAL DRAWINGS FOR FINAL LOCATION	
(F2)		LED	SURFACE	42W LED 4000K 4042 LUMENS	42	120	DAY-BRITE CFI FSSZ-4-40L-840L UNV-DIM	4' LED STRIPLIGHT WITH NON-DIMMING ELECTRONIC DRIVER	
(F3)		LED	SURFACE	33W LED 4000K 3665 LUMENS	33	120	DAY-BRITE CFI FSS-4-40L-840-UNV-DIM	4' LED INDUSTRIAL LIGHT FIXTURE, PRISMATIC ACRYLIC LENS, END CAP AND 0-10V DIMMABLE ELECTRONIC DRIVER	
(F3E)		LED	SURFACE	33W LED 4000K 3665 LUMENS	33	120	PHILIPS DAYBRITE LFR4-FL-SLD-37-40-U-D2T-EMLED	4' LED INDUSTRIAL LIGHT FIXTURE, PRISMATIC ACRYLIC LENS, END CAP, 0-10V DIMMABLE ELECTRONIC DRIVER AND 1100 LUMEN EMERGENCY BATTERY PACK	
(F4)		LED	RECESSED	17W LED 3500K 1599 LUMENS	17	120	PHILIPS LIGHTOLIER L6RAZ10UVA-L6R15835-L6RDD	6" DIAMETER RECESSED LED DOWN LIGHT, IC RATED HOUSING, OPEN WHITE TRIM AND 0-10V DIMMABLE ELECTRONIC DRIVER	
(F5)		LED	UNDER CABINET	10W LED 4000K 479 LUMENS	10	120	PHILIPS COLOR KINETICS S23-000027-76-120-000065-00	19.25" LED UNDER COUNTER LIGHT, WHITE HOUSING AND WHITE HARD WIRED WIRING COMPARTMENT. PROVIDE A COMPLETE AND OPERABLE SYSTEM	
(F6)		LED	RECESSED	17W LED 3500K 1599 LUMENS	17	120	PHILIPS LIGHTOLIER L6RAZ10UVA-L6R15835-L6RDD	6" DIAMETER RECESSED LED DOWN LIGHT, IC RATED HOUSING, OPEN CLEAR DIFFUSE FINISH, WHITE TRIM AND 0-10V DIMMABLE ELECTRONIC DRIVER, FIRE RATED COVERS WHERE NECESSARY	
(F6E)		LED	RECESSED	17W LED 3500K 1599 LUMENS	17	120	PHILIPS LIGHTOLIER L6RAZ10UVAEM-L6R15835-L6RDD	6" DIAMETER RECESSED LED DOWN LIGHT, IC RATED HOUSING, OPEN CLEAR DIFFUSE FINISH, WHITE TRIM, 0-10V DIMMABLE ELECTRONIC DRIVER AND EMERGENCY BATTERY PACK	
(F7)		LED	RECESSED	17W LED 3500K 1599 LUMENS	17	120	PHILIPS LIGHTOLIER L6RAZ10UVA-L6R15835-L6RDD	6" DIAMETER RECESSED LED DOWN LIGHT, IC RATED HOUSING, OPEN CLEAR DIFFUSE FINISH, WHITE TRIM AND 0-10V DIMMABLE ELECTRONIC DRIVER, WET LISTED	
(F8)		FLUOR	WALL	32W 4000K TWIN TUBE FLUOR	36	120	PHILIPS STONCO VWXL-32-HFL-EB-8-VGR100-V127	WALL MOUNTED COMPACT FLUORESCENT VAPORTIGHT LIGHT, RUBY RED GLOBE, CAST ALUMINUM GUARD AND ELECTRONIC BALLAST	
(F9)		LED	RECESSED	21W LED 3500K DN	21	120	PHILIPS LIGHTOLIER P6RD035VB-P6RDCC	6" DIAMETER RECESSED LED DOWN LIGHT, CLEAR REFLECTOR, WHITE TRIM, 0-10V DIMMABLE ELEC DRIVER	
(F10E)		LED	RECESSED	15.7W LED 3500K 1501 LUMENS	15.7	120	PHILIPS LIGHTOLIER P6RD15NZ10UVBEM-P6RDCC	6" DIAMETER RECESSED LED DOWN LIGHT, LENSED COMFORT CLEAR FINISH, WHITE TRIM, 0-10V DIMMABLE ELECTRONIC DRIVER, WET LOCATION LISTED AND EMERGENCY BATTERY PACK	
(F11)		LED	20' TALL, 4" SQUARE POLE 5000K 12,357 LUMENS	104	208	SIGNIFY ECF-S-32L-1A-NW-G2-AR-5-UNV-BL-MR13-BZ	POLE MOUNTED LED SITE LIGHT FIXTURE, FULL CUTOFF, TYPE 5 MEDIUM OPTICS, INTEGRAL MOTION-AMBIENT SENSOR AND DARK BRONZE FINISH		
(F12)		LED	WALL	34W LED 4000K 1358 LUMENS	34	120	ALN440-Y3-32LED4K-700-BL-LDL-WMA55-BL-SCP	WALL MOUNTED LED LIGHT FIXTURE, WHITE HOUSING, WET LOCATION LISTED, SEE ARCHITECTURAL DRAWINGS FOR FINAL LOCATION	
(F13)		LED	WALL	34W LED 4000K 1358 LUMENS	34	120	PHILIPS STONCO VR2RLED-40K-DO-WT	WALL MOUNTED LED LIGHT FIXTURE, WHITE HOUSING, WET LOCATION LISTED, SEE ARCHITECTURAL DRAWINGS FOR FINAL LOCATION	
(F14)		LED	CHAIN HUNG	38W LED 4000K 4431 LUMENS	38	120	PHILIPS DAYBRITE DWPE-43L-840-4-UNV-TBK-FKR-126	4' LED INDUSTRIAL GASKETED LIGHT FIXTURE, POLYCARBONATE LENS, END CAP, SURFACE OR CHAIN HUNG AS DIRECTED BY ARCHITECT AND 0-10V DIMMABLE ELECTRONIC DRIVER	
(F15)		LED	PENDANT	21W LED 3500K 2027 LUMENS	21	120	PHILIPS LIGHTOLIER P6RD035VB-P6RDCC	6" DIAMETER RECESSED LED DOWN LIGHT, LENSED COMFORT CLEAR FINISH, WHITE TRIM, 0-10V DIMMABLE ELEC DRIVER AND WET LOCATION LISTED	
(F16)		LED	GRADE	18W LED 3000K 25 DEGREE SPREAD	18	120	VISTA PRO MODEL 1188	INGROUND & WELL LIGHT FLAG POLE, WET LOCATION LISTED LIGHT FIXTURE WITH REMOTE ELECTRONIC DRIVER	
(F17)		LED	WALL	2.5W LED 3000K	2.5	120	PHILIPS CONSUMER LUMINAIRE 667048748	ADJUSTABLE WALL MOUNTED LED READING LIGHT FIXTURE WITH INTEGRAL SWITCH	
(F18)		LED	RECESSED	27.9W LED 3500K 2739 LUMENS	27.9	120	SIGNIFY D122D1-ST-L8B-E-S-7-D-E	2 X 2 RECESSED MOUNTED LED LIGHT FIXTURE, WHITE HOUSING WITH 0-10V DIMMABLE ELECTRONIC DRIVER	
(F18E)		LED	RECESSED	27.9W LED 3500K 2739 LUMENS	27.9	120	SIGNIFY D122D1-ST-L8B-E-S-N-D-E	2 X 2 RECESSED MOUNTED LED LIGHT FIXTURE, WHITE HOUSING, 0-10V DIMMABLE ELECTRONIC DRIVER AND 900 LUMEN EMERGENCY BATTERY PACK	
(F19)		LED	SURFACE	38W LED 4000K 4431 LUMENS	38	120	PHILIPS DAYBRITE DWAE43L840-4-UNV	1'x4' SURFACE MOUNTED LED LIGHT FIXTURE, WHITE VAPORTIGHT HOUSING, 0-10V DIMMABLE ELECTRONIC DRIVER AND WET LOCATION LISTED	
(F20)		LED	SURFACE	130W LED 4000K 14660 LUMENS	130	120	PHILIPS DAYBRITE DWAE70L840-8-UNV	1'x8' SURFACE MOUNTED LED LIGHT FIXTURE, WHITE VAPORTIGHT HOUSING, 0-10V DIMMABLE ELECTRONIC DRIVER AND WET LOCATION LISTED	
(F20E)		LED	SURFACE	130W LED 4000K 14660 LUMENS	130	120	PHILIPS DAYBRITE DWAE70L840-8-UNV-EMLED	1'x8' SURFACE MOUNTED LED LIGHT FIXTURE, WHITE VAPORTIGHT HOUSING, 0-10V DIMMABLE ELECTRONIC DRIVER, WET LOCATION LISTED WITH EMERGENCY BATTERY PACK	
(F21)		N/A	CEILING	N/A	50	120	HUNTER CEILING PER ARCHITECT REMOTE FAN CONTROL 22691	CEILING FAN WITH 52" BLADE, WHITE SATIN FINISH AND ONE (1) REMOTE CONTROL UNIT	
(F22)		LED	BOLLARD	60W LED 3500K 200 LUMENS	25	120	LUOIFER LIGHTING IS2LB-2-BK-80L04B-35K-120AT2-CP	LED FREE STANDING BOLLARDS.	
(E1)		LED	SURFACE	2.5W LED	2.5	120	PHILIPS CHLORIDE ER46L2R	LED EXIT SIGN, BLACK HOUSING, RED LETTERS WITH INTEGRAL EMERGENCY BATTERY PACK	
(F24)		LED	RECESSED	27.9W LED 3500K 2739 LUMENS	27.9	120	PHILIPS LEDALITE 4124-S1ST-L8BE-S-7-DE	2 X 4 RECESSED MOUNTED LED LIGHT FIXTURE, WHITE HOUSING WITH 0-10V DIMMABLE ELECTRONIC DRIVER	
(F24E)		LED	RECESSED	27.9W LED 3500K 2739 LUMENS	27.9	120	PHILIPS LEDALITE 4124-S1ST-L8BE-S-7/5-DE	2 X 4 RECESSED MOUNTED LED LIGHT FIXTURE, WHITE HOUSING, 0-10V DIMMABLE ELECTRONIC DRIVER AND 900 LUMEN EMERGENCY BATTERY PACK	
(F25)		LED	PENDANT	38W LED 3000K 2660 LUMENS	38	120	STUDIOM LIGHTING ABYSS SM250086BK	THESE CLASSIC CONE PENDANTS IN MATTE BLACK THESE PENDANTS ARE ILLUMINATED ON THE BOTTOM PERIMETER CREATING A BLACK ABYSS ON THE INSIDE GENERATING AN INTERESTING LIGHTING EFFECT	
(F26)		LED	WALL	-	-	-	MEYER LIGHTING S151	1-1/4" DIAMETER LED, OUTDOOR LINEAR WALL WASHER.	
(F27)		LED	WALL	-	-	-	LURA LINE LIGHTING RA11 GNL	11" ANGLED, 11" L-ARM	

LIGHTING FIXTURE NOTES:

1. PROVIDE SPECIFIED LIGHTING MANUFACTURER FOR EACH LIGHT FIXTURE. ANY SUBSTITUTIONS SHALL MEET OR EXCEED THE SPECIFICATIONS OF THE LISTED MANUFACTURERS CATALOG NUMBER. PROVIDE CUT SHEETS FOR APPROVAL BY ARCHITECT PRIOR TO PROCUREMENT.
2. COORDINATE ALL FIXTURE COLORS, REFLECTORS, FINISHES, MOUNTING LOCATIONS, POLES AND HEIGHTS WITH ARCHITECT PRIOR TO PROCUREMENT.

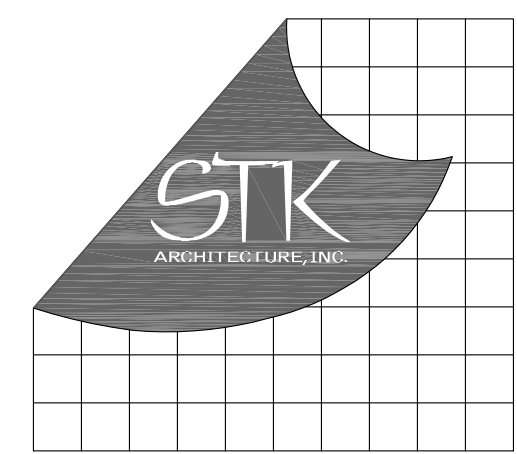

4005 DEVIS DR., TEMECULA, CALIFORNIA 92590-3760
Phone: 951.266.8110 Fax: 951.266.6079 Email: stk@stkbldg.com

CONSULTANT:



69-28-22
www.salasobrien.com
E-Mail: admin@stkbldg.com

PROJECT ADMINISTERED BY:

SAN BERNARDINO COUNTY
PROJECT & FACILITIES
MANAGEMENT DEPARTMENT

385 N. ARROWHEAD AVE.
SAN BERNARDINO, CA 92415

PROJECT NAME:

SAN BERNARDINO
COUNTY FIRE
DEPARTMENT:
FIRE STATION 226

PROJECT # 10.10.1032

CIP #21-037

CAFM # SAB198

APN # 0273-011-22

1920 DEL ROSA AVE N.
SAN BERNARDINO,
CA 92404


ISSUE INFORMATION:

DATE:	INFORMATION:
04-11-2022	20% CD SET
04-28-2022	50% CD SET
06-15-2022	295% CD SET
09-16-2022	295% CD- 3rd BAY
10-03-2022	PLAN CHECK

SHEET INFORMATION:

STK PROJECT NO.:	374-154-21
SCALE:	AS NOTED
DATE:	JANUARY 2021
PLOT DATE:	—
DRAWING NAME:	—

SEAL:

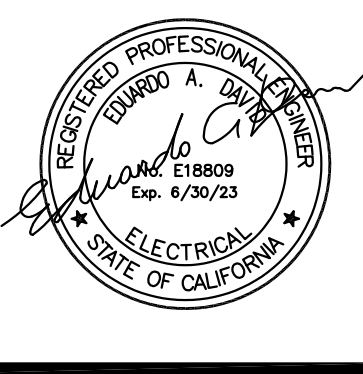

SHEET TITLE:

ELECTRICAL
SCHEDULES

SHEET NO.:

E0.2

STATE OF CALIFORNIA

Outdoor Lighting

NRCC-LTO-E

CALIFORNIA ENERGY COMMISSION

CERTIFICATE OF COMPLIANCE

NRCC-LTO-E

Project Name: San bernardino County Fire Department: Fire Station 226

Report Page: (Page 7 of 8)

Project Address: 1920 Del Rosa Ave, North

Date Prepared: 6/13/2022

P. DECLARATION OF REQUIRED CERTIFICATES OF ACCEPTANCE

Selections have been made based on information provided in this document. If any selection have been changed by permit applicant, an explanation should be included in Table E. Additional Remarks. These documents must be provided to the building inspector during construction and must be completed through an Acceptance Test Technician Certification Provider (ATTCP). For more information visit: <http://www.energy.ca.gov/tite24/attcp/providers.html>

Yes	No	Form/Title	Field Inspector				
<input checked="" type="radio"/>	<input type="radio"/>	NRCA-LTO-02-A - Must be submitted for all outdoor lighting controls except for alterations where controls are added to <= 20 luminaires.	<table><tr><td>Pass</td><td>Fail</td></tr><tr><td><input type="checkbox"/></td><td><input type="checkbox"/></td></tr></table>	Pass	Fail	<input type="checkbox"/>	<input type="checkbox"/>
Pass	Fail						
<input type="checkbox"/>	<input type="checkbox"/>						

Registration Number: CA Building Energy Efficiency Standards - 2019 Nonresidential Compliance

Registration Date/Time: Report Version: 2019.1.003 Schema Version: rev 20200601

Registration Provider: Energysoft

Report Generated: 2022-06-13 17:27:11

STATE OF CALIFORNIA

Outdoor Lighting

NRCC-LTO-E

CALIFORNIA ENERGY COMMISSION

CERTIFICATE OF COMPLIANCE

NRCC-LTO-E

Project Name: San bernardino County Fire Department: Fire Station 226

Report Page: (Page 8 of 8)

Project Address: 1920 Del Rosa Ave, North

Date Prepared: 6/13/2022

DOCUMENTATION AUTHOR'S DECLARATION STATEMENT

I certify that this Certificate of Compliance documentation is accurate and complete.

Documentation Author Name: Eduardo G. Brien	Documentation Author Signature: Eduardo G. Brien
Company: Y-Squared Professional Engineers, Inc.	Signature Date: 2022-06-13
Address: 1340 Specialty Dr., Suite E	CEA/HERS Certification Identification (if applicable):
City/State/Zip: Vista CA 92081	Phone: (760) 560-0100

RESPONSIBLE PERSON'S DECLARATION STATEMENT

I certify the following under penalty of perjury, under the laws of the State of California:

- The information provided on this Certificate of Compliance is true and correct.
- I am eligible under Division 3 of the Business and Professions Code to accept responsibility for the building design or system design identified on this Certificate of Compliance (responsible designer).
- The energy features and performance specifications, materials, components, and manufactured devices for the building design or system design identified on this Certificate of Compliance conform to the requirements of Title 24, Part 1 and Part 6 of the California Code of Regulations.
- The building design features or system design features identified on this Certificate of Compliance are consistent with the information provided on other applicable compliance documents, worksheets, calculations, plans and specifications submitted to the enforcement agency for approval with this building permit application.
- I will ensure that a completed signed copy of this Certificate of Compliance shall be made available with the building permit(s) issued for the building, and made available to the enforcement agency for all applicable inspections. I understand that a completed signed copy of this Certificate of Compliance is required to be included with the documentation the builder provides to the building owner at occupancy.

Responsible Designer Name: Ed David	Responsible Designer Signature: Eduardo G. Brien
Company: Y-Squared Professional Engineers, Inc.	Date Signed: 2022-06-13
Address: 1340 Specialty Dr., Suite E	License: C18809
City/State/Zip: Vista CA 92081	Phone: (760) 560-0100

Registration Number: CA Building Energy Efficiency Standards - 2019 Nonresidential Compliance

Registration Date/Time: Report Version: 2019.1.003 Schema Version: rev 20200601

Registration Provider: Energysoft

Report Generated: 2022-06-13 17:27:11

STATE OF CALIFORNIA

Outdoor Lighting

NRCC-LTO-E

CALIFORNIA ENERGY COMMISSION

CERTIFICATE OF COMPLIANCE

NRCC-LTO-E

Project Name: San bernardino County Fire Department: Fire Station 226

Report Page: (Page 4 of 8)

Project Address: 1920 Del Rosa Ave, North

Date Prepared: 6/13/2022

F. OUTDOOR LIGHTING FIXTURE SCHEDULE

For new or altered lighting systems demonstrating compliance with §140.7, all new luminaires being installed and any existing luminaires remaining or being moved within the spaces covered by the permit application are included in the Table below. For altered lighting systems using the Existing Power method per §141.0(b)(2), only new luminaires being installed and replacement luminaires being installed as part of the project scope are included (i.e. existing luminaires remaining or existing luminaires being moved are not included).

Designed Wattage:

01	02	03	04	05	06	07	08	09	10
----	----	----	----	----	----	----	----	----	----

⁴ Compliance with mandatory cutoff requirements is required for luminaires with initial lumen output >= 6,200 unless exempted by §130.2(b).

G. CUTOFF REQUIREMENTS (BUG)

This section does not apply to this project.

H. OUTDOOR LIGHTING CONTROLS

This table demonstrates compliance with controls requirements for all new or altered luminaires installed as part of the permit application. For alteration projects, luminaires which are existing to remain (i.e. untouched) and luminaires which are removed and reinstalled (wiring only) do not need to be included in this table even if they are within the spaces covered by the permit application. When an option having a * is selected, the notes section of this table must be completed. The lighting controls section of the Compliance Summary Table on the first page will show "DOES NOT COMPLY" if the notes are left blank.

Mandatory Controls

01	02	03	04	05
Area Description	Shut-Off §130.2(c)(1)	Auto-Schedule §130.2(c)(2)	Motion Sensor §130.2(c)(3)	Field Inspector
				Pass
				Fail

⁴ NOTES: Controls with a * require a note in the space below explaining how compliance is achieved. EX: Not permitted by health & safety to be turned off. EXCEPTION 2 to §130.2(b).

Registration Number: CA Building Energy Efficiency Standards - 2019 Nonresidential Compliance

Registration Date/Time: Report Version: 2019.1.003 Schema Version: rev 20200601

Registration Provider: Energysoft

Report Generated: 2022-06-13 17:27:11

STATE OF CALIFORNIA

Outdoor Lighting

NRCC-LTO-E

CALIFORNIA ENERGY COMMISSION

CERTIFICATE OF COMPLIANCE

NRCC-LTO-E

Project Name: San bernardino County Fire Department: Fire Station 226

Report Page: (Page 5 of 8)

Project Address: 1920 Del Rosa Ave, North

Date Prepared: 6/13/2022

I. LIGHTING POWER ALLOWANCE (per §140.7)

This table includes areas using allowance calculations per §140.7. General Hardscape Allowance is per Table 140.7-A while "Use it or lose it" Allowances are per Table 140.7-B. Indicate which allowances are being used to expand sections for user input. Luminaires that qualify for one of the "Use it or lose it" allowances shall not qualify for another "Use it or lose it" allowance.

<input checked="" type="checkbox"/> General Hardscape Allowance Table I (below)	<input type="checkbox"/> "Use it or lose it" Allowance (select all that apply) (select all that apply) <input type="checkbox"/> Per Application Table J <input type="checkbox"/> Sales Frontage Table K <input type="checkbox"/> Ornamental Table L <input checked="" type="checkbox"/> Per Specific Area Table M
---	---

Calculated General Hardscape Lighting Power Allowance per Table 140.7-A (LZ 0, 1 & 4)

This section does not apply to this project.

Calculated General Hardscape Lighting Power Allowance per Table 140.7-A (LZ 2 & 3)

02	03	04	05	06	07	08	09	10
Area Description	Surface Type	Illuminated Area (ft²)	Allowed Density (W/ft²)	Area Allowance (Watts)	Perimeter Length (ft)	Allowed Density (W/ft)	Linear Allowance (Watts)	Total General AWA + LWA (Watts)
Automotive Hardscape	Asphalt	5100	0.03	127.5	313	0.4	78.25	205.75
Pedestrian Hardscape	Asphalt	4500	0.03	112.5	643	0.4	160.75	273.25
Initial Wattage Allowance for Entire Site (Watts):								350
Total General Hardscape Allowance (Watts):								829

J. LIGHTING ALLOWANCE: PER APPLICATION

This section does not apply to this project.

K. LIGHTING ALLOWANCE: SALES FRONTAGE

This section does not apply to this project.

L. LIGHTING ALLOWANCE: ORNAMENTAL

This section does not apply to this project.

Registration Number: CA Building Energy Efficiency Standards - 2019 Nonresidential Compliance

Registration Date/Time: Report Version: 2019.1.003 Schema Version: rev 20200601

Registration Provider: Energysoft

Report Generated: 2022-06-13 17:27:11

STATE OF CALIFORNIA

Outdoor Lighting

NRCC-LTO-E

CALIFORNIA ENERGY COMMISSION

CERTIFICATE OF COMPLIANCE

NRCC-LTO-E

Project Name: San bernardino County Fire Department: Fire Station 226

Report Page: (Page 6 of 8)

Project Address: 1920 Del Rosa Ave, North

Date Prepared: 6/13/2022

M. LIGHTING ALLOWANCE: PER SPECIFIC AREA

This table includes areas using the wattage allowance per specific area from Table 140.7-B. More than one specific area allowance may be taken in a single project, if applicable. However, multiple specific area allowances may not be taken for the exact same area on the site.

01	02	03	04	05	06	07	08	09	10
Area Description	Specific Area Type per Table 140.7-B	CALCULATED ALLOWANCE (Watts)		DESIGN WATTS			Additional Allowance (Watts)		
		Specific Area (ft²)	Allowed Density (W/ft²)	Extra Allowance (Watts)	Luminaire Name or Item Tag	Watts per Luminaire	# of Luminaires	Design Watts	
Building Facade	Building Facade	350	0.17	59.5	F12	75	3	225	59.5
Total Design Watts for this Area:						225			
Total Allowance (Watts) All Areas:						59.5			

¹ FOOTNOTES: See Table 140.7-B for rules for calculating the specific areas (ft²) for these additional lighting allowances.

² For luminaires indicated in Table F as linear, wattage in column D7 is W/ft instead of Watts/luminaire. Total linear feet should be indicated in column D8 instead of number of luminaires.

N. EXISTING CONDITIONS POWER ALLOWANCE (alterations only)

This section does not apply to this project.

O. DECLARATION OF REQUIRED CERTIFICATES OF INSTALLATION

Selections have been made based on information provided in this document. If any selection have been changed by permit applicant, an explanation should be included in Table E. Additional Remarks. These documents must be provided to the building inspector during construction and can be found online at https://www.energy.ca.gov/tite24/2019standards/2019_compliance_documents/Nonresidential_Documents/NRC/

Yes	No	Form/Title	Field Inspector				
<input type="radio"/>	<input checked="" type="radio"/>	NRCC-LTO-01-E - Must be submitted for all buildings	<table><tr><td>Pass</td><td>Fail</td></tr><tr><td><input type="checkbox"/></td><td><input type="checkbox"/></td></tr></table>	Pass	Fail	<input type="checkbox"/>	<input type="checkbox"/>
Pass	Fail						
<input type="checkbox"/>	<input type="checkbox"/>						
<input checked="" type="radio"/>	<input type="radio"/>	NRCC-LTO-02-E - Must be submitted for a lighting control system, or for an Energy Management Control System (EMCS), to be recognized for compliance.	<table><tr><td>Pass</td><td>Fail</td></tr><tr><td><input type="checkbox"/></td><td><input type="checkbox"/></td></tr></table>	Pass	Fail	<input type="checkbox"/>	<input type="checkbox"/>
Pass	Fail						
<input type="checkbox"/>	<input type="checkbox"/>						

Registration Number: CA Building Energy Efficiency Standards - 2019 Nonresidential Compliance

Registration Date/Time: Report Version: 2019.1.003 Schema Version: rev 20200601

Registration Provider: Energysoft

Report Generated: 2022-06-13 17:27:11

STATE OF CALIFORNIA

Outdoor Lighting

NRCC-LTO-E

CALIFORNIA ENERGY COMMISSION

CERTIFICATE OF COMPLIANCE

NRCC-LTO-E

Project Name: San bernardino County Fire Department: Fire Station 226

Report Page: (Page 1 of 8)

Project Address: 1920 Del Rosa Ave, North

Date Prepared: 6/13/2022

A. GENERAL INFORMATION

01 Project Location (city)	San Bernardino	04 Total Illuminated Hardscape Area (ft²)	9600
02 Climate Zone	10		
03 Outdoor Lighting Zone per Title 24 Part 1 §140.114 or as designated by Authority Having Jurisdiction (AHJ):			
<input type="checkbox"/> LZ-0: Very Low - Undeveloped Parkland		<input type="checkbox"/> LZ-2: Moderate - Rural Areas	<input type="checkbox"/> LZ-4: High - Must be reviewed by CA Energy Commission for Approval
<input type="checkbox"/> LZ-1: Low - Developed Parkland		<input checked="" type="checkbox"/> LZ-3: Moderately High - Urban Areas	

B. PROJECT SCOPE

This table includes outdoor lighting systems that are within the scope of the permit application and are demonstrating compliance using the prescriptive path outlined in §140.7 or §141.0(b)(2), for alterations.

My Project Consists of:

01	02
<input checked="" type="checkbox"/> New Lighting System	Must Comply with Allowances from §140.7
<input type="checkbox"/> Altered Lighting System	Is your alteration increasing the connected lighting load (Watts)?
	<input checked="" type="radio"/> Yes <input type="radio"/> No
03 % of Existing Luminaires Being Altered ¹	04 Sum Total of Luminaires Being Added or Altered
<input type="checkbox"/> < 10% <input type="checkbox"/> >= 10% and < 50% <input type="checkbox"/> >= 50%	05 Calculation Method
Please proceed to Table F. Outdoor Lighting Fixture Schedule to define the project's luminaires.	
¹ FOOTNOTES: % of Existing Luminaires Being Altered = (Sum Total of Luminaires Being Added or Altered / Existing Luminaires within the Scope of the Permit Application) x 100.	

Registration Number: CA Building Energy Efficiency Standards - 2019 Nonresidential Compliance

Registration Date/Time: Report Version: 2019.1.003 Schema Version: rev 20200601

Registration Provider: Energysoft

Report Generated: 2022-06-13 17:27:11

STATE OF CALIFORNIA

Outdoor Lighting

NRCC-LTO-E

CALIFORNIA ENERGY COMMISSION

CERTIFICATE OF COMPLIANCE

NRCC-LTO-E

Project Name: San bernardino County Fire Department: Fire Station 226

Report Page: (Page 2 of 8)

Project Address: 1920 Del Rosa Ave, North

Date Prepared: 6/13/2022

C. COMPLIANCE RESULTS

Results in this table are automatically calculated from data input and calculations in Tables F through I. Note: If any cell on this table says "COMPLIES with Exceptional Conditions" refer to Table D. Exceptional Conditions for guidance or see applicable Table referenced below.

Calculations of Total Allowed Lighting Power (Watts) §140.7 or §141.0(b)(2)										Compliance Results		
01 General Hardscape Allowance §140.7(d)(1) (See Table I)	02 Per Application §140.7(d)(3) (See Table J)	03 Sales Frontage §140.7(d)(2) (See Table K)	04 Ornamental §140.7(d)(2) (See Table L)	05 Per Specific Area §140.7(d)(2) (See Table M)	06 Existing Power Allowance §141.0(b)(2) (See Table N)	07 Total Allowed (Watts)	08 Total Actual (Watts)	09 07 must be >= 08				
829	+	---	+	---	+	59.5	OR	---	=	888.5		
Cutoff Compliance (See Table G for Details)							N/A					
Controls Compliance (See Table H for Details)							COMPLIES					

D. EXCEPTIONAL CONDITIONS

This table is auto-filled with uneditable comments because of selections made or data entered in tables throughout the form.

E. ADDITIONAL REMARKS

This table includes remarks made by the permit applicant to the Authority Having Jurisdiction.

Registration Number: CA Building Energy Efficiency Standards - 2019 Nonresidential Compliance

Registration Date/Time: Report Version: 2019.1.003 Schema Version: rev 20200601

Registration Provider: Energysoft

Report Generated: 2022-06-13 17:27:11

STATE OF CALIFORNIA

Outdoor Lighting

NRCC-LTO-E

CALIFORNIA ENERGY COMMISSION

CERTIFICATE OF COMPLIANCE

NRCC-LTO-E

Project Name: San bernardino County Fire Department: Fire Station 226

Report Page: (Page 3 of 8)

Project Address: 1920 Del Rosa Ave, North

Date Prepared: 6/13/2022

F. OUTDOOR LIGHTING FIXTURE SCHEDULE

For new or altered lighting systems demonstrating compliance with §140.7, all new luminaires being installed and any existing luminaires remaining or being moved within the spaces covered by the permit application are included in the Table below. For altered lighting systems using the Existing Power method per §141.0(b)(2), only new luminaires being installed and replacement luminaires being installed as part of the project scope are included (i.e. existing luminaires remaining or existing luminaires being moved are not included).

Designed Wattage:

01	02	03	04	05	06	07	08	09	10
Name or Item Tag	Complete Luminaire Description	Watts per luminaire ^{1,2}	How is Wattage determined	Total number luminaires ²	Luminaire Status ³	Excluded per §140.7(a)	Design Watts	Cutoff Req. > 6,200 Initial lumen output §130.2(b) ⁴	Field Inspector
F1	75w LED Wall Mounted Area Light	<input type="checkbox"/> Linear	75	Mfr. Spec	3	New	<input type="checkbox"/>	225	NA: < 6200 lumens <input type="checkbox"/> Pass <input type="checkbox"/> Fail
F10E	15.7w LED Down Light	<input type="checkbox"/> Linear	15.7	Mfr. Spec	1	New	<input type="checkbox"/>	15.7	NA: < 6200 lumens <input type="checkbox"/> <input type="checkbox"/>
F11B	104w LED	<input type="checkbox"/> Linear	104	Mfr. Spec	1	New	<input type="checkbox"/>	104	NA: < 6200 lumens <input type="checkbox"/> <input type="checkbox"/>
F12	75w LED Wall Mounted Area Light	<input type="checkbox"/> Linear	75	Mfr. Spec	4	New	<input type="checkbox"/>	300	NA: < 6200 lumens <input type="checkbox"/> <input type="checkbox"/>
F13	34w Decorative LED Wall Light	<input type="checkbox"/> Linear	34	Mfr. Spec	1	New	<input type="checkbox"/>	34	NA: < 6200 lumens <input type="checkbox"/> <input type="checkbox"/>
F14	38w LED Chain Hung Vapor Tight Light	<input type="checkbox"/> Linear	38	Mfr. Spec	3	New	<input type="checkbox"/>	114	NA: < 6200 lumens <input type="checkbox"/> <input type="checkbox"/>
F9	21w LED Down Light	<input type="checkbox"/> Linear	21	Mfr. Spec	4	New	<input type="checkbox"/>	84	NA: < 6200 lumens <input type="checkbox"/> <input type="checkbox"/>
Total Design Watts:								876.7	

¹ NOTES: Selections with a * require a note in the space below explaining how compliance is achieved.

² Luminaire's lighting status: EXCEPTION 2 to §130.2(b).

³ FOOTNOTES: Authority Having Jurisdiction may ask for Luminaire cut sheets to confirm wattage used for compliance per §130.0(c).

⁴ For linear luminaires, wattage should be indicated as W/ft instead of Watts/luminaire. Total linear feet should be indicated in column D5 instead of number of luminaires.


⁵ Select "New" for new luminaires in a new outdoor lighting project, or for added luminaires in an alteration. Select "Altered" for replacement luminaires in an alteration. Select "Existing to Remain" for existing luminaires within the project scope that are not being altered and are remaining. Select "Existing Reinstalled" for existing luminaires which are being removed and reinstalled as part of the project scope.

Registration Number: CA Building Energy Efficiency Standards - 2019 Nonresidential Compliance

Registration Date/Time: Report Version: 2019.1.003 Schema Version: rev 20200601

Registration Provider: Energysoft

Report Generated: 2022-06-13 17:27:11

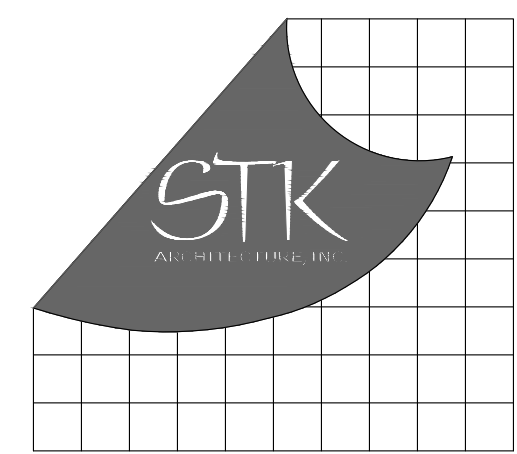

PROJECT ADMINISTERED BY:
SAN BERNARDINO COUNTY
PROJECT & FACILITIES
MANAGEMENT DEPARTMENT

385 N. ARROWHEAD AVE.
SAN BERNARDINO, CA 92415

PROJECT NAME:
SAN BERNARDINO
COUNTY FIRE
DEPARTMENT:
FIRE STATION 226

PROJECT # 10.10.032
CIP #21-037
CAFM # SAB198
APN # 0273-011-22

1920 DEL ROSA AVE N.
SAN BERNARDINO,
CA 92404

ISSUE INFORMATION:	
DATE:	INFORMATION:
04-11-2022	20% CD SET
04-28-2022	50% CD SET
06-05-2022	95% CD SET
09-16-2022	95% CD- 3rd BAY
10-03-2022	PLAN CHECK

SHEET INFORMATION:
STK PROJECT NO.: 374-154-21
SCALE: AS NOTED
DATE: JANUARY 2021
PLOT DATE:
DRAWING NAME:

SEAL:



SHEET TITLE:

EXTERIOR
TITLE 24

SHEET NO.:

E0.3

STATE OF CALIFORNIA

Indoor Lighting

NRCC-LTH-E

CALIFORNIA ENERGY COMMISSION

CERTIFICATE OF COMPLIANCE

Project Name:San Bernardino County Fire Department: Fire Station 220

Report Page:(Page 7 of 8)

Project Address:1920 Del Rosa Ave N

Date Prepared:6/13/2022

U. DECLARATION OF REQUIRED CERTIFICATES OF ACCEPTANCE

Selections have been made based on information provided in this document. If any selection have been changed by the permit applicant, an explanation should be included in Table E.

Additional Remarks: These documents must be provided to the building inspector during construction and any with "A" in the form name must be completed through an Acceptance Test Technician Certification Provider (ATTCP). For more information visit: <http://www.energy.ca.gov/title24/attccp/providers.html>

Yes	No	Form/Title	Field Inspector	
			Pass	Fail
<input checked="" type="radio"/>	<input type="radio"/>	NRCA-LTI-02-A - Must be submitted for occupancy sensors and automatic time switch controls.	<input type="checkbox"/>	<input type="checkbox"/>
<input type="radio"/>	<input checked="" type="radio"/>	NRCA-LTI-03-A - Must be submitted for automatic daylight controls.	<input type="checkbox"/>	<input type="checkbox"/>
<input type="radio"/>	<input type="radio"/>	NRCA-LTI-04-A - Must be submitted for demand responsive lighting controls.	<input type="checkbox"/>	<input type="checkbox"/>
<input type="radio"/>	<input checked="" type="radio"/>	NRCA-LTI-05-A - Must be submitted for institutional tuning power adjustment factor (PAF)	<input type="checkbox"/>	<input type="checkbox"/>

Registration Number:

Registration Date/Time:

Registration Provider: EnergyIQ


CA Building Energy Efficiency Standards - 2019 Nonresidential Compliance


Report Version: 2019.1.003

Schema Version: rev 20200601

Report Generated: 2022-06-13 17:15:09

STATE OF CALIFORNIA Indoor Lighting NSC-014		CALIFORNIA ENERGY COMMISSION	
CERTIFICATE OF COMPLIANCE		NRCC-17E	
Project Name: San Bernardino County Fire Department: Fire Station 220		Report Page: (Page 8 of 8)	
Project Address: 1920 Del Rosa Ave N		Date Prepared: 6/13/2022	

DOCUMENTATION AUTHOR'S DECLARATION STATEMENT I certify that this Certificate of Compliance documentation is accurate and complete.	
Documentation Author Name:	Documentation Author Signature: 
Company:	Signature Date:
Address:	CEA/HERS Certification Identification (if applicable):
City/State/Zip:	Phone:

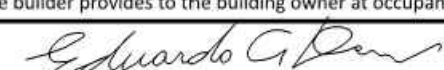RESPONSIBLE PERSON'S DECLARATION STATEMENT I certify the following under penalty of perjury under the laws of the State of California:	
<ol style="list-style-type: none"> 1. The information provided on this Certificate of Compliance is true and correct. 2. I am eligible under Division 3 of the Business and Professions Code to accept responsibility for the building design or system design identified on this Certificate of Compliance (responsible designer) 3. The energy features and performance specifications, materials, components, and manufactured devices for the building design or system design identified on this Certificate of Compliance conform to the requirements of Title 24, Part 1 and Part 6 of the California Code of Regulations. 4. The building design features or system design features identified on this Certificate of Compliance are consistent with the information provided on other applicable compliance documents, worksheets, calculations, plans and specifications submitted to the enforcement agency for approval with this building permit application. 5. I will ensure that a completed signed copy of this Certificate of Compliance shall be made available with the building permit(s) issued for the building, and made available to the enforcement agency for all applicable inspections. I understand that a completed signed copy of this Certificate of Compliance is required to be included with the documentation the builder provides to the building owner at occupancy. 	
Responsible Designer Name: Ed David	Responsible Designer Signature: 
Company: T-Squared Professional Engineers, Inc.	Date Signed: 2022-06-13
Address: 1340 Specialty Dr., Suite E	License: E18809
City/State/Zip: Vista CA 92081	Phone: (760) 560-0100

Registration Number:	Registration Date/Time:	Registration Provider: Energysight
CA Building Energy Efficiency Standards - 2019 Nonresidential Compliance	Report Version: 2019.1.003 Schema Version: rev 20200601	Report Generated: 2022-06-13 17:15:09

STATE OF CALIFORNIA											
Indoor Lighting											
NRC-C-17.4											
CALIFORNIA ENERGY COMMISSION											
NRC-C-17.4											
CERTIFICATE OF COMPLIANCE											
Project Name:				San Bernardino County Fire Department: Fire Station 226				Report Page:		(Page 4 of 8)	
Project Address:				1920 Del Rosa Ave N				Date Prepared:		6/13/2022	
F. INDOOR LIGHTING FIXTURE SCHEDULE											
<i>*Authority Having Jurisdiction may ask for Luminaire cut sheets to confirm wattage used for compliance per §130.0(c). Wattage used must be the maximum rated for the luminaire, not the lamp.</i>											
G. MODULAR LIGHTING SYSTEMS											
This section does not apply to this project.											
H. INDOOR LIGHTING CONTROLS (Not including PAFs)											
<i>This table includes lighting controls for conditioned and unconditioned spaces. Where a control having a * is shown, the notes section of this table provides more detail on how compliance is achieved. The lighting controls section of the Compliance Summary Table on the first page will show "DOES NOT COMPLY" if the notes are left blank.</i>											
Building Level Controls											
01				02				03			
Mandatory Demand Response §130.12(c)				Shut-off controls §130.1(c)				Field Inspector			
Required > 10,000 SF				Whole Building Auto Time Switch				Pass		Fail	
								<input type="checkbox"/>		<input type="checkbox"/>	
Area Level Controls											
04		05		06		07		08		09	
Area Description		Complete Building or Area Category Primary Function Area		Area Controls §130.1(a)		Multi-Level Controls §130.1(c)		Shut-Off Controls §130.1(c)		Primary/Sky Light Daylighting §130.1(d)	
Area Description		Complete Building or Area Category Primary Function Area		Area Controls §130.1(a)		Multi-Level Controls §130.1(c)		Shut-Off Controls §130.1(c)		Secondary Daylighting §140.6(d)	
Area Description		Complete Building or Area Category Primary Function Area		Area Controls §130.1(a)		Multi-Level Controls §130.1(c)		Shut-Off Controls §130.1(c)		Interlocked Systems §140.6(a)(1)	
Area Description		Complete Building or Area Category Primary Function Area		Area Controls §130.1(a)		Multi-Level Controls §130.1(c)		Shut-Off Controls §130.1(c)		Field Inspector	
										Pass	
										Fail	
<p>*NOTES: Controls with a * require a note in the space below explaining how compliance is achieved.</p> <p>EX: Conference 1: Primary/Skylight Daylighting: Exempt because less than 120 watts of general lighting; EXCEPTION 1 to §130.1(d)(2)</p>											
										13	
										Pass	
										Fail	
Plan Sheet Showing Daylit Zones:											
I. LIGHTING POWER ALLOWANCE: COMPLETE BUILDING OR AREA CATEGORY METHODS											
<i>Each area complying using the Complete Building or Area Category Methods per §140.6(b) are included in this table. Column 06 indicates if additional lighting power allowances per §140.6(c) or adjustments per §140.6(a) are being used.</i>											
Conditioned Spaces											
<p>Registration Number: _____</p> <p>CA Building Energy Efficiency Standards - 2019 Nonresidential Compliance</p>											
<p>Registration Date/Time: _____</p> <p>Report Version: 2019.1.003</p> <p>Schema Version: rev 20200601</p>											
<p>Registration Provider: EnergyProof</p> <p>Report Generated: 2022-06-13 17:15:09</p>											

STATE OF CALIFORNIA Indoor Lighting <small>NCC-014</small>		CALIFORNIA ENERGY COMMISSION NRECC-01E	
CERTIFICATE OF COMPLIANCE			
Project Name:		San Bernardino County Fire Department: Fire Station 220	
Project Address:		1920 Del Rosa Ave N	
		Report Page:	(Page 5 of 8)
		Date Prepared:	6/13/2022

I. LIGHTING POWER ALLOWANCE: COMPLETE BUILDING OR AREA CATEGORY METHODS					
01	02	03	04	05	06
Area Description	Complete Building or Area Category Primary Function Area	Allowed Density (W/R ²)	Area (ft ²)	Allowed Wattage (Watts)	Additional Allowance / Adjustment
Whole Building	Assembly Building	0.7	7,299	5,109.3	No
TOTALS:				5,109.3	See Tables J, or P for detail

Unconditioned Spaces

01	02	03	04	05	06
Area Description	Complete Building or Area Category Primary Function Area	Allowed Density (W/R ²)	Area (ft ²)	Allowed Wattage (Watts)	Additional Allowance / Adjustment
Whole Building	Assembly Building	0.7	490	343	No
TOTALS:				343	See Tables J, or P for detail

J. ADDITIONAL ALLOWANCE: AREA CATEGORY METHOD QUALIFYING LIGHTING SYSTEM	
This section does not apply to this project.	

K. TAILORED METHOD GENERAL LIGHTING POWER ALLOWANCE	
This section does not apply to this project.	

L. ADDITIONAL LIGHTING ALLOWANCE: TAILORED WALL DISPLAY	
This section does not apply to this project.	

M. ADDITIONAL LIGHTING ALLOWANCE: TAILORED FLOOR AND TASK LIGHTING	
This section does not apply to this project.	

N. ADDITIONAL LIGHTING ALLOWANCE: TAILORED ORNAMENTAL/SPECIAL EFFECTS	
This section does not apply to this project.	

Registration Number:	Registration Date/Time:	Registration Provider: Energysoft
CA Building Energy Efficiency Standards - 2019 Nonresidential Compliance	Report Version: 2019.1.003 Schema Version: rev 20200601	Report Generated: 2022-06-13 17:15:09

STATE OF CALIFORNIA

Indoor Lighting

WECODE

CALIFORNIA ENERGY COMMISSION

CERTIFICATE OF COMPLIANCE

NRCC-17-E

This document is used to demonstrate compliance with requirements in §110.9, §110.12(c), §130.0, §130.1, §140.6 and §141.0(b)(2) for indoor lighting scopes using the prescriptive path.

Project Name: San Bernardino County Fire Department: Fire Station 228

Report Page: (Page 1 of 8)

Project Address: 1920 Del Rosa Ave N

Date Prepared: 4/13/2022

A. GENERAL INFORMATION

01 Project Location (city)	San Bernardino	04 Total Conditioned Floor Area (ft ²)	7,299
02 Climate Zone	10	05 Total Unconditioned Floor Area (ft ²)	490
03 Occupancy Types Within Project (select all that apply):		06 # of Stories (Habitable Above Grade)	1
<input type="checkbox"/> Office	<input type="checkbox"/> Retail	<input type="checkbox"/> Warehouse	<input type="checkbox"/> Hotel/Motel
<input type="checkbox"/> Parking Garage	<input type="checkbox"/> High-Rise Residential	<input type="checkbox"/> Relocatable	<input type="checkbox"/> Healthcare
		<input type="checkbox"/> School	<input type="checkbox"/> Support Areas
		<input type="checkbox"/> Other (Write in)	Assembly

B. PROJECT SCOPE

This table includes any lighting systems that are within the scope of the permit application and are demonstrating compliance using the prescriptive path outlined in §140.6 or §141.0(b)(2) for alterations.

Scope of Work	Conditioned Spaces		Unconditioned Spaces	
01	02	03	04	05
My Project Consists of (check all that apply):	Calculation Method	Area (ft ²)	Calculation Method	Area (ft ²)
<input checked="" type="checkbox"/> New Lighting System	Complete Building Method	7299	Complete Building Method	490
<input type="checkbox"/> New Lighting System - Parking Garage				
Total Area of Work (ft ²)	7299		490	

Registration Number:

Registration Date/Time:

Registration Provider: Energysoft

CA Building Energy Efficiency Standards - 2019 Nonresidential Compliance

Report Version: 2019.1.003

Schema Version: rev 20200601

Report Generated: 2022-06-13 17:15:09

STATE OF CALIFORNIA									
Indoor Lighting					CALIFORNIA ENERGY COMMISSION				
NRC-CLT-E									
CERTIFICATE OF COMPLIANCE					NRCCL-171-E				
Project Name: San Bernardino County Fire Department - Fire Station 226					Report Page: (Page 2 of 8)				
Project Address: 1920 Del Rosa Ave N					Date Prepared: 6/13/2022				

C. COMPLIANCE RESULTS													
If any cell on this table says "DOES NOT COMPLY" or "COMPLIES with Exceptional Conditions" refer to Table D, for guidance.													
Lighting in conditioned and unconditioned spaces must not be combined for compliance per §140.6(b)(1)	Allowed Lighting Power per §140.6(b) (Watts)					≥	Adjusted Lighting Power per §140.6(a) (Watts)			Compliance Results			
	01	02	03	04	05		06	07	08				
	Complete Building §140.6(c)(1) (See Table I)	Area Category §140.6(c)(2) (See Table II)	Area Category Additional §140.6(c)(2g) (+)	Tailored §140.6(c)(3) (*) (See Table K)	=		Total Designed Watts (See Table F)	Adjustments			Total Adjusted (Watts)* Includes Adjustments		
								PAF Lighting Control Credits §140.6(a)(2) (-)	=				
								Total Designated (Watts) (See Table P)	=				
Conditioned	5,109					=	5,109 ≥	4,140.9	0	=	4140.9	05 must be >= 08 §140.6	COMPLIES
Unconditioned	343					=	343 ≥	185	0	=	185		COMPLIES
Controls Compliance (See Table H for Details)													
Rated Power Reduction Compliance (See Table Q for Details)													

D. EXCEPTIONAL CONDITIONS									
This table is auto-filled with uneditable comments because of selections made or data entered in tables throughout the form.									

E. ADDITIONAL REMARKS									
This table includes remarks made by the permit applicant to the Authority Having Jurisdiction.									

F. INDOOR LIGHTING FIXTURE SCHEDULE									
This table includes all permanent designed lighting and all portable lighting allowed.									
Designed Wattage: Conditioned Spaces									
01	02	03	04	05	06	07	08	09	10
Name or Item Tag	Complete Luminaire Description	Modular (Track) Fixture	Small Aperture & Color Change†	Watts per luminaire²	How is Wattage determined	Total Number of Luminaires	Excluded per §140.6(a)(3)	Design Watts	Field Inspector
F15	21w 6" Diameter LED Shower Light	No	No	21	Mfr. Spec	5	No	0	Pass Fail

Registration Number:	Registration Date/Time:	Registration Provider: Energysoft
----------------------	-------------------------	-----------------------------------

CA Building Energy Efficiency Standards - 2019 Nonresidential Compliance	Report Version: 2019.1.003 Schema Version: rev 20200601	Report Generated: 2022-06-13 17:15:09
--	--	---------------------------------------

STATE OF CALIFORNIA										
Indoor Lighting										
CALIFORNIA ENERGY COMMISSION										
<div style="display: flex; justify-content: space-between;"> NRCC-114 NRCC-114-E </div>										
<div style="display: flex; justify-content: space-between;"> Project Name: San Bernardino County Fire Department: Fire Station 226 Report Page: (Page 3 of 8) </div>										
<div style="display: flex; justify-content: space-between;"> Project Address: 1920 Del Rosa Ave N Date Prepared: 6/13/2022 </div>										
F. INDOOR LIGHTING FIXTURE SCHEDULE										
F17	2.5w LED Reading Light	No	No	2.5	Mfr. Spec	8	No	20	<input type="checkbox"/>	<input type="checkbox"/>
F18/F18E	27.9w 2 X 2 LED Troffer	No	No	27.9	Mfr. Spec	22	No	613.8	<input type="checkbox"/>	<input type="checkbox"/>
F19	38w 48" LED Vapor Tight Light	No	No	38	Mfr. Spec	5	No	190	<input type="checkbox"/>	<input type="checkbox"/>
F2	48" LED Strip Light	No	No	42	Mfr. Spec	8	No	336	<input type="checkbox"/>	<input type="checkbox"/>
F20/F20E	130w 96" LED Vapor Tight Light	No	No	130	Mfr. Spec	15	No	1,950	<input type="checkbox"/>	<input type="checkbox"/>
F21	50w Metal Halide	No	No	58	CEC Default	0	No	0	<input type="checkbox"/>	<input type="checkbox"/>
F24/F24E	27.9w 2 X 4 LED Troffer	No	No	27.9	Mfr. Spec	9	No	251.1	<input type="checkbox"/>	<input type="checkbox"/>
F5	20" 10w LED Linear Under Cabinet	No	No	10	Mfr. Spec	10	No	100	<input type="checkbox"/>	<input type="checkbox"/>
F6	17w 6" Diameter LED Down Light	No	No	17	Mfr. Spec	22	No	374	<input type="checkbox"/>	<input type="checkbox"/>
F6/F6E	17w 6" Diameter LED Down Light	No	No	17	Mfr. Spec	10	No	170	<input type="checkbox"/>	<input type="checkbox"/>
F6	17w 6" Diameter LED Down Light	No	No	17	Mfr. Spec	8	No	136	<input type="checkbox"/>	<input type="checkbox"/>
Total Designed Watts: CONDITIONED SPACES								4,140.9		
Designed Wattage: Unconditioned Spaces										
01	02	03	04	05	06	07	08	09	10	
Name or Item Tag	Complete Luminaire Description	Modular (Track) Fixture	Small Aperture & Color Change ¹	Watts per luminaire ²	How is Wattage determined	Total Number of Luminaires	Excluded per §190.6(a)(3)	Design Watts	Field Inspector Pass Fail	
F2	48" LED Strip Light	No	No	42	Mfr. Spec	4	No	168	<input type="checkbox"/>	<input type="checkbox"/>
F6	17w 6" Diameter LED Down Light	No	No	17	Mfr. Spec	1	No	17	<input type="checkbox"/>	<input type="checkbox"/>
Total Designed Watts: UNCONDITIONED SPACES								185		

¹FOOTNOTE: Design Watts for small aperture and color changing luminaires which qualify per §190.6(a)(3) is adjusted to be 75% of their rated wattage. Table F automatically makes this adjustment, the permit applicant should enter full rated wattage in column 05.

Registration Number:


CA Building Energy Efficiency Standards - 2019 Nonresidential Compliance

Registration Date/Time:

Schema Version: 2019.1.003
Report Number: rev 20200601

Registration Provider: Energysoft

Report Generated: 2022-06-13 17:15:09

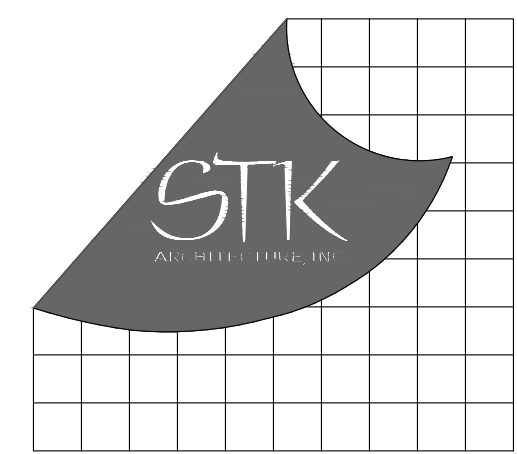

CONSULTANT:



ED ES SS NP

PROJECT ADMINISTERED BY:
SAN BERNARDINO COUNTY
PROJECT & FACILITIES
MANAGEMENT DEPARTMENT

385 N. ARROWHEAD AVE.
SAN BERNARDINO, CA 92415

PROJECT NAME:
SAN BERNARDINO
COUNTY FIRE
DEPARTMENT:
FIRE STATION 226

PROJECT # 10.10.1032

CIP #21-037

CAFM # SABI98

APN #: 0273-011-22

1920 DEL ROSA AVE N.
SAN BERNARDINO,
CA 92404

ISSUE INFORMATION:	
DATE:	INFORMATION:
04-11-2022	20% CD SET
04-28-2022	50% CD SET
06-15-2022	95% CD SET
09-16-2022	95% CD- 3rd BA
10-03-2022	PLAN CHECK

SHEET INFORMATION

STK PROJECT NO.: 374-154-7
SCALE: AS NOTED
DATE: JANUARY 2001
PLOT DATE: -
DRAWING NAME:

SEAL:




SHEET TITLE

INTERIOR
TITLE 24

SHEET NO.

E0.4

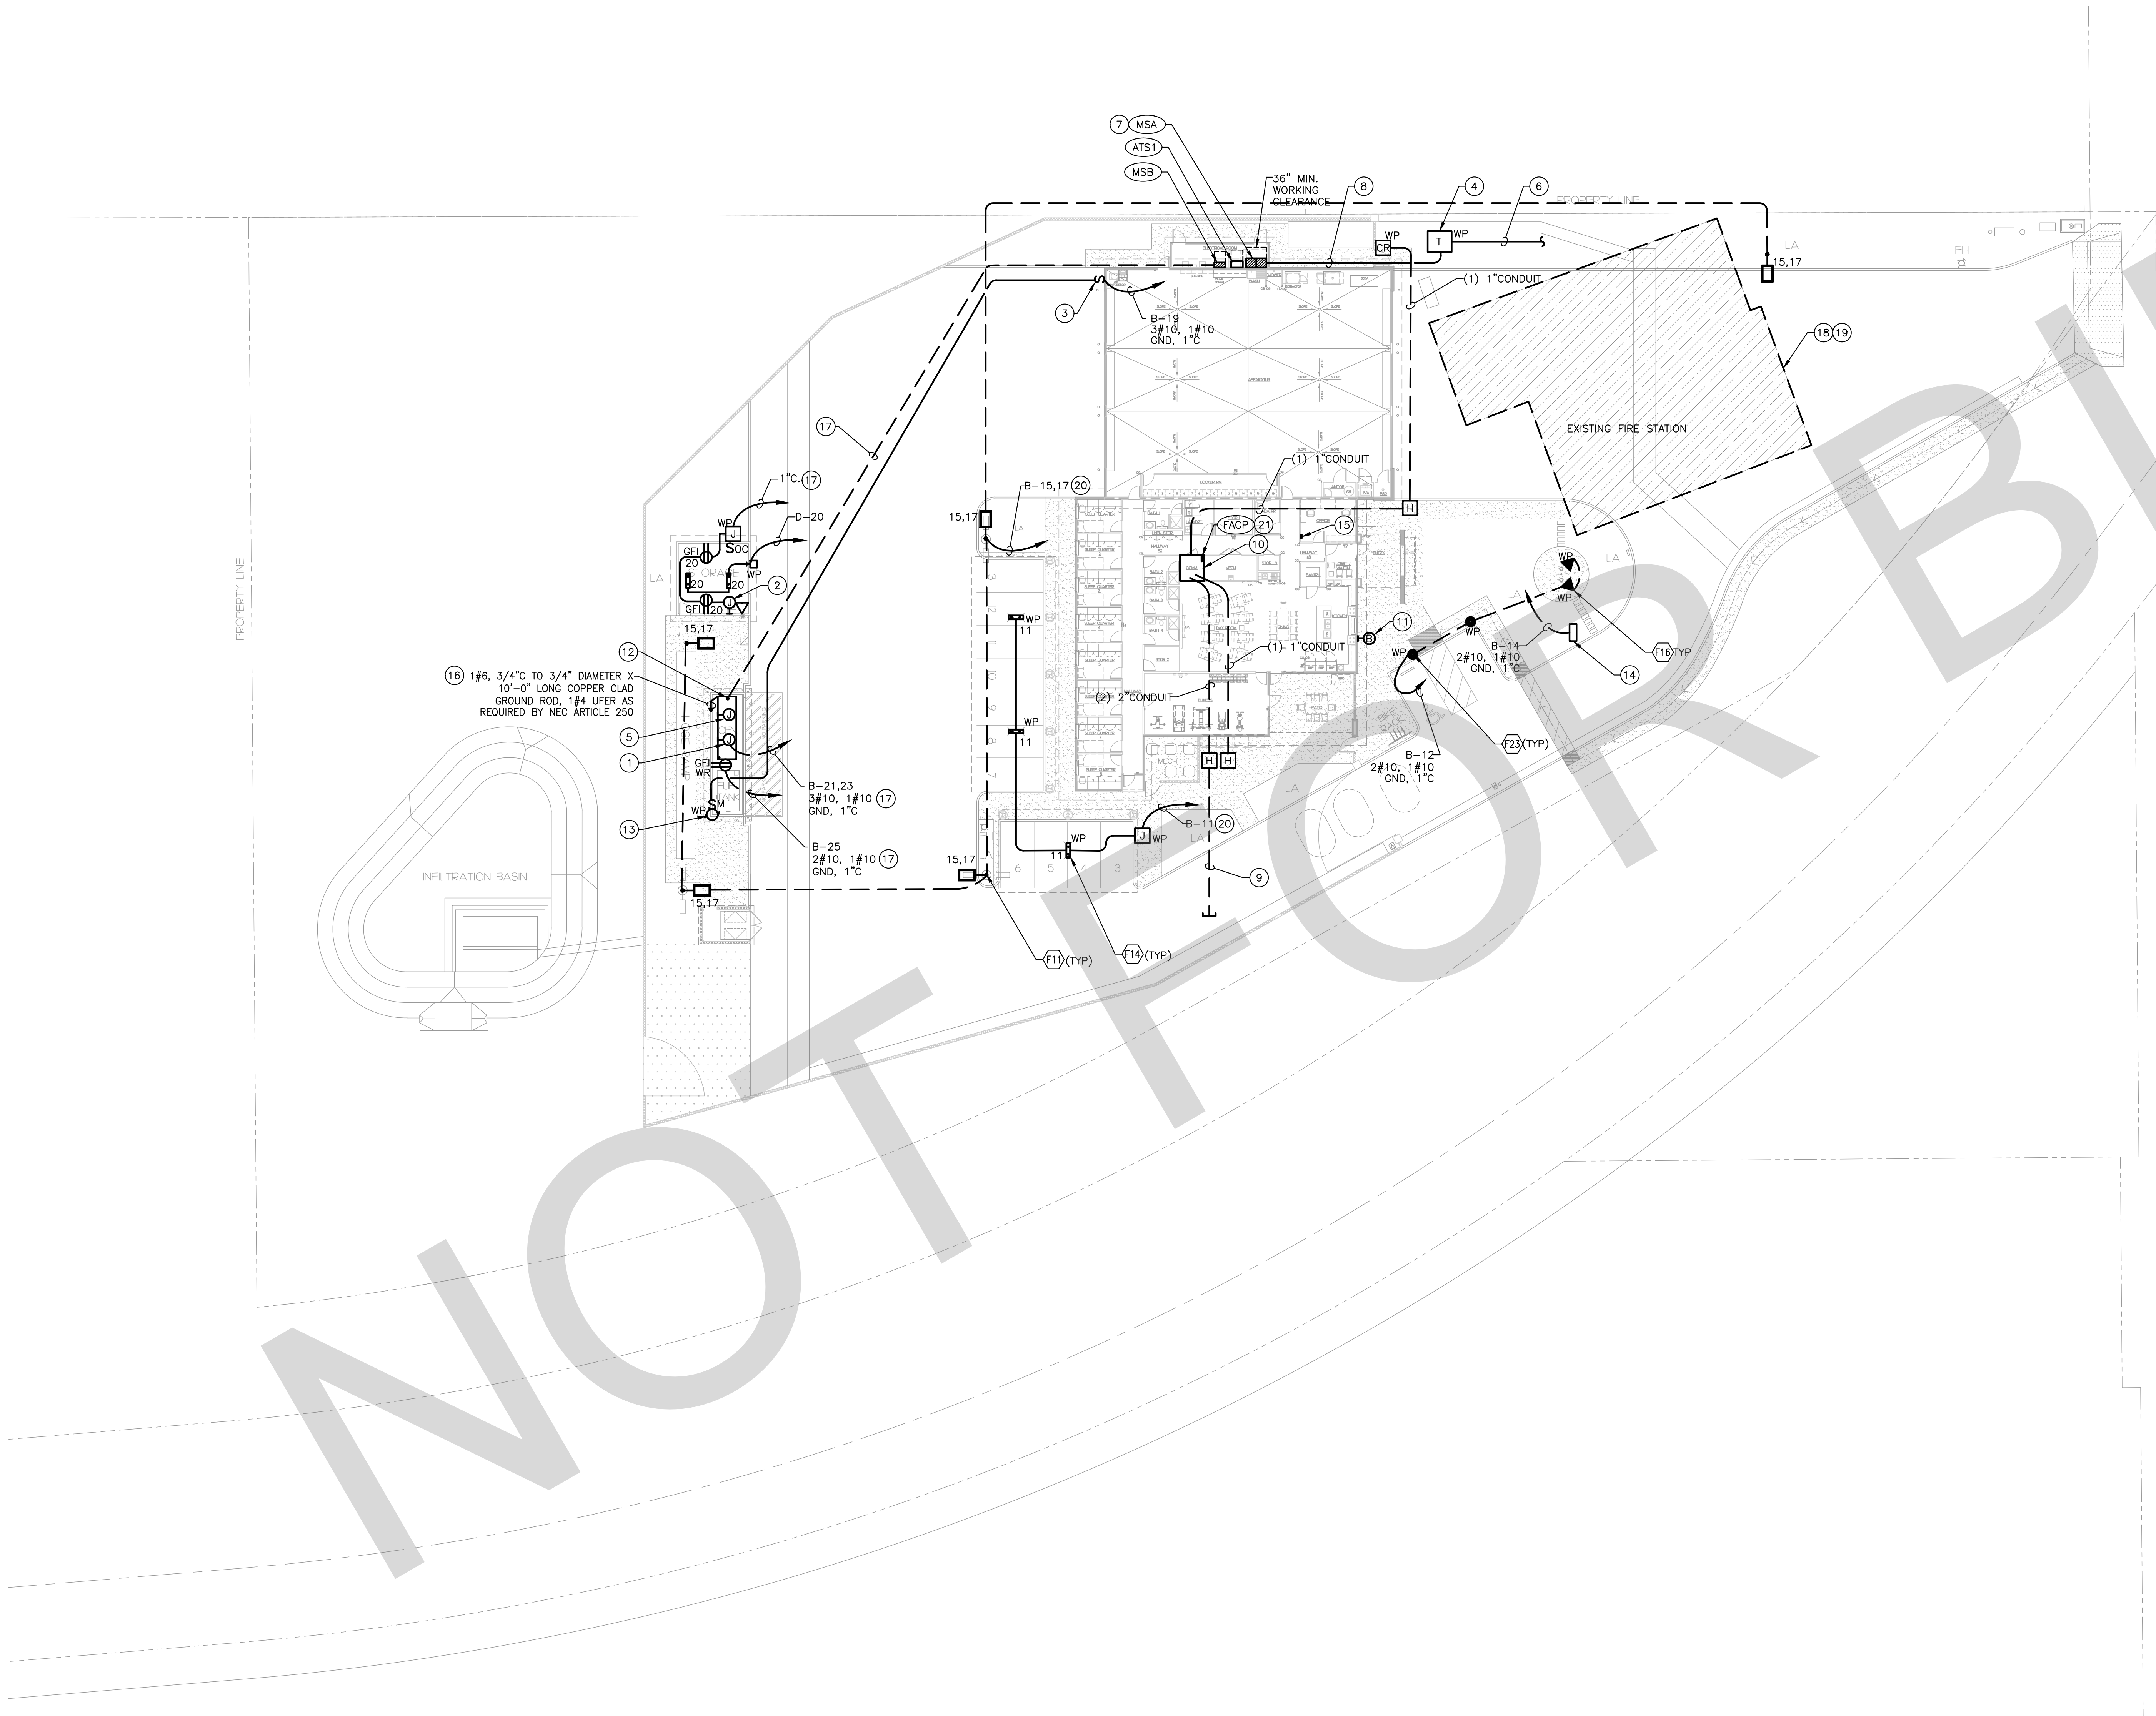


GENERAL NOTES

- A. CONDUITS TO BE MINIMUM 24" BELOW GRADE.
- B. UTILITY SERVICES TO BE MINIMUM 36" BELOW GRADE TO TOP OF CONDUITS. COORDINATE WITH MECHANICAL, CIVIL, LANDSCAPE AND IRRIGATION SITE DRAWINGS, PRIOR TO START OF WORK.
- C. PROVIDE PULL WIRES IN ALL EMPTY CONDUITS AS REQUIRED BY UTILITIES SERVICE.
- D. UTILITY PAD TO BE FURNISHED PER SERVING UTILITY COMPANY STANDARDS. PROVIDE EASILY IDENTIFIABLE MARKERS AT ALL CONDUIT STUBS.
- E. CONSTRUCTION AND INSPECTION WILL BE PER UTILITY-ISSUED DRAWINGS AND SPECIFICATIONS.
- F. REFER TO ARCHITECTURAL UTILITY SITE PLAN A1.1 FOR ELECTRICAL, TELEPHONE AND CATV CONDUIT REQUIREMENTS AND INSTALLATION POINTS TO BE INCLUDED IN BID.
- G. ALL OUTLETS (INCLUDING OUTSIDE) NEAR POSSIBLE WATER SOURCE SHALL BE GFI TYPE.
- H. UNLESS SWITCH IS SHOWN, ALL EXTERIOR LIGHTS SHALL BE CONTROLLED BY LIGHTING CONTROL PANEL.
- I. PROVIDE ALL UNDERGROUND CONDUIT REQUIRED AS PART OF THE BASE BID.
- J. ALL EQUIPMENT LOCATED OUTSIDE SHALL BE RATED AS SUCH.
- K. CONTRACTOR SHALL FIELD VERIFY EXISTING CONDITIONS AND COORDINATE WITH ALL OTHER TRADES. IN CASE OF DISCREPANCIES OR POTENTIAL CONFLICTS, INFORM ARCHITECT AND ENGINEER IN WRITING PRIOR TO START OF WORK.
- L. EXTERIOR LIGHT POLLUTION SHALL COMPLY WITH CGC SECTION 5.106.8.

KEY NOTES

- 1. CONNECT TO GENERATOR JACKET WATER HEATER. COORDINATE WIRING REQUIREMENTS AND LOCATION WITH GENERATOR PROVIDER/INSTALLER PRIOR TO START OF WORK.
- 2. JUNCTION BOX FOR IRRIGATION CONTROLLER. COORDINATE LOCATION WITH LANDSCAPE CONTRACTOR PRIOR TO START OF WORK.
- 3. PROVIDE 2-POLE, PUSHBUTTON WITH RED MUSHROOM HEAD SWITCHES IN "FS" BOX AND WEATHER PROOF COVER FLUSH IN WALL AT +54" TO CENTER LINE. SWITCHES TO DISCONNECT BOTH HOT AND NEUTRAL CONDUCTORS. PROVIDE RED 6" X 12" MICARTA SIGN WITH 1-1/2" H X 1/4" STROKE LETTERS ENGRAVED: "EMERGENCY FUEL PUMP "A" SHUT OFF" AND "EMERGENCY FUEL PUMP "B" SHUT OFF". PROVIDE 3" H X 1/2" STROKE LETTERS (RED LETTERS ON WHITE BACKGROUND). "NO SMOKING" SIGN ON EACH SIDE OF ABOVE GROUND FUEL TANKS. PROVIDE EYS FITTING IN CONDUIT GOING TO PUSHBUTTON AND 12" X 16" PULL BOX.
- 4. PROPOSED LOCATION OF UTILITY TRANSFORMER. VERIFY EXACT LOCATION WITH UTILITY COMPANY PRIOR TO START OF WORK.
- 5. CONNECT TO GENERATOR BATTERY CHARGER. COORDINATE WIRING REQUIREMENTS AND LOCATION WITH GENERATOR PROVIDER/INSTALLER PRIOR TO START OF WORK.
- 6. UTILITY COMPANY PRIMARY FEEDER. COORDINATE REQUIREMENTS WITH UTILITY PLANNER.
- 7. PROVIDE 600 AMP, 208Y/120 VOLT, 3 PHASE, 4 WIRE, METER MAIN SWITCHBOARD "MS". SEE SINGLE LINE DIAGRAM ON SHEET E4.1 FOR MORE INFORMATION.
- 8. PROVIDE TWO (2) 4" CONDUIT TO UTILITY TRANSFORMER. COORDINATE WITH UTILITY COMPANY FOR EXACT LOCATION AND REQUIREMENTS. PRIOR TO START OF WORK.
- 9. PROVIDE TWO (2) 2" SCHEDULE 40 PVC CONDUIT, ONE FOR CATV AND ONE FOR TELEPHONE WITH 3/8" PULL ROPE. COORDINATE WITH CATV AND TELCO UTILITY FOR EXACT LOCATION AND REQUIREMENTS PRIOR TO START OF WORK. CONDUITS SHALL BE BURIED A MINIMUM OF 36" BELOW FINISHED GRADE.
- 10. PROVIDE 3/4" X 8'-0" HIGH X 6'-0" WIDE FIRE RATED PLYWOOD BACKBOARD WITH 1#6 COPPER GROUNDING CONDUCTOR BOND TO MAIN SWITCHBOARD GROUND ELECTRODE SYSTEM.
- 11. PROVIDE 2#12, 1#12 GROUND IN 3/4" CONDUIT TO FLOW SWITCH, PIV AND CONNECT TO SPRINKLER BELLS. COORDINATE WITH SPRINKLER SYSTEM FOR EXACT LOCATION AND REQUIREMENTS.
- 12. GENERATOR PROVIDED BY CONTRACTOR. SEE SINGLE LINE DIAGRAM FOR MORE INFORMATION.
- 13. PROVIDE CONNECTION TO 1/4 HP 120 VOLT PUMP/TANK PACKAGE UNIT. COORDINATE WITH MANUFACTURER FOR EXACT REQUIREMENTS PRIOR TO START OF WORK.
- 14. IRRIGATION CONTROLLER, COORDINATE EXACT LOCATION AND REQUIREMENTS WITH SUPPLIER/INSTALLER PRIOR TO START OF WORK.
- 15. PROVIDE GENERATOR REMOTE ANNUNCIATOR PANEL IN LOBBY ABOVE COUNTER WITH 1" CONDUIT TO GENERATOR CONTROLS LOCATION, COORDINATE ALL REQUIREMENTS WITH GENERATOR SUPPLIER/INSTALLER PRIOR TO START OF WORK.
- 16. PROVIDE GROUNDING ELECTRODE SYSTEM TO METALLIC BUILDING STRUCTURE AS REQUIRED BY NEC ARTICLE 250.
- 17. PROVIDE 1#10 BOND TO METALLIC BUILDING GROUNDING ELECTRODE SYSTEM AS REQUIRED BY NEC ARTICLE 250.
- 18. THE EXISTING FIRE STATION BUILDING SHALL REMAIN FULLY FUNCTIONAL AND OCCUPIED DURING THE DURATION OF THE CONSTRUCTION OF THE NEW FIRE STATION. THE GENERAL CONTRACTOR SHALL PROVIDE ANY TEMPORARY UTILITIES THAT MAY BE REQUIRED FOR EITHER OR BOTH BUILDINGS TO REMAIN OPERATIONAL. THIS SHALL BE INCLUDED IN THE CONTRACTORS BID AND SHALL NOT INCUR ADDITIONAL COST TO THE OWNER. EXISTING FIRE STATION TO BE REMAIN AND IN OPERATIONAL. ALL UTILITIES CONNECTED TO EXISTING SHALL PROTECT IN PLACE DURING CONSTRUCTION OF THE PROJECT DURING PHASE 1.
- 19. DISCONNECT AND REMOVE ALL EXISTING UTILITIES (POWER, PHONE, DATA, ETC.) BACK TO ITS ORIGINAL SOURCE ONCE THE NEW FIRE STATION IS COMPLETED DURING PHASE 2 OF THE CONSTRUCTION. ALL DEMOLITION OF THE EXISTING BUILDING DURING PHASE 2 OF THE PROJECT SHALL BE IN THE CONTRACTOR'S BID PROPOSAL FOR BOTH PHASES AND SHALL NOT INCUR ADDITIONAL COST TO THE OWNER.
- 20. ROUTE LIGHTING CIRCUIT THRU LIGHTING CONTROL PANEL "LCP".
- 21. COORDINATE EXACT LOCATION WITH FIRE ALARM CONTRACTOR.

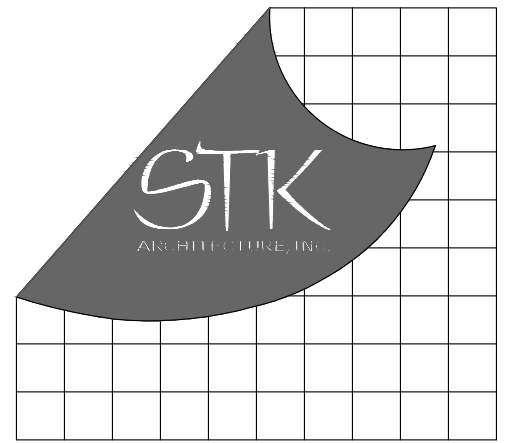

4205 ZEVOS DR., TEMECULA, CALIFORNIA 92590-3761
Phone: 951.296.8110 Fax: 951.296.6079 Email: sk@stk.com

CONSULTANT



3220 EXECUTIVE RIDGE
SUITE 210
VISTA, CA 92081
TEL: (760) 560-0100
#21189
www.salasobrien.com
E-Mail: admin@stgeng.com

PROJECT ADMINISTERED BY:
SAN BERNARDINO COUNTY
PROJECT & FACILITIES
MANAGEMENT DEPARTMENT

385 N. ARROWHEAD AVE.
SAN BERNARDINO, CA 92415

PROJECT NAME:
SAN BERNARDINO
COUNTY FIRE
DEPARTMENT:
FIRE STATION 226

PROJECT # 10J0J032

CIP #21-037

CAFM # SAB198

APN # 0273-011-22

1920 DEL ROSA AVE N.
SAN BERNARDINO,
CA 92404


ISSUE INFORMATION:

DATE:	INFORMATION:
04-11-2022	20% CD SET
04-28-2022	50% CD SET
06-15-2022	95% CD SET
09-16-2022	95% CD- 3rd BAY
10-03-2022	PLAN CHECK

SHEET INFORMATION:

STK PROJECT NO.: 374-154-21
SCALE: AS NOTED
DATE: JANUARY 2021
PLOT DATE:
DRAWING NAME:

SEAL:

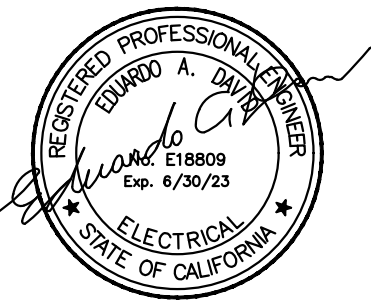

SHEET TITLE:



ELECTRICAL
SITE PLAN


SHEET NO.:

E1.1

ELECTRICAL SITE PLAN

1" = 20'-0"

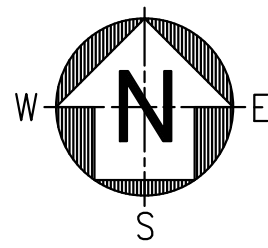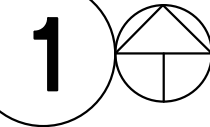

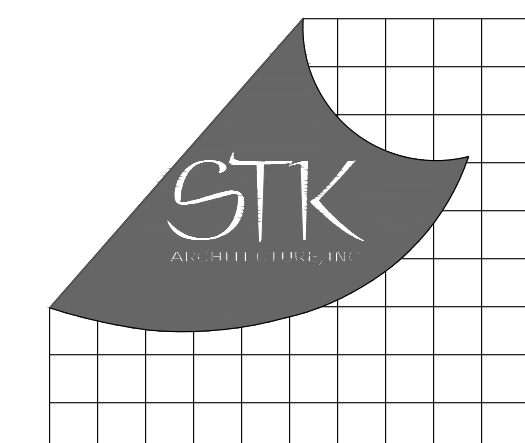

4205 ZEVOR DR., TEMECULA, CALIFORNIA 92590-3760
Phone: 951.296.8110 Fax: 951.296.6079 Email: sk@stk.com

CONSULTANT:



#21189
www.salasobrien.com
E-Mail: admin@stgeng.com

PROJECT ADMINISTERED BY:
SAN BERNARDINO COUNTY
PROJECT & FACILITIES
MANAGEMENT DEPARTMENT

385 N. ARROWHEAD AVE.
SAN BERNARDINO, CA 92415

PROJECT NAME:
SAN BERNARDINO
COUNTY FIRE
DEPARTMENT:
FIRE STATION 226


PROJECT # 10J0J032
CIP #21-037
CAFM # SAB198
APN # 0273-011-22

1920 DEL ROSA AVE N.
SAN BERNARDINO,
CA 92404

ISSUE INFORMATION:	
DATE:	INFORMATION:
04-11-2022	20% CD SET
04-28-2022	50% CD SET
06-15-2022	95% CD SET
09-16-2022	95% CD- 3rd BAY
10-03-2022	PLAN CHECK

SHEET INFORMATION:
STK PROJECT NO.: 374-154-21
SCALE: AS NOTED
DATE: JANUARY 2021
PLOT DATE:
DRAWING NAME:

SEAL:

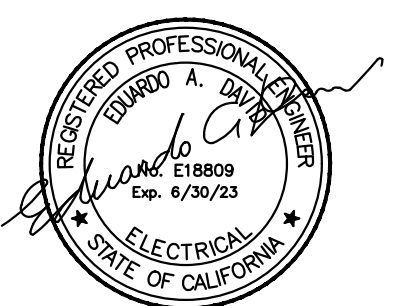


SHEET TITLE:

ELECTRICAL
SITE PLAN
PHOTOMETRIC



SHEET NO.:

E1.1ph

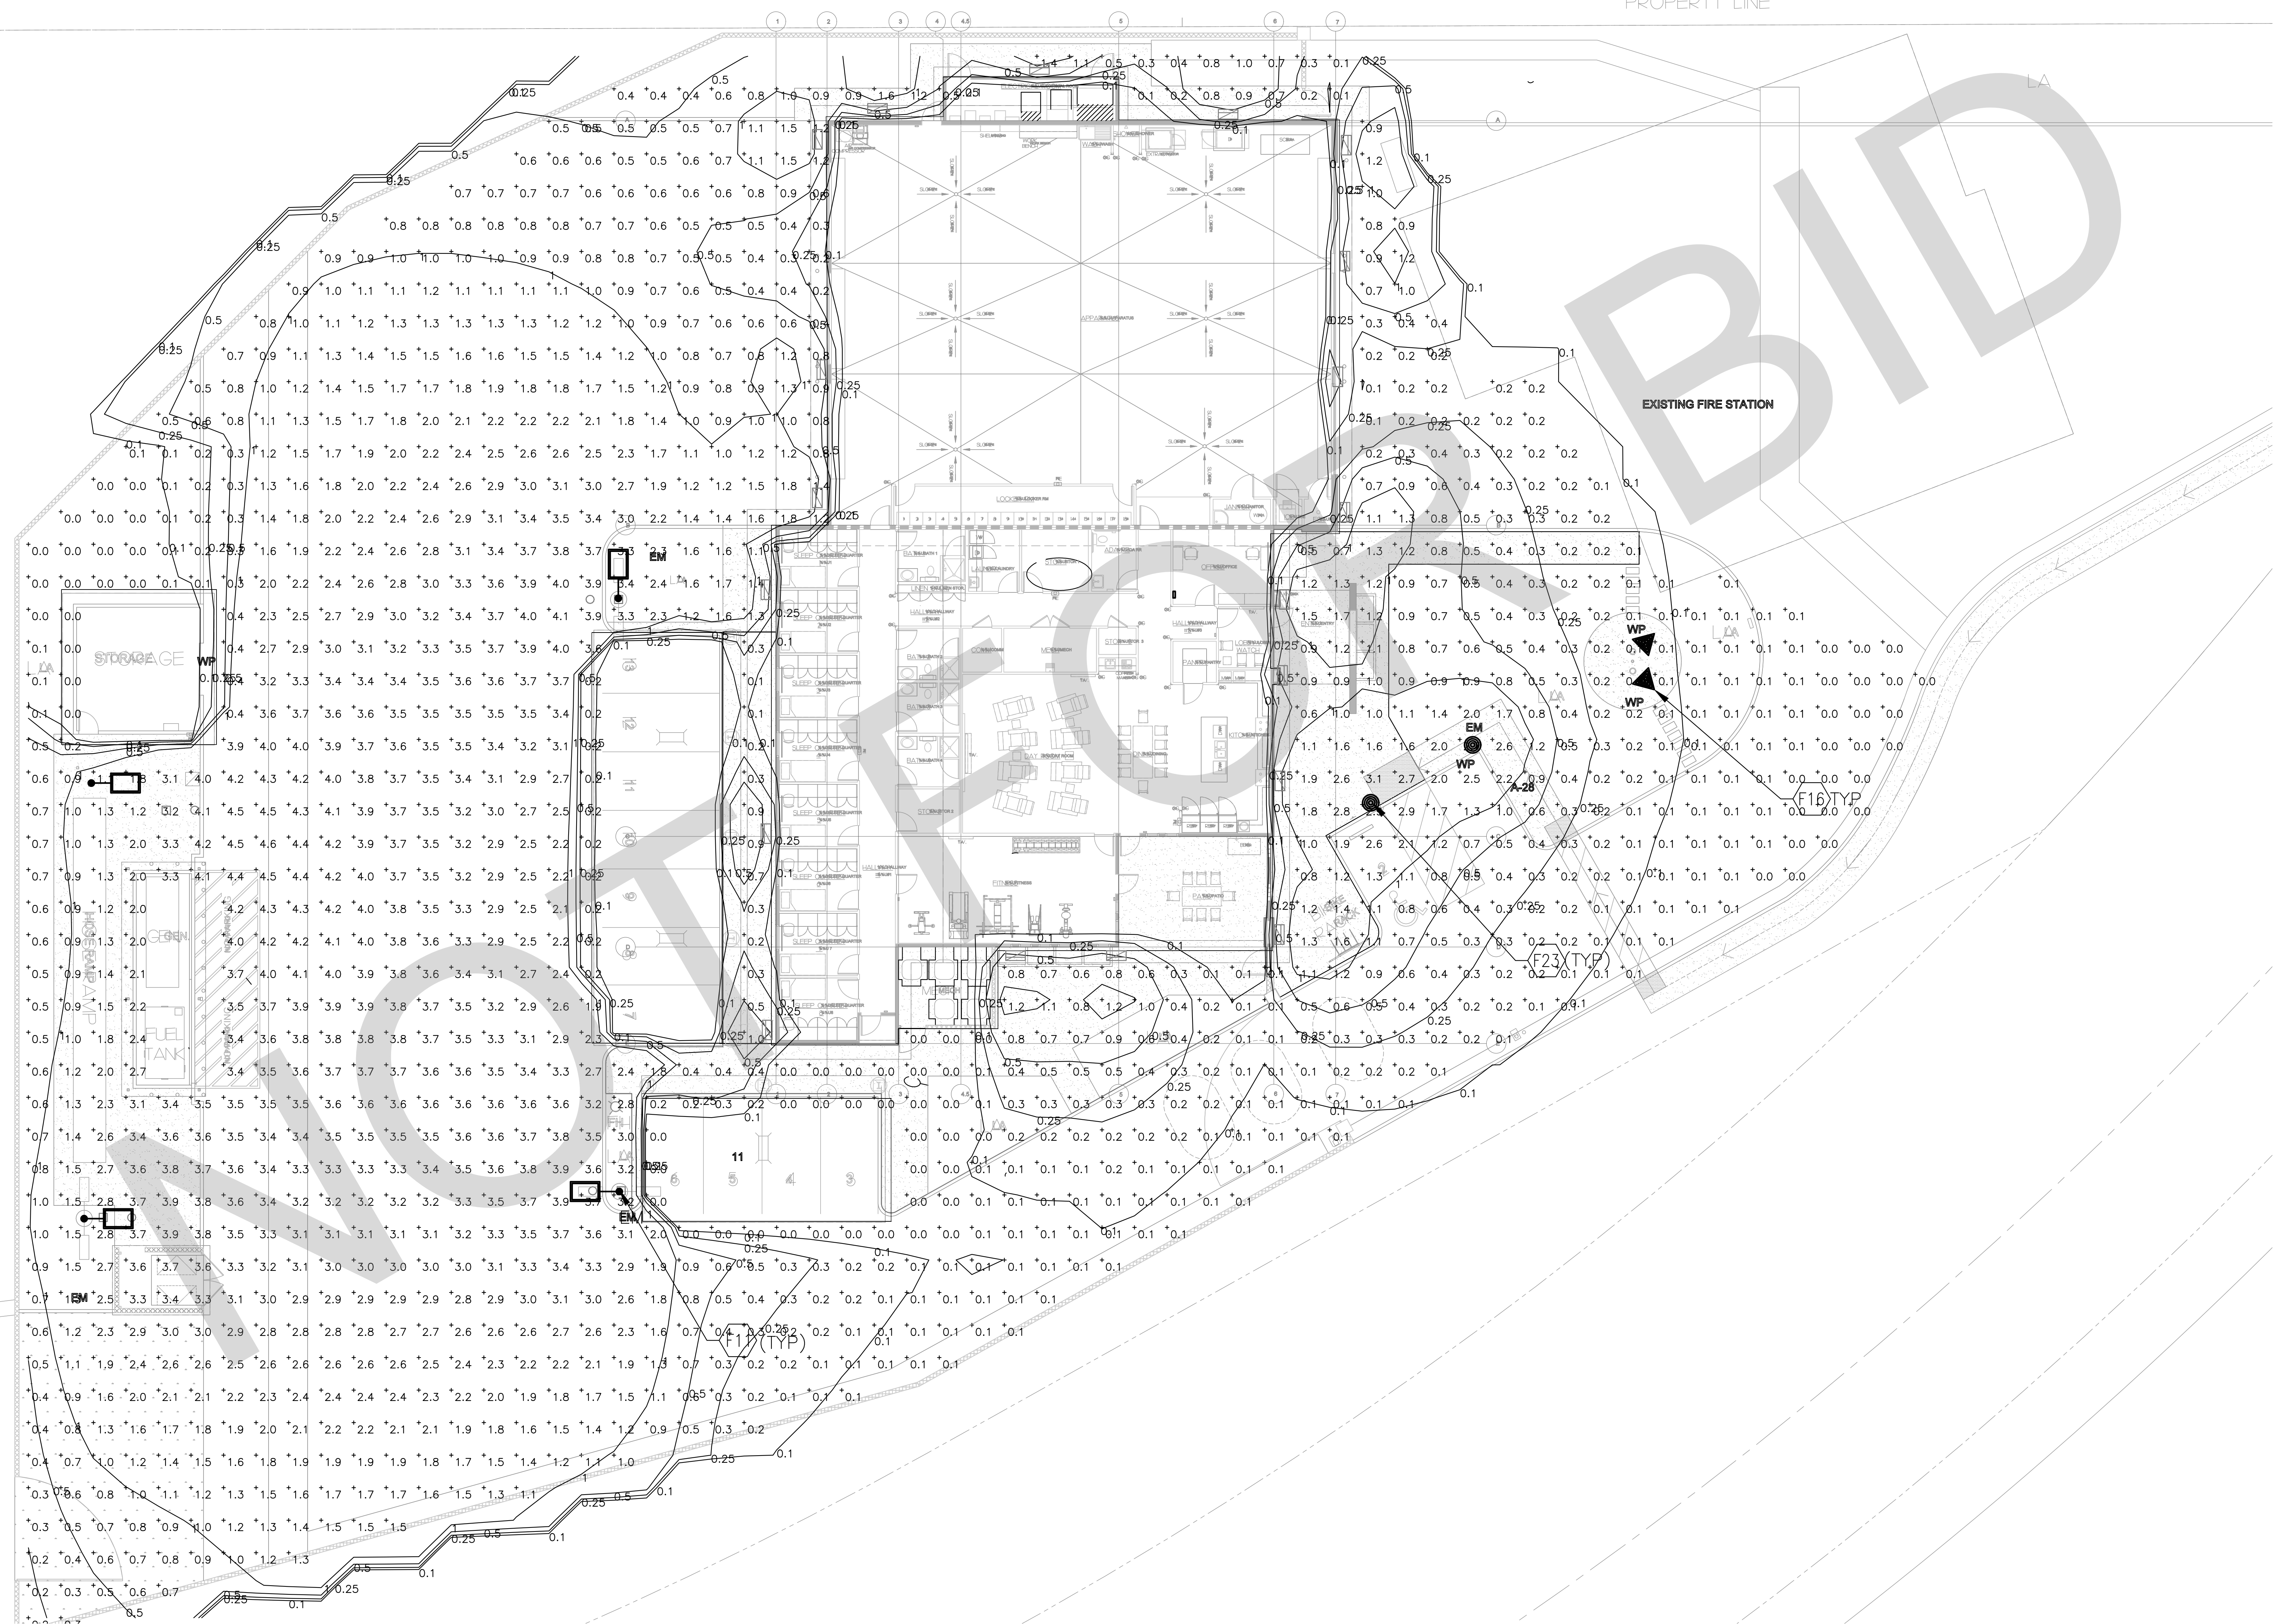


ELECTRICAL SITE PLAN - PHOTOMETRIC

3/32" = 1'-0"

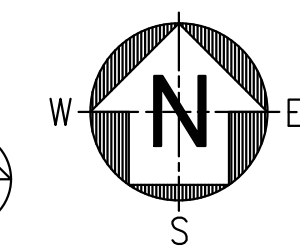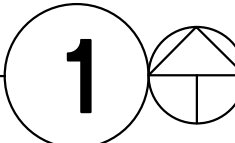

Statistics						
Description	Symbol	Avg	Max	Min	Max/Min	Avg/Min
Calc Zone #1	+	1.5 fc	4.6 fc	0.0 fc	N/A	N/A


05/26/2022 1:38AM T:_2021\21189 San Bernardino County F-226\21189_E2.1.dwg

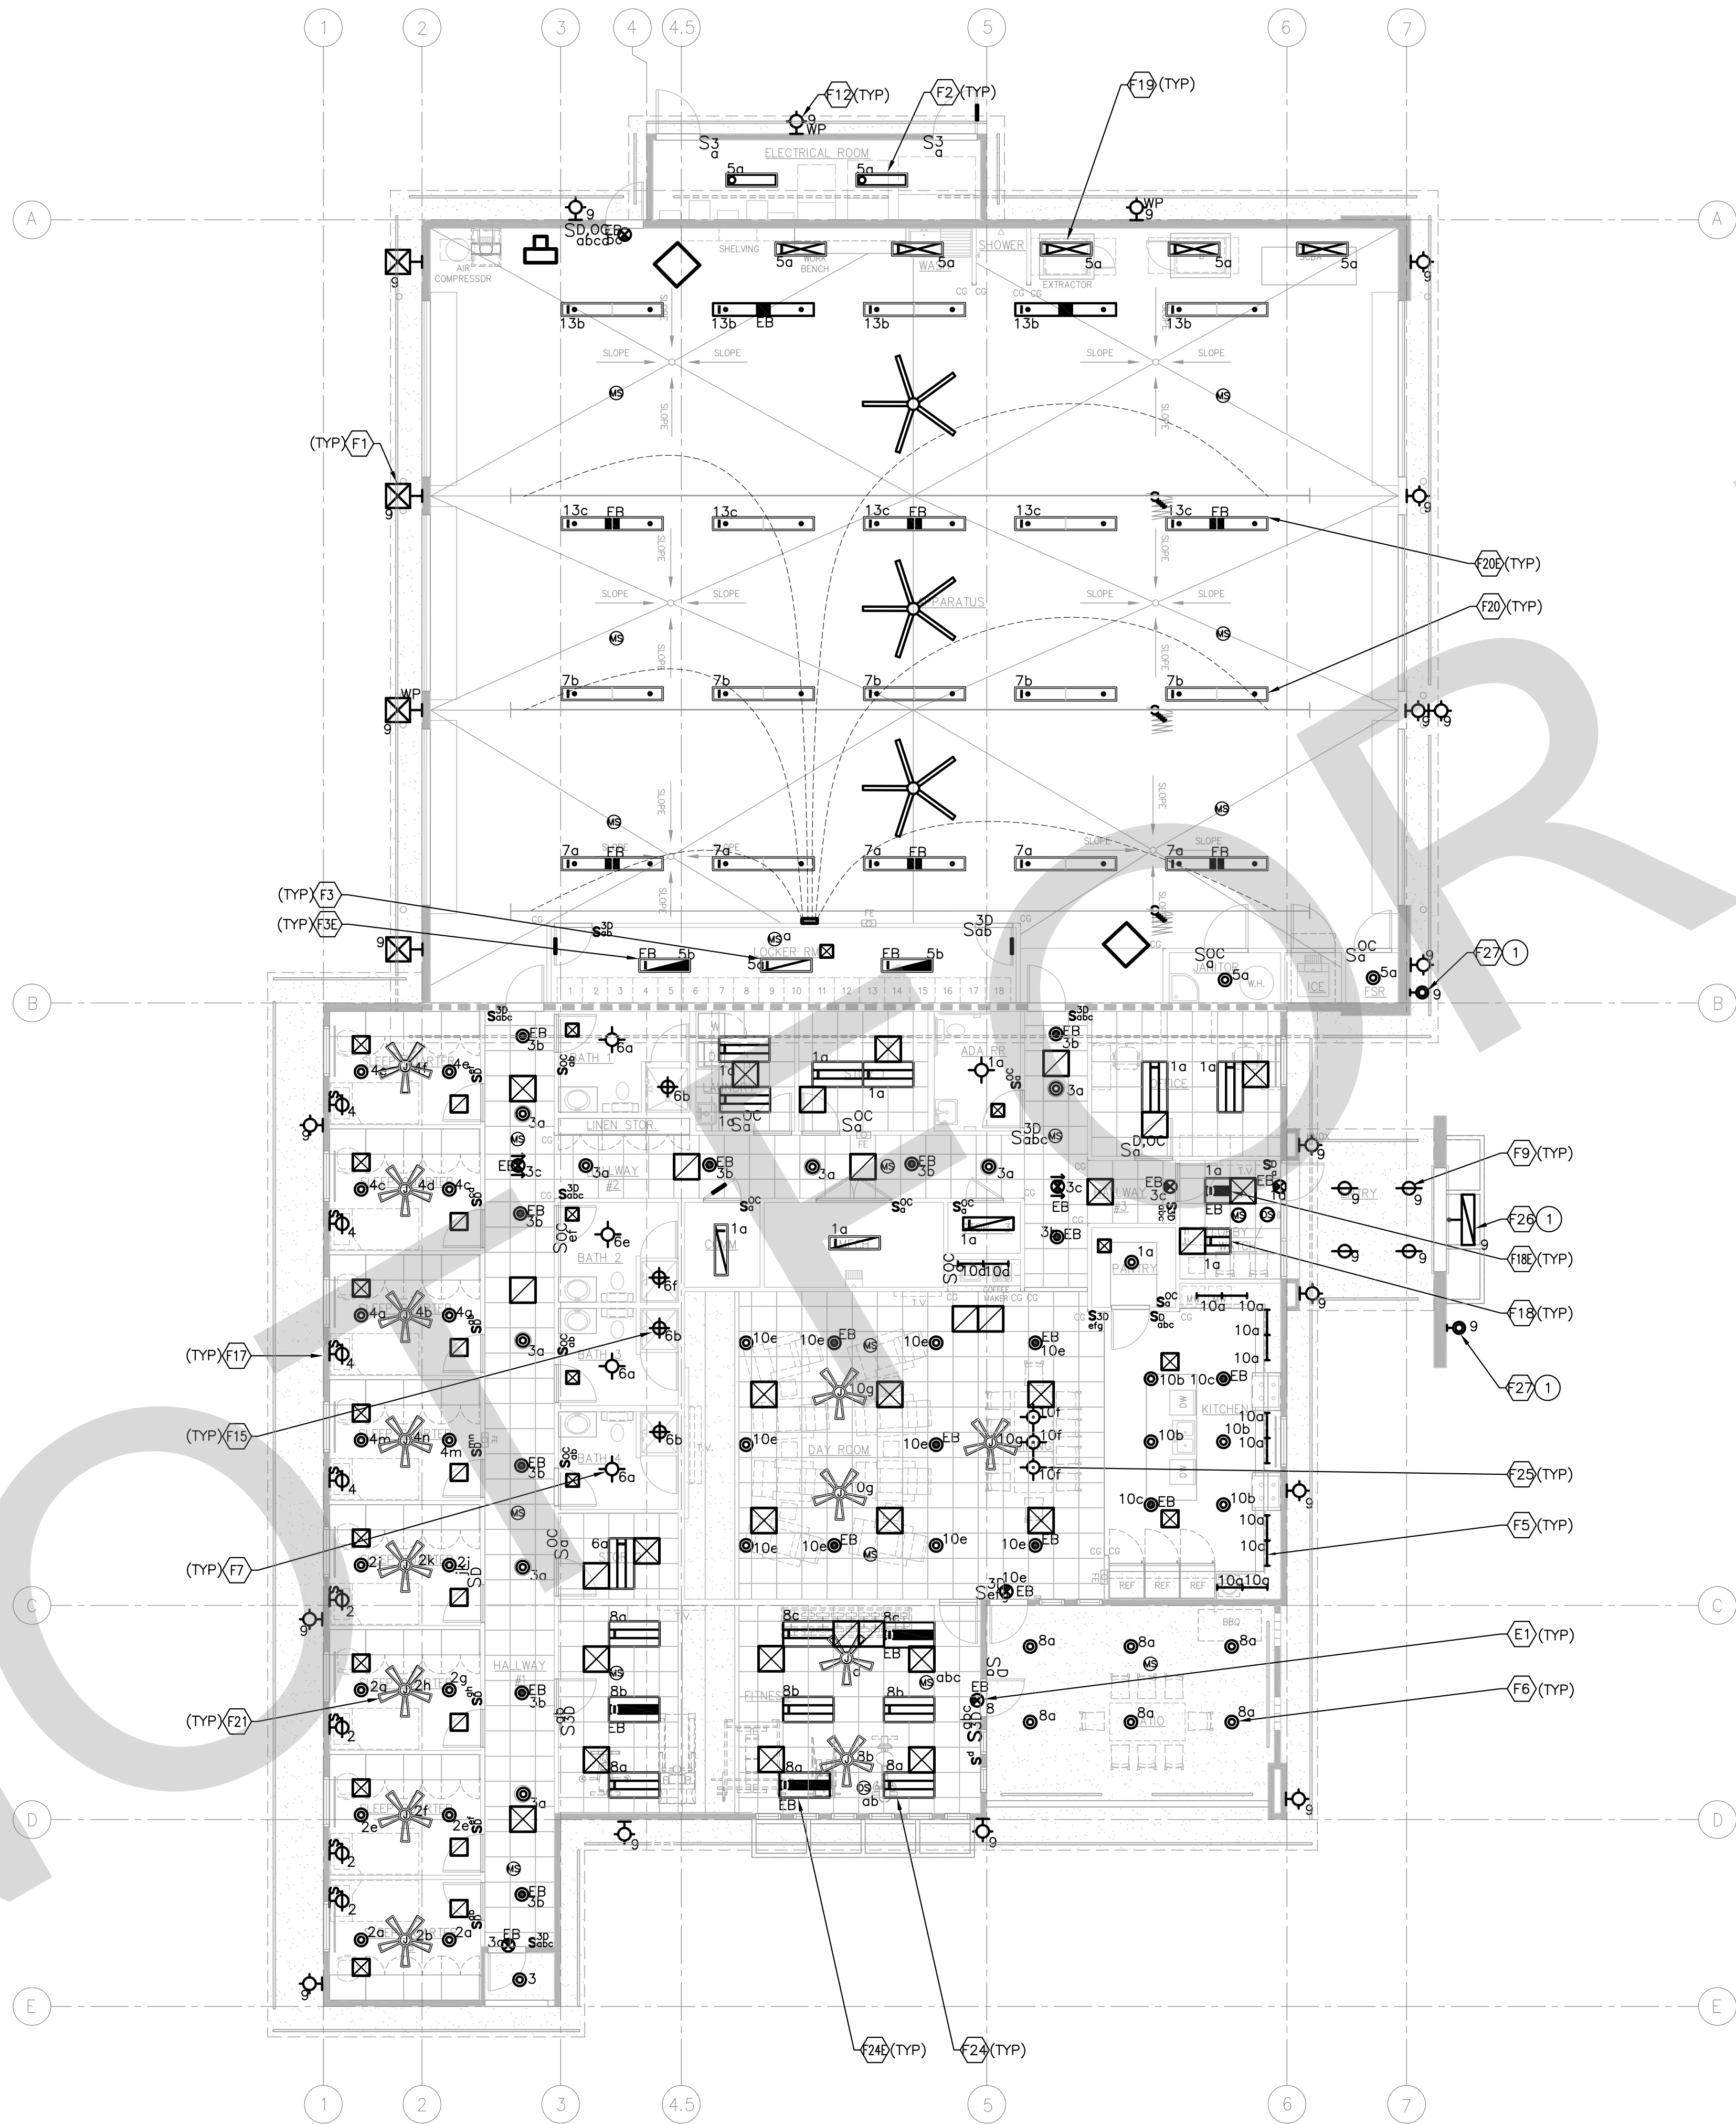

LIGHTING FLOOR PLAN

1/8" = 1'-0"

1

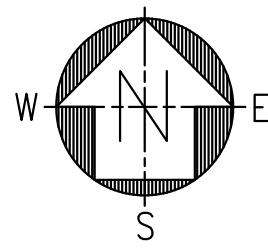


GENERAL NOTES

- CONTRACTOR SHALL FIELD VERIFY EXISTING CONDITIONS AND COORDINATE WITH ALL OTHER TRADES. IN CASE OF DISCREPANCIES OR ANY POTENTIAL CONFLICTS, INFORM THE ARCHITECT AND ENGINEER IN WRITING PRIOR TO START OF WORK.
- CONTRACTOR SHALL VERIFY EXACT QUANTITIES, LOCATIONS AND HEIGHTS OF ALL FIXTURES WITH TENANT AND ARCHITECT PRIOR TO START OF WORK.
- ALL LIGHTING TO BE CONNECTED TO PANEL 'B', CIRCUIT NUMBER(S) AS SHOWN.
- ALL FIXTURES PROVIDED WITH EGRESS LIGHTING BATTERY PACK BACK-UP SHALL BE FED FROM UNSWITCHED CIRCUIT SERVING LIGHTING IN SAME AREA PER NEC ARTICLE 700.12(F). EMERGENCY BATTERY PACK SHALL BE ACTIVATED ONLY UPON NORMAL POWER FAILURE.

KEY NOTES

- SIGNAGE LIGHT, MOUNT ABOVE SIGNAGE. COORDINATE WITH ARCHITECT PLANS FOR EXACT LOCATION OF THE SIGNAGE AND MOUNTING HEIGHT. ROUTE EXTERIOR THRU LIGHTING CONTROL PANEL.

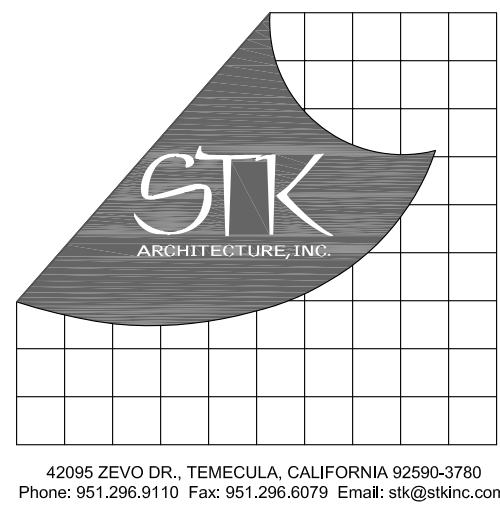

CONSULTANT:



PROJECT ADMINISTERED BY:
SAN BERNARDINO COUNTY
PROJECT & FACILITIES
MANAGEMENT DEPARTMENT

385 N. ARROWHEAD AVE.
SAN BERNARDINO, CA 92415

PROJECT NAME:
SAN BERNARDINO
COUNTY FIRE
DEPARTMENT:
FIRE STATION 226

PROJECT # 10.10.1032
CIP #21-037
CAFM # SAB198
APN # 0273-011-22

1920 DEL ROSA AVE N.
SAN BERNARDINO,
CA 92404

ISSUE INFORMATION:

DATE:	INFORMATION:
04-11-2022	20% CD SET
04-28-2022	50% CD SET
06-15-2022	95% CD SET
09-16-2022	95% CD- 3rd BAY
10-03-2022	PLAN CHECK

SHEET INFORMATION:

STK PROJECT NO.: 374-154-21
SCALE: AS NOTED
DATE: JANUARY 2021
PLOT DATE:
DRAWING NAME:

SEAL:




SHEET TITLE:

LIGHTING
FLOOR PLAN

SHEET NO.:


E2.1

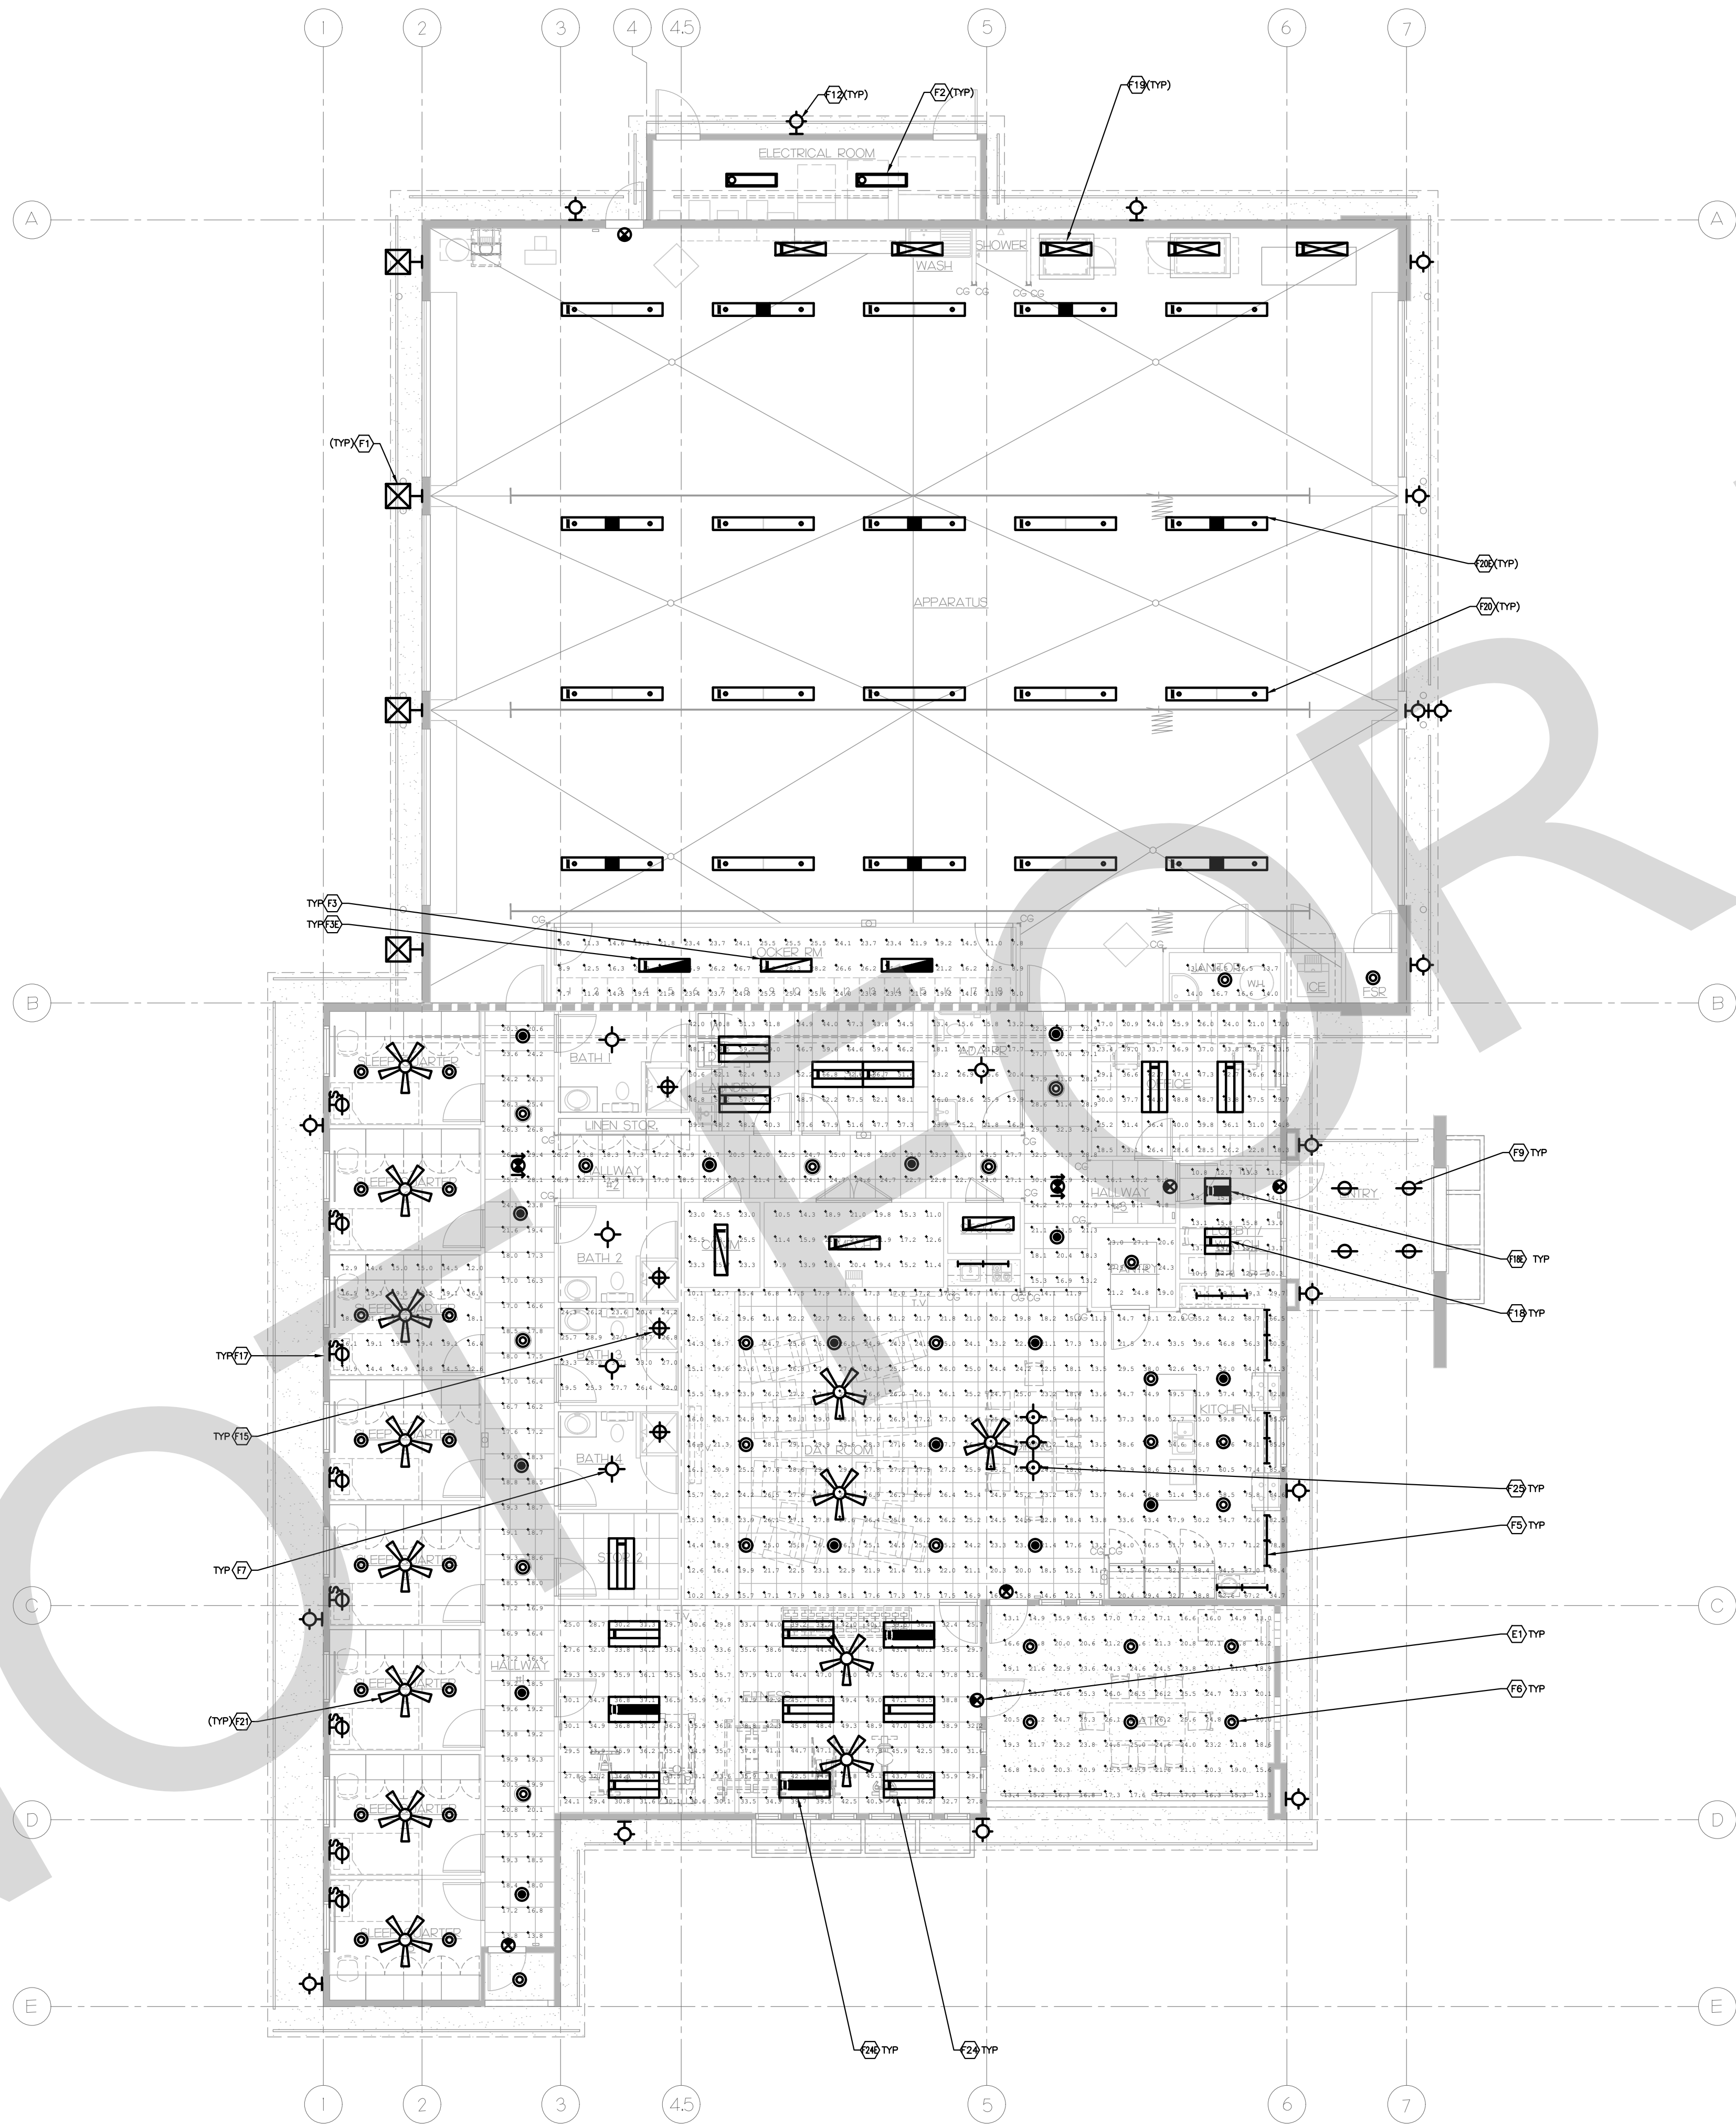

GENERAL NOTES

- A. CONTRACTOR SHALL FIELD VERIFY EXISTING CONDITIONS AND COORDINATE WITH ALL OTHER TRADES. IN CASE OF DISCREPANCIES OR ANY POTENTIAL CONFLICTS, INFORM THE ARCHITECT AND ENGINEER IN WRITING PRIOR TO START OF WORK.
- B. CONTRACTOR SHALL VERIFY EXACT QUANTITIES, LOCATIONS AND HEIGHTS OF ALL FIXTURES WITH TENANT AND ARCHITECT PRIOR TO START OF WORK.

Calculation Summary							
Label	CalcType	Units	Avg	Max	Min	Avg/Min	Max/Min
ADA BATH Floor	Illuminance	FC	21.07	28.6	13.2	1.60	2.17
BATH TYPICAL Floor	Illuminance	FC	26.12	34.1	19.5	1.34	1.75
COMM Floor	Illuminance	FC	24.80	29.4	23.0	1.08	1.23
CORRIDOR Floor	Illuminance	FC	21.22	32.5	4.8	4.42	6.77
DAY ROOM Workplane	Illuminance	FC	21.87	29.9	9.5	2.30	3.15
FITNESS Floor	Illuminance	FC	37.47	49.4	24.1	1.55	2.05
JANITOR Floor	Illuminance	FC	15.23	16.7	13.7	1.11	1.22
KITCHEN Workplane	Illuminance	FC	34.58	34.5	14.7	3.71	6.43
LAUNDRY Workplane	Illuminance	FC	30.72	42.4	39.1	1.10	1.60
LOBBY Floor	Illuminance	FC	13.42	16.0	10.3	1.30	1.55
LOCKER ROOM Floor	Illuminance	FC	20.08	28.3	7.7	2.61	3.68
MENCH Floor	Illuminance	FC	16.32	23.4	9.9	1.65	2.36
OFFICE Workplane	Illuminance	FC	31.48	48.8	17.0	1.85	2.87
PANTRY Workplane	Illuminance	FC	24.48	32.8	19.0	1.29	1.73
RETRY Floor	Illuminance	FC	20.59	26.5	13.0	1.38	2.04
SLEEP QUARTER TYPICAL Floor	Illuminance	FC	16.93	21.4	11.9	1.42	1.80
STOR 1 Workplane	Illuminance	FC	52.06	72.6	34.5	1.51	2.10

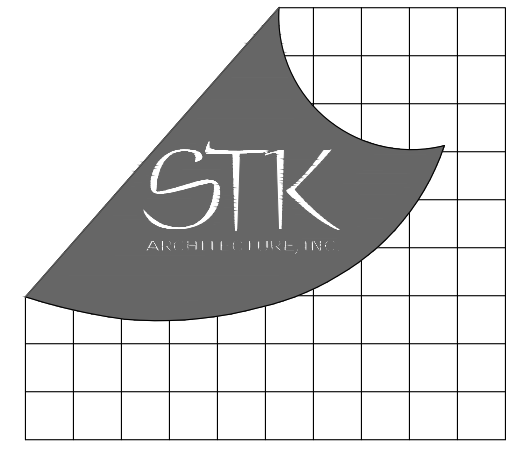

CONSULTANT:



PROJECT ADMINISTERED BY:
SAN BERNARDINO COUNTY
PROJECT & FACILITIES
MANAGEMENT DEPARTMENT

385 N. ARROWHEAD AVE.
SAN BERNARDINO, CA 92415

PROJECT NAME:
SAN BERNARDINO
COUNTY FIRE
DEPARTMENT:
FIRE STATION 226

PROJECT # 10J0J032
CIP #21-037
CAFM # SAB198
APN # 0273-011-22

1920 DEL ROSA AVE N.
SAN BERNARDINO,
CA 92404


ISSUE INFORMATION:

DATE:	INFORMATION:
04-11-2022	20% CD SET
04-28-2022	50% CD SET
06-15-2022	95% CD SET
09-16-2022	95% CD- 3rd BAY
10-03-2022	PLAN CHECK

SHEET INFORMATION:

STK PROJECT NO.: 374-154-21
SCALE: AS NOTED
DATE: JANUARY 2021
PLOT DATE:
DRAWING NAME:

SEAL:

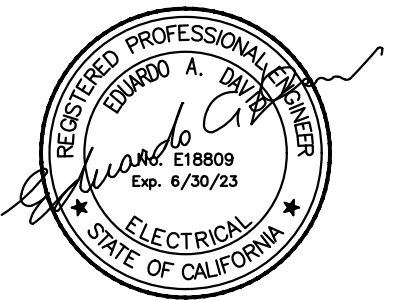

SHEET TITLE:

LIGHTING
PHOTOMETRIC


SHEET NO.:


E2.1PH

LIGHTING PHOTOMETRIC


1/8" = 1'-0"

1

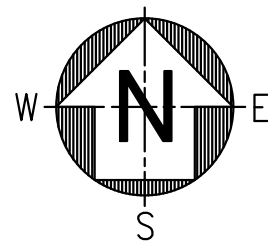

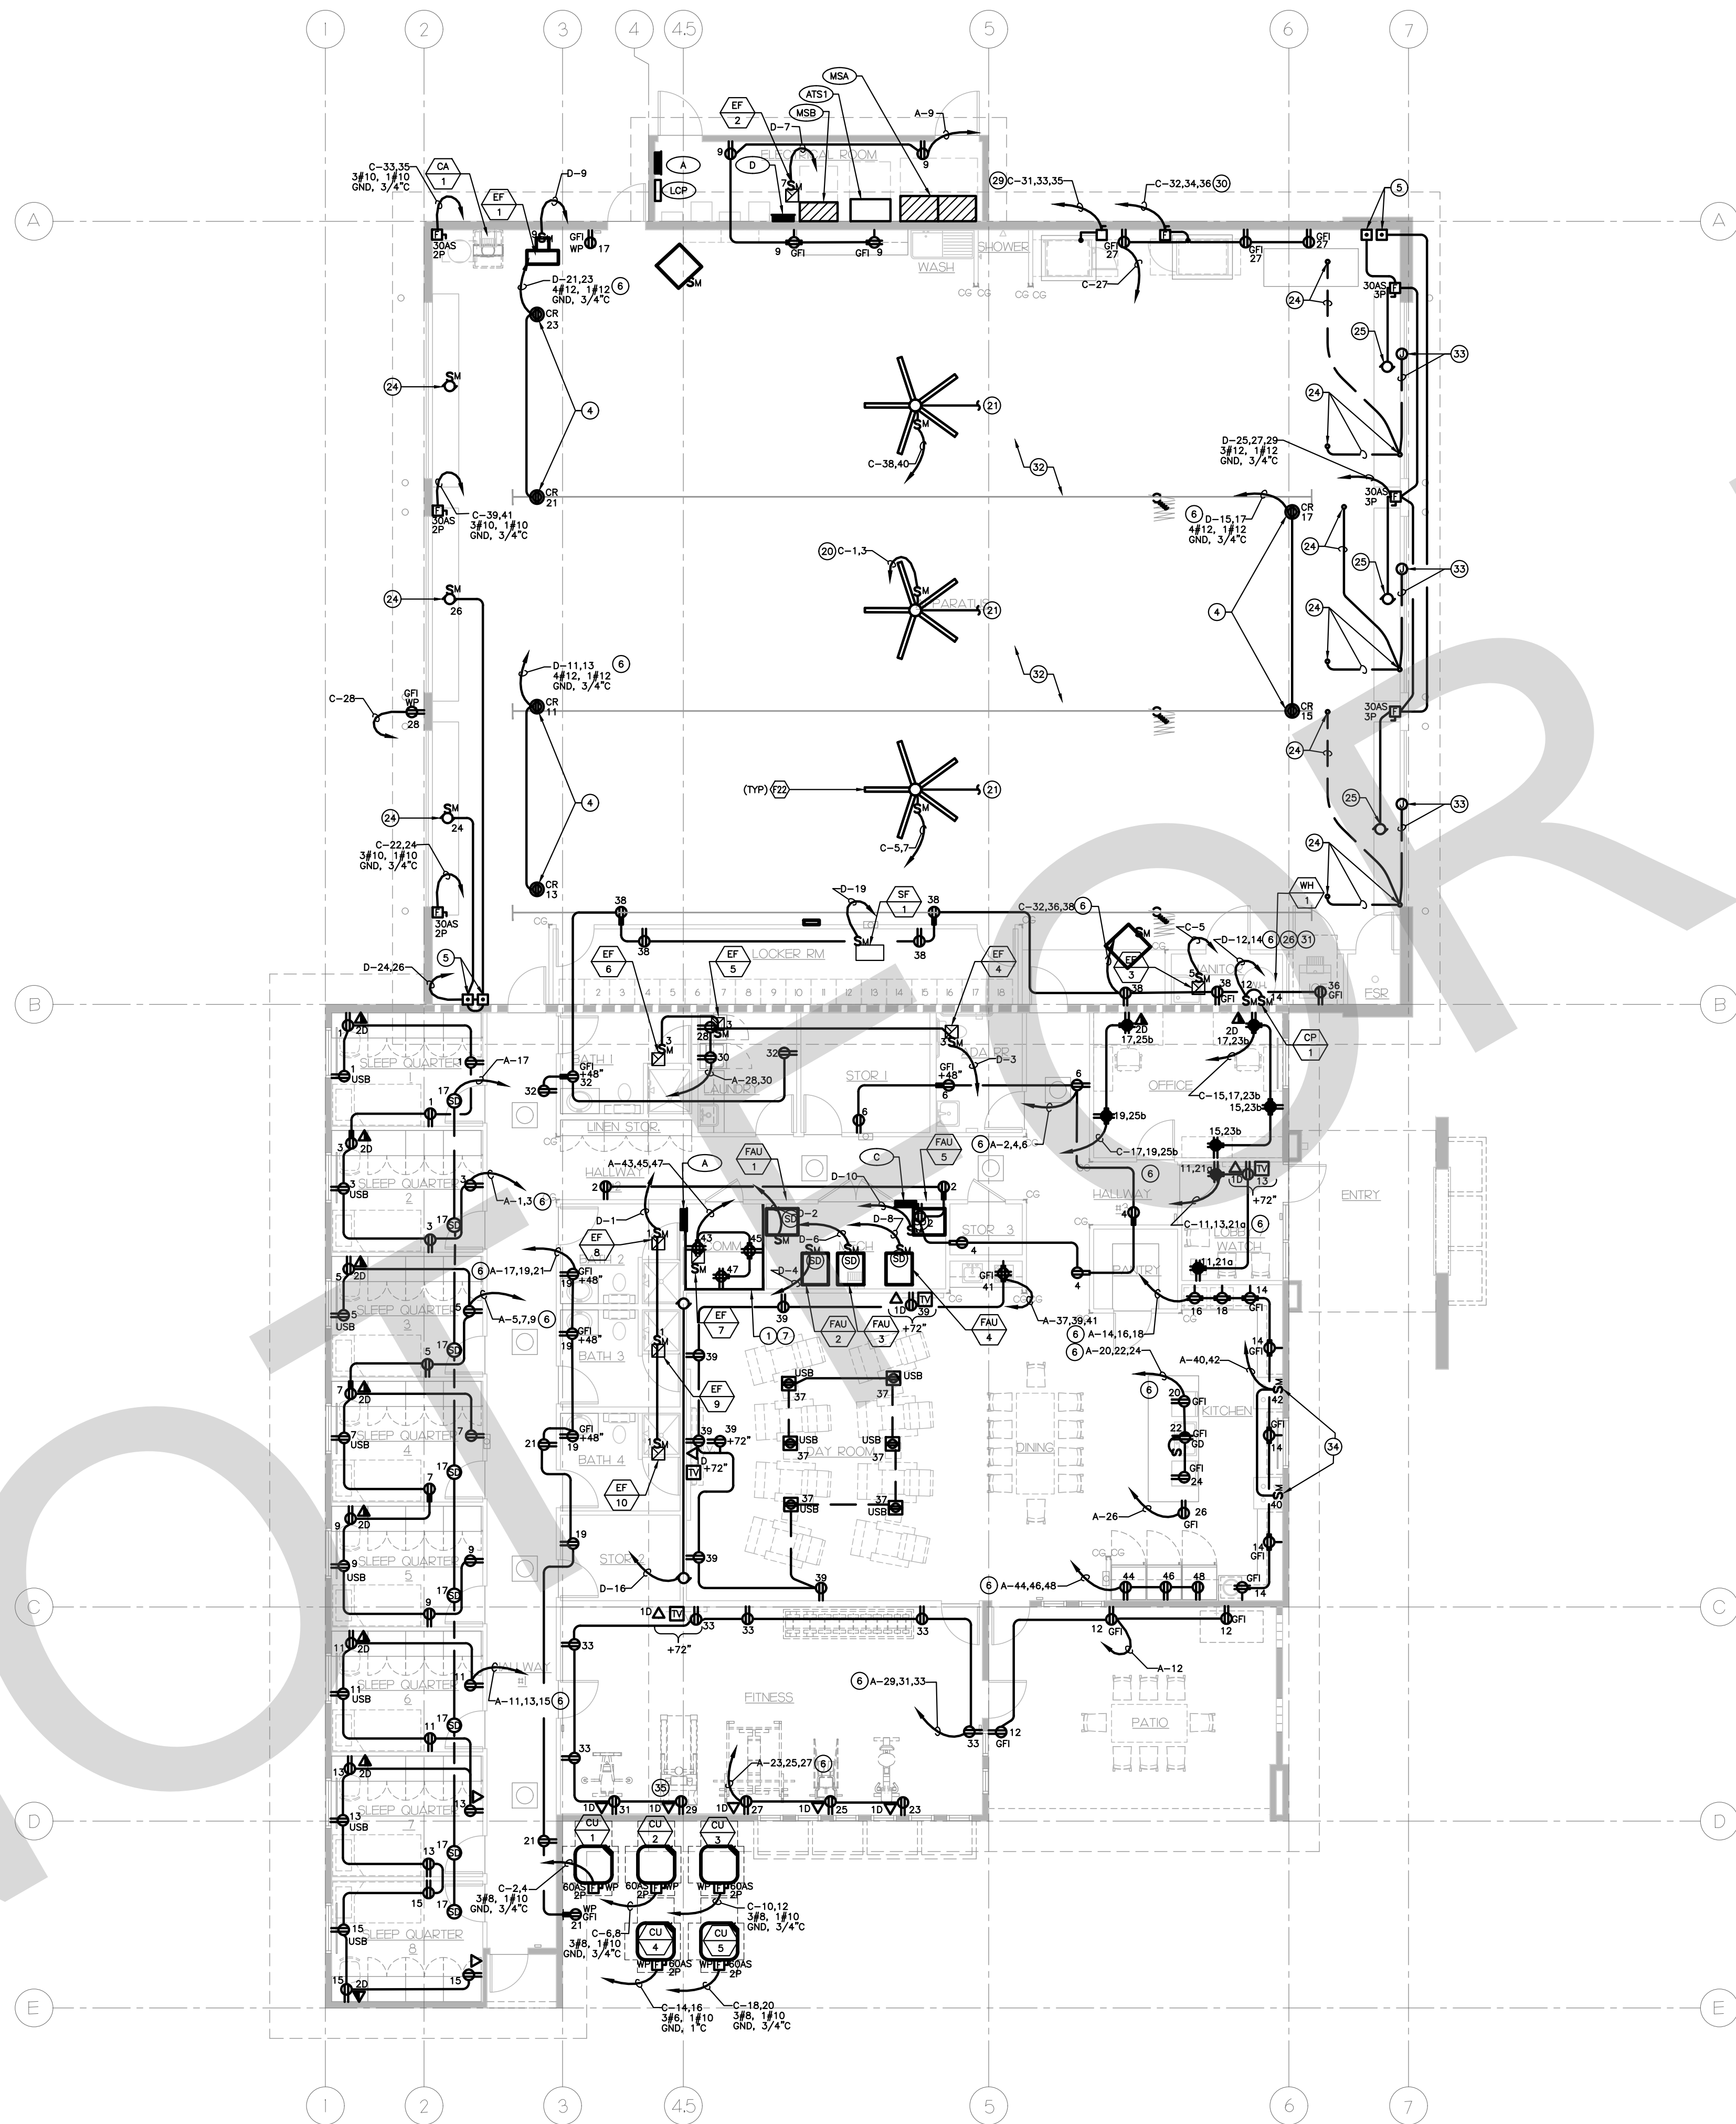

POWER FLOOR PLAN 1
1/8" = 1'-0"

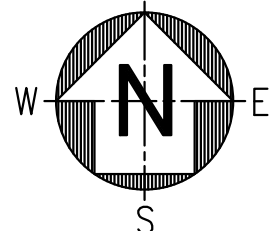


GENERAL NOTES

- A. CONTRACTOR SHALL FIELD VERIFY EXISTING CONDITIONS AND COORDINATE WITH ALL OTHER TRADES. IN CASE OF DISCREPANCIES OR ANY POTENTIAL CONFLICTS, INFORM THE ARCHITECT AND ENGINEER IN WRITING PRIOR TO START OF WORK.
- B. CONTRACTOR SHALL VERIFY EXACT QUANTITIES, LOCATIONS AND HEIGHTS OF ALL OUTLETS WITH TENANT AND ARCHITECT PRIOR TO START OF WORK.
- C. CONTRACTOR SHALL FIELD VERIFY AND COORDINATE WITH MECHANICAL DRAWINGS FOR EXACT LOCATION OF EQUIPMENT AND REQUIREMENTS PRIOR TO START OF WORK.
- D. MECHANICAL EQUIPMENT FUSE SIZE RATINGS PER EQUIPMENT MANUFACTURER'S RECOMMENDATIONS.
- E. ALL MECHANICAL EQUIPMENT FUSED DISCONNECTS AND MOTOR RATED SWITCHES EXPOSED TO WEATHER SHALL BE WEATHERPROOF RATED.
- F. RECEPTACLES AND SWITCHES BACKED UP BY GENERATOR SHALL BE RED IN COLOR AND WITH RED COVER PLATES.
- G. ALL RECEPTACLES IN SLEEPING ROOMS AND WHERE REQUIRED BY CODE SHALL BE TAMPERPROOF SPECIFICATION RECEPTACLES FED FROM ARC-FAULT-CIRCUIT-INTERRUPTING (AFCI) TYPE CIRCUIT BREAKERS.

KEY NOTES

- 1. MAIN TELEPHONE SERVICE BACKBOARD.
- 2. GENERATOR REMOTE ANNUNCIATOR PANEL. COORDINATE LOCATION OF ANNUNCIATOR PANEL WITH ARCHITECT AND OWNER'S REPRESENTATIVE PRIOR TO START OF WORK.
- 3. MOUNT SMOKE DETECTORS A MINIMUM OF 36" FROM AIR REGISTERS AND CEILING FANS. INTERFACE ALL SMOKE DETECTORS WITH FIRE ALARM SYSTEM.
- 4. PROVIDE DUAL CIRCUIT, DUAL RECEPTACLE, 30 AMP CORD REEL. COORDINATE WITH OWNER FOR EXACT RECEPTACLE TYPE PRIOR TO START OF WORK.
- 5. GARAGE BAY DOOR CONTROL. MOUNT AT 42" ABOVE FINISH FLOOR. COORDINATE WITH ARCHITECTURAL DRAWINGS FOR EXACT LOCATION PRIOR TO START OF WORK.
- 6. PROVIDE DEDICATED NEUTRAL CONDUCTOR FOR EACH BRANCH CIRCUIT.
- 7. PROVIDE 3/4" X 8'-0" X 4'-0" FIRE TREATED PLYWOOD WITH 1#6 GROUND CONNECTED TO BUILDING MAIN SERVICE GROUND.
- 8. GAS SHUTOFF VALVE MOMENTARY RESET PUSH BUTTON WITH PILOT LIGHT BY INTELLIGENT LIGHTING CONTROLS, INC. CATALOG NUMBER - NFP-01-01-LED-PW OR APPROVED EQUAL. PROVIDE WITH 3/8" 1/2" 1/8" 1/2" CONDUIT AND 3/4" CONDUIT AND CONNECT TO LIGHTING CONTROL PANEL 'LCP1'. COORDINATE LOCATION OF PUSH BUTTON WITH ARCHITECT AND OWNER'S REPRESENTATIVE PRIOR TO START OF WORK.
- 9. JUNCTION BOX FOR POWER OR TELE/DATA FEED TO SYSTEM FURNITURE PANELS. PROVIDE FLUSH COVER PLATE AND FLEXIBLE CONDUIT CONNECTION TO FURNITURE PANEL. COORDINATE EXACT LOCATION AND POINT OF CONNECTION WITH SYSTEM FURNITURE SUPPLIER/INSTALLER PRIOR TO START OF WORK.
- 10. ROUTE CONTROLLED RECEPTACLE THROUGH CEILING MOUNTED OCCUPANCY SENSOR.
- 11. PROVIDE DOOR BELL SYSTEM AS INDICATED ON PLAN. COORDINATE WITH ARCHITECT FOR EXACT LOCATION PRIOR TO START OF WORK.
- 12. DUPLEX FLOOR OUTLETS. MANUFACTURER BY CARLON OR EQUAL. FIELD VERIFY EXACT LOCATION AND COORDINATE WITH ARCHITECT AND OWNER'S REPRESENTATIVE PRIOR TO START OF WORK.
- 13. DISPATCH PANEL. COORDINATE WITH ARCHITECT FOR EXACT LOCATION PRIOR TO START OF WORK.
- 14. AREA FOR FUTURE PV EQUIPMENT.
- 15. FIRE ALARM CONTROL PANEL. COORDINATE LOCATION WITH FIRE ALARM CONTRACTOR PRIOR TO START OF WORK.
- 16. CONNECT TO FLOW SWITCH. COORDINATE LOCATION AND WIRING REQUIREMENTS WITH FLOW SWITCH PROVIDER/INSTALLER PRIOR TO START OF WORK.
- 17. RECEPTACLE OUTLET FOR KITCHEN HOOD. COORDINATE MOUNTING HEIGHT WITH KITCHEN HOOD PROVIDER/INSTALLER PRIOR TO START OF WORK.
- 18. SPRINKLER SYSTEM CONTROLLER (WET AND DRY). COORDINATE LOCATION WITH FIRE ALARM CONTRACTOR PRIOR TO START OF WORK.
- 19. PROVIDE CONNECTION TO ROLL-UP DOOR MOTOR. COORDINATE EXACT LOCATION AND POINT OF CONNECTION WITH DOOR SUPPLIER/INSTALLER PRIOR TO START OF WORK.
- 20. PROVIDE 2-POLE, MOTOR RATED SWITCH AS A DISCONNECTING MEANS FOR FAN MOTOR. COORDINATE EXACT LOCATION AND POINT OF CONNECTION WITH FAN SUPPLIER/INSTALLER PRIOR TO START OF WORK.
- 21. PROVIDE 3/4" CONDUIT FOR FAN CONTROL WIRING AND ALL CONTROLS FOR A COMPLETE AND OPERABLE SYSTEM. COORDINATE EXACT LOCATION AND POINTS OF CONNECTION WITH FAN SUPPLIER/INSTALLER PRIOR TO START OF WORK.
- 22. PROVIDE 30 AMP, 3 POLE DISCONNECT SWITCH WITH 3#8, 1#12 GROUND, 3/4" CONDUIT THROUGH-OUT.
- 23. THERE SHALL BE NO EXPOSED CONDUIT WITHIN THE APPARATUS BAY.
- 24. PROVIDE 3/4" CONDUIT UNDER SLAB FOR DOOR OBSTRUCTION DETECTION SYSTEM AND CONTROLS AND STUB-UP AS REQUIRED FOR A COMPLETE AND OPERABLE SYSTEM. COORDINATE EXACT LOCATION AND POINTS OF CONNECTION WITH DOOR SUPPLIER/INSTALLER PRIOR TO START OF WORK.
- 25. PROVIDE CONNECTION TO AIR COMPRESSOR. PROVIDE WITH MAGNETIC STARTER, START UP KIT. COORDINATE WITH PLUMBING PLANS.
- 26. PROVIDE 40 AMP, 2 POLE DISCONNECT SWITCH FOR WATER HEATER WH-2.
- 27. PROVIDE JUNCTION BOX AND POWER FOR CARD READER. COORDINATE EXACT LOCATION, POINT OF CONNECTION AND REQUIREMENTS WITH CARD READER SUPPLIER/INSTALLER PRIOR TO START OF WORK.
- 28. PROVIDE CONNECTION TO IRRIGATION CONTROLLER. COORDINATE EXACT LOCATION, POINT OF CONNECTION AND REQUIREMENTS WITH IRRIGATION SYSTEM SUPPLIER/INSTALLER PRIOR TO START OF WORK.
- 29. PROVIDE 60 AMP, 3 POLE DISCONNECT SWITCH WITH 3#8, 1#10 GROUND, 3/4" CONDUIT THROUGH-OUT.
- 30. PROVIDE 60 AMP, 3 POLE DISCONNECT SWITCH WITH 3#8, 1#10 GROUND, 1" CONDUIT THROUGH-OUT.
- 31. PROVIDE 20 AMP, 2 POLE MOTOR RATED SWITCH FOR INSTA-HOT WATER HEATER DISCONNECTING MEANS. COORDINATE EXACT REQUIREMENTS AND LOCATIONS WITH EQUIPMENT SUPPLIER/INSTALLER PRIOR TO START OF WORK.
- 32. THERE SHALL BE NO EXPOSED CONDUIT WITHIN THE APPARATUS BAY.
- 33. PROVIDE 3/4" CONDUIT IN CMU WALL TO WEATHER PROOF JUNCTION BOX ABOVE DOOR AT 15'-4" FOR DOOR OBSTRUCTION DETECTION SYSTEM AND CONTROLS AND STUB-UP AS REQUIRED FOR A COMPLETE AND OPERABLE SYSTEM. COORDINATE EXACT LOCATION AND POINTS OF CONNECTION WITH DOOR SUPPLIER/INSTALLER PRIOR TO START OF WORK.
- 34. RECEPTACLE OUTLET FOR KITCHEN HOOD. COORDINATE MOUNTING HEIGHT WITH KITCHEN HOOD PROVIDER/INSTALLER PRIOR TO START OF WORK.
- 35. RECEPTACLE FOR THREADMILL. COORDINATE RECEPTACLE NEMA CONFIGURATION WITH THREADMILL MANUFACTURER PRIOR TO START OF WORK.

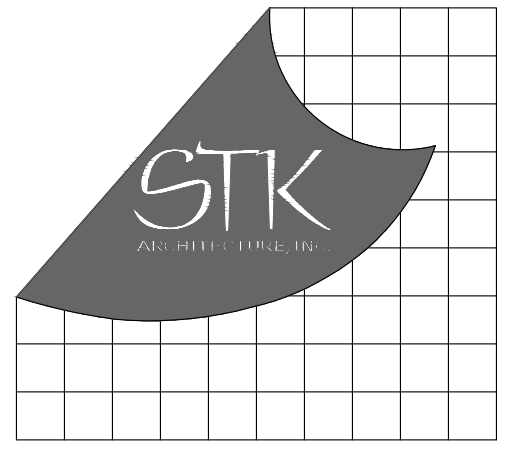

4305 ZEVOS DR., TEMECULA, CALIFORNIA 92590-3760
Phone: 951.266.8110 Fax: 951.266.6079 Email: sk@stkinc.com

CONSULTANT



#21189
www.salasobrien.com
E-Mail: admin@sthegeng.com

PROJECT ADMINISTERED BY:
SAN BERNARDINO COUNTY
PROJECT & FACILITIES
MANAGEMENT DEPARTMENT

385 N. ARROWHEAD AVE.
SAN BERNARDINO, CA 92415

PROJECT NAME:
SAN BERNARDINO
COUNTY FIRE
DEPARTMENT:
FIRE STATION 226

PROJECT # 10J0J032
CIP #21-037
CAFM # SABI98
APN # 0273-011-22

1920 DEL ROSA AVE N.
SAN BERNARDINO,
CA 92404

ISSUE INFORMATION:

DATE:	INFORMATION:
04-11-2022	20% CD SET
04-28-2022	50% CD SET
06-15-2022	95% CD SET
09-16-2022	95% CD- 3rd BAY
10-03-2022	PLAN CHECK

SHEET INFORMATION:

STK PROJECT NO.: 374-154-21
SCALE: AS NOTED
DATE: JANUARY 2021
PLOT DATE: -
DRAWING NAME:
SEAL:



SHEET TITLE:


POWER
FLOOR PLAN

SHEET NO.:

E2.2

GENERAL NOTES




- A. CONTRACTOR SHALL FIELD VERIFY EXISTING CONDITIONS AND COORDINATE WITH ALL OTHER TRADES. IN CASE OF DISCREPANCIES OR ANY POTENTIAL CONFLICTS, INFORM THE ARCHITECT AND ENGINEER IN WRITING PRIOR TO START OF WORK.
- B. CONTRACTOR SHALL VERIFY EXACT QUANTITIES, LOCATIONS AND HEIGHTS OF ALL OUTLETS WITH TENANT AND ARCHITECT PRIOR TO START OF WORK.

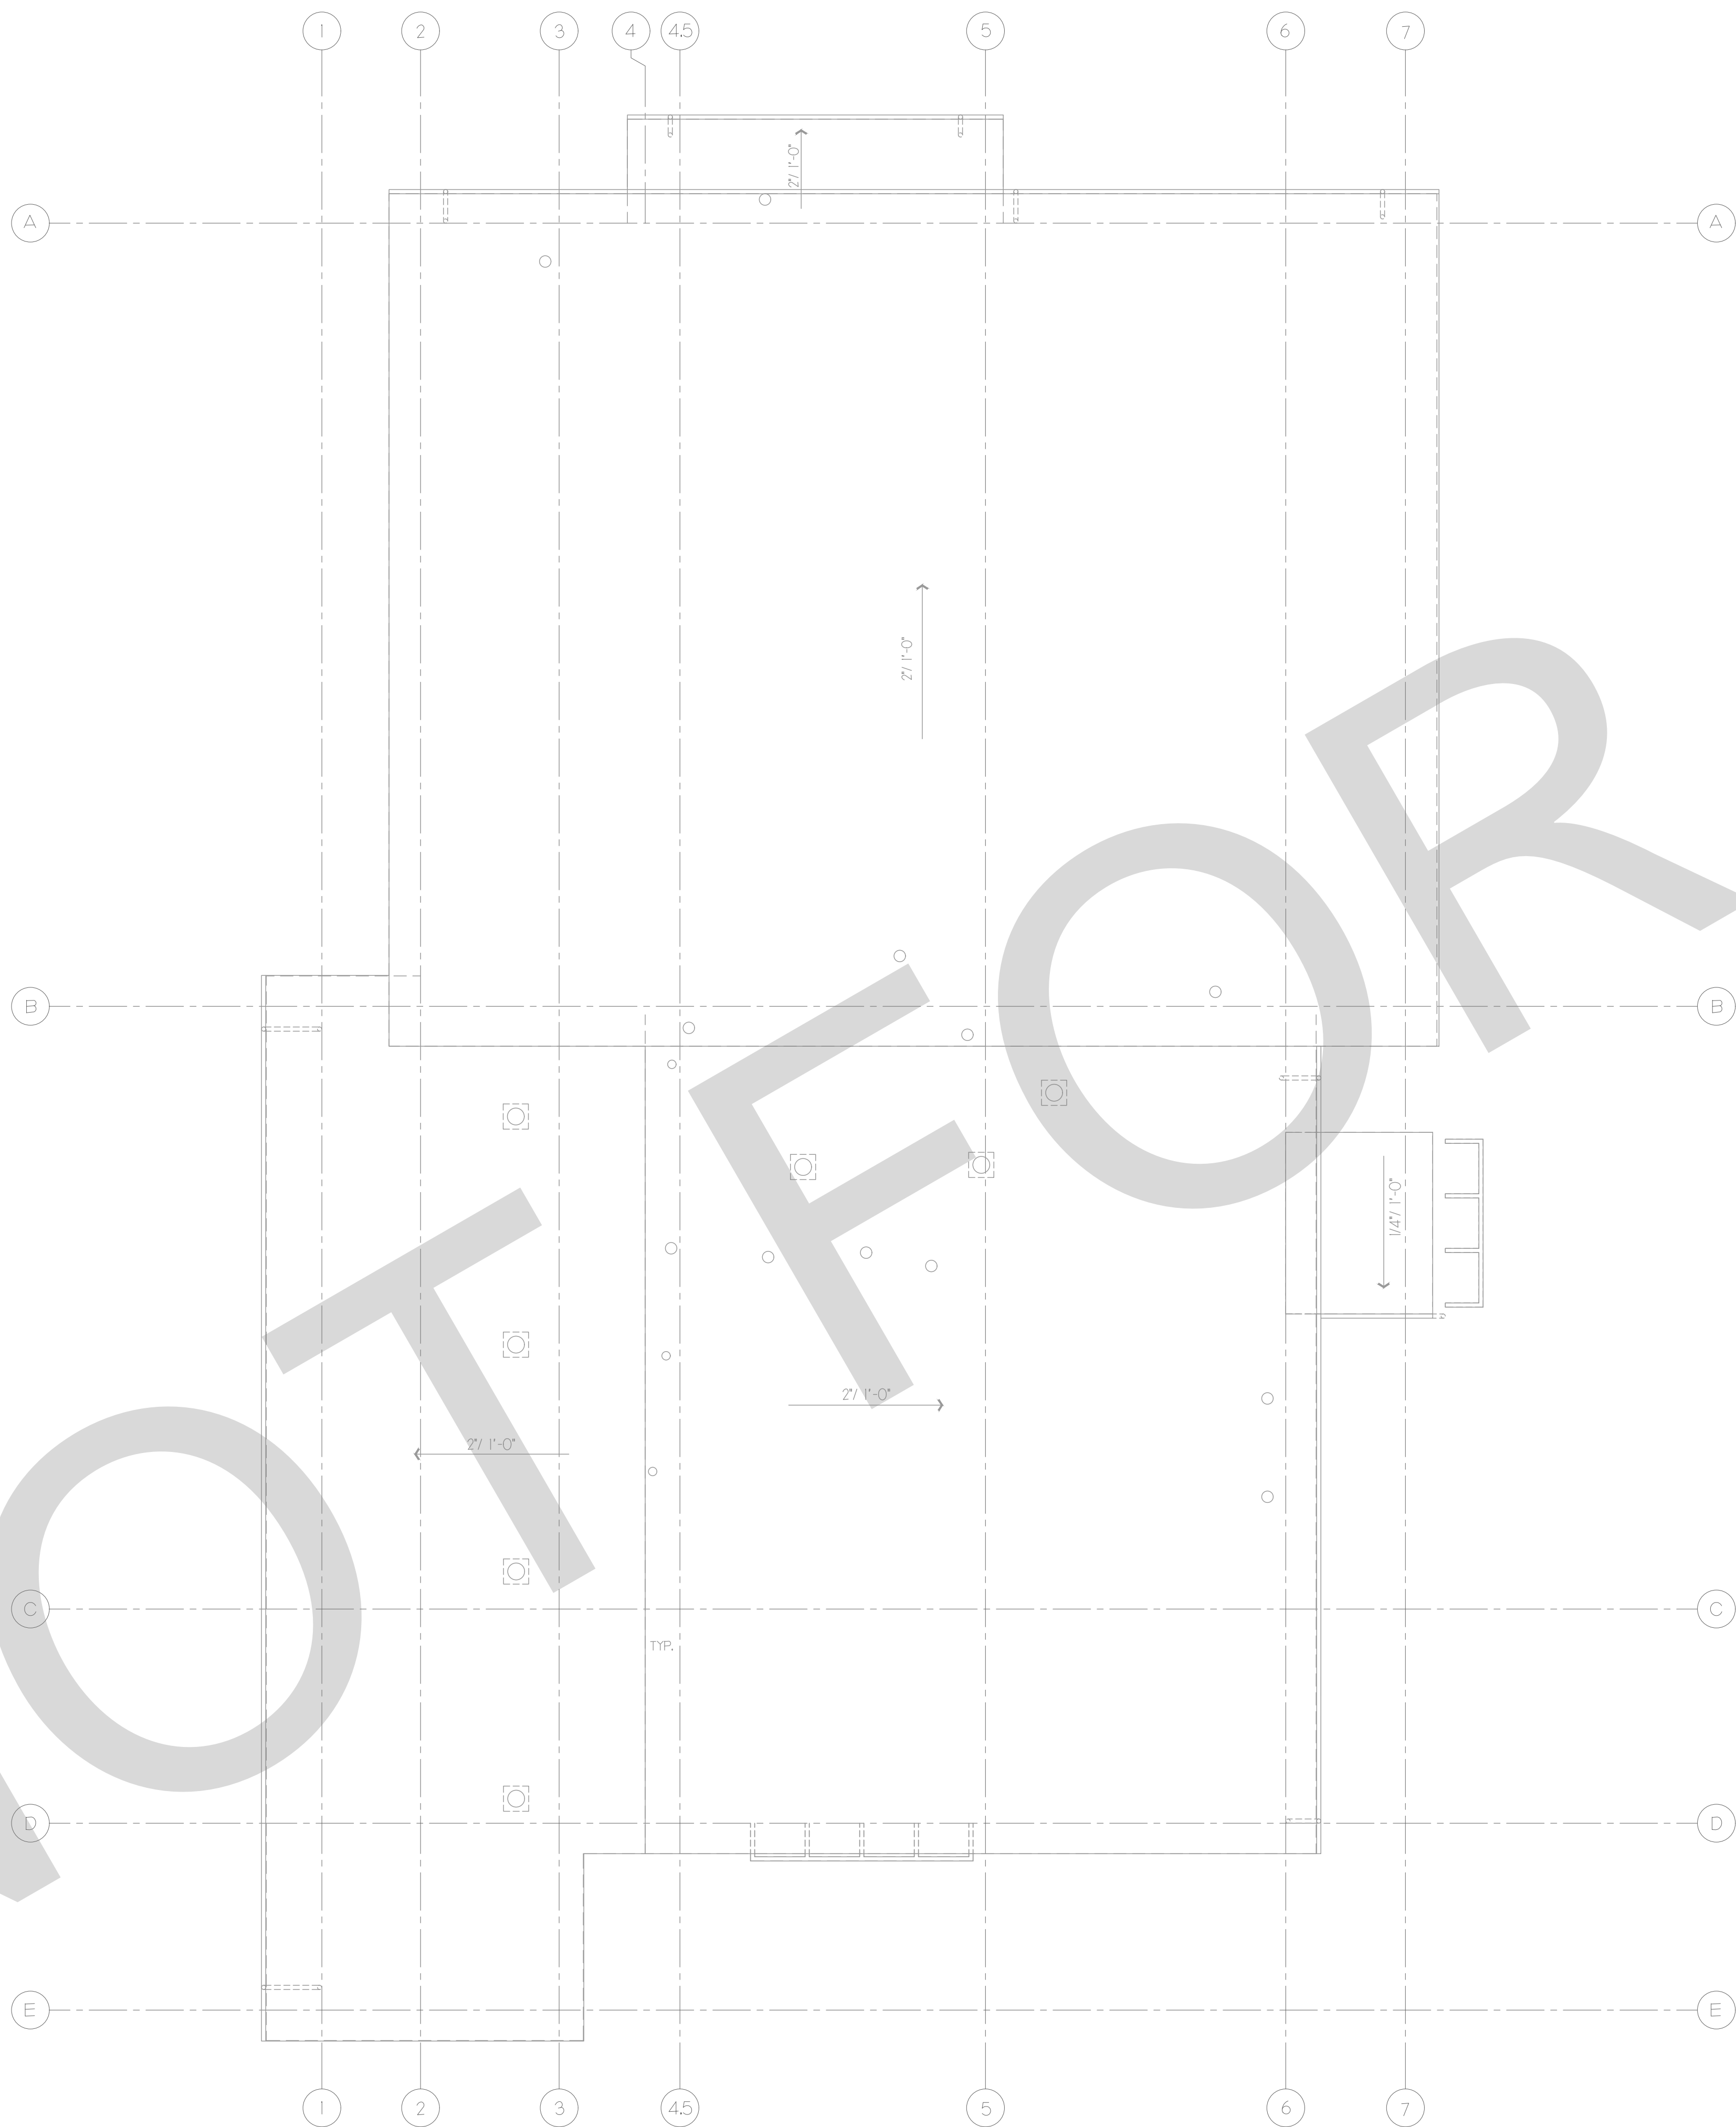

ELECTRICAL ROOF PLAN

1/8" = 1'-0"

1

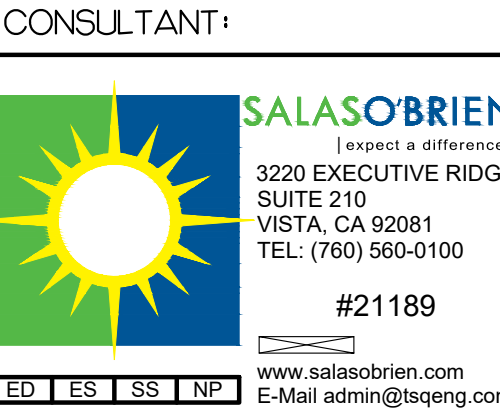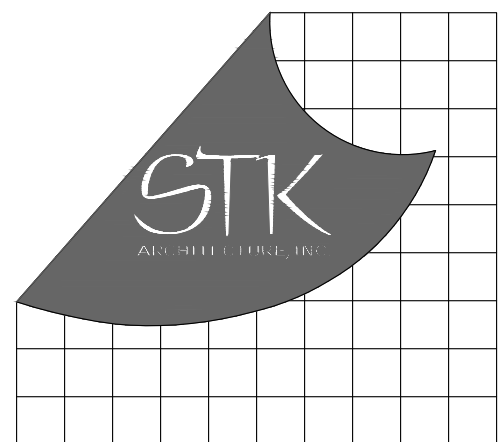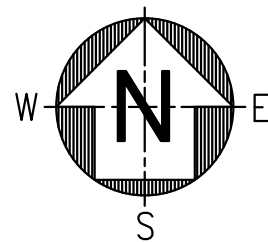

PROJECT ADMINISTERED BY:
SAN BERNARDINO COUNTY
PROJECT & FACILITIES
MANAGEMENT DEPARTMENT

385 N. ARROWHEAD AVE.
SAN BERNARDINO, CA 92415

PROJECT NAME:
SAN BERNARDINO
COUNTY FIRE
DEPARTMENT:
FIRE STATION 226

PROJECT # 10J0J032

CIP #21-037

CAFM # SAB198


APN # 0273-011-22

1920 DEL ROSA AVE N.
SAN BERNARDINO,
CA 92404

ISSUE INFORMATION:	
DATE:	INFORMATION:
04-11-2022	20% CD SET
04-28-2022	50% CD SET
06-15-2022	95% CD SET
09-16-2022	95% CD- 3rd BAY
10-03-2022	PLAN CHECK

SHEET INFORMATION:
STK PROJECT NO.: 374-154-21
SCALE: AS NOTED
DATE: JANUARY 2021
PLOT DATE: -
DRAWING NAME: -

SEAL:

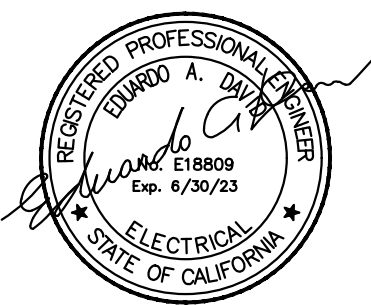

SHEET TITLE:

ELECTRICAL
ROOF PLAN

SHEET NO.:


E2.3

GENERAL NOTES

- A. CONTRACTOR SHALL FIELD VERIFY EXISTING CONDITIONS AND COORDINATE WITH ALL OTHER TRADES. IN CASE OF DISCREPANCIES OR ANY POTENTIAL CONFLICTS, INFORM THE ARCHITECT AND ENGINEER IN WRITING PRIOR TO START OF WORK.
- B. ALL WORK SHOWN IS NEW UNLESS NOTED OTHERWISE.
- C. ALL CONDUCTORS SHALL BE COPPER UNLESS NOTED OTHERWISE.

KEY NOTES

- ① REMOTE GENERATOR ANNUNCIATOR PANEL.
- ② PROVIDE REVERSE FEED LISTED CIRCUIT BREAKER FOR PV INSTALLATION.
- ③ FRONIUS SYMO 15kW 15.0-3 (208) (5 STR) INVERTER WITH INTEGRAL AC AND DC DISCONNECTS, (6) INTEGRAL FUSED POSITIONS, (3) PER MPPT. SYSTEM SHOWN IS AN EXAMPLE, ELECTRICAL CONTRACTOR MAY, AT THEIR EXPENSE PROVIDE A DIFFERENT EQUIVALENT, COMPLETE, OPERABLE PV SYSTEM DESIGNED AND PERMITTED AT THEIR OWN EXPENSE.
- ④ THE EXISTING FIRE STATION BUILDING SHALL REMAIN FULLY FUNCTIONAL AND OCCUPIED DURING THE DURATION OF THE CONSTRUCTION OF THE NEW FIRE STATION. THE GENERAL CONTRACTOR SHALL PROVIDE ANY TEMPORARY UTILITIES THAT MAY BE REQUIRED FOR EITHER OR BOTH BUILDINGS TO REMAIN OPERATIONAL. THIS SHALL BE INCLUDED IN THE CONTRACTORS BID AND SHALL NOT INCUR ADDITIONAL COST TO THE OWNER. EXISTING FIRE STATION TO BE REMAIN AND IN OPERATIONAL. ALL UTILITIES CONNECTED TO EXISTING SHALL PROTECT IN PLACE DURING CONSTRUCTION OF THE PROJECT DURING PHASE 1.
- ⑤ DISCONNECT AND REMOVE ALL EXISTING UTILITIES (POWER, PHONE, DATA, ETC. BACK TO ITS ORIGINAL SOURCE ONCE THE NEW FIRE STATION IS COMPLETED DURING PHASE 2 OF THE CONSTRUCTION. ALL DEMOLITION OF THE EXISTING BUILDING DURING PHASE 2 OF THE PROJECT SHALL BE IN THE CONTRACTOR'S BID PROPOSAL FOR BOTH PHASES AND SHALL NOT INCUR ADDITIONAL COST TO THE OWNER.

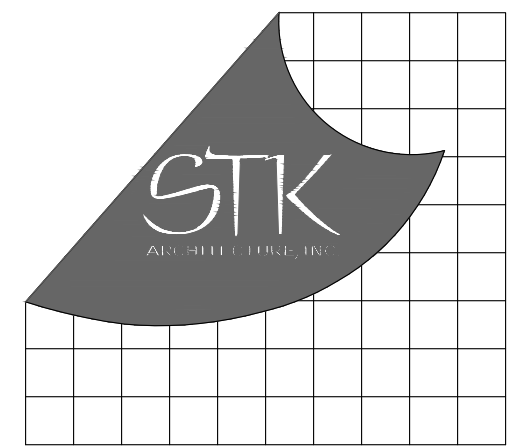

PROJECT ADMINISTERED BY:
SAN BERNARDINO COUNTY
PROJECT & FACILITIES
MANAGEMENT DEPARTMENT

385 N. ARROWHEAD AVE.
SAN BERNARDINO, CA 92415

PROJECT NAME:
SAN BERNARDINO
COUNTY FIRE
DEPARTMENT:
FIRE STATION 226


PROJECT # 10J0J032
CIP #21-037
CAF# # SABI98
APN # 0273-011-22

1920 DEL ROSA AVE N.
SAN BERNARDINO,
CA 92404

ISSUE INFORMATION:	
DATE:	INFORMATION:
04-11-2022	20% CD SET
04-28-2022	50% CD SET
06-15-2022	95% CD SET
09-16-2022	95% CD- 3rd BAY
10-03-2022	PLAN CHECK

SHEET INFORMATION:	
STK PROJECT NO.:	374-154-21
SCALE:	AS NOTED
DATE:	JANUARY 2021
PLOT DATE:	-
DRAWING NAME:	-


SEAL:

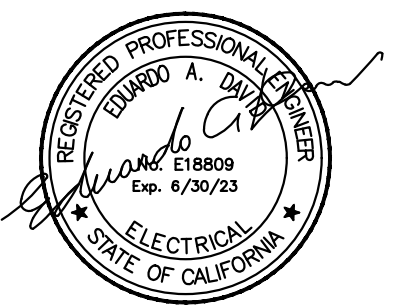

SHEET TITLE:
SINGLE LINE
DIAGRAM AND
LOAD
SUMMARY


SHEET NO.:

E4.1

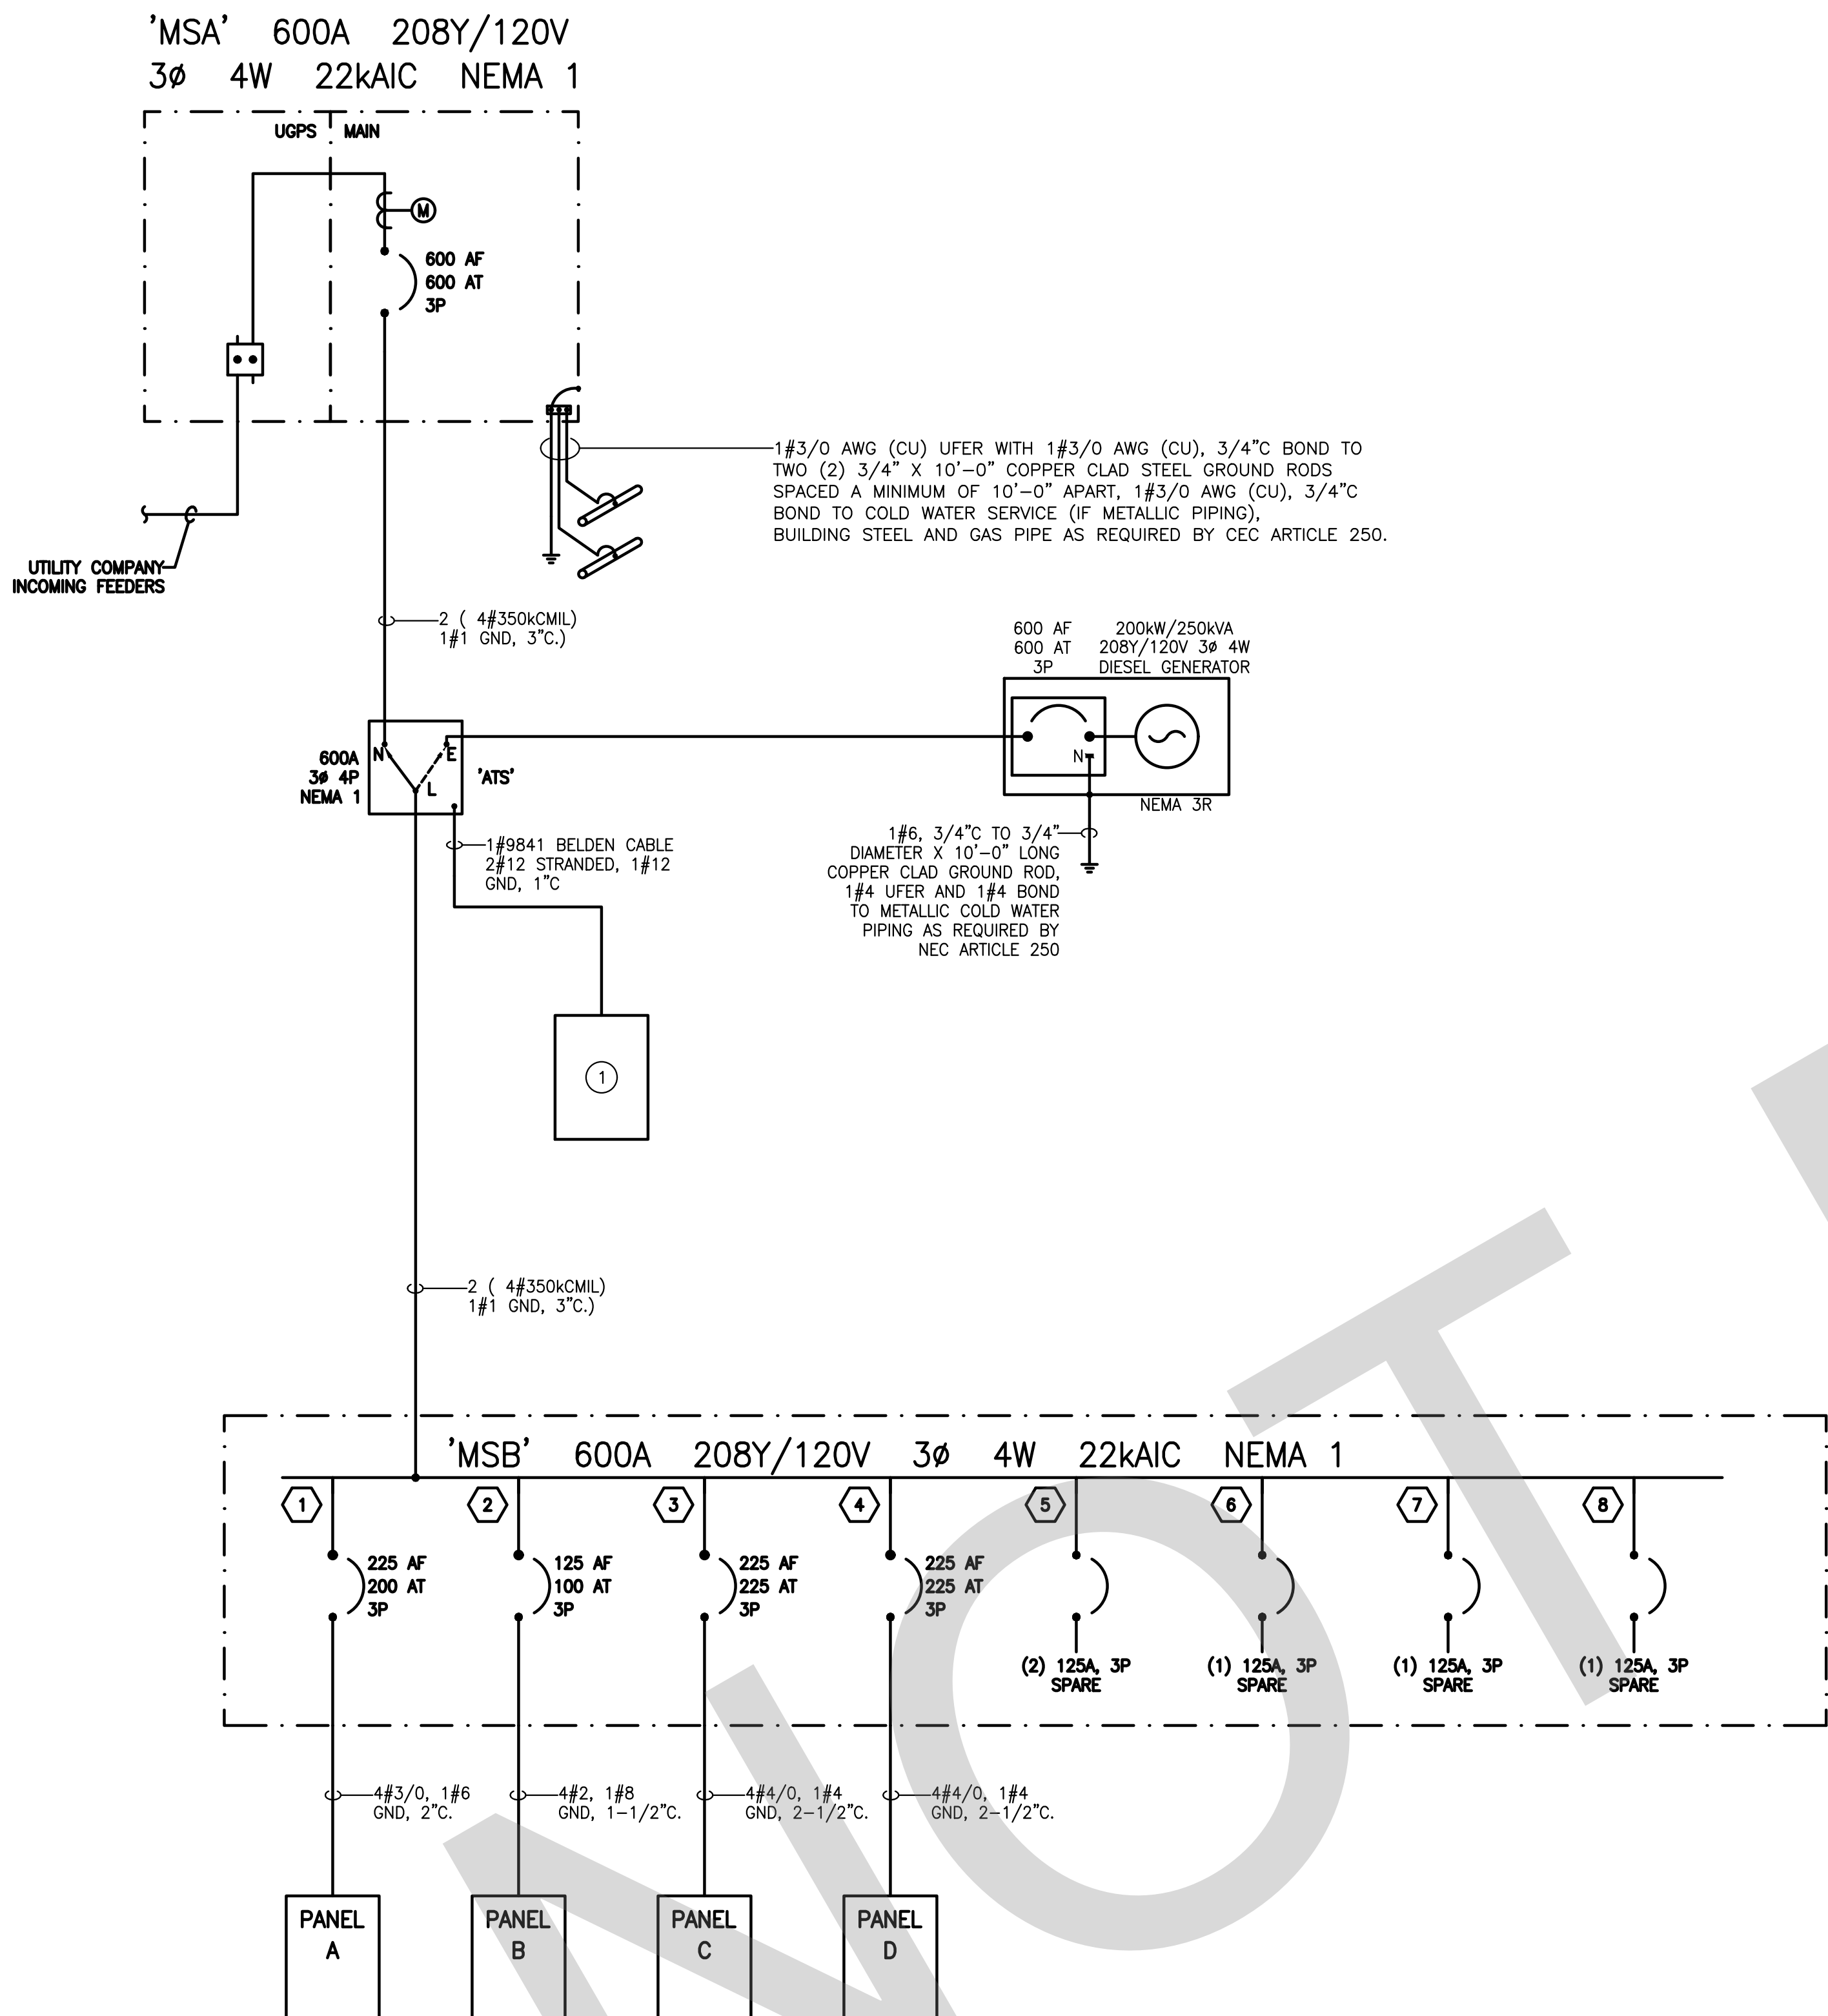

SINGLE LINE DIAGRAM

1

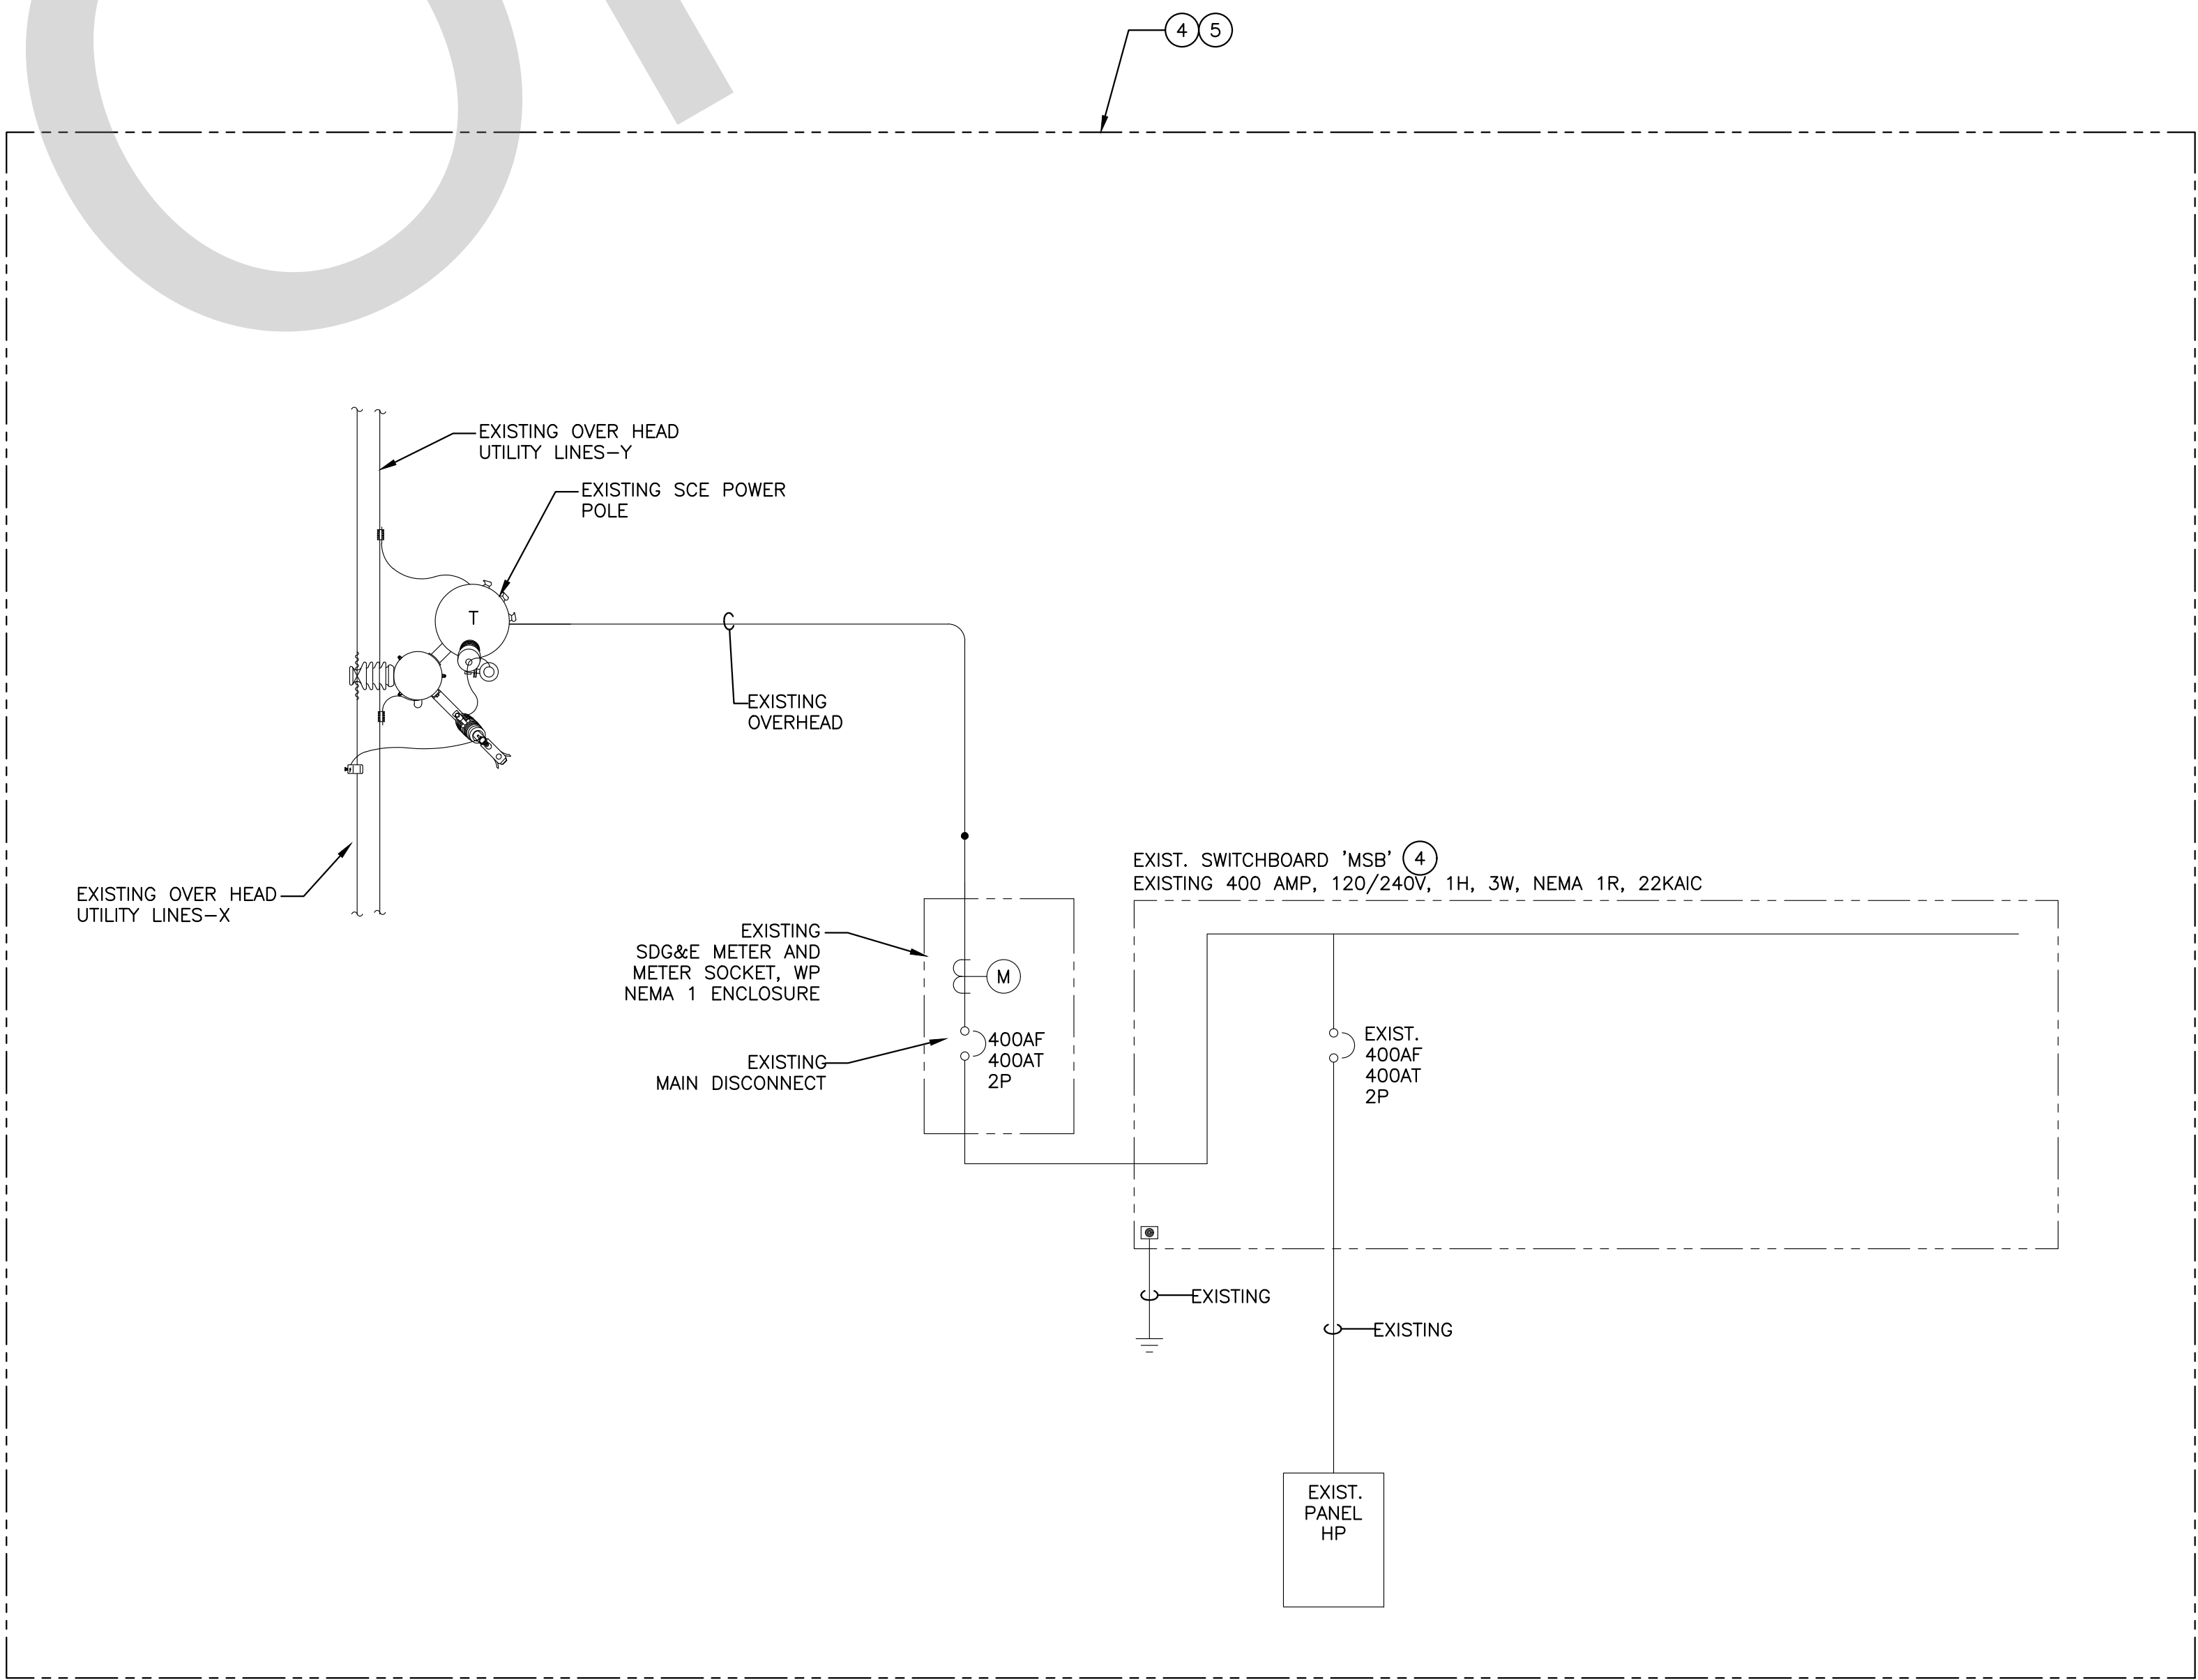

EXISTING SINGLE LINE DIAGRAM


2

PANEL: C		LOCATION: SEE PLANS		MAIN: 225A/3P		BUS: 225A		NEMA 1						
VOLTAGE: 208 / 120		AIC RATING: 10000		FEED: BOTTOM		MTG: SURFACE								
PHASE: 3		CIRCUIT CODE:												
WIRE: 4		blank=NON-CONTINUOUS, N=NON-COINCIDENTAL, L=LONG CONTINUOUS, R=RECEPT (NEC ART. 220-44), K=KITCHEN												
NOTE	DESCRIPTION	CODE	BKR	P	#	VA	PHASE	VA	#	P	BKR	CODE	DESCRIPTION	NOTE
	APPARATUS FAN	R	20	2	1	125	A	3109	2	2	40	-	CONDENSING UNIT CU-1	
	-		20		3		B	3109		4				
	APPARATUS FAN	R	20	2	5	125	A	3109		6	2	40	CONDENSING UNIT CU-2	
	-		20		7		A	3109		8				
	ELECTRICAL RM, WRK BENCH	R	20	1	9	720	B	3109	10	2	40	-	CONDENSING UNIT CU-3	
	LOBBY WATCH RECEPT	R	20	1	11	720	A	3109	12			-		
	LOBBY WATCH RECEPT	R	20	1	13	180	A	3276	14	2	60	-	CONDENSING UNIT CU-4	
	OFFICE RECEPT	R	20	1	15	720	B	3276	16			-		
	OFFICE RECEPT	R	20	1	17	720	C	3109	18	2	40	-	CONDENSING UNIT CU-5	
	OFFICE RECEPT	R	20	1	19	360	A	3109	20			-		
	LOBBY CONTROLLED RECEPT	R	20	1	21	720	B	22	2	20	R	-	APPARATUS DOORS	
	OFFICE CONTROLLED RECEPT	R	20	1	23	720	C		24			-		
	OFFICE CONTROLLED RECEPT	R	20	1	25	720	A		26			-	FUSED DISCONNECT APPARATUS	
	SCBA AREA RECEPT	R	20	1	27	540	B		28			-		
					29		C		30			-		
	WASHER - EXTRACTOR	R	15	3	31	612	A	6240	32	3	60	R	DRYER	
	-				33	612	B	6240	34			-		
	-				35	612	C	6240	36			-		
	-				37		A	125	38	2	20	-	APPARTUS FAN	
	APPARATUS DOORS	R	20	2	39	30	B	125	40			-		
	-				41		C		42			-		
CONNECTED VA @ A		20965		CONNECTED VA ()		45378		PANEL CONN. AMPS WITH LCL		162.74		PANEL DEMAND KVA WITH LCL		57.00
CONNECTED VA @ B		19201		CONNECTED VA (L)		0		CONNECTED VA WITH LCL (L)		0		PANEL DEMAND AMPS WITH LCL		158.23
CONNECTED VA @ C		18464		CONNECTED VA (R)		13252		DEMAND VA (R)		11626		PANEL CONNECTED AMPS		162.74
TOTAL VA		58630		CONNECTED VA (K)		0		DEMAND VA (K)		0		DEMAND HIGH @ AMPS WITH LCL		166.16
SPECIAL NOTES:														
1	6													
2	7													
3	8													
4	9													
5	10													


PANEL: D		LOCATION: SEE PLANS		MAIN: 225A/3P		BUS: 225A		NEMA 1						
VOLTAGE: 208 / 120		AIC RATING: 10000		FEED: BOTTOM		MTG: SURFACE								
PHASE: 3		CIRCUIT CODE:												
WIRE: 4		blank=NON-CONTINUOUS, N=NON-COINCIDENTAL, L=LONG CONTINUOUS, R=RECEPT (NEC ART. 220-44), K=KITCHEN												
NOTE	DESCRIPTION	CODE	BKR	P	#	VA	PHASE	VA	#	P	BKR	CODE	DESCRIPTION	NOTE
	EXHAUST FAN 8,9,10	R	20	1	1	210	A	1464	2	1	20		FAU 1	
	EXHAUST FAN 4,5,6	R	20	1	3	210	B	1464	4	1	20		FAU 2	
	EXHAUST FAN 3	R	20	1	5	53	C	1464	6	1	20		FAU 3	
	EXHAUST FAN 2	R	20	1	7	107	A	1464	8	1	20		FAU 4	
	EXHAUST FAN 1	R	20	1	9	5	B	1464	10	1	20		FAU 5	
	APPARATUS CORD REEL	R	20	2	11	800	C	73	12	1	20		WH-1	
	SUPPLY FAN 1	R	20	1	19	107	A	76	20	1	20		LIGHTING STORAGE	
	APPARATUS CORD REEL	R	20	2	21	800	B		22	1	20		POWER STORAGE	
	-					23			24	1	20		GARAGE DOOR CONTROL	
	DOOR OBSTRUCTION SENSOR	R	20	1	25		A		26	1	20		GARAGE DOOR CONTROL	
	DOOR OBSTRUCTION SENSOR	R	20	1	27		B		28	1	20		EXTERIOR GARAGE RECEP	
	DOOR OBSTRUCTION SENSOR	R	20	1	29		C		30	1	20		SPARE	
	SPARE				31		A		32	1	20		SPARE	
	SPARE				33		B		34	1	20		SPARE	
	SPARE				35		C		36	1	20		SPARE	
	SPARE				37		A		38	1	20		SPARE	
	SPARE				39		B		40	1	20		SPARE	
	SPARE				41		C		42	1	20		SPARE	
	SPARE				43		A		44	1	20		SPARE	
	SPARE				45		B		46	1	20		SPARE	
	SPARE				47		C		48	1	20		SPARE	
POWER LOADS ABOVE - SPLIT-BUS - MECHANICAL LOADS BELOW														
	SPARE				20	1	49	A		50	1	20	SPARE	
	SPARE				20	1	51	B		52	1	20	SPARE	
	SPARE				20	1	53	C		54	1	20	SPARE	
	SPARE				20	1	55	A		56	1	20	SPARE	
	SPARE				20	1	57	B		58	1	20	SPARE	
	SPARE				20	1	59	C		60	1	20	SPARE	
	SPARE				20	1	61	A		62	1	20	SPARE	
	SPARE				20	1	63	B		64	1	20	SPARE	
CONNECTED VA @ A		4696	CONNECTED VA ()		8737	PANEL CONN. AMPS WITH LCL		37.28	PANEL DEMAND KVA WITH LCL		13.43			
CONNECTED VA @ B		4743	CONNECTED VA (L)		0	CONNECTED VA WITH LCL (L)		0	PANEL DEMAND AMPS WITH LCL		37.28			
CONNECTED VA @ C		3990	CONNECTED VA (R)		4692	DEMAND VA (R)		4692	PANEL CONNECTED AMPS		37.28			
TOTAL VA		13429	CONNECTED VA (K)		0	DEMAND VA (K)		0	DEMAND HIGH @ AMPS WITH LCL		39.50			
1	6													
2	7													
3	8													
4	9													
5	10													
SPECIAL NOTES:														

PANEL: A		LOCATION: SEE PLANS				MAIN: 200A/3P		BUS: 200A		NEMA 1				
VOLTAGE: 208 / 120		AIC RATING: 10000				FEED: BOTTOM		MTG: SURFACE						
PHASE: 3		CIRCUIT CODE:												
WIRE: 4		blank=NON-CONTINUOUS, N=NON-COINCIDENTAL, L=LONG CONTINUOUS, R=RECEPT (NEC ART. 220-44), K=KITCHEN												
NOTE	DESCRIPTION	CODE	BKR	P	#	VA	PHASE	VA	#	P	BKR	CODE	DESCRIPTION	NOTE
1a.3	SLEEPING QUARTER 1 REC		20	1	1	720	A	540	2	1	20		HALLWAY 2, MECH RM REC	1h
1a.3	SLEEPING QUARTER 2 REC		20	1	3	720	B	540	4	1	20		STOR 3, PANTRY REC.	1g
1b.3	SLEEPING QUARTER 3 REC		20	1	5	720	C	540	6	1	20		STOR 1, ADA BATH REC.	1g
1b.3	SLEEPING QUARTER 4 REC		20	1	7	720	A		8	1	20		SPARE	
1b.3	SLEEPING QUARTER 5 REC		20	1	9	720	B		10	1	20		SPARE	
1c.3	SLEEPING QUARTER 6 REC		20	1	11	720	C	540	12	1	20		PATIO	
1c.3	SLEEPING QUARTER 7 REC		20	1	13	720	A	900	14	1	20		KITCHEN COUNTER RECEPTS	1n
1c.3	SLEEPING QUARTER 8 REC		20	1	15	720	B	1000	16	1	20		MICROWAVE	1n
4	SLEEPING QUARTER SMK DETECTORS		20	1	17	800	C	1000	18	1	20		MICROWAVE	1n
	BATH 2,3,4 & STOR 2 RECEPTS		20	1	19	540	A	1200	20	1	20		DISHWASHER	1k
	HALLWAY 1 & CU AREA RECEPTS		20	1	21	720	B	1200	22	1	20		DISHWASHER	1k
1d	FITNESS EQUIPMENT 1		20	1	23	1600	C	1130	24	1	20		KITCHEN DISPOSAL	1k
1d	FITNESS EQUIPMENT 2		20	1	25	1600	A	1500	26	1	20		KITCHEN ISLAND RECEPT	
1d	FITNESS EQUIPMENT 3		20	1	27	1600	B	1500	28	1	20		WASHER	
1e	FITNESS EQUIPMENT 4		20	1	29	1600	C	1500	30	1	20		DRYER	
1e	FITNESS EQUIPMENT 5		20	1	31	1600	A	540	32	1	20		HALLWAY 1 BATH 1, LAUNDRY REC	
1e	FITNESS RECEPTS		20	1	33	1080	B	540	34	1	20		SPARE	
	SPARE		20	1	35	1080	C	912	36	1	20		ICE MAKER	
1f	DAY ROOM USB RECEPTS		20	1	37	1080	A	1080	38	1	20		LOCKER RM, APPARTUS, JANITOR	
1f	DAY ROOM RECEPTS		20	1	39	1260	B	500	40	1	20		KITCHEN EXHAUST HOOD	
1f	COFFEE MAKER		20	1	41	1500	C	500	42	1	20		KITCHEN EXHAUST HOOD	
1g	COMM REC		20	1	43	500	A	1000	44	1	20		KITCHEN REF. REC	1m
1g	COMM REC		20	1	45	500	B	1000	46	1	20		KITCHEN REF. REC	1m
1g	COMM REC		20	1	47	500	C	1000	48	1	20		KITCHEN REF. REC	1m
	SPARE		20	1	49		A		50	1	20		SPARE	
	SPARE		20	1	51		B		52	1	20		SPARE	
	SPARE		20	1	53		A		54	1	20		SPARE	
	SPARE		20	1	55		A		56	1	20		SPARE	
	SPARE		20	1	57		B		58	1	20		SPARE	
	SPARE		20	1	59		C		60	1	20		SPARE	
	SPARE		20	1	61		A		62	1	20		SPARE	
	SPARE		20	1	63		B		64	1	20		SPARE	
	SPARE		20	1	65		C		66	1	20		SPARE	
CONNECTED VA @ A		14240	CONNECTED VA (L)		43482	PANEL CONN. AMPS WITH LCL		120.69	PANEL DEMAND KVA WITH LCL		43.48			
CONNECTED VA @ B		13600	CONNECTED VA (L)		0	CONNECTED VA WITH LCL (L)		0	PANEL DEMAND AMPS WITH LCL		120.69			
CONNECTED VA @ C		15642	CONNECTED VA (R)		0	DEMAND VA (R)		0	PANEL CONNECTED AMPS		120.69			
TOTAL VA		43482	CONNECTED VA (K)		0	DEMAND VA (K)		0	DEMAND HIGH @ AMPS WITH LCL		130.25			
SPECIAL NOTES:														
1	PROVIDE LISTED HANDLE-TO DEVICE				5									
2	PROVIDE DEDICATED NEUTRAL				6									
3	PROVIDE AFO TYPE CIRCUIT BREAKER AND				7									
4	TAMPERPROOF SPECIFICATION RECEPTACLES				8									
	PROVIDE CIRCUIT BREAKER LOCK-ON DEVICE				9									

PANEL: B		LOCATION: SEE PLANS		MAIN: 100A/3P		BUS: 125A		NEMA 1						
VOLTAGE: 208 / 120		AIC RATING: 10000		FEED: BOTTOM		MTG: SURFACE								
PHASE: 3		CIRCUIT CODE:												
WIRE: 4		blank=NON-CONTINUOUS, N=NON-COINCIDENTAL, L=LONG CONTINUOUS, R=RECEPT (NEC ART. 220-44), K=KITCHEN												
NOTE	DESCRIPTION	CODE	BKR	P	#	VA	PHASE	VA	#	P	BKR	CODE	DESCRIPTION	NOTE
	LOBBY/LAUNDRY/MECH/COMM./A	L	20	1	1	900	A	900	2	1	20	L	SLEEP QUARTER 4,5,6 LIGHT	
	HALLWAY LIGHTS & EXIT SIGNS	L	20	1	3	900	B	900	4	1	20	L	SLEEP QUARTER 1,2,3 LIGHT	
	LOCKER RM./JANITOR/FSR LTG./E	L	20	1	5	900	C	900	6	1	20	L	BATH 1,2,3,4 & STOR 2	
	APPARATUS LIGHTING	L	20	1	7	900	A	900	8	1	20	L	FITNESS & PATIO LIGHTS	
1	EXTERIOR BUILDING LIGHTS	L	20	1	9	900	B	900	10	1	20	L	DAY ROOM AND KITCHEN LIGHTS	
1	CANNOPY LIGHTING	L	20	1	11	114	C	100	12	1	20	L	BOLLARD & INGROUND LAMP	1
	APPARATUS LIGHTING	L	20	1	19	900	A	20	1	20			IRRIGATION CONTROLLER	
1	SITE POLE LIGHTING	L	20	2	21	1000	B	22	1	20			SPARE	
-					23	1000	C						SPARE	
	SPARE				20	1	25	A	26	1	20		SPARE	
	SPARE				20	1	27	B	28	1	20		SPARE	
	SPARE				20	1	29	C	30	1	20		SPARE	
	SPARE				20	1	31	A	32	1	20		SPARE	
	SPARE				20	1	33	A	34	1	20		SPARE	
	SPARE				20	1	35	B	36	1	20		SPARE	
	SPACE								38				SPACE	
	SPACE								40				SPACE	
	SPACE								42				SPACE	
	CONNECTED VA @ A	4500	CONNECTED VA (L)		1260	PANEL CONN. AMPS WITH LCL		42.96	PANEL DEMAND KVA WITH LCL		15.48			
	CONNECTED VA @ B	4860	CONNECTED VA (L)		11374	CONNECTED VA WITH LCL (L)		14216	PANEL DEMAND AMPS WITH LCL		42.96			
	CONNECTED VA @ C	3274	CONNECTED VA (R)		0	DEMAND VA (R)		0	PANEL CONNECTED AMPS		35.07			
	TOTAL VA	12634	CONNECTED VA (K)		0	DEMAND VA (K)		0	DEMAND HIGH @ AMPS WITH LCL		50.59			
1	CIRCUIT ROUTED THRU TIMELOCK, CONTACTOR OR LCP											SPECIAL NOTES:		
2														
3														
4														
5														
6														
7														
8														
9														
10														

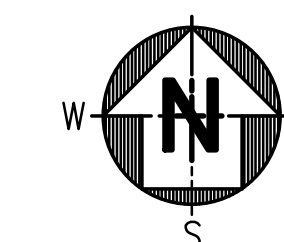


SYMBOL LEGEND

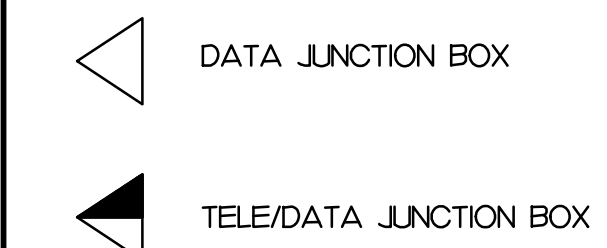

DATA2.1

COMMUNICATIONS PLAN

SCALE:	
3/16"=1'-0"	

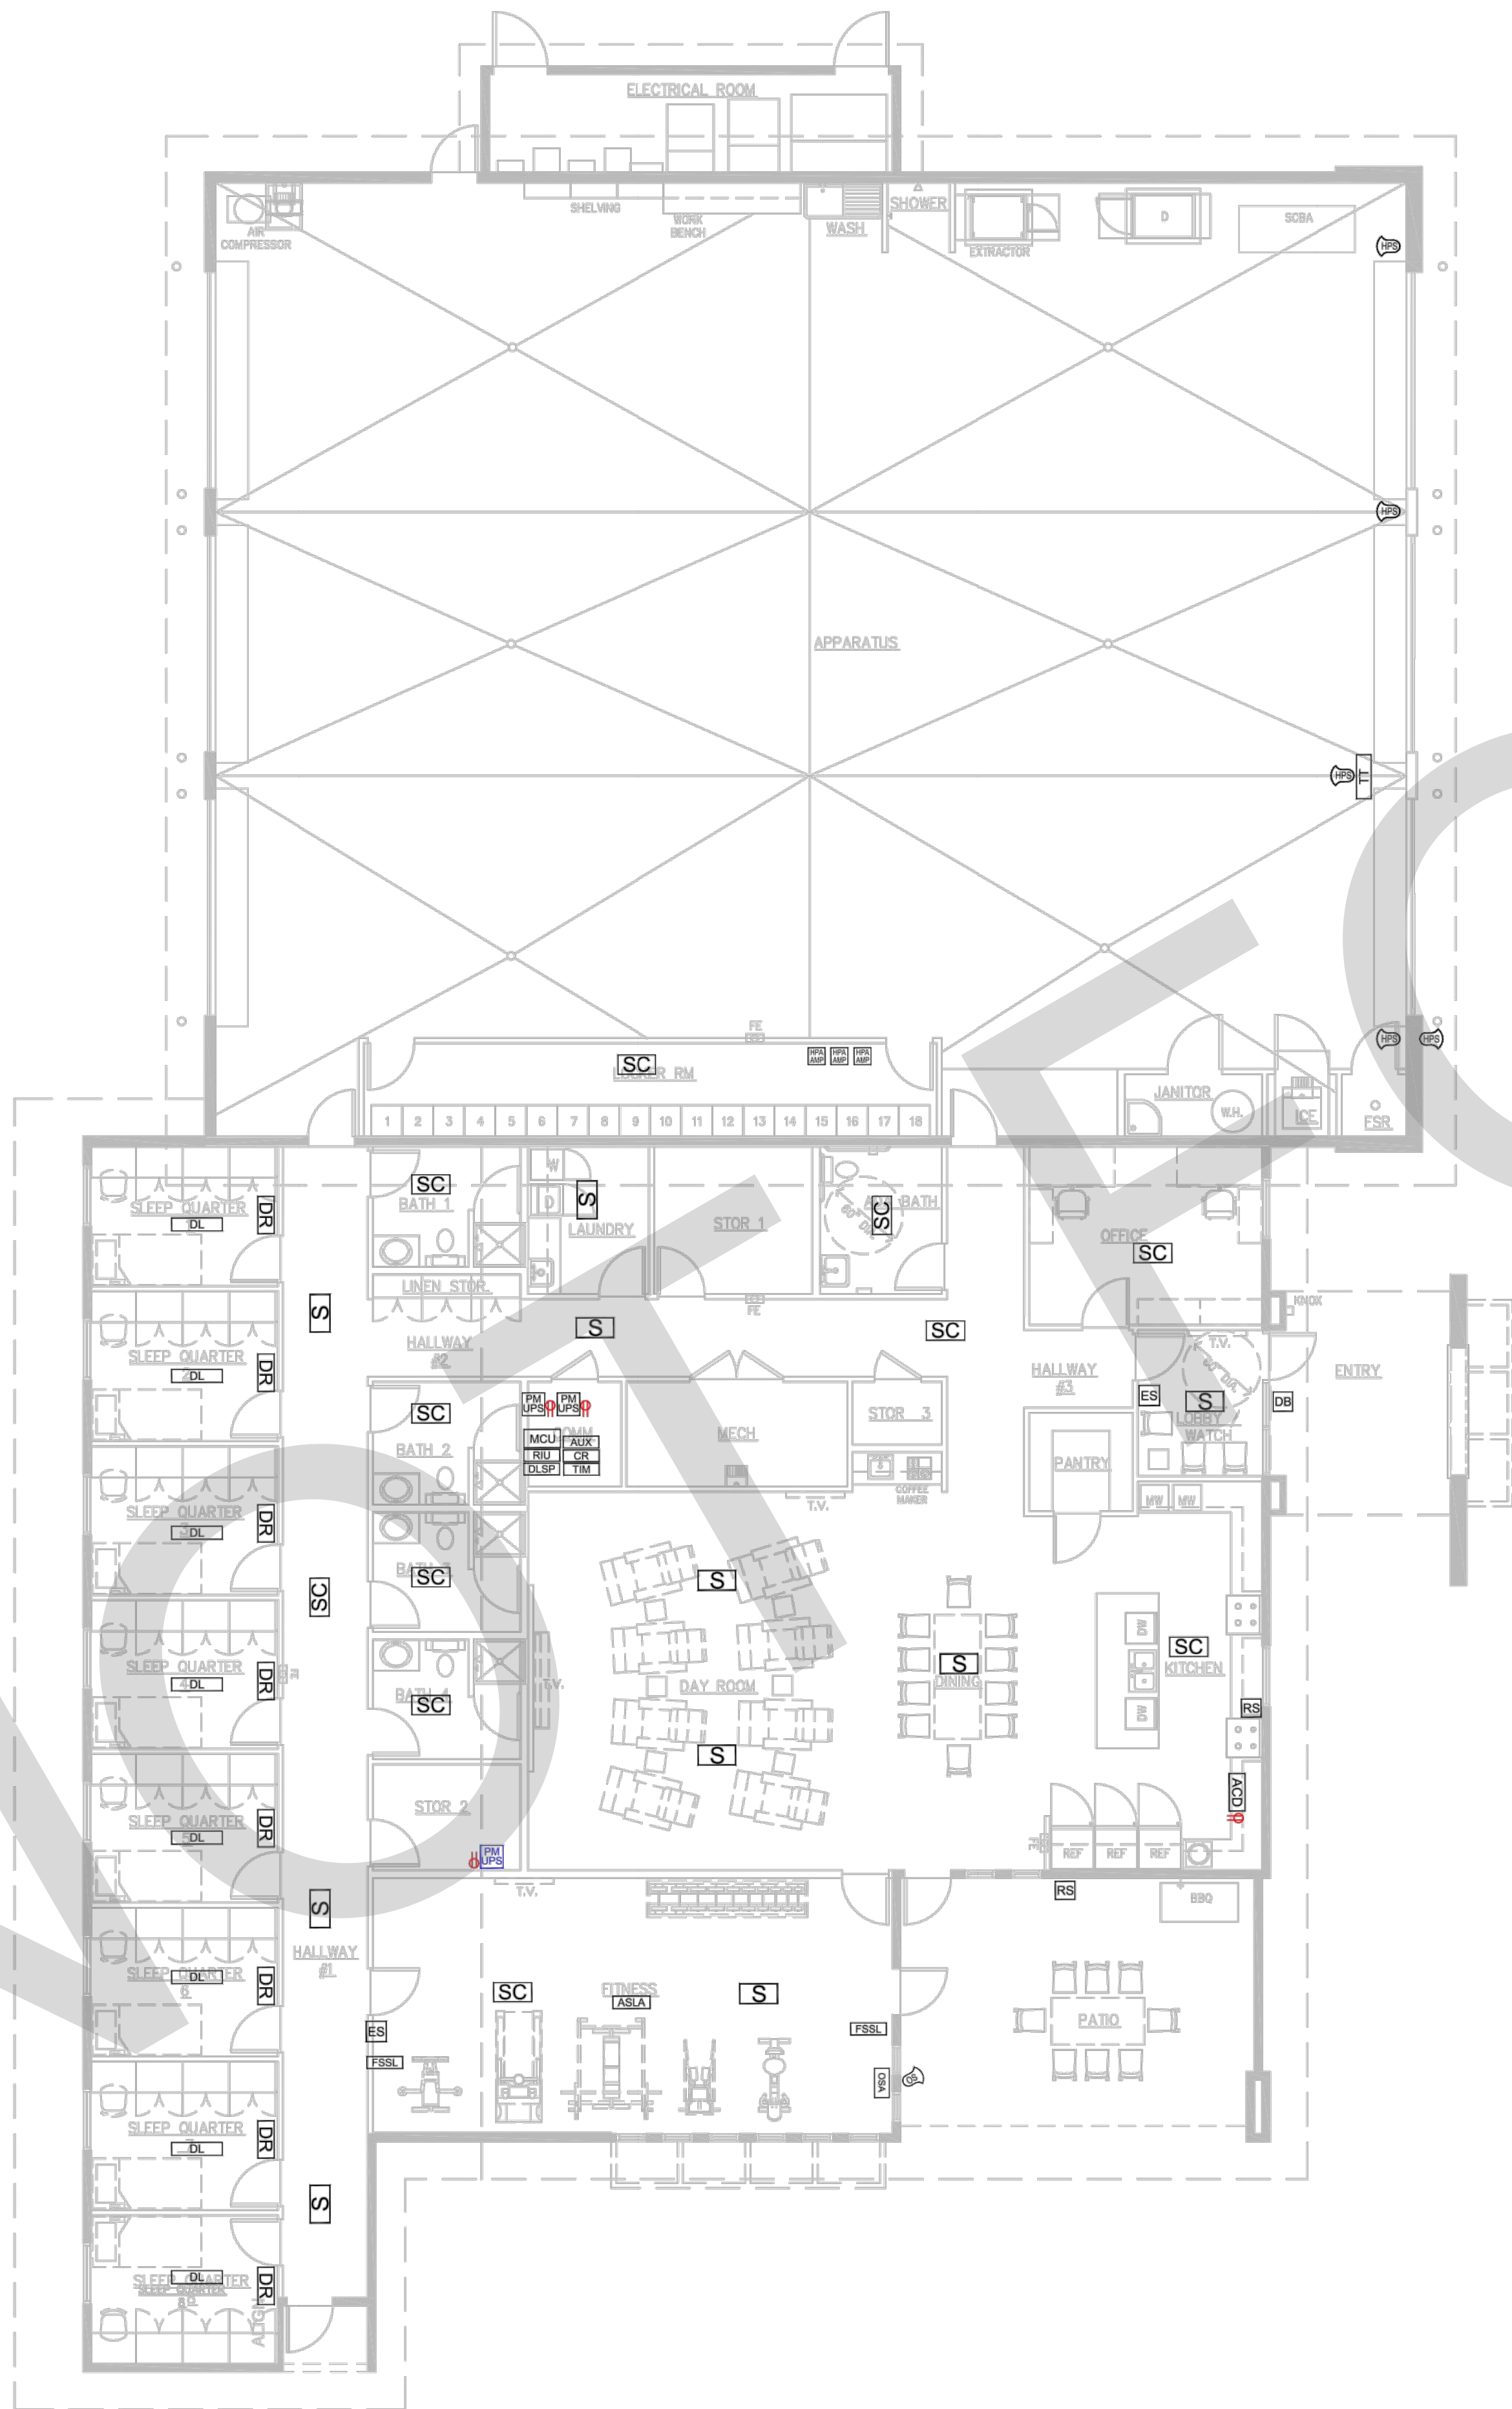

ALERT SYSTEM - DEVICE LAYOUT
SCALE: N.T.S.

FIRST-IN FIRE STATION ALERTING SYMBOL LEGEND	
MCU	MASTER CONTROL UNIT
DLSP	DATA LINE SURGE PROTECTOR
TIM	TELEPHONE INTERFACE MODULE
CR	CONTROL REMOTE
RIU	RADIO ISOLATION UNIT
AUX	AUXILIARY MODULE
PM UPS	POWER MODULE WITH UPS - BLACK (DEDICATED 100V CIRCUIT REQUIRED) EACH PM ON INDIVIDUAL BREAKER
PM UPS	POWER MODULE WITH UPS - BLUE (DEDICATED 120V CIRCUIT REQUIRED) EACH PM ON INDIVIDUAL BREAKER
ACD	APPLIANCE CONTROLLER DEVICE (DEDICATED 150V CIRCUIT REQUIRED)
RS	APPLIANCE RESET SWITCH
SC	SATELLIGHT CONTROLLER
S	SATELLIGHT
FSSL	STROBE LIGHT - IN CONJUNCTION WITH (SCL)
ASLA	ALERTING STROBE LIGHT ADAPTER
DR	DORM REMOTE
DL	DORM LIGHT
CPS	HIGH-POWERED AMPLIFIED SPEAKER
HRA AMP	HIGH-POWERED AMPLIFIER MODULE
OSA	OUTSIDE SPEAKER AUDIO MODULE
OS	OUTSIDE SPEAKER - IN CONJUNCTION WITH (OSA)
TT	TURNOUT TIMER
ES	EMERGENCY SWITCH
DB	DOORBELL BUTTON

- GENERAL NOTES**
- DEVICES ARE TYPICAL AND FOR REFERENCE ONLY.
 - ALL BACK BOXES & CONDUITS ARE TO BE FLUSH MOUNTED UNLESS OTHERWISE SPECIFIED FOR NEW CONSTRUCTION.
 - DEVICES LOCATED IN ACOUSTICAL CEILINGS DO NOT REQUIRE BACKBOXES.
 - DEVICES LOCATED IN ACOUSTICAL CEILINGS REQUIRE ACOUSTICAL WESTNET MOUNTING KIT (SSATKIT-A).
 - DEVICES ONLY LOCATED IN SHEETROCK OR EXPOSED CEILINGS REQUIRE APPROPRIATE WESTNET MOUNTING KIT (SURFACE MOUNT OR FLUSH MOUNT) FOR NEW CONSTRUCTION.
 - LOCATIONS OF DEVICES DETERMINED AT INSTALLATION BY INSTALLER FOR NEW CONSTRUCTION.
 - SEE ARCHITECTURAL SPECIFICATION FOR ALL ROUGH-IN AND INSTALLATION DETAILS FOR NEW CONSTRUCTION.
 - INSTALLER TO VERIFY WALL AND CEILING TYPE TO DETERMINE NEED FOR FLUSH OR SURFACE MOUNT INSTALLATION OF EQUIPMENT SPECIFIED FOR NEW CONSTRUCTION.
 - ALL WIRING AND DEVICES TO BE INSTALLED BY WESTNET.
 - ALL PENETRATION TO EXTERIOR DEVICES MUST BE WEATHERPROOF AND FIRE CAULKED FOR CONSTRUCTION BY OTHERS.
 - DEVICES LOCATED IN BATHROOM/SHOWER AREAS MUST BE VISIBLE FROM SHOWERS. INSTALLER TO FIELD VERIFY DEVICE LOCATION. (TYPICAL)
 - ALL DEVICES MUST BE KEPT CLEAR OF OBSTRUCTIONS & CEILING FAN BLADES.
 - IN ACOUSTICAL CEILING (T-BAR), WIRE CABLEING IS FREE WIRE (NOT IN CONDUIT).
 - IN GYPSUM BOARD CEILING (SHEET ROCK / HARD LID), WIRE CABLEING IN 3/4" CONDUIT UNLESS CONDUIT SIZE OTHERWISE NOTED.
 - IN EXPOSED AREAS ONLY 6X10X4 HOFFMAN BACK BOX MOUNTED AT 4'-0" A.F.F. MAX WITH OPEN FACE DOWN IN CENTER OF ROOM WITH 3/4" CONDUIT TO ACCESSIBLE CEILING SPACE, KEEP CLEAR OF OBSTRUCTIONS.
 - AN INDIVIDUAL GAS CONTROL VALVE IS REQUIRED FOR EACH COOKING APPLIANCE WITH A RESET SWITCH WITHIN 6'-0" FT. OF EACH COOKING APPLIANCE.
 - A 5 OHM EARTH GROUND MUST BE CONNECTED TO THE RADIO ISOLATION UNIT IN THE COMMUNICATION RACK.
 - THE RADIO RECEIVING THE DISPATCH INFORMATION SHALL BE LOCATED WITHIN 6'-0" FT. OF THE RADIO ISOLATION UNIT.
 - INSTALLER TO PROVIDE ONE ADDITIONAL UNCONNECTED BLUE CAT5 CABLE WITH RJ45 CONNECTORS ON BOTH ENDS BETWEEN THE MCU LOCATION AND EACH ALERTING END POINT FOR NETWORK CONNECTIVITY.

WESTNET/FIRST IN SYSTEM LAYOUT REVIEW	
PROJECT: FIRE STATION No. 226	
DEPARTMENT: SAN BERNARDINO COUNTY FIRE DEPARTMENT	
DATE SUBMITTED: 07/27/22	
<input type="checkbox"/> Approved subject to notations and corrections as indicated. — Re-submit corrected Layout for our approval. — Re-submittal of Layout not required. <input type="checkbox"/> Rejected/Re-submit Layout Remarks: _____	
DATE RETURNED: _____	
REVIEWED BY: _____	
DEPT TITLE: _____	
This serves to Certify that this Layout submittal(s) have been reviewed for accuracy and compliance with the general conformance of the design and layout(only) with the Department Contact and/or Contract Documents. ONLY AFTER APPROVAL OF LAYOUT WILL SUBMITTAL INFORMATION AND QUOTES BE AVAILABLE.	
Westnet, Inc. 15542 Chemical Lane Huntington Beach, CA 92649	Phone: (714) 548-3500 Fax: (714) 901-5610 www.FirstInAlerting.com

WESTNET®
15542 CHEMICAL LANE
HUNTINGTON BEACH, CA 92649
TEL: (714) 548-3500 FAX: (714) 901-5610
WWW.FIRSTINALERTING.COM

COPYRIGHT 2022
WESTNET INC.
ALL RIGHTS RESERVED

REV	DATE	BY	REVISION	MAC	MAC
1	06/02/22	MAC	DEVICE LAYOUTS	06/02/22	MAC
2	06/24/22	MAC	DEVICE REVISIONS	06/24/22	MAC
3	07/27/22	MAC	BACKGROUND REVISIONS	07/27/22	MAC





**ALERT
SYSTEM**

**FIRE STATION No. 226
SAN BERNARDINO COUNTY
FIRE DEPARTMENT
1920 DEL ROSA AVE N.
SAN BERNARDINO, CA 92404**

PROJECT NAME:
NOTE:
IF THIS SCALE IS NOT 1" = 10'
THIS SHEET IS NOT TO SCALE.
PROJECT START DATE:
DRAWN BY: MAC
SCALE: N.T.S.
TITLE: LAYOUT LAYOUT
SHEET

AS1.1

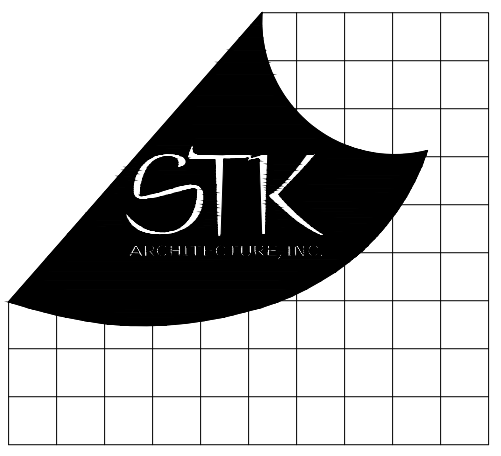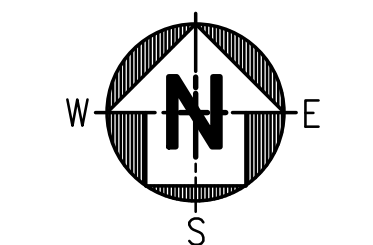

4205 ZEVIO DR., TEMECULA, CALIFORNIA 92590-3701
Phone: 951.296.8110 Fax: 951.296.6079 Email: stk@stkinc.com

CONSULTANT:

PROJECT ADMINISTERED BY:
SAN BERNARDINO COUNTY
PROJECT & FACILITIES
MANAGEMENT DEPARTMENT

385 N. ARROWHEAD AVE.
SAN BERNARDINO, CA 92415

PROJECT NAME:
SAN BERNARDINO
COUNTY FIRE
DEPARTMENT:
FIRE STATION 226

PROJECT # 10101032
CIP #21-037
CAFM # SABI98
APN # 0273-011-22

1920 DEL ROSA AVE N.
SAN BERNARDINO,
CA 92404

ISSUE INFORMATION:	
DATE:	INFORMATION:
04-11-2022	20% CD SET
04-28-2022	50% CD SET
06-05-2022	95% CD SET
09-16-2022	95% CD- 3rd BAY
10-03-2022	PLAN CHECK

SHEET INFORMATION:
STK PROJECT NO.: 374-154-21
SCALE: AS NOTED
DATE: JANUARY 2021
PLOT DATE:
DRAWING NAME:

SEAL:



SHEET TITLE:

**FIRE ALERT
SYSTEM**

SHEET NO.:

DATA2.2