
		GENERAL NOTES:	
1	1.	ALL WORK SHALL BE IN ACCORDANCE WITH COUNTY OF SAN BERNARDINO MUNICIPAL CODE, THE STANDARD SPECIFICATIONS FOR PUBLIC WORKS CONSTRUCTION (GREEN BOOK) LATEST EDITION, AND ALL SUPPLEMENTS. THE PRELIMINARY SOILS REPORT DATED AND ANY SPECIAL REQUIREMENTS OF THE PERMIT.	
	2.	APPROVAL OF THIS PLAN DOES NOT CONSTITUTE A REPRESENTATION AS TO THE ACCURACY OF THE LOCATION OR OF THE EXISTENCE OR NON-EXISTENCE OF ANY UNDERGROUND UTILITY PIPE OR STRUCTURE WITHIN THE LIMITS OF THIS PROJECT. THE CONTRACTOR SHALL ASSUME FULL RESPONSIBILITY FOR THE PROTECTION OF ALL UTILITIES WITHIN THE LIMITS OF THIS PROJECT.	
	3.	DUST SHALL BE CONTROLLED BY WATERING.	$\langle \langle \rangle$
4	4.	FINISH GRADING WILL BE COMPLETED AND APPROVED BEFORE PLACEMENT OF EQUIPMENT.	395
Ę	5.	PUBLIC STREETS SHALL BE KEPT CLEAN AND FREE FROM DIRT AND/OR DEBRIS. THE CONTRACTOR SHALL BE RESPONSIBLE FOR ALL COSTS INCURRED IN STREET CLEANING NECESSITATED BY HIS OPERATION.	
6	6.	NO GRADING IN EXCESS OF 5,000 CY SHALL BE STARTED WITHOUT FIRST NOTIFYING THE ENGINEER. A PRE-GRADING MEETING AT THE SITE IS REQUIRED BEFORE THE START OF GRADING WITH THE FOLLOWING PEOPLE PRESENT: OWNER, GRADING CONTRACTOR, SUPERVISING CIVIL ENGINEER, SOILS ENGINEER AND/OR GEOLOGIST,	
-	7.	NO FILL TO BE PLACED UNTIL STRIPPING OF VEGETATION, REMOVAL OF UNSUITABLE SOILS AND INSTALLATION OF SUB-DRAINS, IF ANY, HAS BEEN INSPECTED AND APPROVED BY THE SOILS ENGINEER.	
8	8.	NO ROCK OR SIMILAR MATERIAL GREATER THAN 6" IN DIAMETER WILL BE PLACED IN THE FILL UNLESS RECOMMENDATIONS FOR SUCH PLACEMENT HAVING BEEN SUBMITTED BY THE SOILS ENGINEER.	
ę	9.	ALL EXISTING FILLS SHALL BE APPROVED BY THE SOILS ENGINEER OR REMOVED BEFORE ANY ADDITIONAL FILLS ARE ADDED.	
1	10.	FILLS SHALL BE BENCHED IN COMPETENT MATERIAL AS REQUIRED IN SOILS REPORT.	
		AREAS TO RECEIVE FILL SHALL BE PROPERLY PREPARED AND APPROVED BY THE SOILS ENGINEER PRIOR TO THE PLACING OF FILL.	
		THE CONTRACTOR SHALL COMPLY WITH THE GRADING CODE REQUIREMENTS WHEN AN EXCESS OF 1,000 CY IS MOVED ON PUBLIC ROADWAYS FROM THE SITE OF AN EARTH GRADING OPERATION. (15.04–210, 5.04.545, 15.38)	395
1	13.	THE SOILS ENGINEER SHALL BE RESPONSIBLE FOR THE OBSERVATION AND APPROVAL CONCERNING THE PREPARATION OF GROUND TO RECEIVE FILLS, TESTING FOR REQUIRED COMPACTION, STABILITY OF ALL FINISH SLOPES AND THE DESIGN OF BUTTRESS FILLS, WHERE REQUIRED, INCORPORATING DATA SUPPLIED BY THE ENGINEERING GEOLOGIST AND INSURE COMPLIANCE WITH THE PLANS, SPECIFICATIONS, AND CODE WITHIN THEIR PURVIEW.	
1	14.	THE DESIGN CIVIL ENGINEER SHALL EXERCISE SUFFICIENT SUPERVISORY CONTROL DURING GRADING AND CONSTRUCTION TO INSURE COMPLIANCE WITH THE PLANS, SPECIFICATIONS, AND CODE WITHIN HIS PURVIEW.	
1	15.	SANITARY FACILITIES SHALL BE MAINTAINED ON THE SITE.	
1	16.	THE LOCATION AND PROTECTION OF ALL UTILITIES IS THE RESPONSIBILITY OF THE CONTRACTOR.	
1	17.	EXPORT SOIL MUST BE TRANSPORTED TO A LEGAL DUMP SITE.	
1	18.	IN THE EVENT THAT SOIL CONTAMINATION IS DISCOVERED DURING EXCAVATION, WORK SHALL BE STOPPED UNTIL A SITE ASSESSMENT AND MITIGATION PLAN HAS BEEN PREPARED, SUBMITTED AND APPROVED BY HCA/ENVIRONMENTAL HEALTH.	EDWARDS AIR FORCE BASE HELEND
1	19.	THE CONTRACTOR SHALL KEEP EACH EXISTING FUEL SERVICE SITE IN OPERATION AS LONG AS POSSIBLE. GOAL IS 2-3 WORKING DAYS, PER SITE.	
	20.	PROPOSED PAVEMENT TO BE PLACED TO MATCH EXISTING SURFACE FLOW DRAINAGE	
		PATTERN. (AC/AB AT 1.5% MIN.) (PCC AT 0.5% MIN.)	395
		PLACE ELECTRICAL CONDUITS IN SLAB AT TANK LOCATIONS.	
4	۷۷.	INSTALLATION CONFIGURATION TO MATCH EXISTING BALDY MESA FUEL SITE (LOCATED AT 12394 SYCAMORE ST. VICTORVILLE, CA 92392)	
2	23.	ALL NEW TANKS TO BE CONNECTED TO EMERGENCY GENERATOR	
			(18)
	<u>U</u>	NAUTHORIZED CHANGES AND USES	
		<u>AUTION:</u> IE ENGINEER PREPARING THESE PLANS WILL NOT BE RESPONSIBLE FOR	138
	ΤH	IAUTHORIZED CHANGES TO OR USE OF THESE PLANS. ALL CHANGES TO IE PLANS MUST BE IN WRITING AND MUST BE APPROVED BY THE	138
	PR	EPARER OF THESE PLANS.	
	LI	ABILITY FOR UNDERGROUND STRUCTURES	215
	AV INF	L UNDERGROUND UTILITIES SHOWN ON THE PLANS WERE OBTAINED FROM A REVIEW OF AILABLE RECORD DATA, WHILE DUE CARE WAS TAKEN IN PREPARATION OF THIS FORMATION, THE ENGINEER CANNOT AND DOES NOT GUARANTEE THE ACCURACY OR	21
	IT	MPLETENESS OF THE INFORMATION. SHALL BE THE RESPONSIBILITY AND LIABILITY OF THE CONTRACTOR TO DETERMINE THE INSTENCE OF NON EXISTENCE OF SUCH LITUITIES AND TO PROTECT THEM IN PLACE	FONTANA
	IN	ISTENCE OR NON-EXISTENCE OF SUCH UTILITIES AND TO PROTECT THEM IN PLACE. THE EVENT UNKNOWN UTILITIES OR UNKNOWN STRUCTURES ARE FOUND, OR KNOWN CULTIES ARE FOUND DURING CONSTRUCTION AT UNEXPECTED FLEVATIONS OR	
	LO	CILITIES ARE FOUND DURING CONSTRUCTION AT UNEXPECTED ELEVATIONS OR CATIONS, THE ENGINEER IS TO BE NOTIFIED OF SUCH CONDITIONS AT ONCE. THE IGINEER WILL MAKE ANY REQUIRED DESIGN CHANGES AND THE CONTRACTOR AGREES	60 60
	ТО	COMPLETE THE WORK INCLUDING REPAIRS REQUIRED IN AN EXPEDITIOUS MANNER.	
	FO IN(	R JOB SITE CONDITIONS DURING THE COURSE OF CONSTRUCTION OF THIS PROJECT CLUDING SAFETY OF ALL PERSONS AND PROPERTY: THAT THIS REQUIREMENT SHALL	
	PS	PLY CONTINUOUSLY AND NOT BE LIMITED TO NORMAL WORKING HOURS. COMAS IS NOT RESPONSIBLE FOR ANY INFORMATION SHOWN ON THIS DRAWING	91
	ЧK	ROVIDED BY OTHERS.	· - \

# TRONA

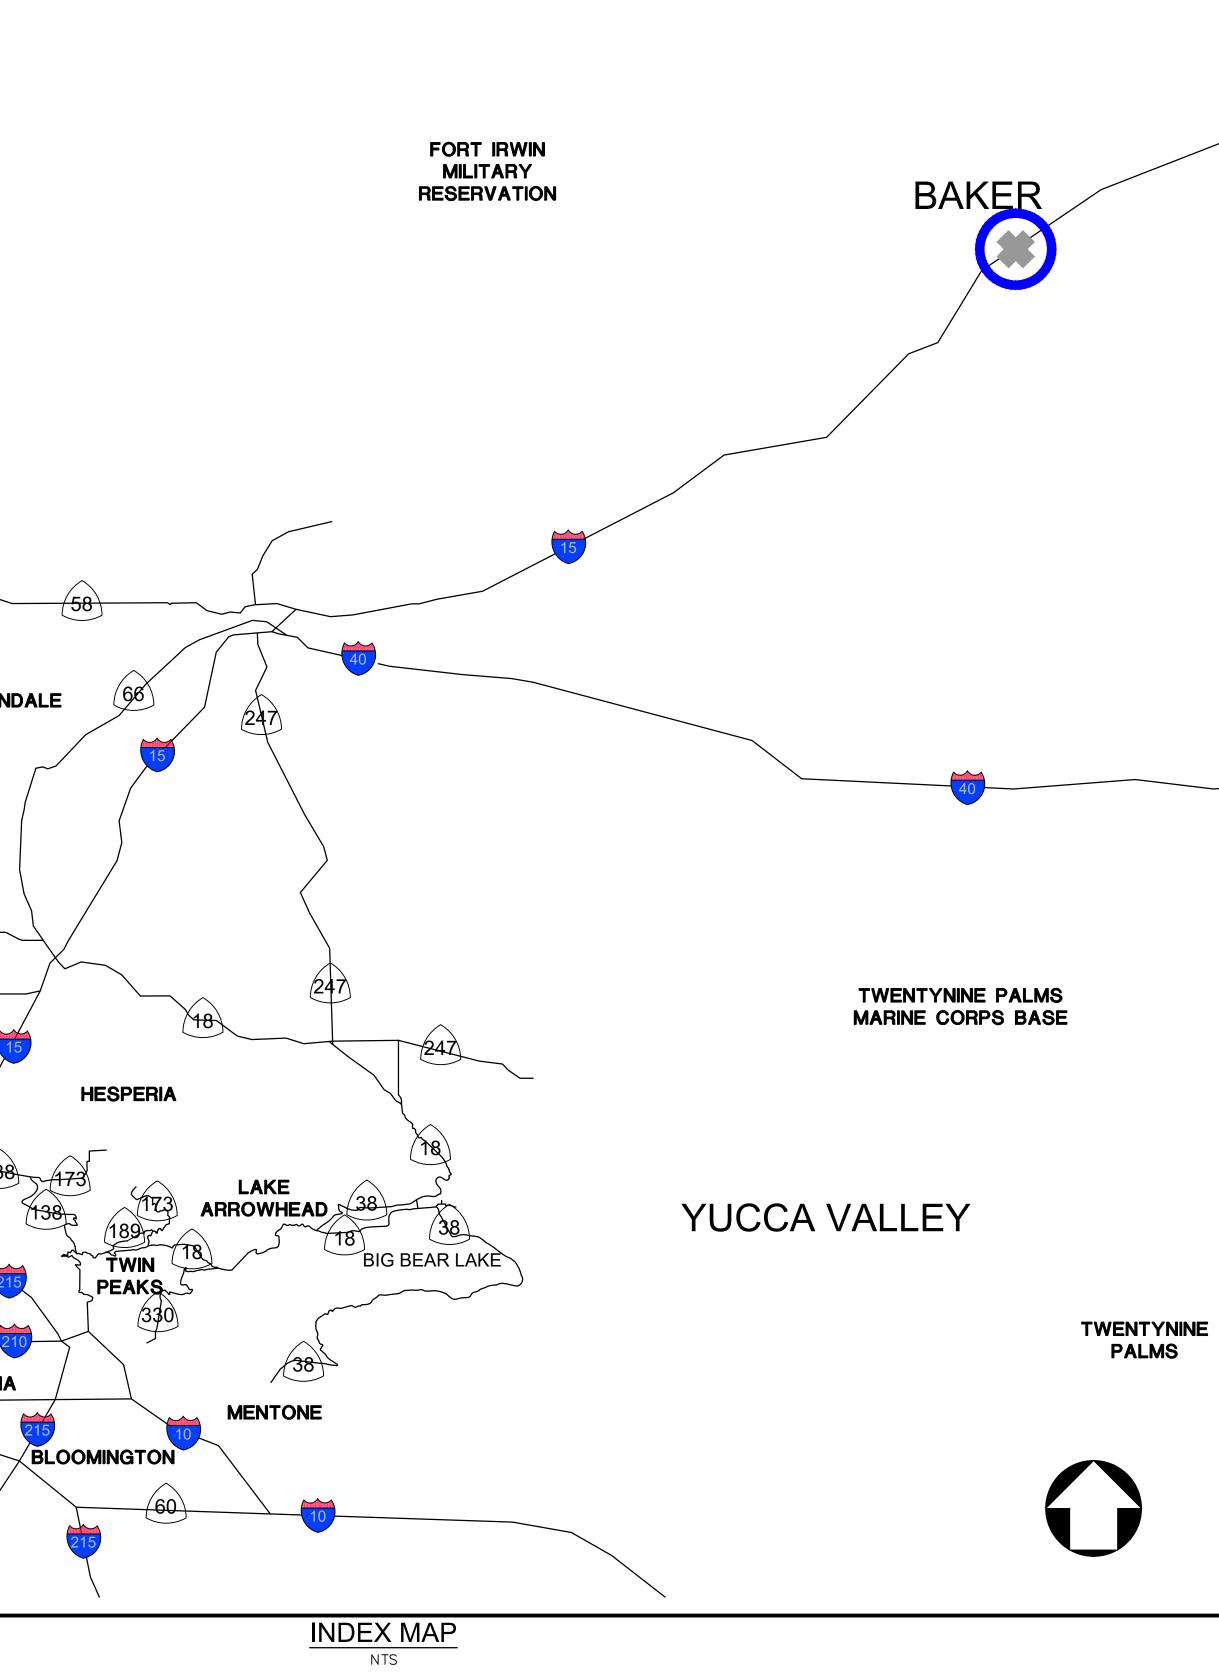

### LEGEND



EXISTING FUEL SITE

### SHEET INDEX:

SHT. <u>NO.</u>	DWG. <u>NO.</u>	<u>SHEET</u>	SITE <u>NO.</u>	REGION	<u>SITE</u>	<u>CITY</u>
01	0.10	TITLE SHEET				
02	0.20	CONSTRUCTION NOT	E MATRIX			
03	1.10	PRECISE GRADING PI	LAN	BAKER	Baker Blvd.	Baker
04	2.10	TANK LAYOUTS				
05	2.11	TANK DETAILS				
06	2.12	TANK DETAILS				
07	2.13	TANK LAYOUT DETAIL	LS			
08	2.14	SITE DETAILS				
09	E0.01	ELECTRICAL COVER	SHEET			
10	E1.00	SITE LAYOUT PLAN		BAKER	Baker Blvd.	Baker
11	E1.01	ELECTRICAL DETAILS	3			

### NOTICE TO CONTRACTOR FOR COUNTY PERMITS: COUNTY PERMIT

- A. AN ENCROACHMENT PERMIT FROM THE COUNTY OF SAN BERNARDINO WILL BE REQUIRED FOR WORK IN COUNTY RIGHT-OF-WAY.
- B. CONTRACTOR SHALL PAY ANY FEES.
- C. COUNTY SHALL BE LISTED AS CO-APPLICANT. CONTRACTOR SHALL SUBMIT OF PROOF OF INSURANCE, AND PAYMENT OF PERMIT FEE.D. CONTRACTOR SHALL BE RESPONSIBLE FOR MAINTAINING
- ENCROACHMENT PERMIT IN FORCE, TRACKING EXPIRATION DATES, AND APPLYING FOR PERMIT RENEWALS AND EXTENSIONS AS NEEDED.

### COUNTY OF SAN BERNARDINO FIRE DEPARTMENT PERMIT

- A. A PERMIT FROM COUNTY OF SAN BERNARDINO FIRE DEPARTMENT WILL BE REQUIRED FOR WORK RELATED TO THE INSTALLATION OF FUEL TANKS
- B. CONTRACTOR SHALL PAY ANY FEES.
- C. COUNTY SHALL BE LISTED AS CO-APPLICANT. CONTRACTOR SHALL SUBMIT OF PROOF OF INSURANCE, AND PAYMENT OF PERMIT FEE.
  D. CONTRACTOR SHALL BE RESPONSIBLE FOR MAINTAINING PERMIT IN FORCE, TRACKING EXPIRATION DATES, AND APPLYING FOR PERMIT RENEWALS AND EXTENSIONS AS NEEDED.

DEMOLITION / STAGING OF EXISTING TANKS / NOTES: AFTER NEW WORK IS COMPLETED AND ACCEPTED:

A. COUNTY WILL EMPTY FUEL TANKS.
B. CONTRACTOR WILL REMOVE/RELOCATE FUEL TANKS TO AN UNUSED AREA ON PROPERTY.
C. CONTRACTOR WILL REMOVE FUEL PADS AND REPAIR PAVEMENT AND PATCH TO MATCH EXISTING SITE CONDITIONS.
D. COUNTY WILL CLEAN AND SCRAP EMPTY FUEL TANKS.

# **100% CONSTRUCTION DOCUMENTS**



# COUNTY OF SAN BERNARDINO

ARCHITECTURE & ENGINEERING DEPARTMENT

385 NORTH ARROWHEAD AVENUE SAN BERNARDINO, CA 92415-0184

Project Title: BAKER FUEL SITE

CIP NUMBER:

Project No: 2SAN020200

Project Address: **Fire Station 53** 72734 Baker Blvd. Baker CA 92309



Santa Ana, CA 92707 (714) 751—7373 Fax(714) 545—8883



No.	REVISION	DATE

Drawing Title:

PRECISE GRADING PLAN

### TITLE SHEET INDEX MAP, NOTES

Revision Date:	
Scale:	
Drawn By:	MS
Reviewd By:	HN
Date:	12/18/19
Drawing Size:	24 x 36
Drawing Numbe	r

0.10

01 of 11 Sheets


# CONSTRUCTION NOTE

NOTE: THIS IS BEING BID AS LUMP SUMP SO UNIT QUANTITIES ARE PROVIDED FOR REFERENCE ONL


CONCINCIENTION

NOTE	CONSTRUCTION ITEM:
1	PROTECT IN PLACE (ITEMS NOTED)
2	INSTALL FUEL TANK PER DETAIL 2 ON SHT 5
2B	INSTALL TANK ACCESSORIES PER DETAIL 2B ON SHT 5
2C	INSTALL RUNG LADDER AND 3'X 18'PLATFORM THAT EXTENDS TO BOTH ENDS OF EACH FUE
2D	INSTALL TANK PUMP (FILL-RITE) PER DETAIL 2D ON SHT 6
2E	INSTALL 2" TANK VALVE (MORRISON) PER DETAIL 2E ON SHT 6
3	INSTALL FUEL TANKS LAYOUT PER DETAIL 3 ON SHT. 4
4	INSTALL RELIANCE S1 DISPENSER PER DETAIL 4 ON SHT. 5
5	CONSTRUCT 10" PCC CONCRETE PAVEMENT PER DETAIL 5 ON SHT. 7
6	CONSTRUCTION 6" CONTAINMENT CURB (TYPE A1-6) PER APWA STD. PLAN 120-2. SEE DET
7	INSTALL BOLLARD PER DETAIL 7 ON SHT. 7
8	NOT USED
9	NOT USED
(10)	CONSTRUCT 30-FEET WIDE DRIVEWAY APPROACH PER SAN BERNARDINO COUNTY STD. DWG.
(11)	INSTALL SLIDING GATE LAYOUT PER DETAIL 11 ON SHT. 8
(12)	INSTALL SENSOR LOOP FOR GATE EXIT AREAS TO BE PROVIDED BY CONTRACTOR. SEE GATE
(13)	INSTALL WIRING AND CONDUIT FOR CARD READER BY CONTRACTOR. CARD READER AND PE SEE GATE DETAIL 13 ON SHT. 8
(14)	INSTALL CHAIN LINK FENCE PER DETAIL 14 ON SHT. 8
(15)	INSTALL ACCESS GATE – CHAIN LINK PER DETAIL 15 ON SHT. 8
(16)	INSTALL FILTRATION BASIN USING 3/4" GRAVEL WITH GEOFABRIC PER DETAIL 16 ON SHT. 7
(17)	INSTALL 4" PVC STORM DRAIN PIPE (MINIMUM SLOPE OF 0.5%). REMOVE CONFLICTING EXISTI
(18)	CONSTRUCT REDWOOD HEADER

	COUNTY OF SAN BERNARDINO ARCHITECTURE & ENGINEERING DEPARTMENT 385 NORTH ARROWHEAD AVENUE SAN BERNARDINO, CA 92415-0184 Project Title: BAKER FUEL SITE CIP NUMBER: Project No: 2SAN020200 Project Address: Fire Station 53 72734 Baker Bivd. Baker CA 92309 Project Address: Fire Station 53 72734 Baker Bivd. Baker CA 92309					
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	928	SF				
AIL 6 ON SHT. 7	126	LF				
	11	EA				
	_	_	No.	RE\	/ISION	DATE
129A AND DETAIL 10 ON SHT. 8	- 378	SF				
	2	EA				
DETAIL 12 ON SHT. 8	2	EA				
ESTAL TO BE PROVIDED BY OWNER.	2	EA				
	181	LF				
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	1	EA		ring Title:		
IG STORM DRAIN PIPE.	78	LF	PR	RECISE	GRADING F	'LAN
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100% CONSTRUC	TION DOC	UMENTS			<b>).20</b> 02 of 11 St	neets

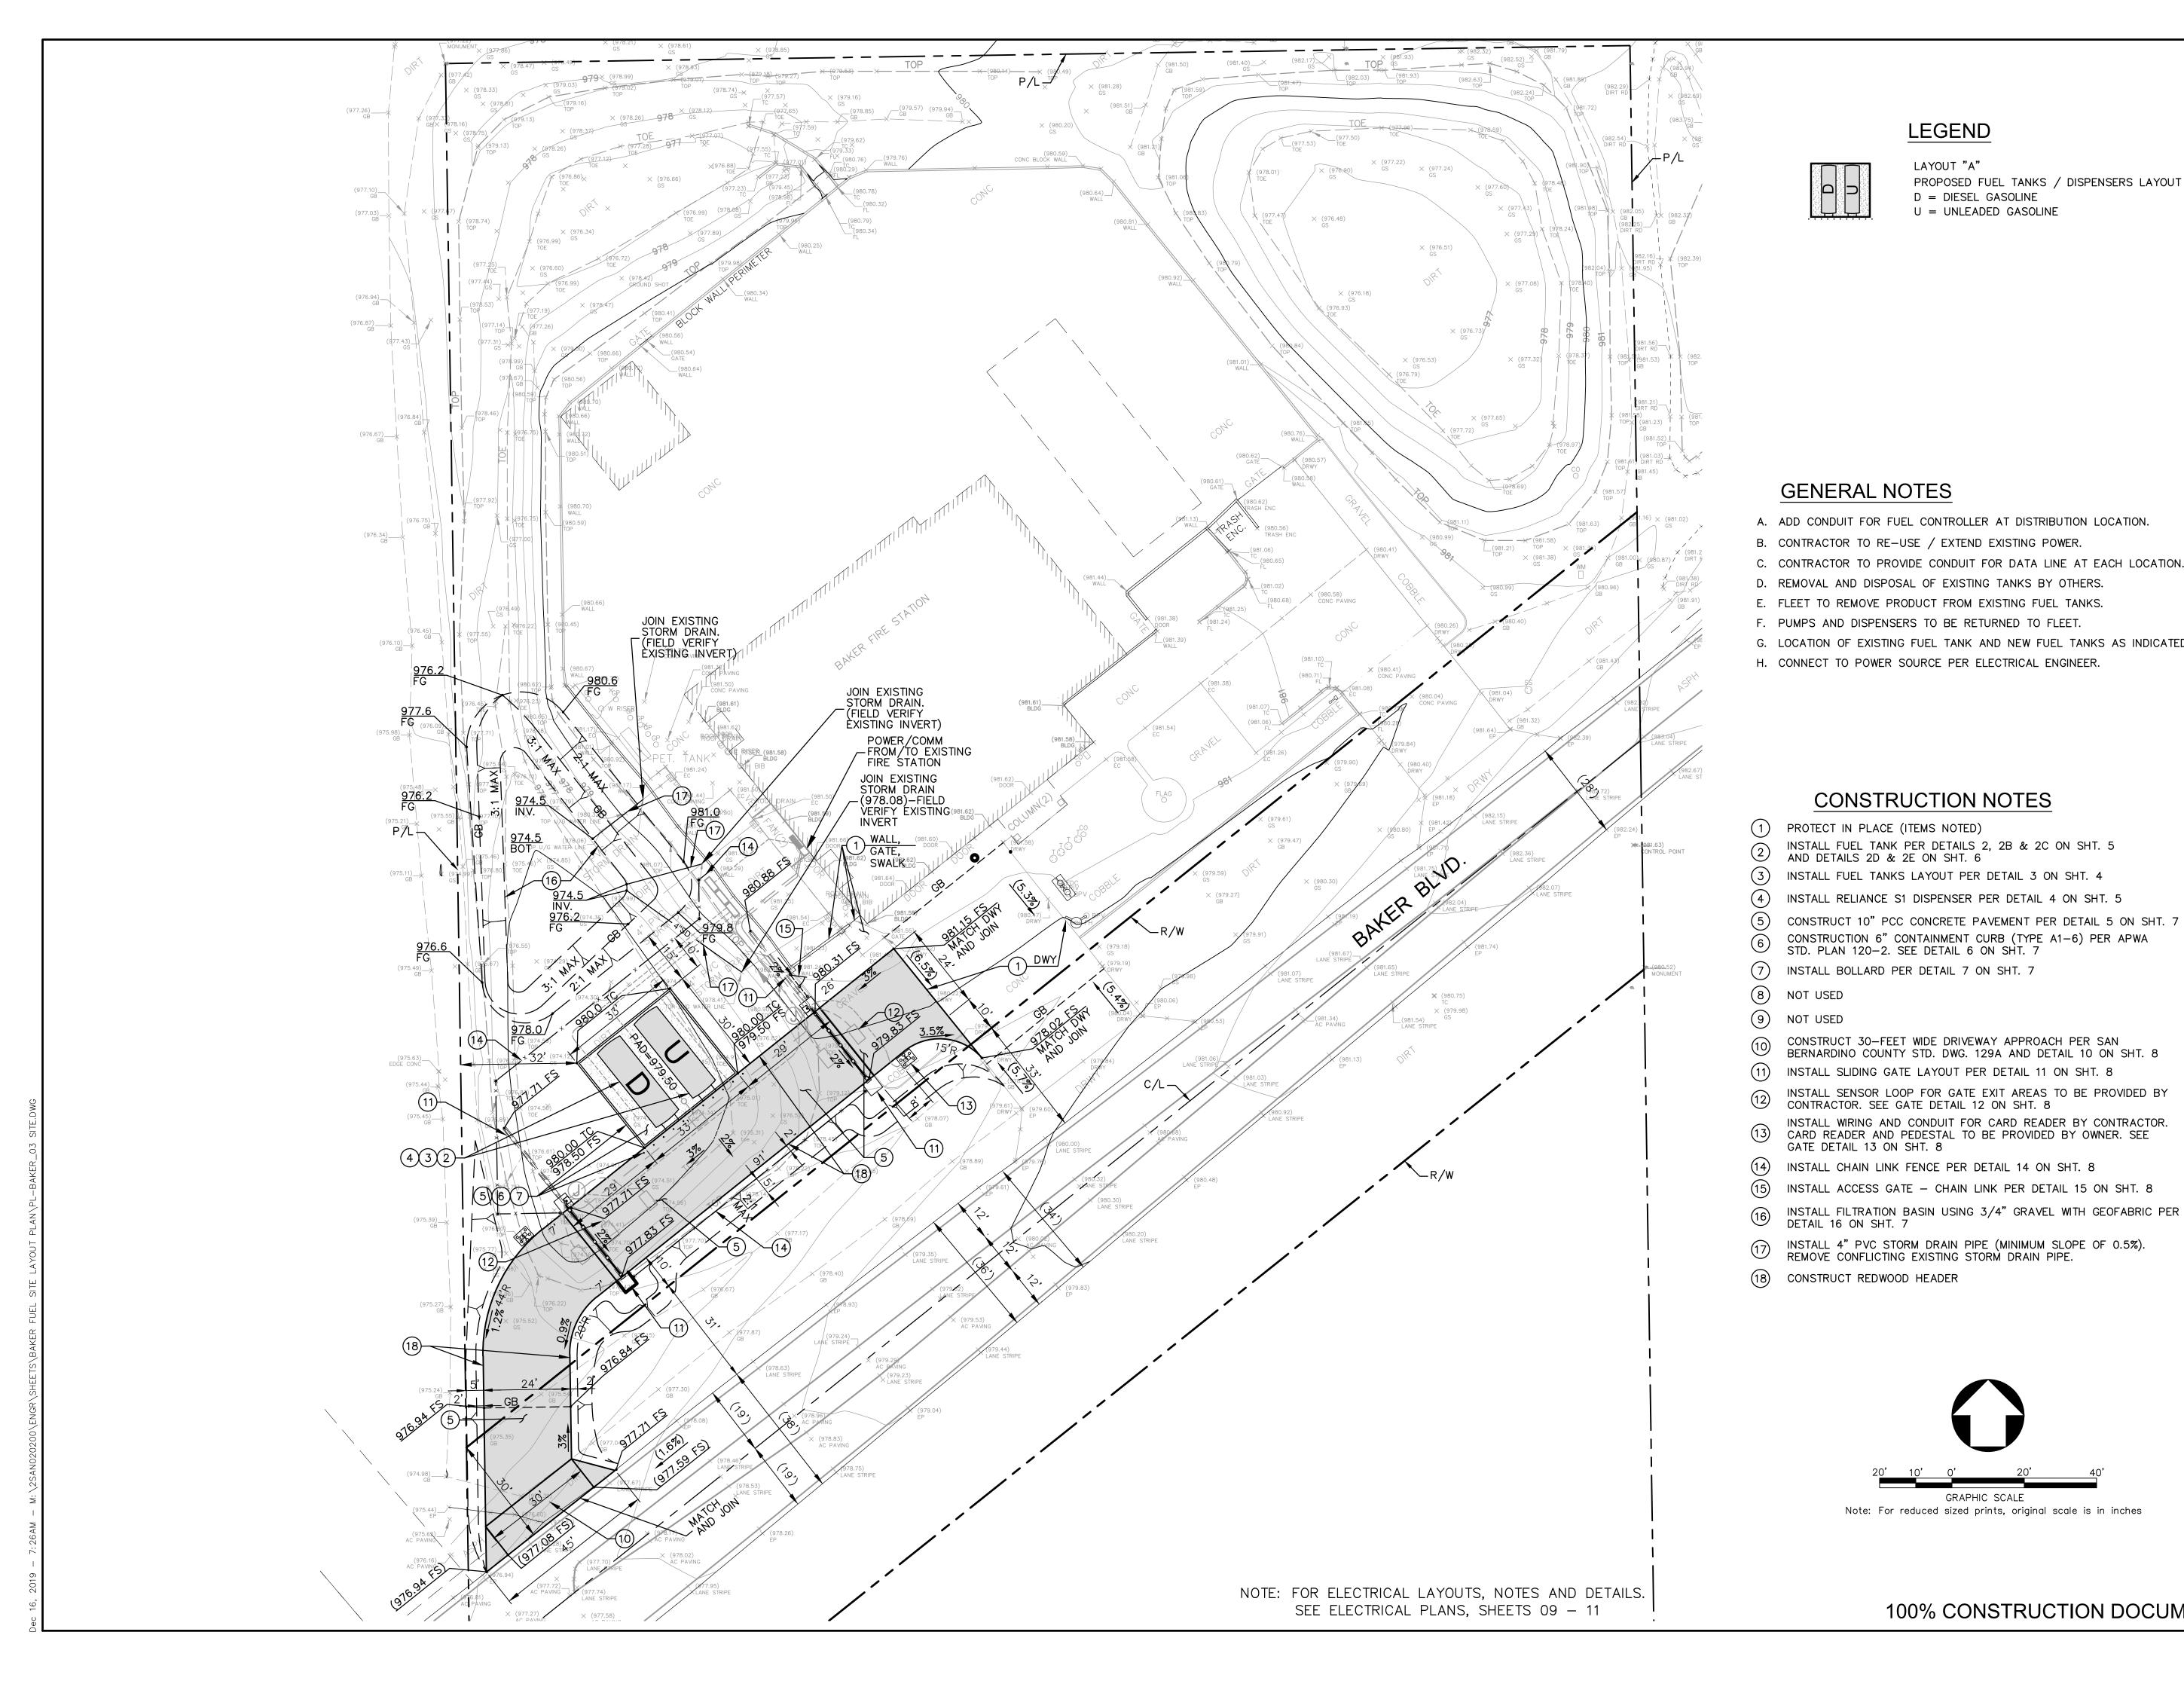

# LEGEND

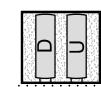

LAYOUT "A" PROPOSED FUEL TANKS / DISPENSERS LAYOUT D = DIESEL GASOLINEU = UNLEADED GASOLINE



# COUNTY OF SAN BERNARDINO

**ARCHITECTURE &** ENGINEERING DEPARTMENT

385 NORTH ARROWHEAD AVENUE SAN BERNARDINO, CA 92415-0184

Project Title: BAKER FUEL SITE

CIP NUMBER:

Project No: 2SAN020200


Project Address: Fire Station 53 72734 Baker Blvd. Baker CA 92309

Ρ	S	0	Μ	Α	S

3 Hutton Centre Drive				
Suite 200				
Santa Ana, CA 92707				
(714) 751–7373 Fax(714) 545–8883				



No.	REVISION	DATE

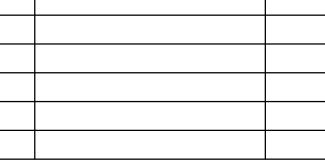

Drawing Title:

# PRECISE GRADING PLAN

# PRECISE GRADING PLAN

Revision Date:		
Scale:	1" = 20'	
Drawn By:	MS	
Reviewd By:	HN	
Date:	12/18/19	
Drawing Size:	24 x 36	
Drawing Number		

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03 of 11 Sheets

**100% CONSTRUCTION DOCUMENTS** 


D. REMOVAL AND DISPOSAL OF EXISTING TANKS BY OTHERS. E. FLEET TO REMOVE PRODUCT FROM EXISTING FUEL TANKS.

GENERAL NOTES


- F. PUMPS AND DISPENSERS TO BE RETURNED TO FLEET.
- G. LOCATION OF EXISTING FUEL TANK AND NEW FUEL TANKS AS INDICATED.
- H. CONNECT TO POWER SOURCE PER ELECTRICAL ENGINEER.

# CONSTRUCTION NOTES

- PROTECT IN PLACE (ITEMS NOTED)
- INSTALL FUEL TANK PER DETAILS 2, 2B & 2C ON SHT. 5 AND DETAILS 2D & 2E ON SHT. 6
- (3) INSTALL FUEL TANKS LAYOUT PER DETAIL 3 ON SHT. 4
- (4) INSTALL RELIANCE S1 DISPENSER PER DETAIL 4 ON SHT. 5
- (5) CONSTRUCT 10" PCC CONCRETE PAVEMENT PER DETAIL 5 ON SHT. 7
- CONSTRUCTION 6" CONTAINMENT CURB (TYPE A1–6) PER APWA STD. PLAN 120–2. SEE DETAIL 6 ON SHT. 7
- INSTALL BOLLARD PER DETAIL 7 ON SHT. 7
- 8 NOT USED
- 9 NOT USED
- CONSTRUCT 30-FEET WIDE DRIVEWAY APPROACH PER SAN BERNARDINO COUNTY STD. DWG. 129A AND DETAIL 10 ON SHT. 8
- INSTALL SLIDING GATE LAYOUT PER DETAIL 11 ON SHT. 8
- INSTALL SENSOR LOOP FOR GATE EXIT AREAS TO BE PROVIDED BY CONTRACTOR. SEE GATE DETAIL 12 ON SHT. 8
- INSTALL WIRING AND CONDUIT FOR CARD READER BY CONTRACTOR. CARD READER AND PEDESTAL TO BE PROVIDED BY OWNER. SEE GATE DETAIL 13 ON SHT. 8 (13)
- (14) INSTALL CHAIN LINK FENCE PER DETAIL 14 ON SHT. 8
- INSTALL ACCESS GATE CHAIN LINK PER DETAIL 15 ON SHT. 8
- INSTALL FILTRATION BASIN USING 3/4" GRAVEL WITH GEOFABRIC PER DETAIL 16 ON SHT. 7
- INSTALL 4" PVC STORM DRAIN PIPE (MINIMUM SLOPE OF 0.5%). REMOVE CONFLICTING EXISTING STORM DRAIN PIPE.
- (18) CONSTRUCT REDWOOD HEADER

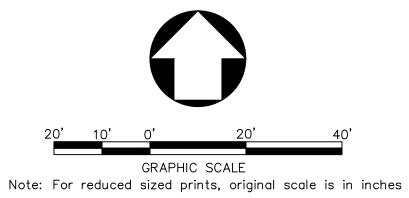

: 18, 2019 – 7:08AM – M:\2SAN020200\ENGR\SHEETS\BAKER FUEL SITE LAYOUT PLAN\PL-BAKER\_04-08 DET.D\

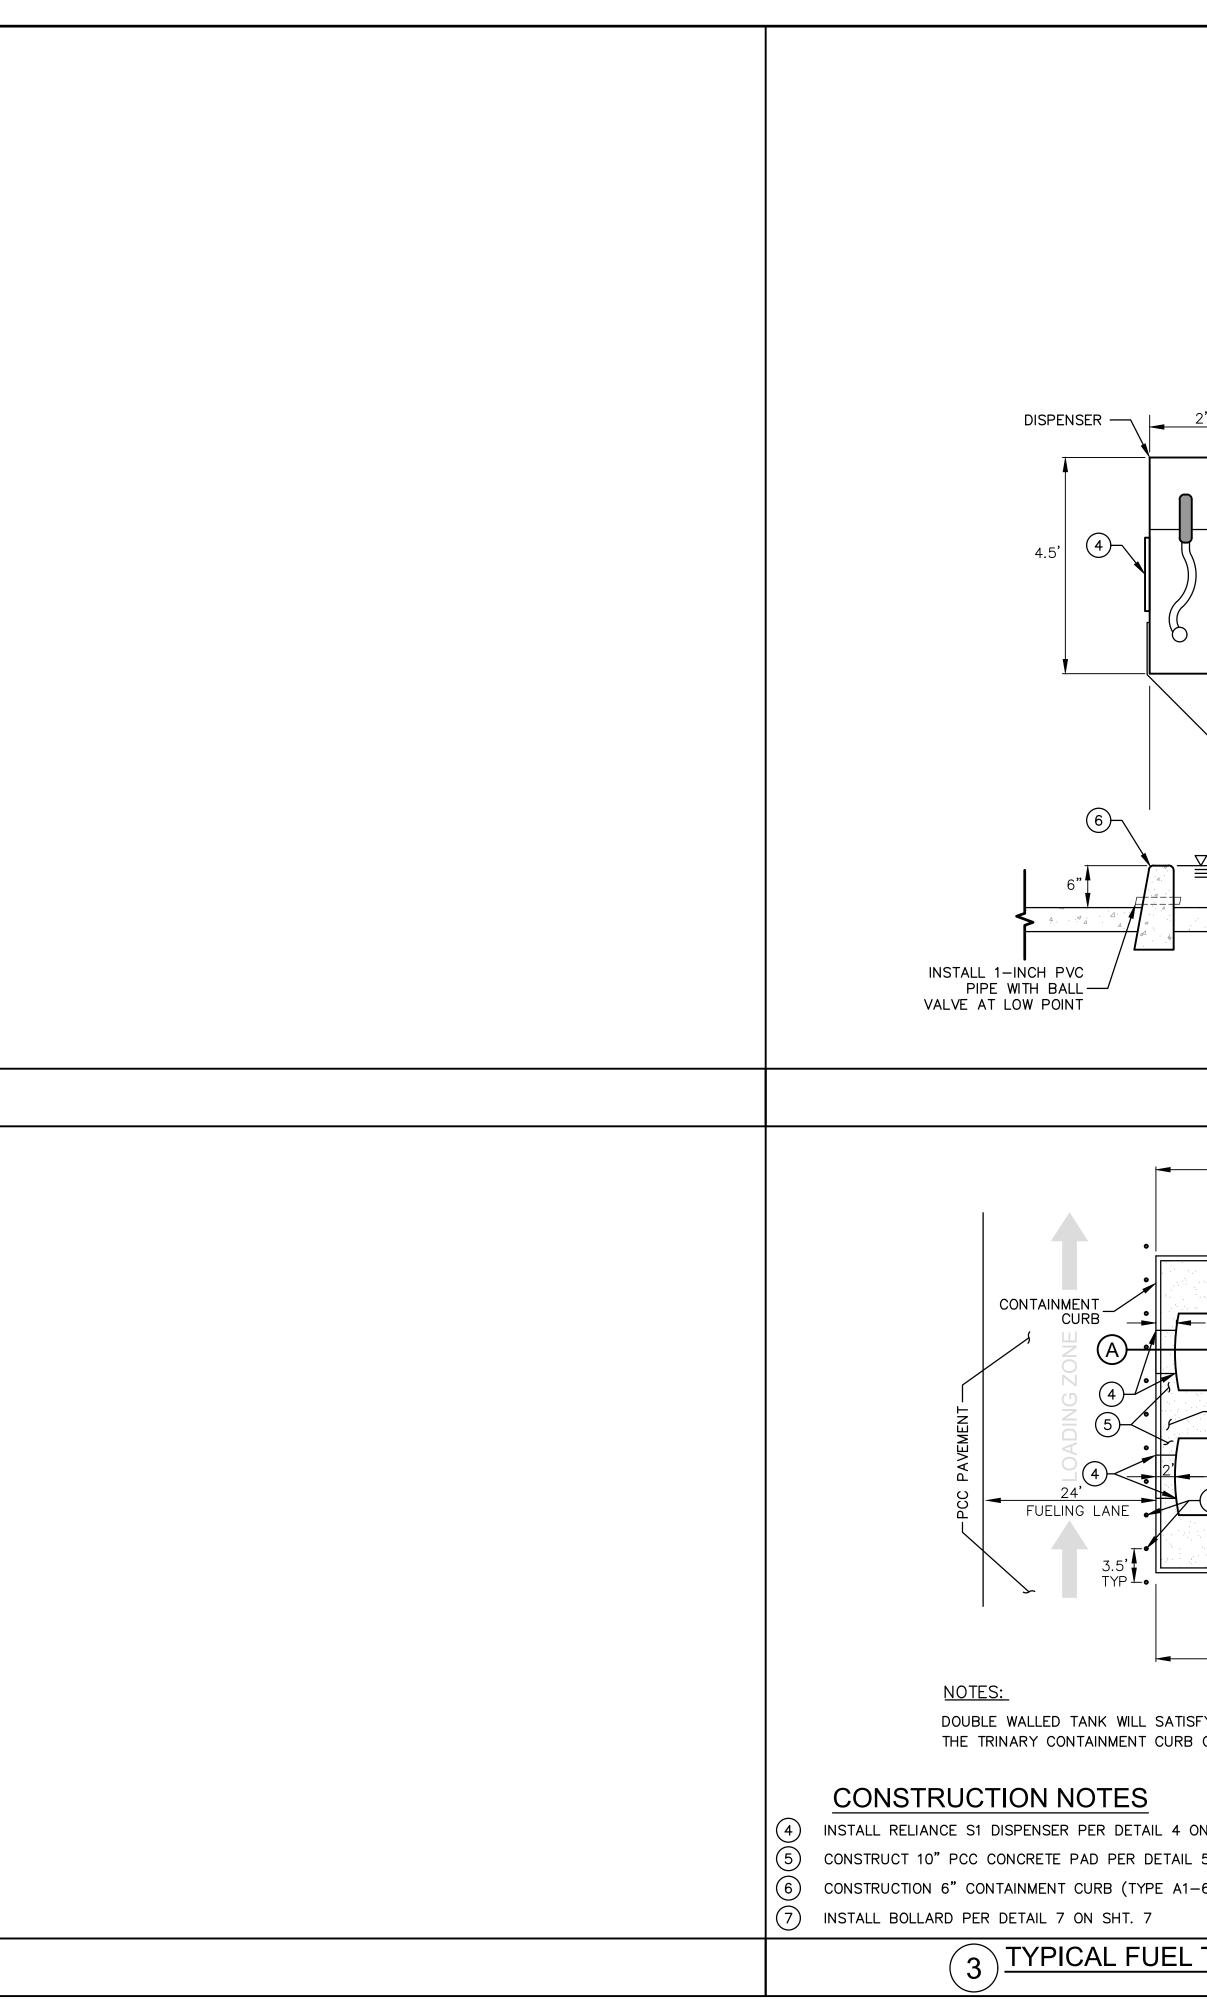

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CONTAINMENT STORAGE VOLUME				<b>.</b>	
		3 H Sui	Hutton Centre ite 200		S
			nta Ana, CA 9  4) 751—7373	92707 Fax(714) 545-8883	
			Kell	D PROFESSIONAL	
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TANK 6		No.	RE	VISION	DATE
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FY SECONDARY CONTAINMENT REQUIREMENTS. ONLY ADDRESS THE RAINFALL STORAGE.				< LAYOUTS ECTION	;
ON SHT. 5 5 ON SHT. 7		Revis	sion Date:		
-6) PER APWA STD. PLAN 120–2. SEE DETAIL 6 ON SHT. 7	7	Draw		MS HN	
TANKS LAYOUT - SINGLE SIDE SCALE: 1"=10'		Date:	-	12/18/19 24 x 36	
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100% CONSTRUCTION	N DOCUMENTS			04 of 11 Sh	neets



The Reliance S1 AST combines space-saving design with full-featured performance Compact size is ideal for AST shelf-attached applications and other special situations like marinas Accurately records fuel usage with a weights and measures sealable meter Available in an E85 compatible model for an easy transition to alternative fueling



### Specifications

Model Number: Prefix / G6101D / Suffix 1 Options / Suffix 2 Options (e.g. / G6101D / 2JK / W1) Standard model includes the following options as standard: 1" piping [2], j-box [J], hose hanger [K], solenoid valve [//W1]. Option prefix or suffixes are noted in the options below in []. A \*//" (e.g. [//W1]) indicates a suffix 2

option. Performance: Up to 22 GPM (83 lpm)\*.

Compatibility: For dispensing low viscosity petroleum fuels - diesel; biodiesel blends up to 20%; gasoline, including oxygenated blends; kerosene; AvGas^, and let fuel^. See E85 option. Fuel must meet the applicable ASTM standard. ANote: Confirm with fuel supplier on any fluid path metal restrictions before use.

If aluminum, zinc, or red metals are not desired, the E85 option may be utilized. Register: Non-computer mechanical register with power reset with interlock. Up to 999.9 gallons per delivery. Non-resettable accumulative totalizer up to 9999999.9. Optional liters measure.

Meter: Reliable micro-accurate 2-piston positive displacement design. Weights & Measures sealable.

Solenoid Valve [//W1]: 1" (2.5 cm) two-stage valve. Single stage valve with E85 option.

Electrical: 115VAC, 60 Hz. Optional 230VAC 50/60 Hz operation [Z]. Inlet Connection: 11/2" (3.8 cm) NPT. Bottom access hole sized for 11/2" emergency valve installation.

Discharge: 1" (2.5 cm) with 34" reducing bushing.

Mounting: Four 7/16" (1.1 cm) mounting holes in bottom. Optional shelf-mount kit.

Cabinet Construction: All panels are fabricated from galvannealed steel for corrosion resistance. Front door includes lock and is removable for service. Outer sides, back, and top are removable for additional service access if required.

Cabinet Finish: Extremely durable powder-coated finish gives outstanding appearance and toughness. Metallic silver sides, top, and back. Blue door with black register decal. Optional black, brown, green, red, silver, yellow, ar white doors.

Nozzle Boot and Hook: Fits standard UL interchangeable nozzles. Also fits Emco Wheaton 4015 and Husky V short spout balance vapor recovery nozzles. Hook extension kits+ for OPW 11VF (p/n 892081-001) and Healy 400 (p/n 892080-001) long spout vapor recovery nozzles. Lift-to-start nozzle hook.

Hose Hanger [K]: Keeps hose off ground when not in use. Actual Dimensions: 30.25"H x 16.75"W x 14"D (76.8cm H x 42.5cm W x 35.6cm D)

Pressure: Working pressure up to 50 psi.

Approvals: C-UL-US Listed. Sealable by U.S. Weights & Measures.

### Options

Shelf-Mount Kit+: Carbon steel shelf brackets for mounting dispenser to tank. Black powder coat finish. P/n 891839-001.

Pulsers: 10:1 [7A] and 100:1 [7B] ratio options. E85\*\* [E/ prefix]: Utilizes nickel-plating, hard anodizing, stainless steel, and special elastomers, which have been used successfully for E85

compatibility Hose Mast [//J]: Raises hose to ease hose handling. Optional hose clamp

kit+ (p/n 890898-001) for Goodyear® vapor recovery hose. External Filter Kit+: Installs on discharge. P/n 889921-002. Stainless Steel: All exterior panels [//S], all panels except painted galvannealed steel doors [//S1], or stainless steel doors only [//S2].

Other Options: Liter measure [8] and 230VAC 50/60 Hz operation [Z]. **Rear View Shown** 

VR register with power reset (10:1 or 100:1 pulser option)

panels facilitate service

J-box for AC & pulser terminations 1" two-stage solenoid valve

Weights & Measures sealable 2-piston meter

11/2" dispenser inlet 5" clearance hole

Vertical strainer with

for mounting 11/2" shear valve

Note: Kits require field installation.

\*Flow rates are maximum test rates at discharge. Actual rates will depend upon instal-lation conditions, dispenser accessories and the size of the submersible or suction pump. "E/models are UL Listed for Class I liquids, which include gasoline and diesel. A UL

listing specific to a new UL guideline for ethanol is pending. Select only hose and nozzle accessories that are expressly compatible with the fuel type being dispensed.






FUEL TECH

2680 US HWY 1 MIMS, FL 32754 1-800-628-1863 EMAIL: INFO@FUELTECH.COM

133-MHC-1000 16SVEQ1005 16SVGF30015 16SVGF10503 16SVGF20503 SVEQ80160


L&P10KD5 TA-732A

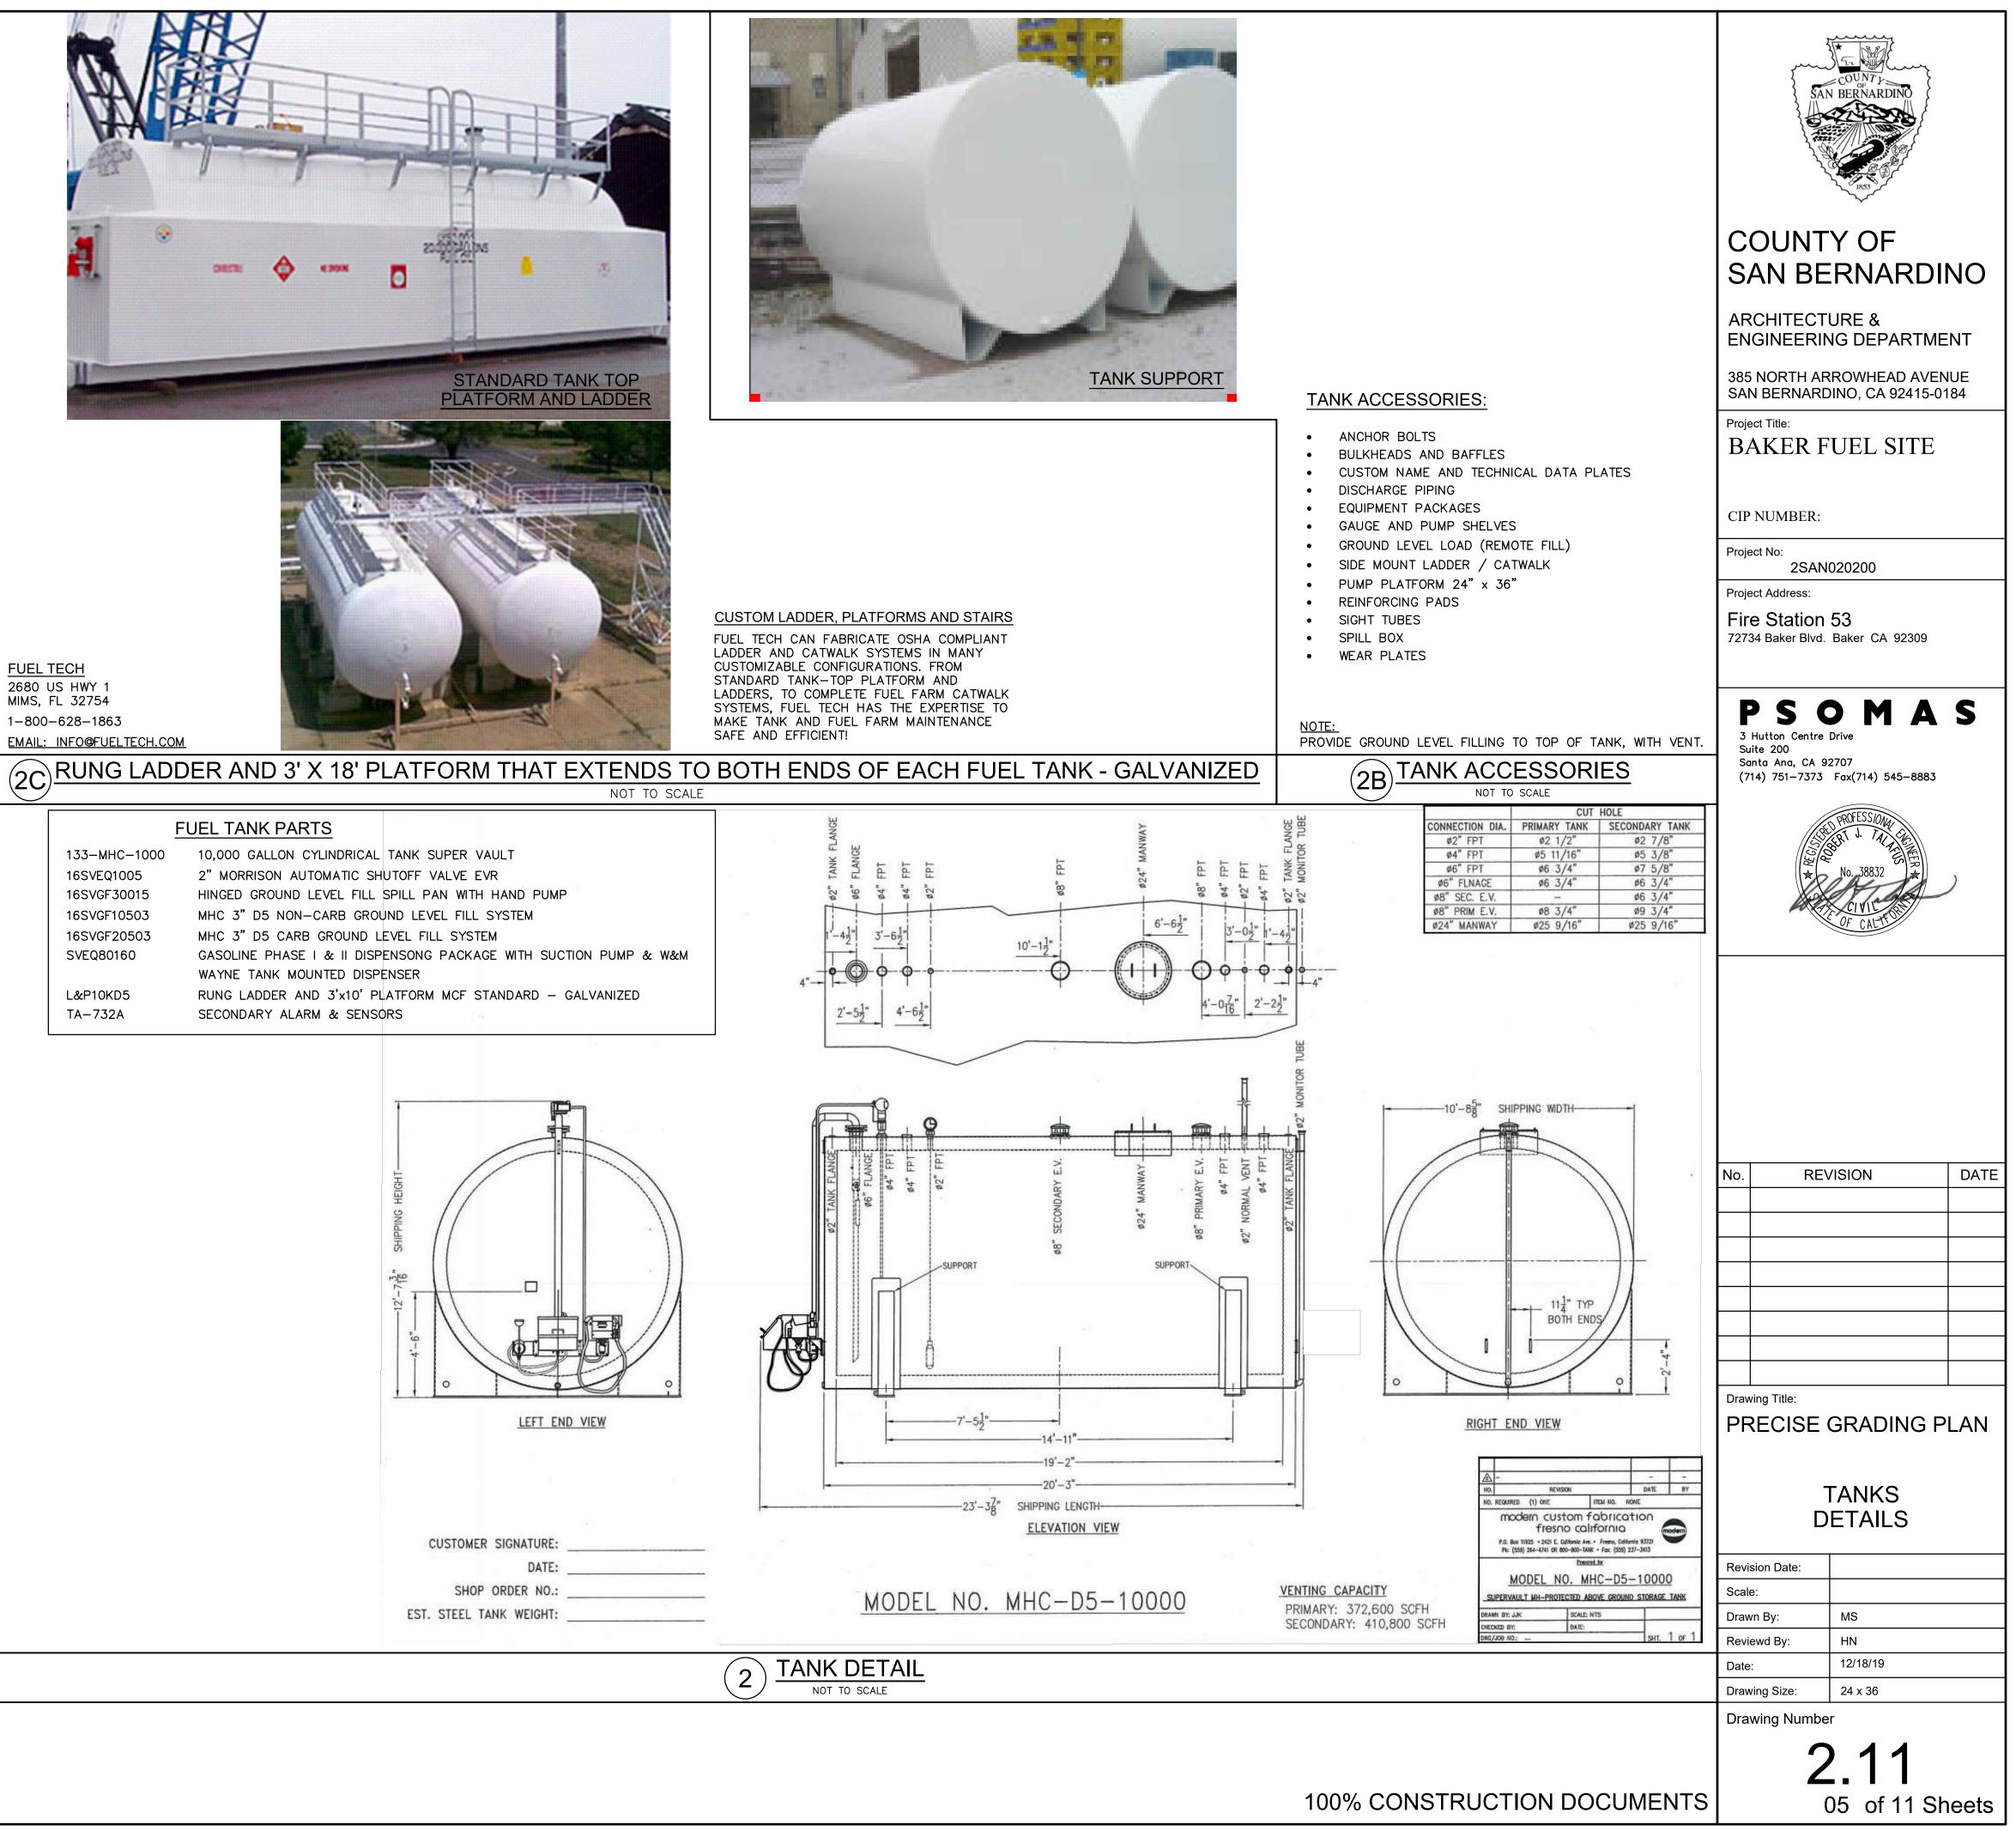

# Model 927/928/735DC Series & 9095A5201

The Morrison 927 dry disconnect adaptor is installed at the fill point in the fill line of a fuel storage tank system. The internal spring loaded poppet assembly remains closed providing a liquid-tight seal when not connected to a dry disconnect adaptor.

The Morrison 928 dry disconnect coupler is installed on the end of delivery vehicle hose. When coupled, the 927 and 928 provide a liquidtight connection enabling a dry connection and a dry disconnection.

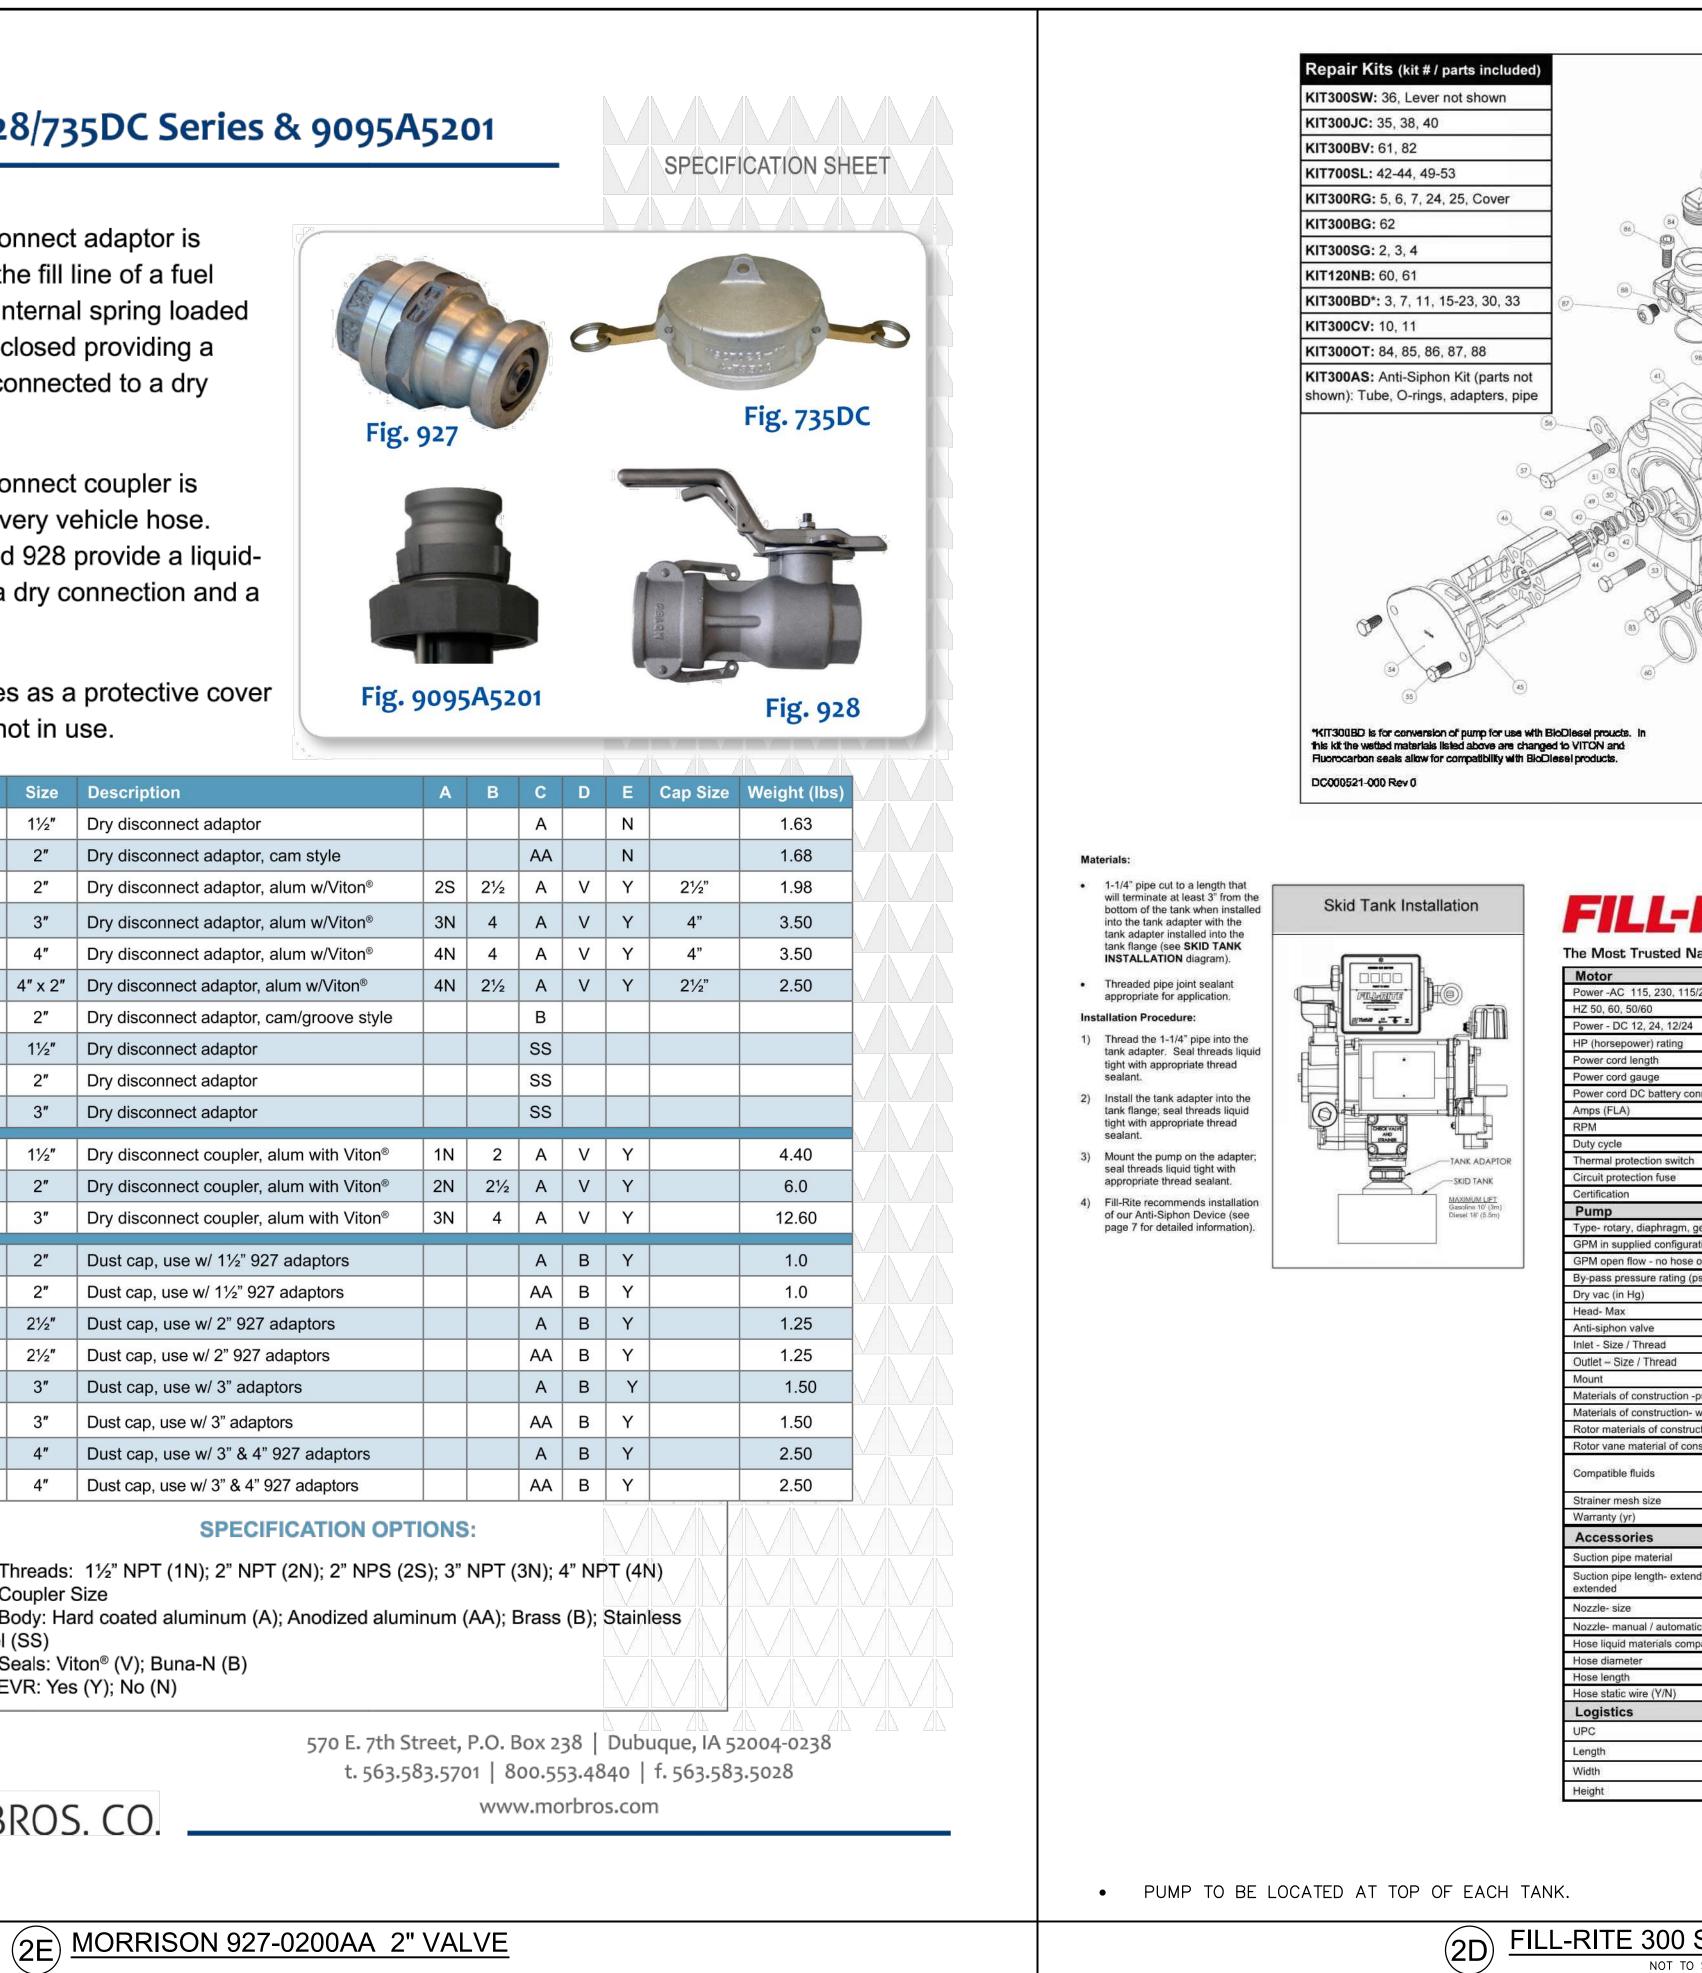


The 735DC dust cap serves as a protective cover for the 927 adaptor when not in use.


						_
I.D. Number		Size	Description	Α	В	
9270150 1A		11⁄2″	Dry disconnect adaptor			
9270200 AA		2″	Dry disconnect adaptor, cam style			
9270200AAEV	/R	2″	Dry disconnect adaptor, alum w/Viton®	2S	21⁄2	
9270300AAEV	/R	3″	Dry disconnect adaptor, alum w/Viton®	3N	4	
9270400AAEV	/R	4″	Dry disconnect adaptor, alum w/Viton®	4N	4	
9095A5201AAE	VR	4" x 2"	Dry disconnect adaptor, alum w/Viton®	4N	21/2	
927B0200 AA		2″	Dry disconnect adaptor, cam/groove style			
927S0150 1A		11⁄2″	Dry disconnect adaptor			
927S0200 1A		2″	Dry disconnect adaptor			
927S0300 1A		3″	Dry disconnect adaptor		-	
9280150ACE\	/R	11⁄2″	Dry disconnect coupler, alum with Viton®	1N	2	
9280200ACE\	/R	2″	Dry disconnect coupler, alum with Viton®	2N	21⁄2	
9280300ACE\	/R	3″	Dry disconnect coupler, alum with Viton®	3N	4	
735DC-2000ACE	EVR	2″	Dust cap, use w/ 11/2" 927 adaptors			
735DCA2000AC	EVR	2″	Dust cap, use w/ 11/2" 927 adaptors			
735DC-2500ACE	EVR	21⁄2″	Dust cap, use w/ 2" 927 adaptors			
735DCA2500AC	EVR	21⁄2″	Dust cap, use w/ 2" 927 adaptors			
735DC-3000ACE	EVR	3″	Dust cap, use w/ 3" adaptors			
735DCA3000AC	EVR	3″	Dust cap, use w/ 3" adaptors			
735DC-4000ACE	EVR	4″	Dust cap, use w/ 3" & 4" 927 adaptors			
735DCA4000AC	EVR	4″	Dust cap, use w/ 3" & 4" 927 adaptors			
	B—C C—E steel	Coupler S Body: Ha (SS)	1½" NPT (1N); 2" NPT (2N); 2" NPS (2S Size rd coated aluminum (A); Anodized alumin	S); 3"	NPT (	
						_
L			570 E. 7th St t. 563.58	-	-	
	9270150 1A 9270200 AA 9270200AAE 9270300AAE 9270400AAE 92780400AAE 92780200 AA 92780200 AA 927S0150 1A 927S0300 1A 927S0300 1A 9280200ACE 9280200ACE 9280200ACE 735DC-2000ACE 735DC-2000ACE 735DC-2500ACE 735DC-2500ACE 735DC-2500ACE	9270150 1A 9270200 AA 9270200AAEVR 9270300AAEVR 92750300AAEVR 92780200 AA 927S0150 1A 927S0200 1A 927S0300 1A 9280150ACEVR 9280300ACEVR 9280300ACEVR 735DC-2000ACEVR 735DC-2500ACEVR 735DCA2000ACEVR 735DC-3000ACEVR 735DC-3000ACEVR 735DCA3000ACEVR 735DCA3000ACEVR	9270150 1A       11/2"         9270200 AA       2"         9270200 AA       2"         9270300AAEVR       3"         9270400AAEVR       4" × 2"         9095A5201AAEVR       4" × 2"         927B0200 AA       2"         927S0150 1A       11/2"         927S0200 1A       2"         927S0200 1A       2"         927S0300 1A       3"         9280150ACEVR       11/2"         9280200ACEVR       2"         9280300ACEVR       2"         9280300ACEVR       2"         735DC-2000ACEVR       2"         735DC-2000ACEVR       2"         735DC-2500ACEVR       21/2"         735DC-3000ACEVR       3"         735DC-3000ACEVR       3"         735DC-3000ACEVR       3"         735DC-4000ACEVR       4"         735DC-4000ACEVR       4"         735DC-4000ACEVR       4"         8Coupler S       CBody: Ha         Steel (SS)       DSeals: Vit	9270150 1A1½"Dry disconnect adaptor9270200 AA2"Dry disconnect adaptor, cam style9270200AAEVR2"Dry disconnect adaptor, alum w/Viton®9270300AAEVR3"Dry disconnect adaptor, alum w/Viton®9270400AAEVR4"Dry disconnect adaptor, alum w/Viton®9270400AAEVR4" x 2"Dry disconnect adaptor, alum w/Viton®9095A5201AAEVR4" x 2"Dry disconnect adaptor, alum w/Viton®927B0200 AA2"Dry disconnect adaptor, cam/groove style927S0150 1A1½"Dry disconnect adaptor927S0200 1A2"Dry disconnect adaptor927S0300 1A3"Dry disconnect coupler, alum with Viton®9280150ACEVR1½"Dry disconnect coupler, alum with Viton®9280200ACEVR2"Dry disconnect coupler, alum with Viton®9280300ACEVR2"Dust cap, use w/ 1½" 927 adaptors735DC-2000ACEVR2"Dust cap, use w/ 1½" 927 adaptors735DC-2000ACEVR2½"Dust cap, use w/ 2" 927 adaptors735DC-2000ACEVR3"Dust cap, use w/ 3" adaptors735DC-3000ACEVR3"Dust cap, use w/ 3" adaptors735DC-3000ACEVR4"Dust cap, use w/ 3" adaptors735DC-4000ACEVR4"Dust cap, use w/ 3" adaptors735DC-4000ACEVR4"Dust cap, use w/ 3" adaptors735DC-4000ACEVR4"Dust cap, use w/ 3" & 4" 927 adaptors735DC-4000ACEVR4"Dust cap, use w/ 3" & 4" 927 adaptors735DC-4000ACEVR4"Dust cap, use w/ 3"	9270150 1A       1½"       Dry disconnect adaptor       927         9270200 AA       2"       Dry disconnect adaptor, cam style       927         9270200 AA       2"       Dry disconnect adaptor, alum w/Viton®       2S         9270300AAEVR       3"       Dry disconnect adaptor, alum w/Viton®       3N         9270400AAEVR       4"       Dry disconnect adaptor, alum w/Viton®       4N         9095A5201AAEVR       4" x 2"       Dry disconnect adaptor, alum w/Viton®       4N         927B0200 AA       2"       Dry disconnect adaptor, alum w/Viton®       4N         927S0150 1A       1½"       Dry disconnect adaptor       92         927S0300 1A       2"       Dry disconnect adaptor       92         9280150 ACEVR       1½"       Dry disconnect coupler, alum with Viton®       1N         9280300 ACEVR       1½"       Dry disconnect coupler, alum with Viton®       1N         9280300ACEVR       2"       Dust cap, use w/ 1½" 927 adaptors       1         735DC-2000ACEVR       2"       Dust cap, use w/ 1½" 927 adaptors       1         735DC-2000ACEVR       2½"       Dust cap, use w/ 2" 927 adaptors       1         735DC-2000ACEVR       2½"       Dust cap, use w/ 3" adaptors       1         <	9270150 1A       1½"       Dry disconnect adaptor       Image: Second Sec

MORRISON BROS. CO.

		F			Pump Kits		AR EN 385 SAN Proje BA	OUNT AN BE CHITECT GINEERIN NORTH AF NORTH AF NORTH AF	RNARD	ENT
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94		82)	0		thill Transfer System Fort Wayns, Inc 18001 634-2	siana			Baker CA 92309	
	FR313V os and Meters 115/230 VOLT 60/50 None 3/4 None N/A N/A 9.8/4.9/11.4/5.7 A 1725/1425 30 min. Y NONE				ications		3   Sui Sai	Hutton Centre ite 200 nta Ana, CA 9		
gear, vane	UL, cUL Rotary Vane	Sku/Kit #'s	Small Pump Kits	Col	nsists of	1				
ation or nozzle osi) - Max	26.8 34.3 26 14 60.06	KIT300BD KIT300BV KIT300JC KIT300NB	Bio-Diesel Bypass Junction Box Nozzle Boot	Special Shart Seal Asser Bypass O-ring Poppet, Spring, O-ring, O Junction Box Cover, O-R Nozzle Boot, Attaching H	ing, Hardware	-				
	Anti-siphon Ready 1 ¼" NPT	KIT300NR KIT300OT	Nozzle Retainer Outlet	Lockable Nozzle Retaine Outlet Flange, O-Ring Se	20.07 - 0-0		No.	RE	VISION	DATE
pump housing wetted material	Bung (NPT) Cast Iron Buna	KIT300RG KIT300SW	Rotary Group Switch Lever	Rotor, 8 Vanes, Rotor Ke Screws Switch Lever, Nut	ıy, Gasket, Rotor Cover, 4					
ction nstruction	80% Iron/20% Copper Carbon Diesel, Gasoline, Bio-Diesal up	KIT700AS KIT700BG	Anti-Siphon	Anti-Siphon Hose and Ha	ardware					
	to B20, E15, Kerosene 40 x 40 x .008" 2 Years	KIT700SL	Shaft Seal	8 Piece Assembly 300 SERIES						
11. 0	None	15.0		PERFORMANCE CURVE						
ded/not	None	30.0 2			$\sum$					
ic patibility	None None None	310.0						ing Title:	GRADING I	
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	18 18			Т	Tuthill uthill Transfer Systems 325 Aviation Drive			D	ETAILS	
				(8	ort Wayne, IN 46809 00) 634-2695 ww.tuthill.com		Revis Scale	sion Date:		
							Draw		MS	
SERIES	S PUMP						Revie Date:	ewd By:	HN 12/18/19	
SCALE								ing Size:	24 x 36	
	100%	CON	STR	UCTION	DOCUM	ENTS	Drav		<b>2.12</b> 06 of 11 S	heets

	1. CONCF 2. PLACE

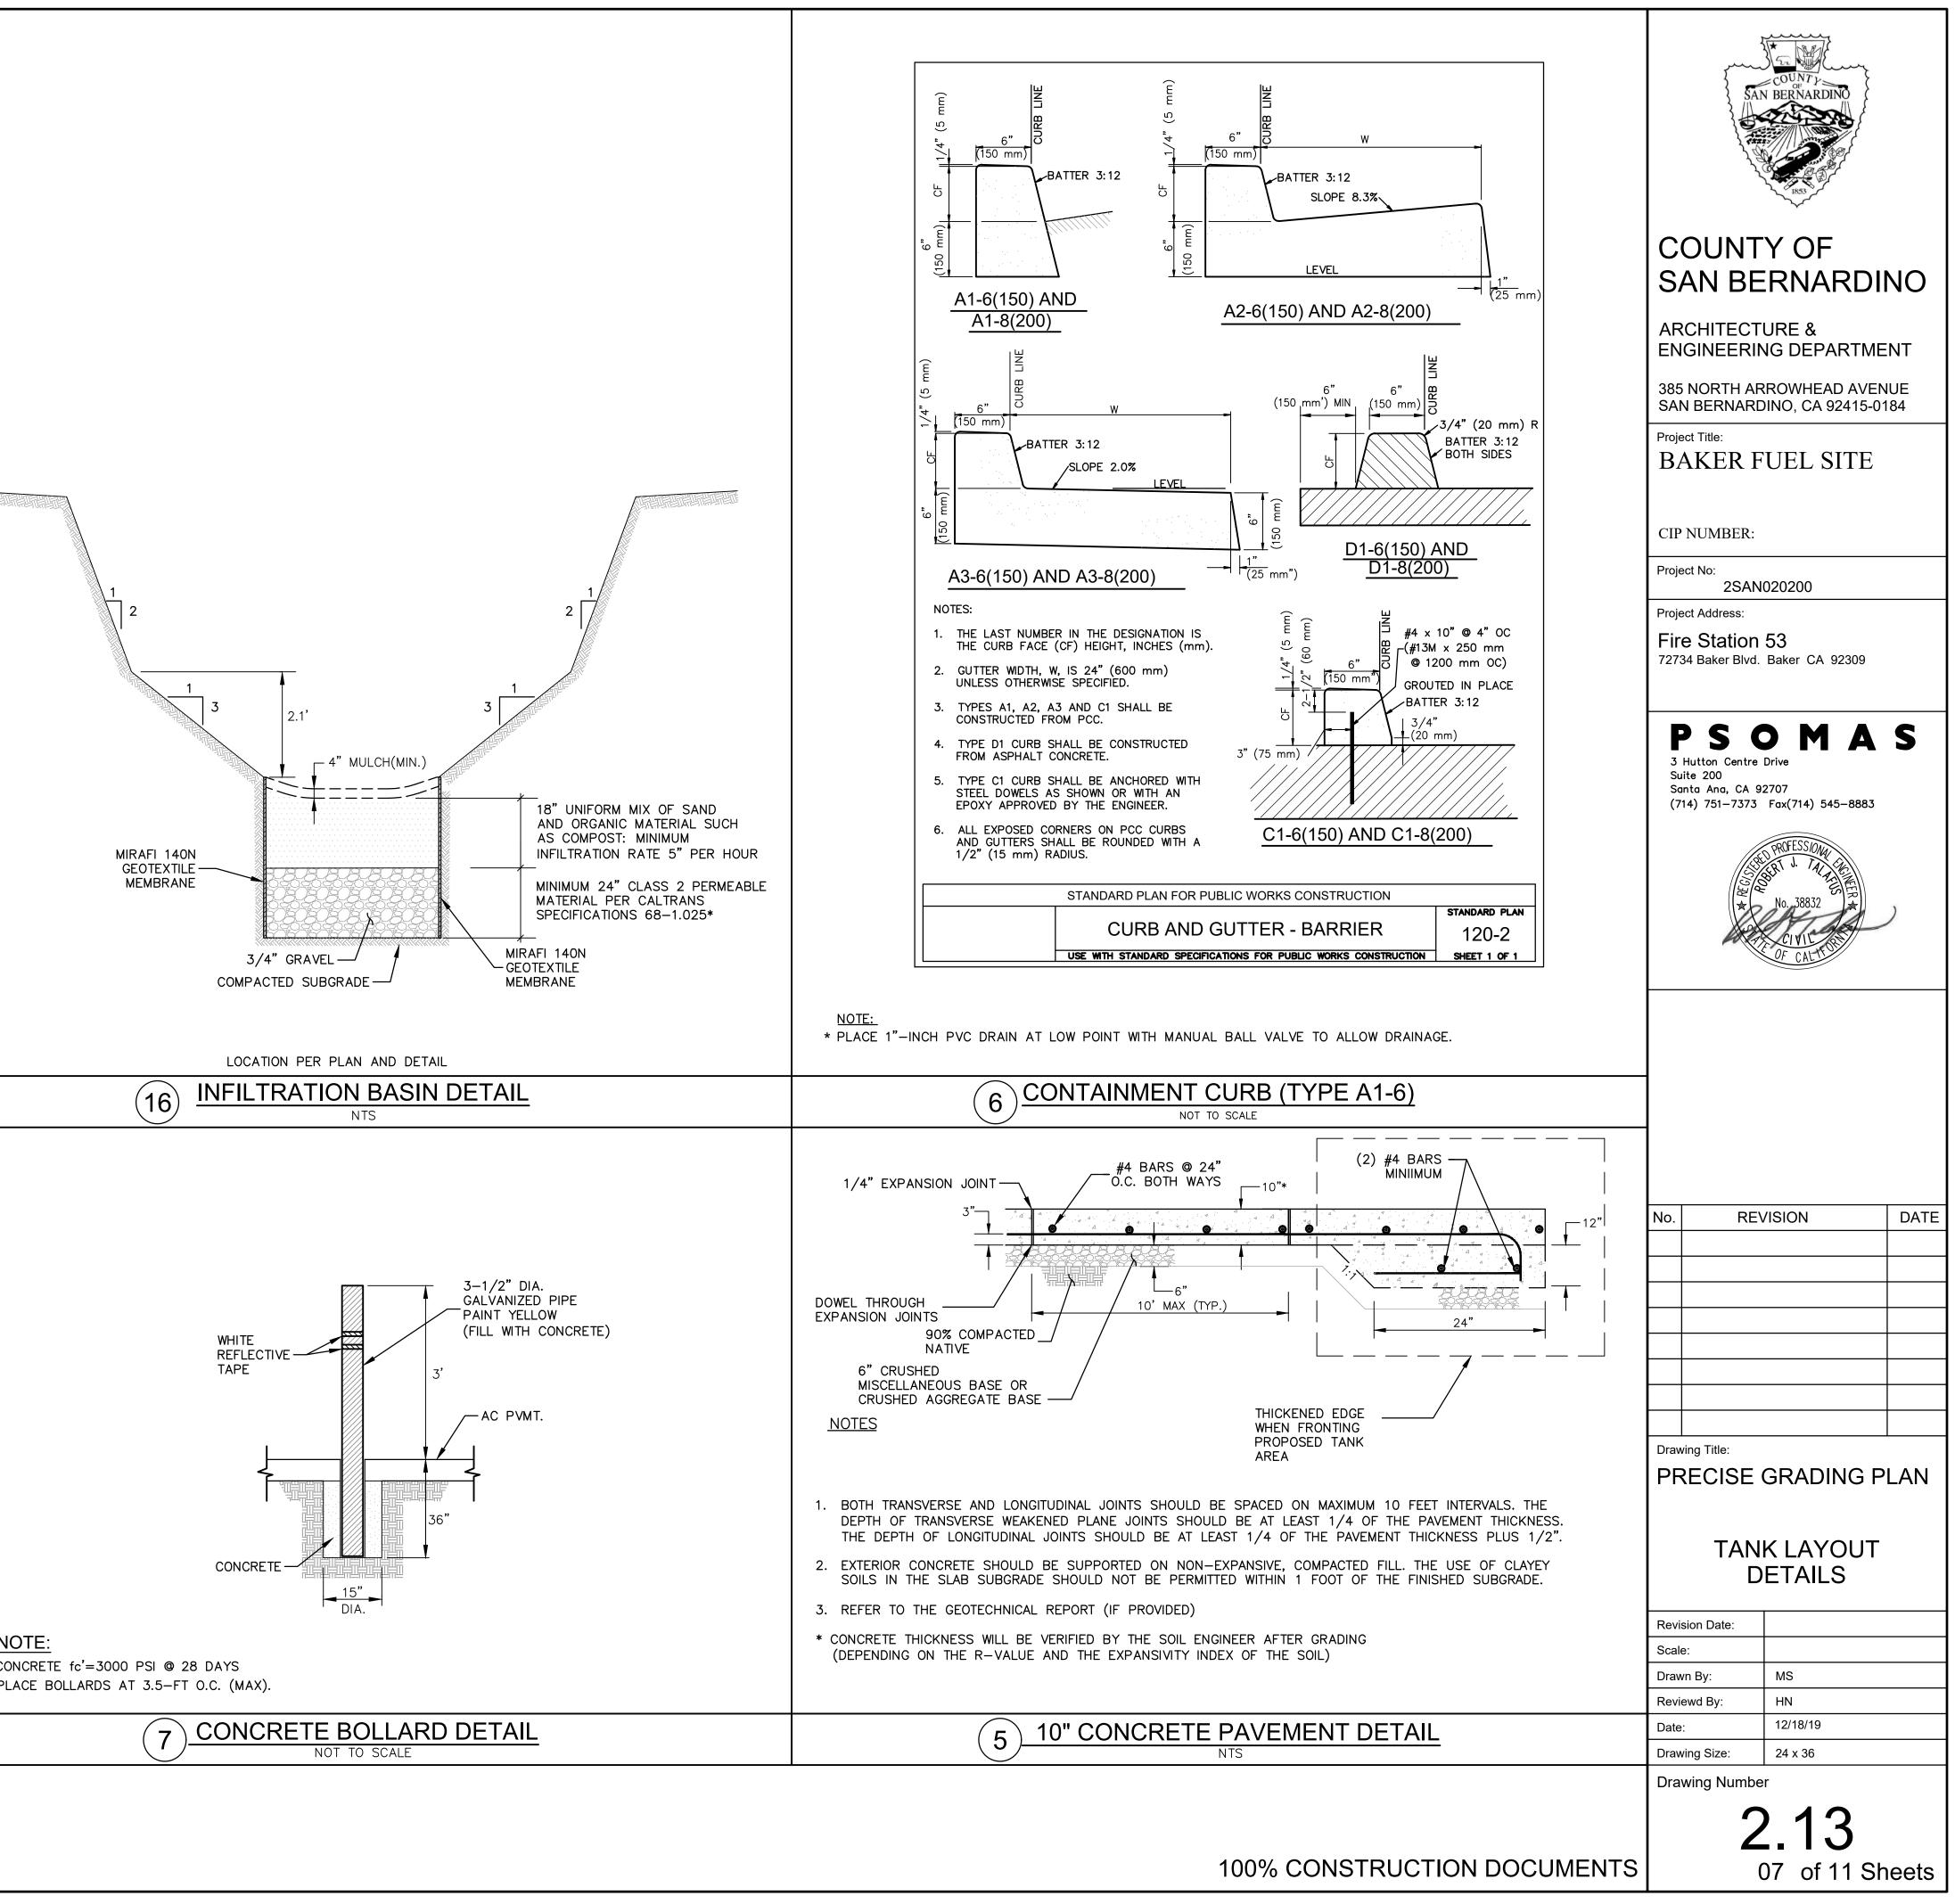

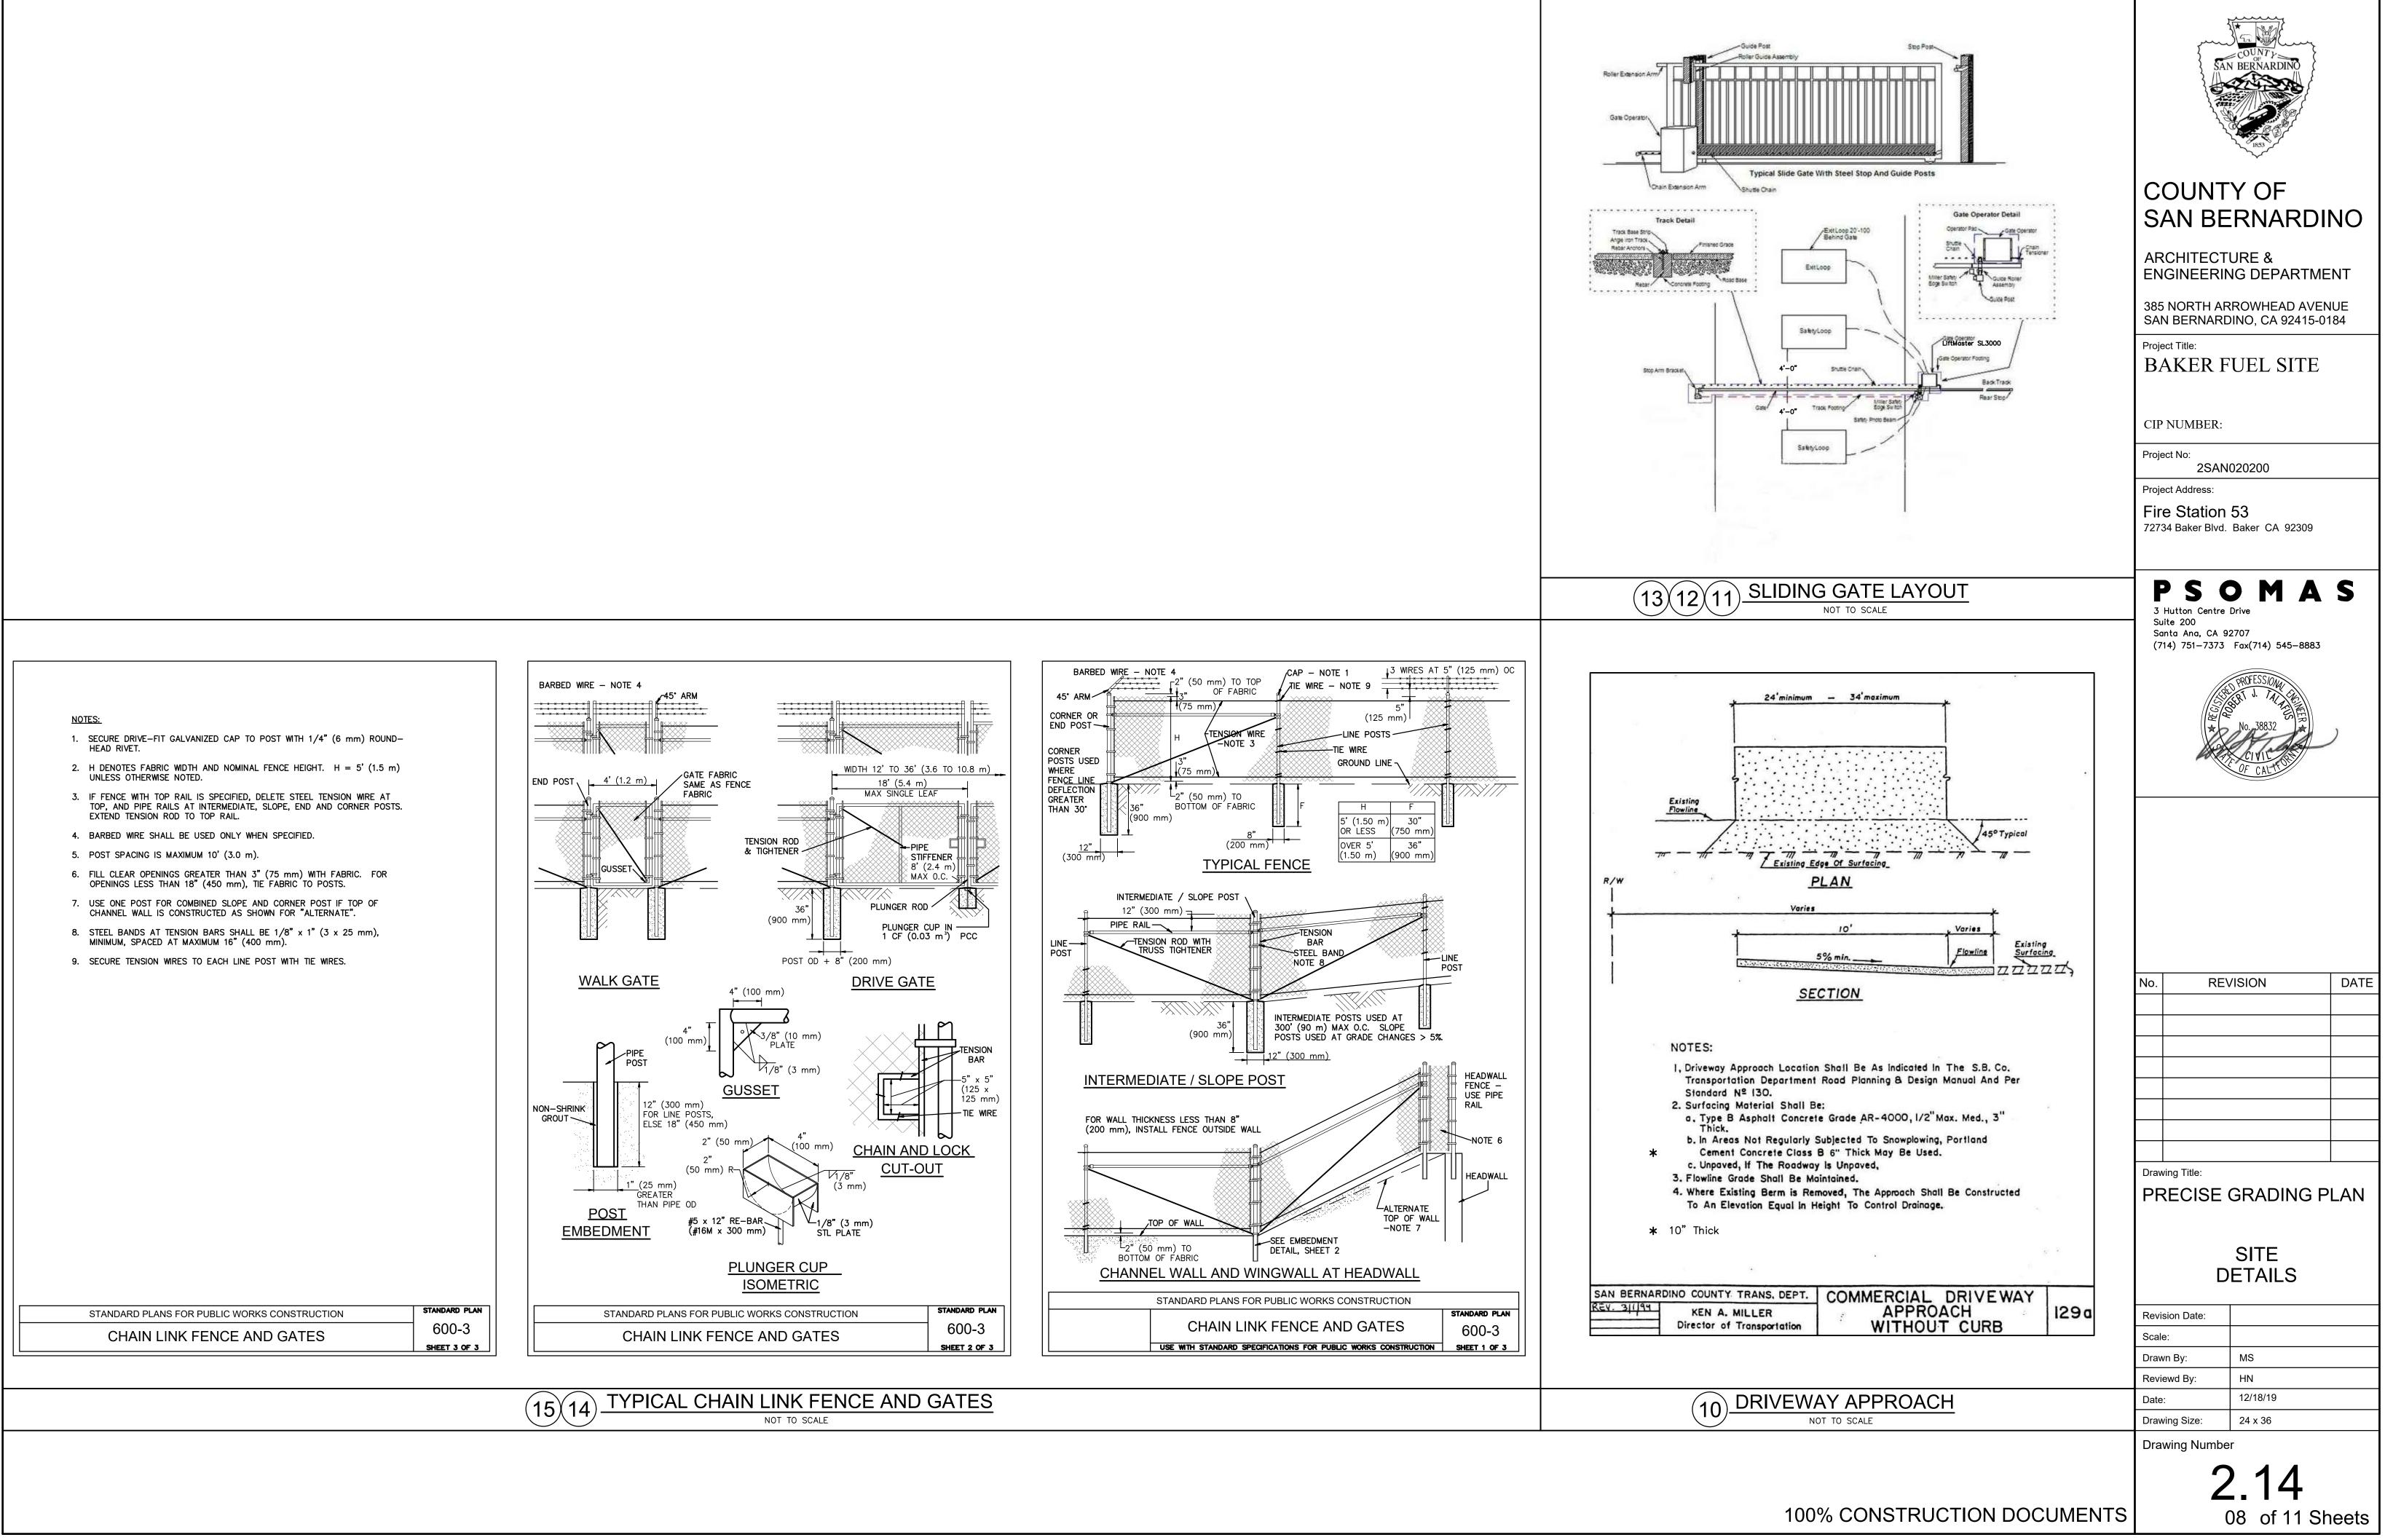

2019 – 7:47AM – M:\2SAN020200\ENGR\SHEETS\BAKER FUEL SITE LAYOUT PLAN\PL-BAKER\_04-08 DET.I

# **ELECTRICAL ABBREVIATIONS**

0	AT	SCHED.	SCHEDULE		BRANCH CIRCUIT PANELBOARD
A ABV	AMPERES ABOVE	SHT SOL	SHEET SOLENOID		SWITCHBOARDS, DISTRIBUTION PANE
A/C AF	AIR CONDITIONING AMP FUSE OR AMP FRAME	SPKR SQ. FT.	SPEAKER SQUARE FEET	T	TRANSFORMER, SIZE AS INDICATED
AFC A.F.F.	AVAILABLE FAULT CURRENT (SYMMETRICAL) ABOVE FINISHED FLOOR	STD. SURF.	STANDARD SURFACE		CONDUIT RUN CONCEALED IN CEILI DEFINITION SYMBOLS FOR RACEWAY
ARCH. AS	ARCHITECT AMP SWITCH	SW. SWBD	SWITCH SWITCHBOARD		CONDUIT RUN EXPOSED
AT	AMP TRIP	SYS.	SYSTEM	— — <del>   </del> —	CONDUIT RUN BELOW FLOOR SLAB
ATS AUTO	AUTOMATIC TRANSFER SWITCH AUTOMATIC	TAC TEL	TENANT AIR CONDITIONING TELEPHONE	<u># 10</u>	CONDON NON DELON FECON SEAD
BKBD	BACKBOARD	TEMP. TRANSF.	TEMPORARY OR TEMPERATURE TRANSFORMER	$\neg$	
C CAP.	CONDUIT CAPACITY	ΠB TV	TELEPHONE TERMINAL BACKBOARD TELEVISION		HASH MARKS INDICATE THE QUANT OTHERWISE NOTED, NO HASH MARI
CATV CB	COMMUNITY ANTENNA TELEVISION CIRCUIT BREAKER	TYP	TYPICAL		CONDUCTORS INDICATED). WHERE CONDUCTORS ARE #12 AWG (MIN).
CCTV	CLOSED CIRCUIT TELEVISION	U.G. U.O.N.	UNDERGROUND UNLESS OTHERWISE NOTED		CONDUIT SIZE SHALL BE AS FOLLO
C.I. CKT	CAST IRON CIRCUIT	0.0.N. V	VOLT		MIN. RACEWAY SIZE
CLG. CLR.	CEILING CLEAR	VA V.D.	VOLT AMPERES VOLTAGE DROP		THREE—QUARTER INCH (MIN) ONE INCH
C.O. COMPR.	CONDUIT ONLY COMPRESSOR	VERT.	VERTICAL		*QUANTITY OF CONDUCTORS AS IN
CONC. CONDR.	CONCRETE CONDENSER	W /	WATTS OR WIRE OR WIDE	<del>-                                     </del>	INDICATES A HOMERUN TO PANEL
CONN. CONT.	CONNECT OR CONNECTION CONTINUED/CONTINUATION	W/ W/O	WITH WITHOUT	2LA−1,3,5,7	NEUTRAL AND CIRCUIT 7 WITH DED
C.W.	COLD WATER	W.P.	WEATHERPROOF	Ļ	FLEXIBLE CONDUIT
D DET. DIA.	DEPTH DETAIL DIAMETER			l	CABLE OR CORD ARROW INDICATES A PLUG—IN CON
DISC. DN	DISCONNECT DOWN			G	GROUND CONDUCTOR
DWG	DRAWING			NOTES:	1) MOUNTING HEIGHTS NOTED ARE DI
EA EDF	EACH ELECTRIC DRINKING FOUNTAIN				CENTERLINE TO THE FINISH FLOOR NOTED.
ELEC ELEV	ELECTRIC OR ELECTRICAL ELEVATION OR ELEVATOR			(1)	2) CIRCLE WITH A NUMBER INSIDE RE
EMERG. EQUIP.	EMERGENCY EQUIPMENT				DRAWING WHERE IT IS INDICATED.
EXIST. EXT.	EXISTING EXTERIOR			o	CONDUIT BEND UP TOWARD OBSER
FA	FIRE ALARM			•	CONDUIT BEND DOWN AWAY FROM
FDR. FIXT.	FEEDER FIXTURE				
FLA	FULL LOAD AMPERES				
FLR FLUOR.	FLOOR FLUORESCENT				
GALV. GEN	GALVANIZED GENERATOR			SU	RFACE MOUNTED
GFCI	GROUND FAULT CIRCUIT INTERRUPTER			WITH M	OUNTING HEIGHT +46" (U.O.N.)
GFI GND	GROUND FAULT INTERRUPTER GROUND				DISCONNECT SWITCH WITH OVERCURRE SIZE AS REQUIRED BY EQUIPMENT MA
H HORIZ.	HIGH OR HEIGHT HORIZONTAL			Б	COMBINATION MOTOR STARTER-DISCON
HP HTR	HORSEPOWER HEATER				PROTECTION UNLESS OTHERWISE NOTE
HVAC	HEATING, VENTILATING AND AIR CONDITIONING				MAGNETIC MOTOR STARTER.
I.C.	INTERCOM			S <sub>т</sub> Sт	MANUAL MOTOR SWITCH WITH THERMAL MOTOR RATED TOGGLE DISCONNECT SI
I.G. INCAND.	ISOLATED GROUND INCANDESCENT			5	
IND. INT.	INDICATED INTERIOR				
JB	JUNCTION BOX			GE	NERAL POWER C
KVA KW	KILOVOLT AMPERES KILOWATT			EP (J)+	SURFACE MOUNTED JUNCTION BO
KWH	KILOWATT HOUR				
L LCL				EP 🕖	ABOVE GROUND JUNCTION BOX 1 EP INDICATE EXPLOSION PROOF.
LOC.	LONG CONTINUOUS LOAD LOCATION				
LTG L.V.	LIGHTING LOW VOLTAGE				
MAC	MALL AIR CONDITIONING				
MAX MCC	MAXIMUM MOTOR CONTROL CENTER				
MECH MFR.	MECHANICAL MANUFACTURER				
MH MIN	MANHOLE MINIMUM OR MINUTES				
MTD MTG	MOUNTED MOUNTING				
MTG. HT.	MOUNTING HEIGHT				
NA N/A	NOT APPLICABLE NON-AUTOMATIC				
NF	NON FUSIBLE				
N.L. NTS	NIGHT LIGHT NOT TO SCALE				
OL	OVERLOADS				
P PA	POLE PUBLIC ADDRESS				
PB P.C.	PULLBOX PHOTOCELL				
PNL P.O.C.	PANEL POINT OF CONNECTION				
PR.0.0.	PAIR				

INSTALL EQUIPMENT GREEN GROUNDING CONDUCTOR, SIZED PER N.E.C. 250-122 IN ALL CONDUITS. GROUND WIRES ARE NOT SHOWN ON DRAWINGS OR IN SYMBOL LIST.

POWER

ROOM

RECEPTACLE

REQUIRED

PR PWR.


RECEPT

REQ'D

RM

# POWER AND WIRING DISTRIBUTION

- ANELBOARD OR MOTOR CONTROL CENTER ED ON PLAN
- EILING OR WALL (SEE SPECIAL SYSTEMS AND WAY CODING)
- AB OR GRADE
- ANTITY OF CONDUCTORS REQUIRED. UNLESS ARKS INDICATE 2 #12 AWG (#10 AWG RE A NUMBER IS NOT INDICATED, THE

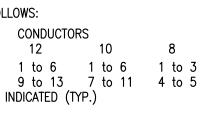

L 2LA, CIRCUITS 1-3-5 WITH SHARED DEDICATED NEUTRAL

ONNECTION

### DISTANCES MEASURED FROM THE DEVICE OR OR FINISH GRADE, UNLESS OTHERWISE

REFERS TO A SPECIAL NOTE ON THE

ERVER

M OBSERVER

# ED SWITCHES

RENT PROTECTION. MANUFACTURER. U.O.N.

CONNECT DEVICE, WITH OVERCURRENT )TFD

MAL OVERLOAD PROTECTION. SWITCH.

# OUTLETS

BOX, EP INDICATE EXPLOSION PROOF

12" ABOVE FINISH FLOOR,

# N.E.C. HAZARDOUS AREA NOTES:

- 1. TYPICAL N.E.C. ARTICLE 514 CLASS 1 LOCATION (UNDERGROUND TANK - FILL OPENING) EXTENT OF CLASS 1, GROUP D, DIVISION 1 LOCATION: ANY PIT, BOX OR SPACE BELOW GRADE LEVEL, ANY PART OF WHICH IS WITHIN THE DIVISION 1 OR 2 CLASSIFIED LOCATION. EXTENT OF CLASS 1, GROUP D. DIVISION 2 LOCATION: UP TO 18 INCHES ABOVE GRADE LEVEL WITHIN A HORIZONTAL RADIUS OF 10 FEET FROM A LOOSE FILL CONNECTION AND WITHIN A HORIZONTAL RADIUS OF 5 FEET FROM A TIGHT FILL CONNECTION.
- 2. TYPICAL N.E.C. ARTICLE 514 CLASS 1 LOCATION (UNDERGROUND TANK – VENT–DISCHARGE UPWARD) EXTENT OF CLASS 1, GROUP D, DIVISION 1 LOCATION: WITHIN 3 FEET OF OPEN END OF VENT, EXTENDING IN ALL DIRECTIONS. EXTENT OF CLASS 1, GROUP D, DIVISION 2 LOCATION: SPACE BETWEEN 3 FEET AND 5 FEET OF OPEN END OF VENT, EXTENDING IN ALL DIRECTIONS.
- 3. TYPICAL N.E.C. ARTICLE 514 CLASS 1 LOCATION (REMOTE PUMP - OUTDOOR) EXTENT OF CLASS 1, GROUP D, DIVISION 1 LOCATION: ANY PIT, BOX, OR SPACE BELOW GRADE LEVEL, ANY PART OF WHICH IS WITHIN THE DIVISION 1 OR 2 CLASSIFIED LOCATION. EXTENT OF CLASS 1, GROUP D. DIVISION 2 LOCATION: WITHIN 3 FEET OF ANY EDGE OF PUMP, EXTENDING
- IN ALL DIRECTIONS. ALSO UP TO 18 INCHES ABOVE GRADE LEVEL WITHIN 10 FEET HORIZONTALLY FROM ANY EDGE OF PUMP.
- 4. TYPICAL N.E.C. ARTICLE 514 CLASS 1 LOCATION (DISPENSING DEVICE - PITS) EXTENT OF CLASS 1, GROUP D, DIVISION 1 LOCATION: ANY PIT, BOX, OR SPACE BELOW GRADE LEVEL, ANY PART OF WHICH IS WITHIN THE DIVISION 1 OR 2 CLASSIFIED LOCATION.

- 5. TYPICAL N.E.C. ARTICLE 514 CLASS 1 LOCATION (DISPENSING DEVICE - DISPENSER) EXTENT OF CLASS 1, GROUP D, DIVISION 2 LOCATION: WITHIN 18 INCHES HORIZONTALLY IN ALL DIRECTIONS EXTENDING TO GRADE FROM (1) THE DISPENSER ENCLOSURE OR (2) THAT PORTION OF THE DISPENSER ENCLOSURE CONTAINING LIQUID HANDLING COMPONENTS.
- 6. TYPICAL N.E.C. ARTICLE 514 CLASS 1 LOCATION (DISPENSING DEVICE - OUTDOOR) EXTENT OF CLASS 1, GROUP D, DIVISION 2 LOCATION: UP TO 18 INCHES ABOVE GRADE LEVEL WITHIN 20 FEET HORIZONTALLY OF ANY EDGE OF ENCLOSURE.
- 7. TYPICAL N.E.C. ARTICLE 514 CLASS 1 LOCATION (DISPENSING DEVICE - OUTDOOR) EXTENT OF CLASS 1, GROUP D, DIVISION 1 LOCATION: VAPOR PROCESSING SYSTEM PITS ANY PIT OR BOX BELOW GRADE LEVEL, ANY PART OF WHICH IS WITHIN A DIVISION 1 OR DIVISION 2 CLASSIFIED LOCATION OR THAT HOUSES ANY EQUIPMENT USED TO TRANSPORT OR PROCESS VAPORS.
- 8. TYPICAL N.E.C. ARTICLE 514 CLASS 1 LOCATION (DISPENSING DEVICE - OUTDOOR) EXTENT OF CLASS 1, GROUP D, DIVISION 2 LOCATION: VAPOR PROCESSING EQUIPMENT LOCATED WITHIN PROTECTIVE ENCLOSURES WITHIN ANY PROTECTIVE ENCLOSURE HOUSING VAPOR PROCESSING EQUIPMENT.
- 9. TYPICAL N.E.C. ARTICLE 514 CLASS 1 LOCATION (DISPENSING DEVICE - DISPENSER) EXTENT OF CLASS 1, GROUP D, DIVISION 1 LOCATION: SPACE CLASSIFICATION INSIDE THE DISPENSER ENCLOSURE IS COVERED IN ANSI/UL 87, "POWER OPERATED DISPENSING DEVICES FOR PETROLEUM PRODUCTS."

	LIGHTING FIXTURE SCHEDULE									
TYPE SYMBOL (*) DESCRIPTION		INPUT		LAMPS		MOUNTING	MANUFACTURER & CATALOG NO.	REMARKS		
			•//	NO.	WATTS	TYPE	VOLT.			MOUNTED 20' ON
A	<b>⊶</b>	20' HIGH LED LIGHT POLE	94	1	94	LED	120	20' STEEL POLE	LITHONIA KAD LED 40C 700 40K R5-MVOLT SPD-PER7-PIRH	MOUNTED 20' ON SQUARE STEEL POLE; WITH PHOTOCELL AND MOTION SENSOR

# **GENERAL NOTES:**

- 1. ALL MATERIALS AND EQUIPMENT SHALL BE NEW AND SHALL BEAR THE UNDERWRITERS' LABEL (UL) AND SHALL BE INSTALLED IN THE MANNER FOR WHICH THEY ARE DESIGNED AND APPROVED.
- 2. ALL DEVICES INSTALLED OUTSIDE OR IN DAMP LOCATIONS SHALL BE APPROVED WEATHERPROOF.
- 3. ALL WIRE SHALL BE COPPER. ALL WIRE SHALL BE UL LISTED, RATED FOR 600 VOLTS, TYPE THHN/THWN INSULATION, NO. 12 MINIMUM SIZE EXCEPT FOR CONTROLS.
- 4. PROVIDE SUPPORT FOR ALL FIXTURES AND ELECTRICAL EQUIPMENT TO COMPLY WITH SEISMIC REQUIREMENTS OF THE CALIFORNIA BUILDING CODE.
- 5. PROVIDE AN ENCLOSURE OF EQUAL FIRE RESISTANT RATING AROUND ALL FIXTURES AND EQUIPMENT INSTALLED IN OR PENETRATING THROUGH FIRE RATED SEPARATIONS.
- 6. FOR PURPOSES OF CLEARNESS AND LEGIBILITY, THE ELECTRICAL DRAWINGS ARE ESSENTIALLY DIAGRAMMATIC. THE SIZE AND LOCATION OF EQUIPMENT IS SHOWN TO SCALE WHEREVER POSSIBLE. VERIFY ALL CONDITIONS, DATA INFORMATION AS INDICATED ON THE DRAWINGS AND IN THE SPECIFICATIONS SECTIONS WHERE ELECTRICAL WORK INTERFACES WITH OTHER TRADES.
- 7. WIRING IN JUNCTION BOXES, USED TO FEED SURFACE MOUNTED FIXTURES, ETC., SHALL BE ACCESSIBLE WITHOUT THE REMOVAL OF FIXTURES.
- 8. SEE ARCHITECTURAL PLANS FOR EXACT LOCATION OF ALL RECEPTACLES AND SWITCHES.
- 9. PAY ALL COST ASSOCIATED WITH CONSTRUCTION INCLUDING BONDS, INSURANCE, PERMITS AND INSPECTION FEES.

COUNTY SAN BERNARDINO								
COUNTY OF SAN BERNARDINO								
ARCHITECTURE & ENGINEERING DEPARTMENT								
385 NORTH ARROWHEAD AVENUE SAN BERNARDINO, CA 92415-0184								
Project Title: <b>PROJECT 5F15</b> FLEET MANAGEMENT FUEL TANK REPLACEMENT PROJECT - PHASE I CIP NUMBER: 15-009								
Project No: 4SAN030303								
Project Address: <b>Fire Station 53</b> 72734 Baker Blvd. Baker CA								
PSOMAS 3 Hutton Centre Drive Suite 200 Santa Ana, CA 92707 (714) 751-7373 Fax(714) 545-8883								
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Sak K								
ENGINEERS 421 East Huntington Drive Monrovia, California 91016 P: 626.930.1383 F: 626.930.1385 Job No: 18035								
No. REVISION DATE								
	_							
	_							
BID DRAWINGS	_							
Drawing Title: ELECTRICAL COVER SHEET								
BAKER Fire Station 53								
Revision Date:Scale:1" = 40'	_							
Drawn By:								
Reviewd By:Date:12/18/19	_							
Drawing Size: 24 x 36								
Drawing Number E0.01 09 of 11 Sheets								

### **100% CONSTRUCTION DOCUMENTS**